3

	CENERAL NOTES:
н	GENERAL NOTES: 1. SECURITY CONTRACTOR SHALL PROVIDE ALL LABOR AND MATERIAL REQUIRED FOR A COMPLETE AND FULLY OPERATING ACCESS CONTROL SYSTEM. UNLESS OTHERWISE NOTED, ALL MATERIAL SHALL BE NEW AND SHALL BE FURNISHED, INSTALLED, AND WIRED AS PART OF THE SECURITY CONTRACTOR'S SCOPE OF WORK.
	2. THESE DRAWINGS ARE DIAGRAMMATIC AND GENERALLY INDICATIVE OF THE WORK TO BE COMPLETED. CONTRACTOR SHALL CAREFULY INVESTIGATE THE STRUCTURAL, MECHANICAL, ELECTRICAL, AND FINISH CONDITIONS AFFECTING THIS WORK, AND INSTALL ACCORDINGLY.
	3. THESE DRAWINGS UTILIZE SYMBOLS AND SCHEMATIC DIAGRAMS WHICH HAVE DO DIMENSIONAL SIGNIFICANCE. THE WORK SHALL THEREFORE BE INSTALLED TO FULLFILL THE DIAGRAMMATIC INTENT EXPRESSED ON THE DRAWINGS, BUT WITH CONFORMITY WITH THE DIMENSIONS INDICATED ON THE FINAL WORKING DRAWINGS, FIELD LAYOUTS, AND SHOP DRAWINGS FROM ALL TRADES.
G	4. CERTAIN DETAILS APPEAR ON THE DRAWINGS FOR SECURITY WORK, WHICH ARE SPECIFIC WITH REGARD TO THE DIMENSIONING AND POSITIONING OF THE WORK. THESE ARE INTENDED ONLY FOR GENERAL INFORMATION PURPOSES. THEY DO NOT OBVIATE FIELD COORDINATION FOR INDIVIDUAL ITEMS OF THE INDICATED WORK.
	5. DRAWINGS ARE DIAGRAMMATIC AND CERTAIN SPECIALITIES ARE NOT SHOWN HOWEVER, THEY SHALL BE PROVIDED AS REQUIRED. ALL MEASUREMENTS SHALL BE DONE IN THE FIELD.
	6. PRIOR TO BID, CONTRACTOR SHALL VISIT THE SITE TO BECOME FAMILIAR WITH EXISTING CONDITIONS.
	7. ALL MATERIALS AND WORKMANSHIP SHALL BE GUARANTEED FOR A MINIMUM OF 1 YEAR FOLLOWING THE DATE OF ACCEPTANCE.
	8. THE WORK SHALL CONFORM TO THE MORE STRINGENT OF ALL APPLICABLE RULES, CODES, AND REGULATIONS, INCLUDING BUT NOT LIMITED TO THE NATIONAL ELECTRICAL DOE, THE AHJ, AND OWNER'S STANDARDS.
F	9. SECURITY CONTRACTOR SHALL SECURE ALL PERMITS, PAY ALL FEES, AND ARRANGE FOR ALL INSPECTIONS.
	10. KEEP PREMISES FREE FROM RUBISH, AND REMOVE RUBBISH FROM SITE.
	11. FURNISH PRODUCT CUTSHEETS , AND SHOP DRAWINGS FOR APPROVAL PRIOR TO PURCHASE OF THE EQUIPMENT. FURNISH SHOP DRAWINGS AND SUBMITTALS FOR APPROVAL BY SECURITY DESIGNER PRIOR TO PURCAHSE OF CABLING, EQUIPMENT, AND DEVICES. THE SECURITY CONTRACTOR WILL BE RESPONSIBLE FOR REMOVING AND/OR REPLACING ANY MATERIALS THAT WERE NOT APPROVED AS PART OF THE SUBMITTAL PROCESS.
	12. PROVIDE ALL CUTTING REQUIRED FOR THIS WORK. ALL PAINTING AND PATCHING SHALL BE PERFORMED BY THE GENERAL CONTRACTOR.
E	13. THE TERMS "FURNISH" SHALL MEAN TO OBTAIN AND SUPPLY TO THE JOB SITE. THE TERM "INSTALL" SHALL MEAN TO FIX IN POSITION AND CONNECT FOR USE. THE TERM "PROVIDE" SHALL MEAN TO FURNISH AND INSTALL. THE TERM "CONTRACTOR" SHALL MEAN SECURITY CONTRACTOR.
	14. THE CONTRACTOR SHALL COORDINATE THE INSTALLATION OF ALL CONDUITS, RACEWAYS, PATHWAYS, AND CHASES WITH OTHER TRADES PRIOR TO THE FABRICATION AND INSTALLATION.
	15. THE CONTRACTOR SHALL EXAMINE THE DRAWINGS OF ALL TRADES AND COORDINATE THEIR WORK TO AVOID INTERFERENCE WITH STRUCTURE AND OTHER EQUIPMENT ABOVE AND BELOW CEILING.
	16. COORDINATE LOCATION AND MOUNTING REQUIREMENTS OF ALL CEILING MOUNTED OR ABOE CEILING MOUNTED DEVICES WITH REFLECTED CEILING PLAN, LIGHTING LAYOUT AND OTHER CEILING MOUNTED EQUIPMENT.
D	17. THE CONTRACTOR IS REQUIRED TO PROPERLY FIRE—STOP ANY CORES, SLEEVES, OPENINGS AND CONDUITS UTILIZED FOR THE PLACING OF SECURITY CABLING WITH APPROVED FIRESTOPPING PRODUCTS AND ACCORDING TO LOCAL, STATE AND NATIONAL CODES. MATERIALS IN THE CABLE PATHWAY SHALL BE RE—ENTERABLE MATERIAL.
	18. THE CONTRACTOR SHALL BE RESPONSIBLE FOR BRINGING TO ATTENTION OF THE SECURITY DESIGNER ANY DISCREPANCIES IN THE PLANS AND SPECIFICATIONS THAT WILL AFFECT THE WORK. PRIOR TO SUBMISSION OF THE PRICE.
	19. CONDUIT SIZES SHOWN ON THE SECURITY DRAWINGS ARE TYPICAL AND ARE SUBJECT TO CHANGE ASED ON DOOR TYPES, AND HARDWARE CONFIGURATIONS.
	20. CABLE TYPES SHOWN ON THE SECURITY DRAWINGS ARE TYPICAL AND ARE SUBJECT TO CHANGE BASED ON DOOR HARDWARE AND DEVICE TYPE.

1. ELECTRICAL CONTRACTOR SHALL PROVIDE SECURITY CABLING, INCLUDING CONDU STRINGS, FITTINGS, SURFACE RACEWAYS

SECURITY SYSTEM RACEWAY NOTES:

- UNISTRUT/THREADED ROD, OUTLET BOXES PULL BOXES, EXCAVATION, DEMOLITION PATCHING, SEALING, ETC. REQUIRED REFER TO THOSE RESPECTIVE TRADE SPECIFIC REQUIREMENTS RELATED TO LOCATIONS AND OTHER REQUIREMENTS L NOTED.
- 2. THE CONTRACTOR PROVIDING THE LOW CABLE SHALL PROVIDE ALL J-HOOK CABLE
- 3. ELECTRICAL CONTRACTOR SHALL WORK/REQUIREMENTS WITH THE SECURITY
- 4. ELECTRICAL CONTRACTOR SHALL PROVIDE ADDITIONAL LABOR AND MATERIALS PER DRAWINGS AND/OR CALL FOR IN SPECIFICATIONS.
- 5. ENTIRE INSTALLATION, INCLUDING MATERIALS, EQUIPMENT AND WORKMANSHIP, SHALL CONFORM AS OUTLINED IN THE CONTRACT DOCUMENTS, THE NATIONAL ELECTRICAL CODE AND WITH ALL APPLICABLE LAWS, CODES, REGULATIONS, AND REGULATORY BODIES HAVING JURISIDICTION OVER THIS WORK.

CAT 6 CABLE NOTES:

- 1. STRUCTURED CABLE CONTRACTOR SHALL FURNISH AND INSTALL ALL CATEGORY 6 CABLE FOR THE SECURITY IP CAMERAS UNLESS OTHERWISE NOTED. SECURITY CONTRACTOR IS RESPONSIBLE FOR COORDINATING DATA OUTLET LOCATIONS FOR THE IP CAMERAS AND FINAL CONNECTIVITY REQUIREMENTS WITH THE STRUCTURED CABLE CONTRACTOR AND DUKE ENERGY TELECOMMUNICATIONS DEPARTMENT.
- 2. STRUCTURED CABLE CONTRACTOR SHALL FURNISH AND INSTALL ALL CATEGORY 6 CABLE FOR NETWORK CONNECTIVITY TO THE ACCESS CONTROL PANELS. COORDINATE CONNECTION WITH SECURITY CONTRACTOR AND DUKE ENERGY TELECOMMUNICATIONS.
- 3. MOTOROLA SOLUTIONS IS RESPONSIBLE FOR FURNISHING AND INSTALLING ALL CAT 6 PATCH CABLES FROM THE PATCH PANELS TO THE VIDEO MANAGEMENT SYSTEM POE SWITCHES.

SECURITY CABLE NOTES:

- 1. SECURITY SYSTEM CABLES MUST BE SUPPORTED INDEPENDENT OF OTHER UTILITIES, SUCH AS CONDUITS, PIPES, CEILING SUPPORT SYSTEMS, CABLE TRAYS AND NOT LAID DIRECTLY ON CEILING PANELS. CABLE SHALL BE BUNDLED IN PARALLEL WITH APPLICABLE TIES AND PROPERLY LABELED. CABLE SHALL BE SUPPORTED WITH HANDLERS SPACED AT APPROPRIATE DISTANCES.
- 2. CABLES SHALL BE CONTINUOUS BETWEEN THE DEVICE AND THE TERMINAL CONNECTOR ON THE CONTROLLER AND/OR POWER SUPPLY.
- 3. CABLES WITHIN EQUIPMENT RACKS, CABINETS AND CABLE TRAYS SHALL BE NEATLY STRAPPED, DRESSED AND SUPPORTED. CABLES SHALL BE GROUPED ACCORDING TO SIGNALS BEING CARRIED.
- 4. VELCRO CABLE TIES SHALL BE USED FOR CABLE TRAINING IN EQUIPMENT RACKS. BUNDLE NO MORE THAN FOUR (4) CABLES PER BUNDLE TO FACILITATE MANUAL TRACING OF CABLE.
- 5. UNUSED CABLE CONDUCTORS AND SHIELDS SHALL BE LABELED AS SPACE. THE CABLE SHALL BE PROTECTED FROM ACCIDENTAL SHORTING OR GROUND CONTACT.
- 6. LABEL BOTH ENDS OF ABANDONED SECURITY SYSTEM CABLE AT THEIR POINTS OF ORIGIN AND TERMINATION POINT. USE INDELIBLE MARKER AND HELLERMAN SELF-LAMINATING GENERIC WRITE-ON TAGS TO IDENTIFY THE CABLE. TAGS SHALL BE SECURED TO CABLES WITH CABLE TIES.
- 7. SECURITY SYSTEM CABLE SHALL BE MULTI-CONDUCTOR CABLES, SHIELDED STRANDED COPPER TYPE WITH PVC JACKET AND ULT TYPE CMT.
- 8. CABLE INSTALLED IN EXTERIOR DUCT BANKS, UNDERGROUND CONDUIT, OR WET LOCATIONS SHALL BE SUITABLE FOR DIRECT BURIAL WITH AN OVERALL FOIL SHIELD AND WATER/UV RESISTANT JACKET. THE CABLE SHALL BE FILLED TO PREVENT THE ENTRY OF MOISTURE BETWEEN THE CONDUCTORS.

1. LABELS FOR CARD READERS, PACS NODES, WIU AND POWER

2. LABELS FOR CARD READERS SHALL BE AFFIXED TO EITHER

3. PLUG-IN TRANSFORMERS SHALL BE LABELED TO IDENTIFY

4. POWER SUPPLIES SHALL BE LABELED WITH THE ELECTRICAL

SUPPLY ENCLOSURES SHALL BE 1"X3" BRADY B–93 RAISED

PANEL LABEL, BLACK IN COLOR WITH WHITE TEXT. NO

TOP OR SIDE OF THE READER. LABEL SHALL NOT

SECURITY SYSTEM LABELING NOTES:

SUBSTITUTIONS WILL BE ACCEPTED.

INTERFERE WITH THE READER LED.

PANEL ID AND CIRCUIT NUMBER.


THE CONNECTED DEVICE.


CONNECTED DEVICE.

UIT ′S, ES, N FO D S	RACE S WI BACF FLOO CUTT R TH OCUME SIZES, ESS	TH F K BO R BO ING IS W ENTS ROU ^T	PULL XES, XES, AND ORK. FOR TING,		
	LTAGE SUPPO		IRITY		
	ORDINA ONTRAC		ALL		
ΞR	ANY THE THEIR	SECL	IRITY		




5. FIBER OPTIC MODULES SHALL BE LABELED TO IDENTIFY THE

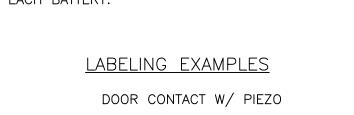

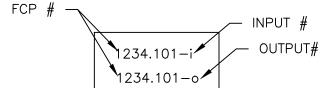

NOTE: LABEL ATTACHED TO ENCLOSURE

CARD READER W/ PIEZO FCP # CARD READER PORT ADDRESS ✓ OUTPUT# 1234.11 1234.101-0 NOTE: LABEL ATTACHED TO READER

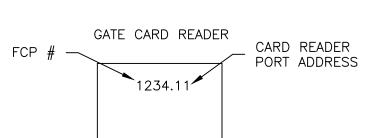

NOTE: LABEL ATTACHED TO READER

FCP ENCLOSURE FCP # 1234

NOTE: LABEL ATTACHED ON FRONT

POWER SUPPLY ENCLOSURE

	24VDC LOCK
	PANEL: CIRCUIT:
NOTE:	LABEL ATTACHED ON FRONT

7	

8

	(
	•

Н

G

	DRAWING	G INDEX	
SHEET #	TITLE	REV	DATE
EY-0002	NOTES	0	05/24/23
EY-0003	SECURITY SIGNS	0	05/24/23
EY-0100	SECURITY PLAN	0	05/24/23
EYD-0110	BUILDING PLAN	0	05/24/23
EY-5001	DETAILS	0	05/24/23
EY-5002	DETAILS	0	05/24/23
EY-5003	DETAILS	0	05/24/23
EY-5004	DETAILS	0	05/24/23
EY-5005	DETAILS	0	05/24/23
EY-5006	DETAILS	0	05/24/23
EY-5007	DETAILS	0	05/24/23
EY-7001	VEHICLE GATE RISER	0	05/24/23
EY-7002	BUILDING PACS RISER	0	05/24/23
EY-7003	BUILDING VMS RISER	0	05/24/23

GE	INERAL SYMBOLS	
#	SHEET KEY NOTE	
(1234.11)	READER PORT ADDRESS	
(1234.101-0)	OUTPUT PORT ADDRESS	
(1234.101-I)	INPUT PORT ADDRESS	
(FCAM-01)	FIXED CAMERA	
(MCAM-01)	MULTI-SENSOR CAMERA	
(LPR-01)	LICENSE PLATE CAMERA	
PACS	PHYSICAL ACCESS CONTROL SYSTEM	
VMS	VIDEO MANAGEMENT SYSTEM	
DC	DOOR CONTACT	
	CAMERA	
CR	CARD READER	

ELECTRICAL AND DATA SYMBOLS

 \cup

_/__`

 \leftarrow

DENOTES CONDUIT ROUGH-IN FOR SECURITY DEVICE. REFER TO DEVICE DETAIL FOR MORE INFORMATION.


DENOTES DEDICATED, UNSWITCHED 120VAC ELECTRICAL CONNECTION FOR PACS EQUIPMENT.

DENOTES DATA CONNECTION FOR PACS AND VMS EQUIPMENT.

D

В

	DE		KE ERC	GY.
MAILING ADDR P.O. BOX 1007 CHARLOTTE, N				
Safety ILLNESS ZER INJURY		educe Ris emove E	sk	to Hazards avior
SEAL				
DUNN MOBILE				
DUNN, NOF	RTH CA	ROLIN	A	
				NSTRUCTION
REVISION				SSUED FOR CONSTR
DRN BY				- da
PROJECT NO:		0000		05/24/23
CFD-PN(ELECTRONIC FI	0000-]		EY-0002	2
CHK'D BY: E-MAIL: THIS DESIGN DRAWN	ING IS THE I	BP TER@PAYNT	05/2 ERCONSULTIN	4/23 NG.COM DUKE ENERGY
CORPORATION AND MODIFIED, COPIED, INFORMATION SHOUL INTENDED. SHEET TITLE: PROJEC SECU	OR DISTRIBL	DTES	t prior appr the specific	NDEX
SHEET NO.				

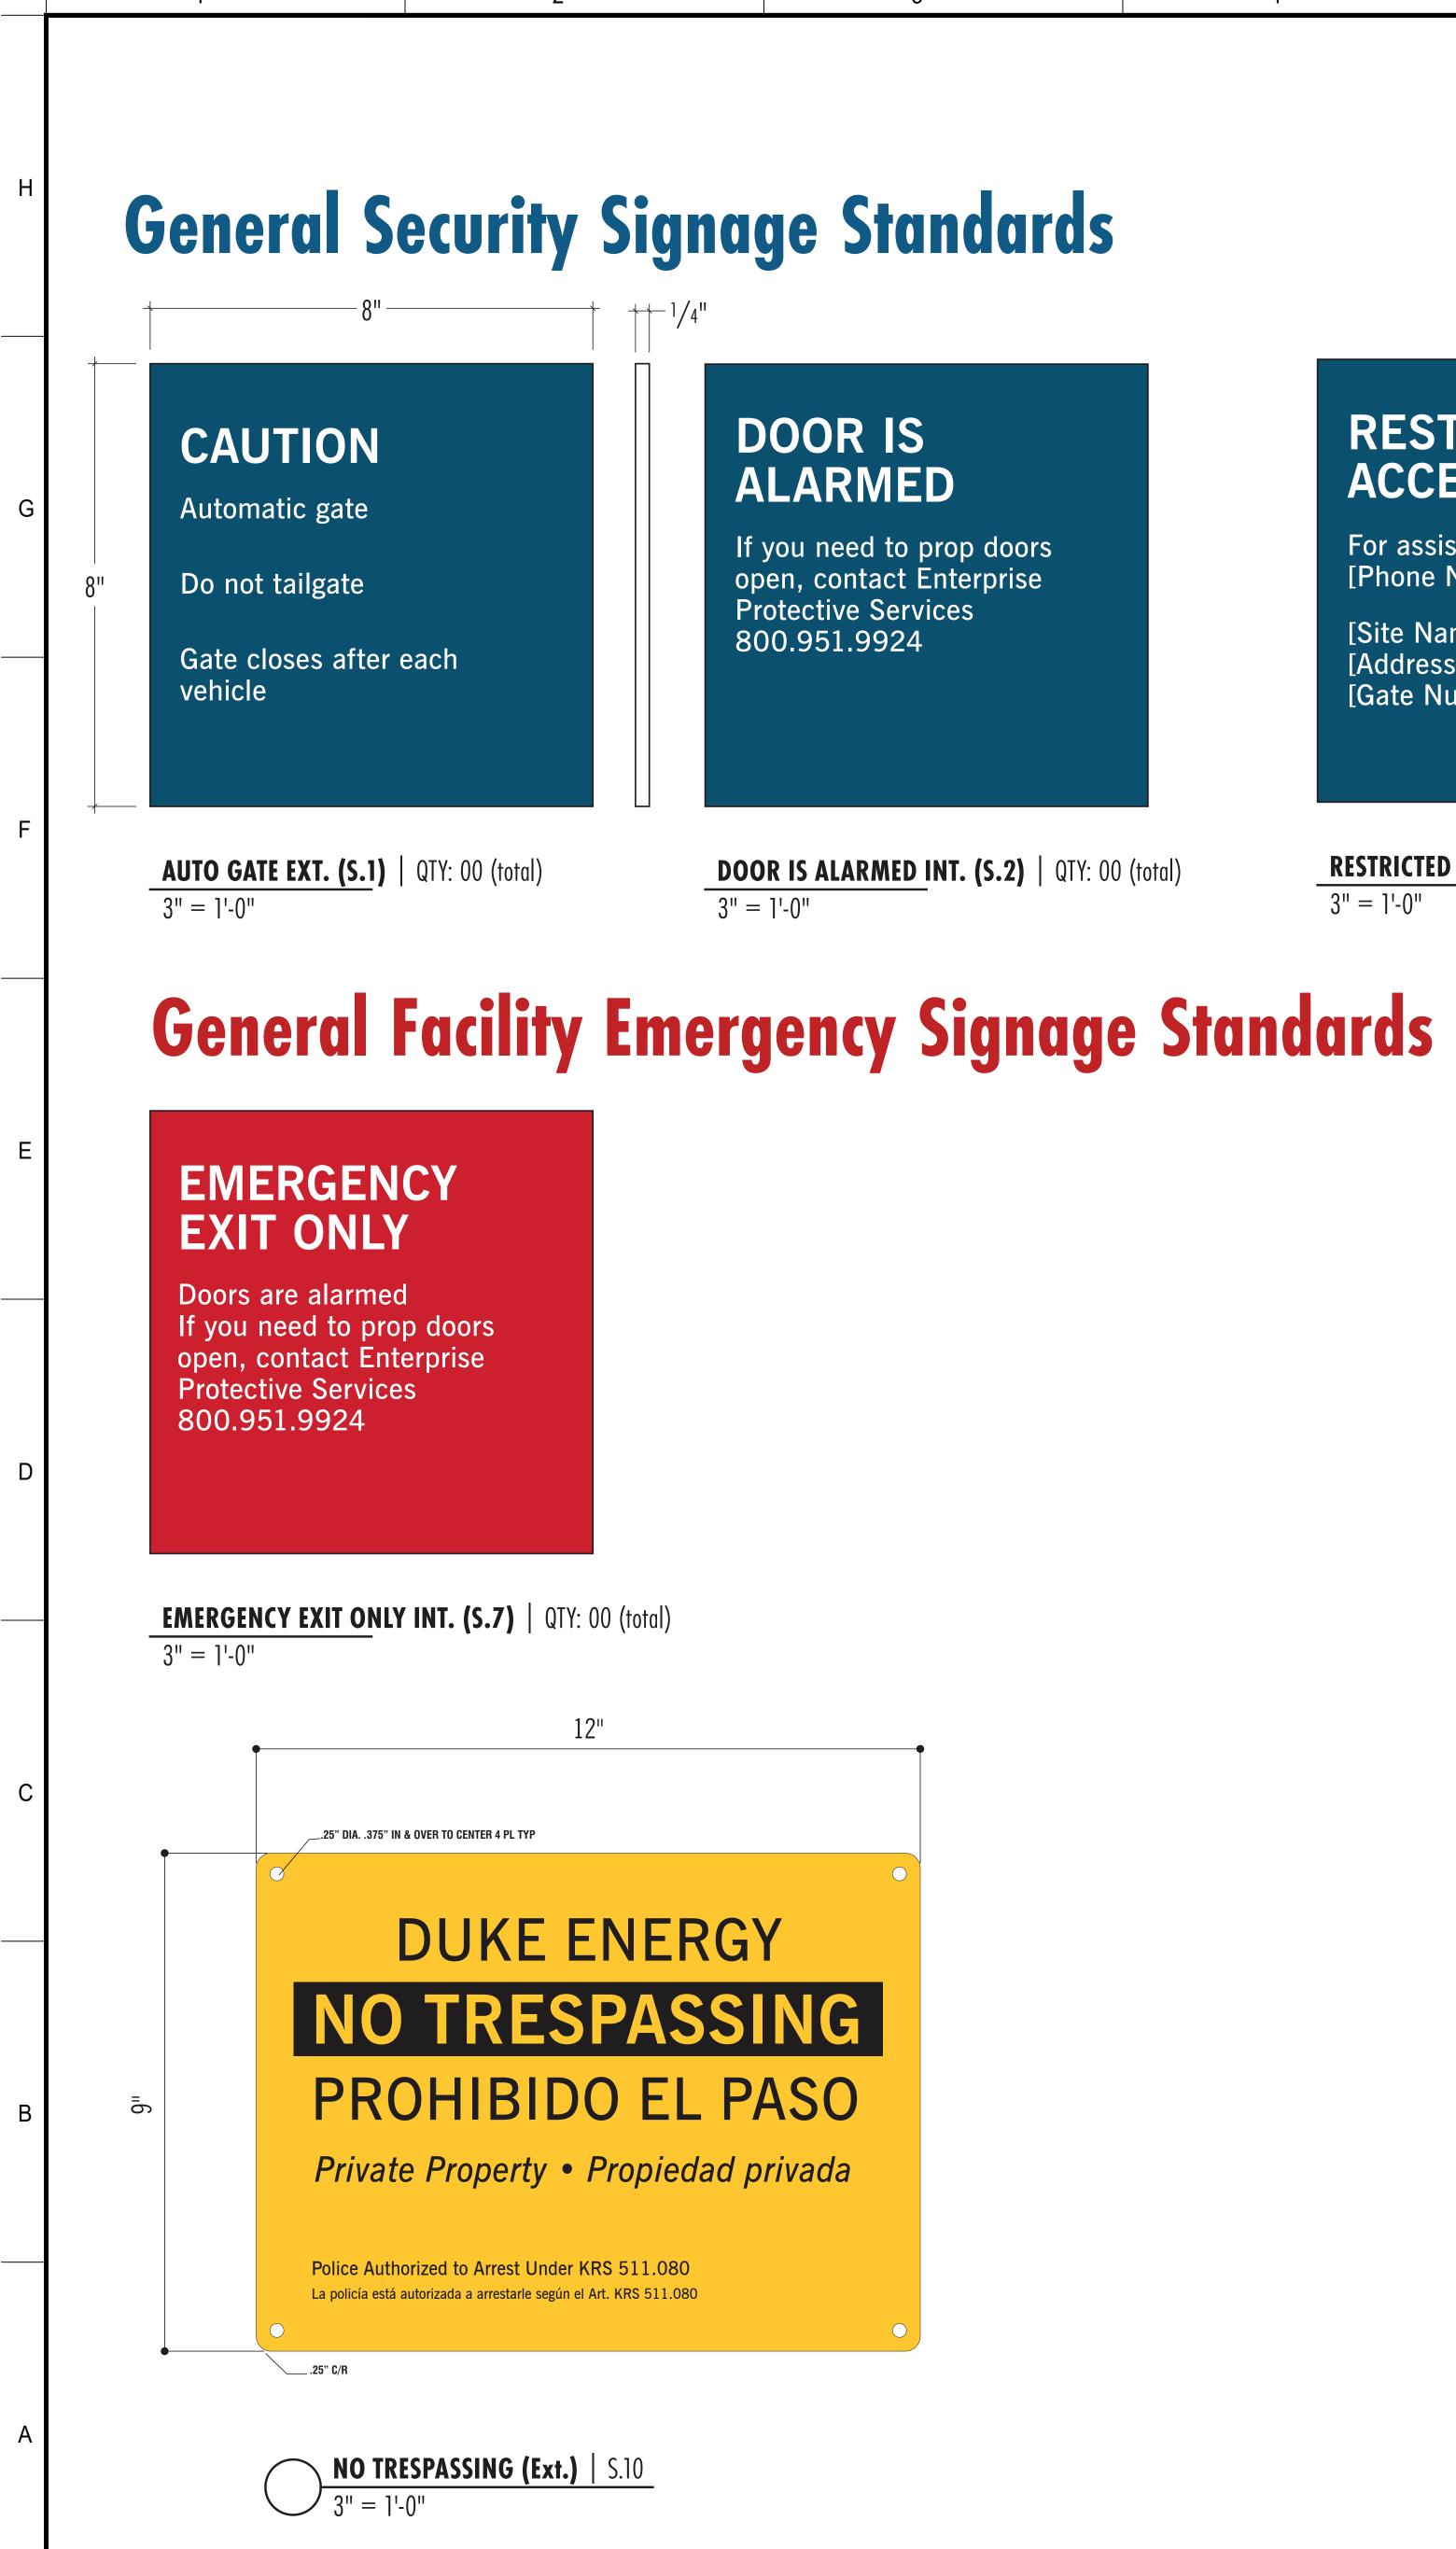

RESTRICTED ACCESS AREA

For assistance call [Phone Number]

[Site Name] [Address] [Gate Number]



RESTRICTED ACCESS EXT. (S.5) | QTY: 00 (total) 3" = 1'-0"

3" = 1'-0"

Telecom Signage


RESTRICTED ACCESS AREA

Entry by authorized individuals only.

Must be locked and secured at all times:

Contact the Telecom NOC to log entry: 1.888.600.3853

RESTRICTED ACCESS EXT. (S.9) QTY: 00 (total) 3" = 1'-0"

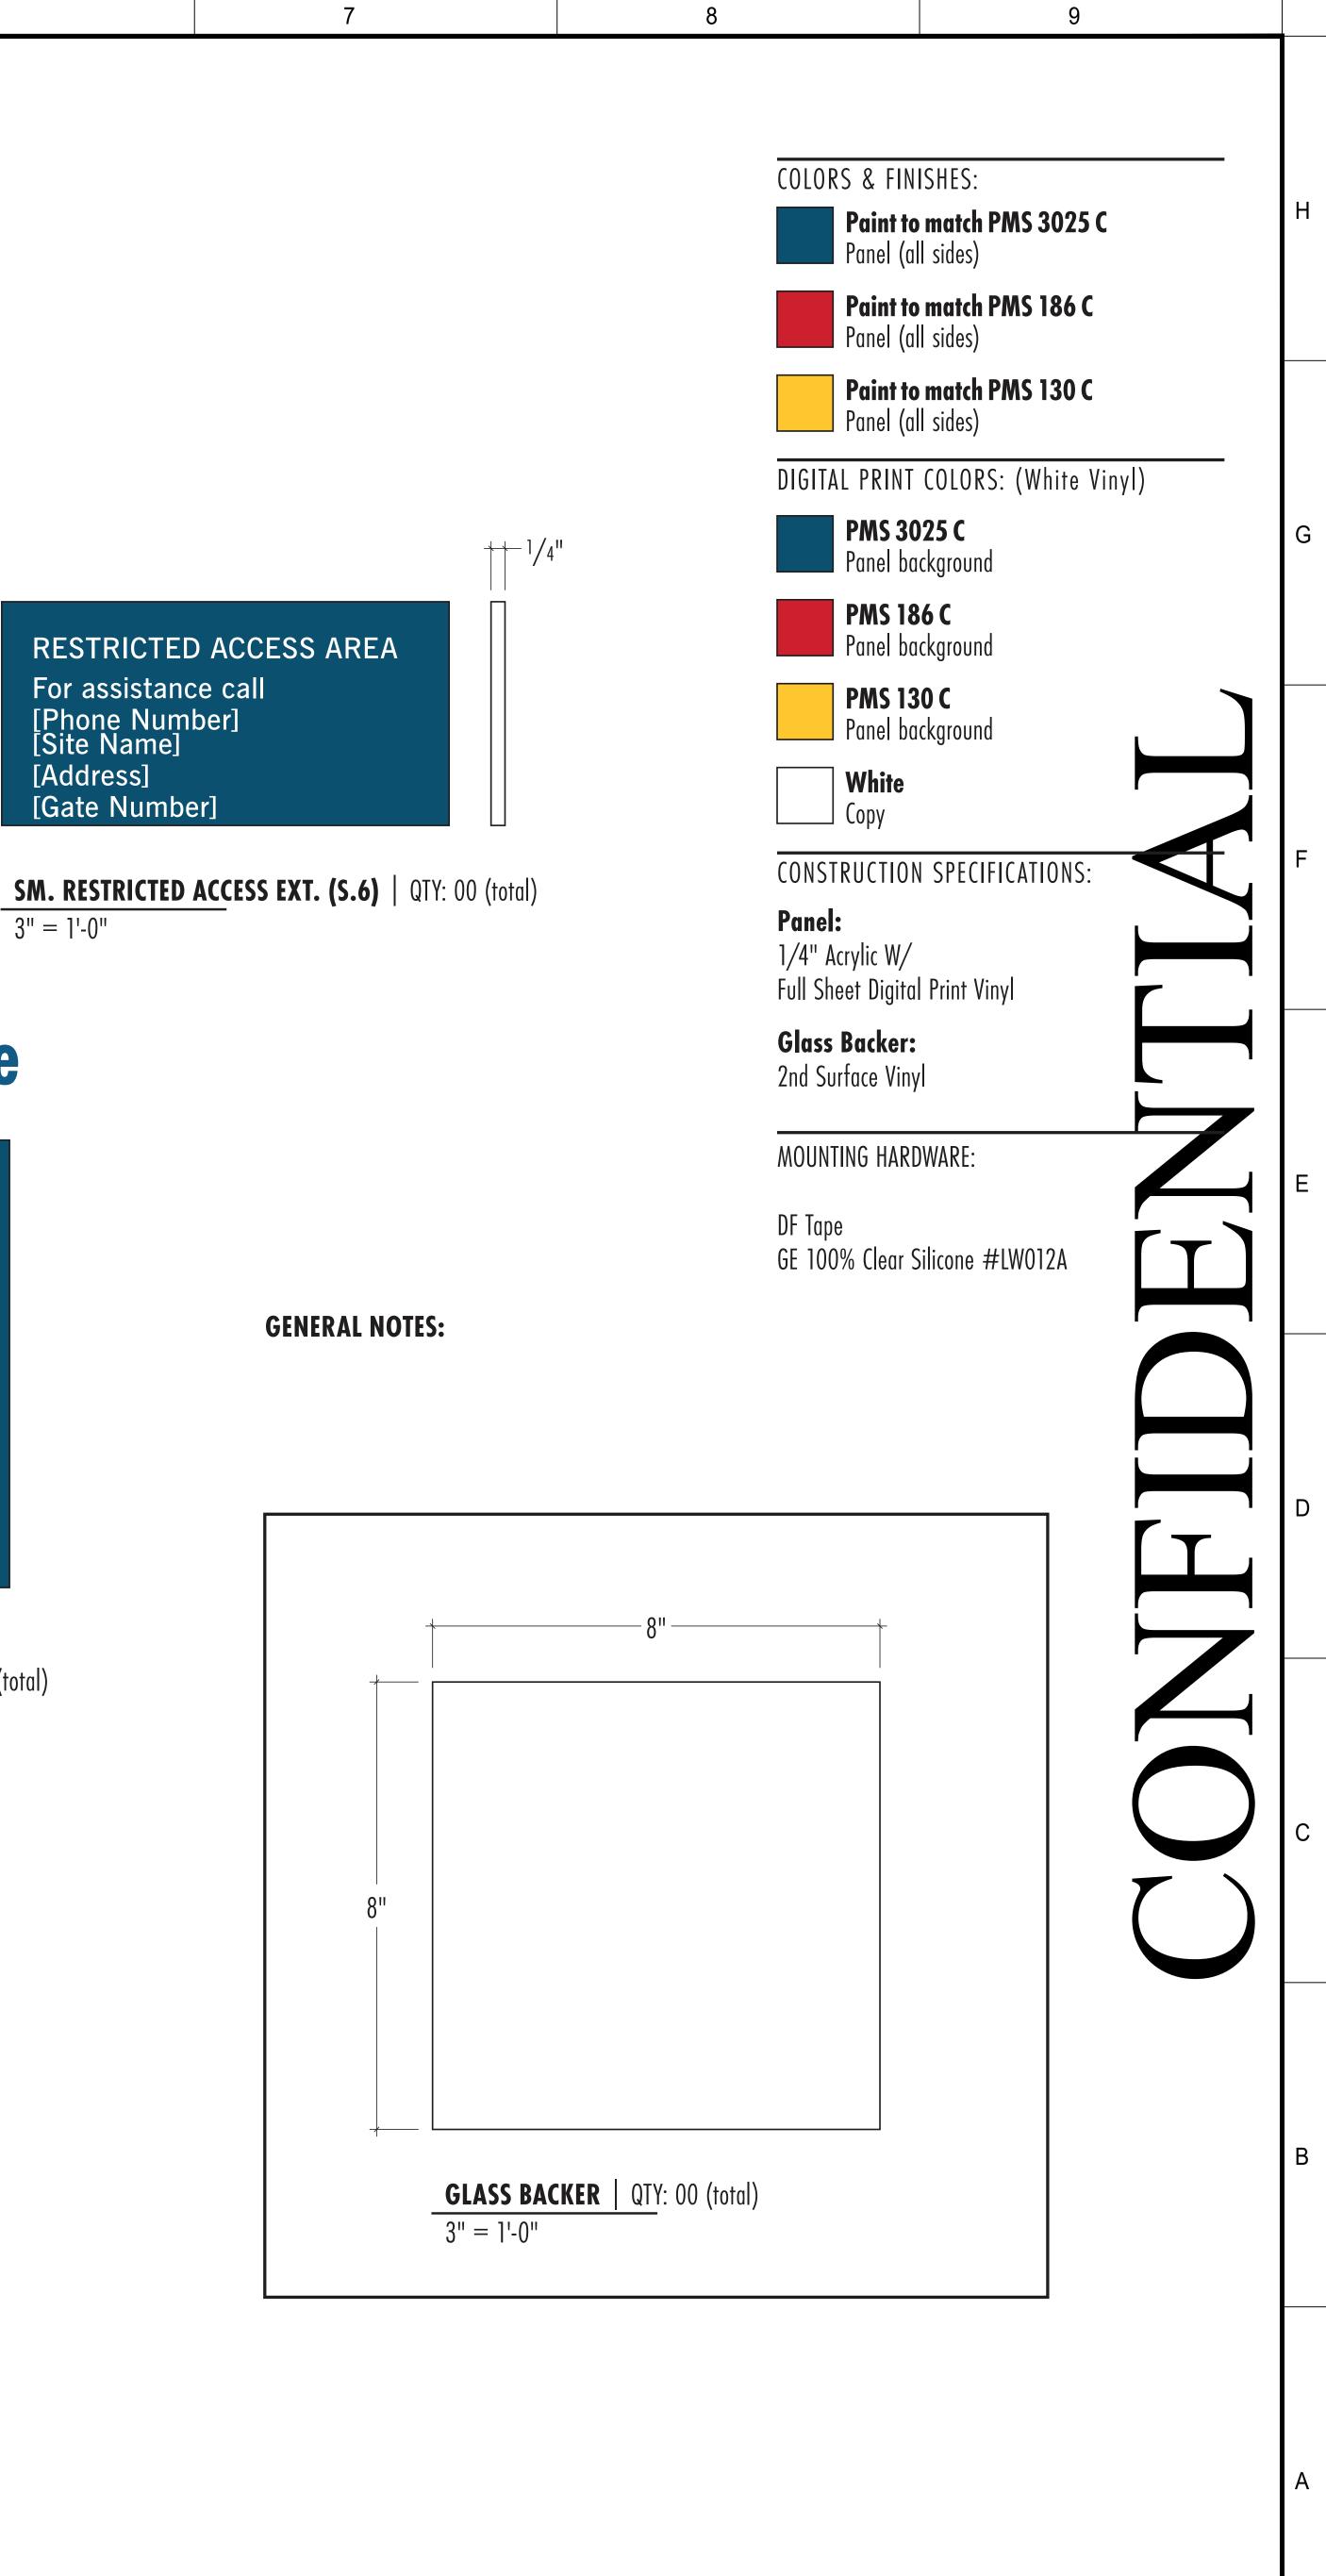

Safety Ex	pectati	ons:	
ILLNESS	Reduce Ris	sk	
	Remove Ex	xposures to H	azards
	Reinforce S	Safe Behavior	
SEAL			
DUNN (
MOBILE SUI	BSTATIC	ON STORA	AGE
DUNN, NC			
			CTION
			ISSUED FOR CONSTRUCTION
REVISION			SONS
RE			OR (
			ED F
			ISSUI
DRNBY			BB
			/23
DATE			05/24/23
MARK 0	4		
PROJECT NO:			
DRAWING NUMBER	0000		
CFD-PN000	0-EY-00	03-00000	000
ELECTRONIC FILE NA	AME:	EY-0003	
DRAWN BY:	BP	05/24/23	5
CHK'D BY:	BP	05/24/23	3
E-MAIL: BF	Paynter@paynte	RCONSULTING.COM	1
THIS DESIGN DRAWING IS CORPORATION AND IS COM MODIFIED, COPIED, OR DIS INFORMATION SHOULD ONL	NSIDERED CONFIDE	NTIAL, IT SHALL NO T PRIOR APPROVAL.	t be This
SHEET TITLE:			
SIGN I	PAC	KAG	Ē
PHYSICA			
SHEET NO.			
EY	/-0(JU3	

DUKE ENERGY® I

MAILING ADDRESS:


CHARLOTTE, NC 28201

P.O. BOX 1007

1

G

CA	CAMERA SCHEDULE					
CAMERA #	MODEL	NOTE				
08	3.0C-HD-LP-B1	3.0C-HD-L P-B1				
09	24C-H4A-3MH-270	270 DEGREE				
10	3.0C-H4VI-R01-IR	VIDEO INTERCOM				
11	3.0C-H4VI-R01-IR	VIDEO INTERCOM				
12	3.0C-HD-LP-B1	3.0C-HD-L P-B1				
13	24C-H4A-3MH-270	270 DEGREE				

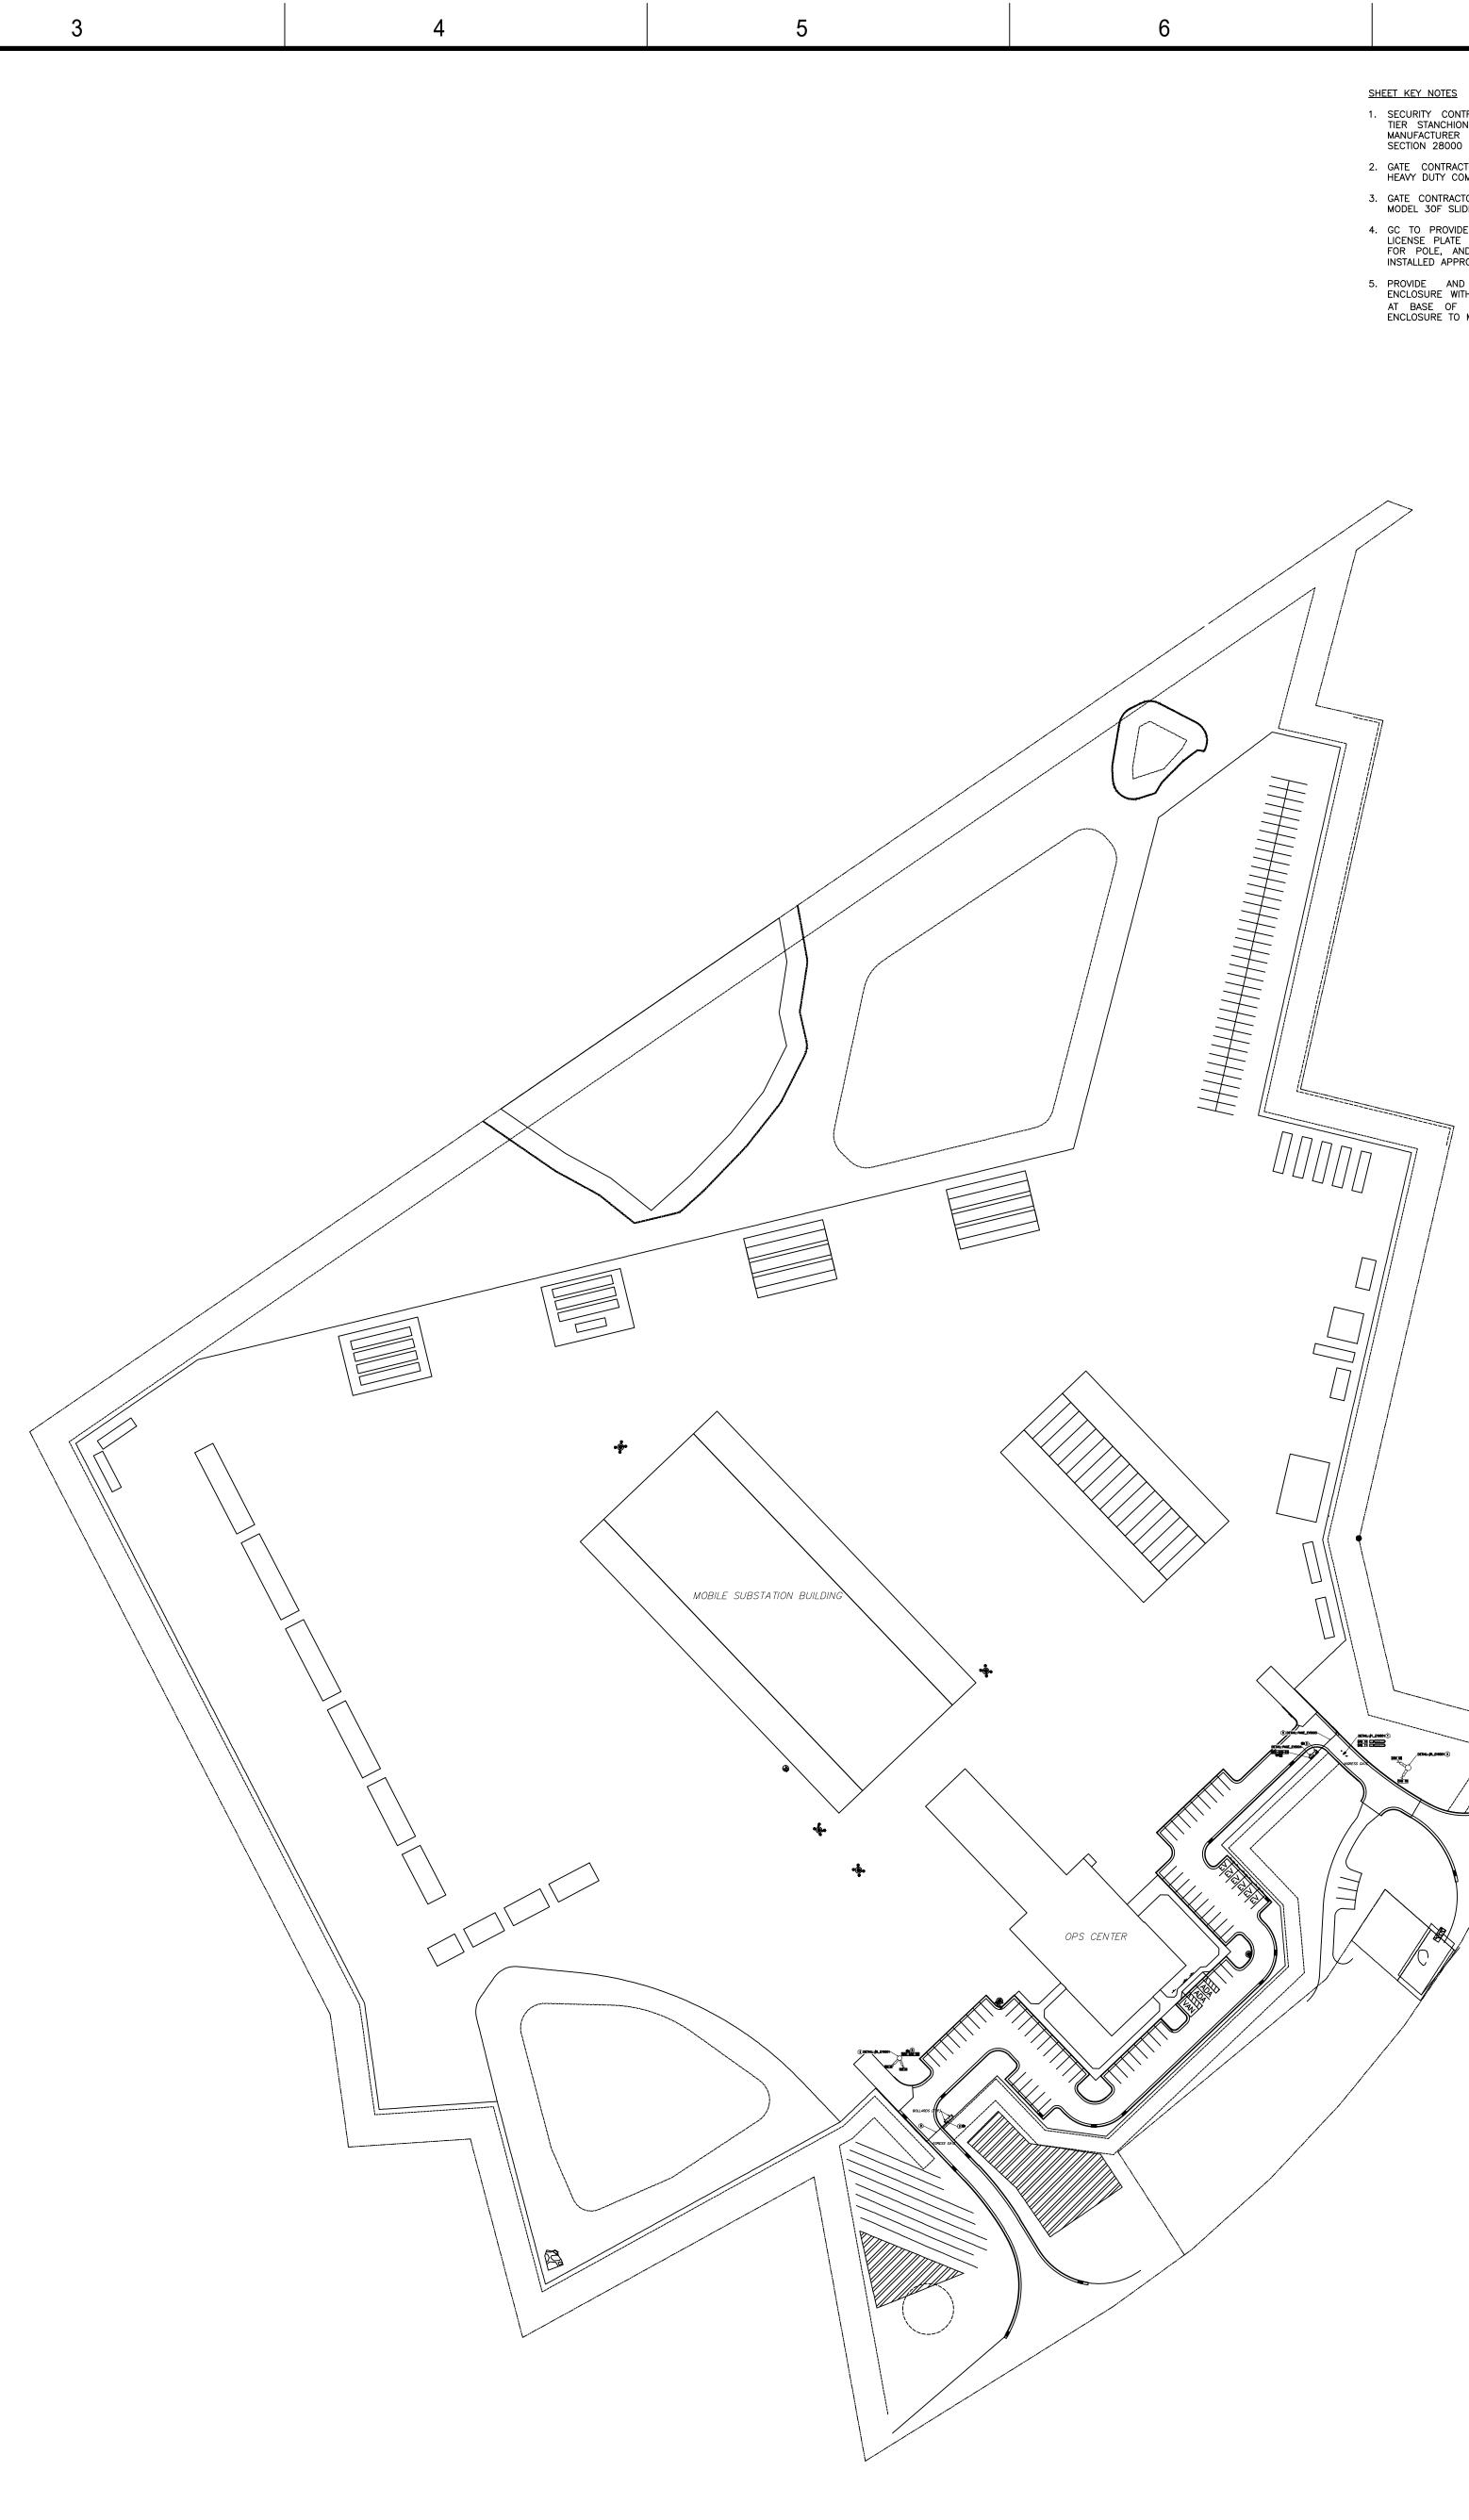

- SECURITY CONTRACTOR TO PROVIDE AND INSTALL DUAL TIER STANCHION. STANCHION AND HOUSING SHALL BE MANUFACTURER BY PARAGON METALS AS OUTLINED IN SECTION 28000 OF DEWS. 2. GATE CONTRACTOR TO PROVIDE AND INSTALL TYMETAL HEAVY DUTY COMMERCIAL CANTILEVER GATE.
- 3. GATE CONTRACTOR TO PROIVDE AND INSTALL HYSECURITY MODEL 30F SLIDE OPERATOR . 4. GC TO PROVIDE AND INSTALL METAL CAMERA POLE FOR LICENSE PLATE RECOGNITION CAMERA. REFER TO DETAIL FOR POLE, AND CONDUIT REQUIREMENTS. POLE TO BE INSTALLED APPROXIMATELY 70' FROM GATE.
- 5. PROVIDE AND INSTALL HOFFMAN A24H24BLP3PRT ENCLOSURE WITH 120VAC RECEPTACLE INSIDE ENCLOSURE AT BASE OF POLE. PROVIDE 1 ½" CONDUIT FROM ENCLOSURE TO MSS TELECOM ROOM.
- GENERAL SHEET NOTES 1. REFER TO SHEET EY-0002 FOR SYMBOL LEGEND, PROJECT NOTES.
- DUKE ENERGY TELECOM TO PROVIDE ONE (1) STATIC IP ADDRESS FOR EACH ACCESSED CONTROLLED VEHICLE GATE SHOWN ON THE DRAWINGS.
- FIBER OPTIC CONTRACTOR TO FURNISH AND INSTALL ALL FIBER OPTIC CABLE REQUIRED FOR INSTALLATION. REFER TO EY-7000 SERIES RISER DIAGRAMS FOR FIBER REQUIREMENTS. INSTALLATION SHALL BE COMPLETE TURNKEY.
- MOTOROLA SOLUTIONS TO FURNISH AND INSTALL CAMERAS, CAMERA MOUNTING BRACKETS, CAT 6 CABLE, AND VMS HARDENED PoE SWITCHES.
 - MOTOROLA SOLUTIONS TO PROVIDE VMS LICENSES, SYSTEM CONFIGURATION, AND COMMISSIONING.
 - 6. SECURITY CONTRACTOR TO FURNISH AND INSTALL ALL PACS EQUIPMENT, LOW VOLTAGE CABLE, AND COMMISSIONING.
 - GC SHALL PROVIDE AND INSTALL SECURITY SIGNS FOR THE READER STANCHIONS AND PEDESTRIAN GATE. REFERENCE EY-0003 AND DEWS SECURITY SIGN STANDARDS.
 - ELECTRICAL DOOR HARDWARE FOR PEDESTRIAN GATE SHALL BE FURNISHED AND INSTALLED BY GC. SECURITY CONTRACTOR SHALL CONNECT ELECTRIC DOOR HARDWARE TO 24 VDC POWER SUPPLY.
 - 9. ELECTRICAL CONTRACTOR TO PROVIDE DEDICATED 120VAC 20AMP ELECTRICAL CIRCUITS FOR EACH VEHICLE GATE OPERATORS AND NEMA 4 ENCLOSURE. REFER TO SPECIFIC DETAILS FOR MORE INFORMATION.
 - 10. CONDUIT REQUIREMENTS FOR EACH VEHICLE GATE IS SHOWN ON EY-5002.

- DENOTES CONDUIT ROUGH-IN FOR SECURITY DEVICE. REFER TO DEVICE DETAIL FOR MORE INFORMATION.
- DENOTES DEDICATED, UNSWITCHED 120VAC ELECTRICAL CONNECTION FOR PACS EQUIPMENT.
- DENOTES DATA CONNECTION FOR PACS AND VMS EQUIPMENT.

F D

С

В

MAILING ADDRESS P.O. BOX 1007 CHARLOTTE, NC 28			
Safety Ex	kpecta	tions:	
ILLNESS ZERO INJURY	Reduce I		
SEAL			
DUNN (MOBILE SU			
DUNN, NC			
			ICTION
REVISION			SSUED FOR CONSTRUCTION
DRN BY			
PROJECT NO:		000 4 2 2 2 2 2 2 2 2 2 2 2 2 2 2 2 2 2	<u>/1</u> 05/24/23
CFD-PN000)0-EY-0	100-0000	00000
ELECTRONIC FILE N	IAME: BP	EY-0100 05/24/	23
CHK'D BY: E-MAIL: B THIS DESIGN DRAWING IS CORPORATION AND IS CO MODIFIED, COPIED, OR DI INFORMATION SHOULD ON INTENDED.	THE EXCLUSIVE	IDENTIAL. IT SHALL OUT PRIOR APPROV	COM KE ENERGY NOT BE VAL. THIS
SHEET TITLE: GATE A PHYSIC			
SHEET NO.	/- 0	100)

DUKE ENERGY®


Н

G

	1

G

(CAMERA SCHEDU	JLE
CAMERA #	MODEL	NOTE
1	24C-H4A-3MH-270	CORNER MOUNT
2	24C-H4A-3MH-180	WALL MOUNT
3	24C-H4A-3MH-180	WALL MOUNT
4	24C-H4A-3MH-180	WALL MOUNT
5	24C-H4A-3MH-180	WALL MOUNT
6	24C-H4A-3MH-270	CORNER MOUNT
7	4.0C-H5A-D01-IR	INTERIOR MOUNT

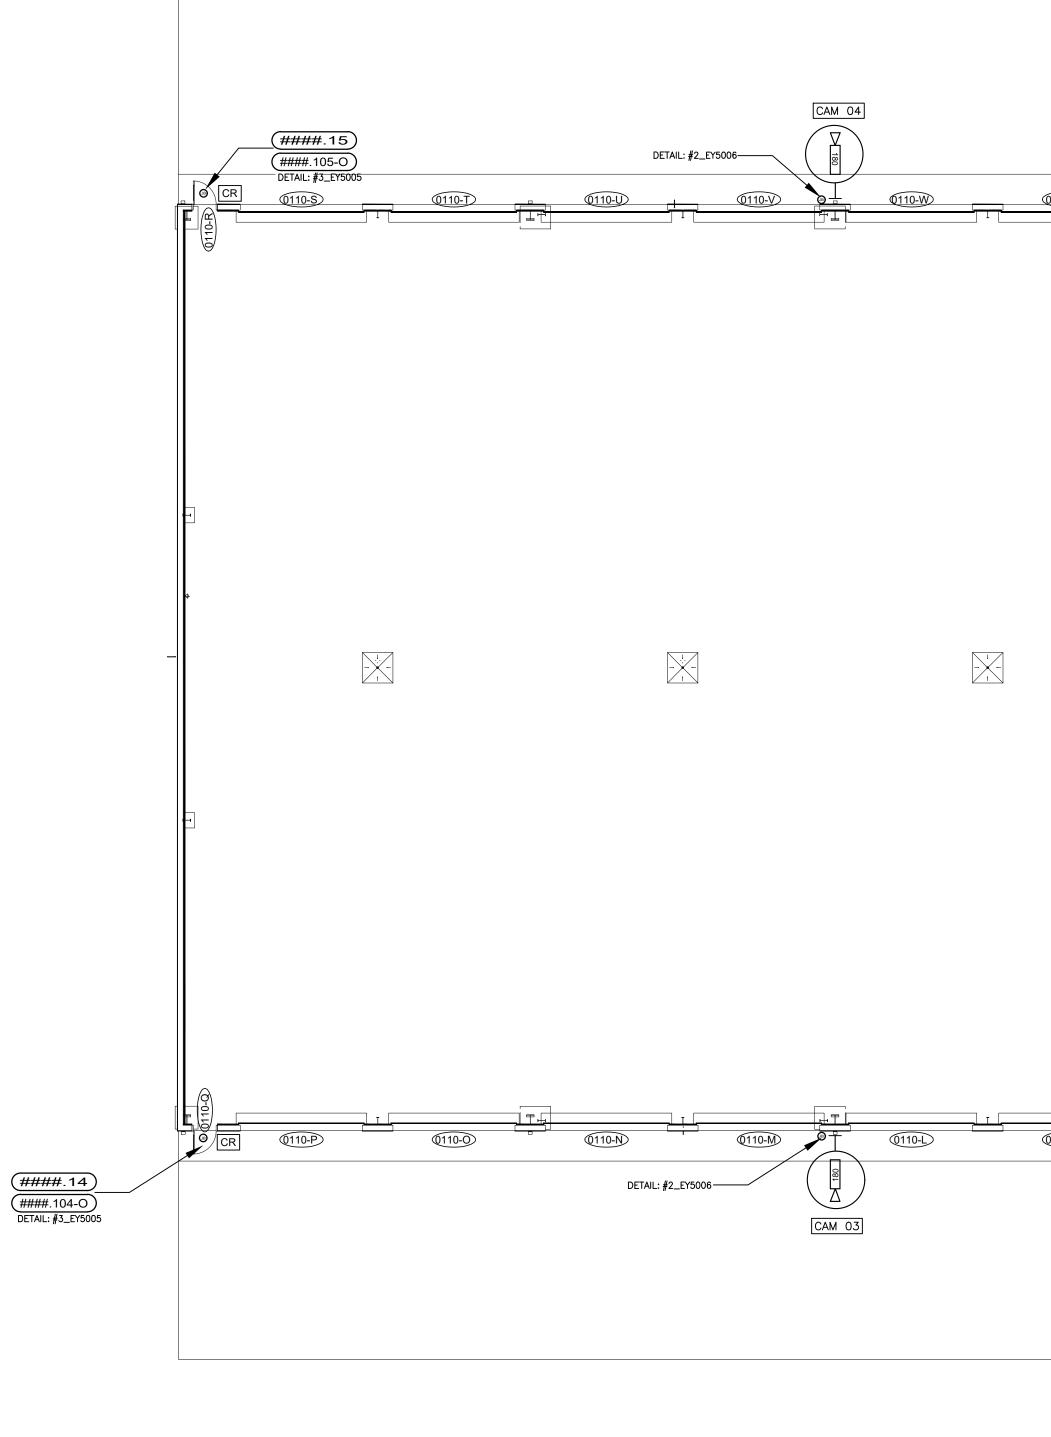

В

1	-
ł	
•	-

ELECTRI	CAL AND DATA SYMBOLS
JB	DENOTES CONDUIT ROUGH-IN FOR REFER TO DEVICE DETAIL FOR MOI
\ominus	DENOTES DEDICATED, UNSWITCHED CONNECTION FOR PACS EQUIPMEN
	DENOTES DATA CONNECTION FOR I EQUIPMENT.

					DETAIL: #2_E	/5006	CAM 05				
(0110-X)	(0110-Y)	(0110-Z)	_	Q110-AA		Q110-BB		Q110-CC	Q110-DD	Q110-EE	
	TRUCK BAYS										
		-									
		2									
											\sim
											2 DETAIL
											DETAIL
											(
		<u> </u>									
0110-K	@110-J	0110-1		0110-H)		@110-G		0110-F	(0110-E)	@110-D	
				DET	AIL: #2_EY5006—						(####.
							CAM 02				(####.10 DETAIL: #3_

|--|

ROUGH-IN FOR SECURITY DEVICE. DETAIL FOR MORE INFORMATION.

, UNSWITCHED 120VAC ELECTRICAL ACS EQUIPMENT.

NECTION FOR PACS AND VMS


<u>SHEET KEY NOTES</u>

REQUIREMENTS.

- CONNECTION FOR FCP AND 12 / 24 VDC POWER SUPPLY CABINETS. COORDINATE LOCATION OF ELECTRICAL CONNECTION WITH SECURITY STATIC IP ADDRESS FOR THE FCP SHOWN ON CONNECTION.
- 3. APPROXIMATE LOCATION OF WALL MOUNTED VIDEO MANAGEMENT EQUIPMENT CABINET. REFER TO DETAIL PAGE FOR CONDUIT AND POWER
- <u>GENERAL SHEET NOTES</u>
- 1. ELECTRICAL CONTRACTOR TO PROVIDE ONE WALL
 1. REFER TO SHEET EY-0002 FOR SYMBOL LEGEND,

 MOUNTED
 DEDICATED
 120VAC
 ELECTRICAL
 1. REFER TO SHEET EY-0002 FOR SYMBOL LEGEND,

 PROJECT NOTES.
 PROJECT NOTES.
 - THE DRAWINGS.
- APPROXIMATE LOCATION OF WALL MOUNTED FCP AND POWER SUPPLY CABINETS. REFER TO DETAIL FOR CONDUIT AND POWER REQUIREMENTS.
 3. DUKE ENERGY TELECOM TO PROVIDE TWO (2) STATIC IP ADDRESSES FOR THE VMS SERVER.
 - MOTOROLA SOLUTIONS TO FURNISH AND INSTALL CAMERAS, CAMERA MOUNTING BRACKETS, CAT 6 CABLE, VMS SERVER AND VMS PoE SWITCH. 5. MOTOROLA SOLUTIONS TO PROVIDE VMS LICENSES,
 - SYSTEM CONFIGURATION, AND COMMISSIONING. 6. SECURITY CONTRACTOR TO FURNISH AND INSTALL ALL PACS EQUIPMENT, LOW VOLTAGE CABLE, AND COMMISSIONING.
 - 7. GC SHALL PROVIDE AND INSTALL SECURITY SIGNS FOR CARD READER DOORS SHOWN ON THE DRAWING. REFERENCE EY-0003 AND DEWS SECURITY SIGN STANDARDS.
 - 8. ELECTRICAL DOOR HARDWARE FOR CARD READER DOORS SHALL BE FURNISHED AND INSTALLED BY GC. SECURITY CONTRACTOR SHALL CONNECT ELECTRIC DOOR HARDWARE TO 24 VDC POWER SUPPLY.
 - REFER TO DEWS SECTION 0800 APPROVED ELECTRIC DOOR HARDWARE TYPE.

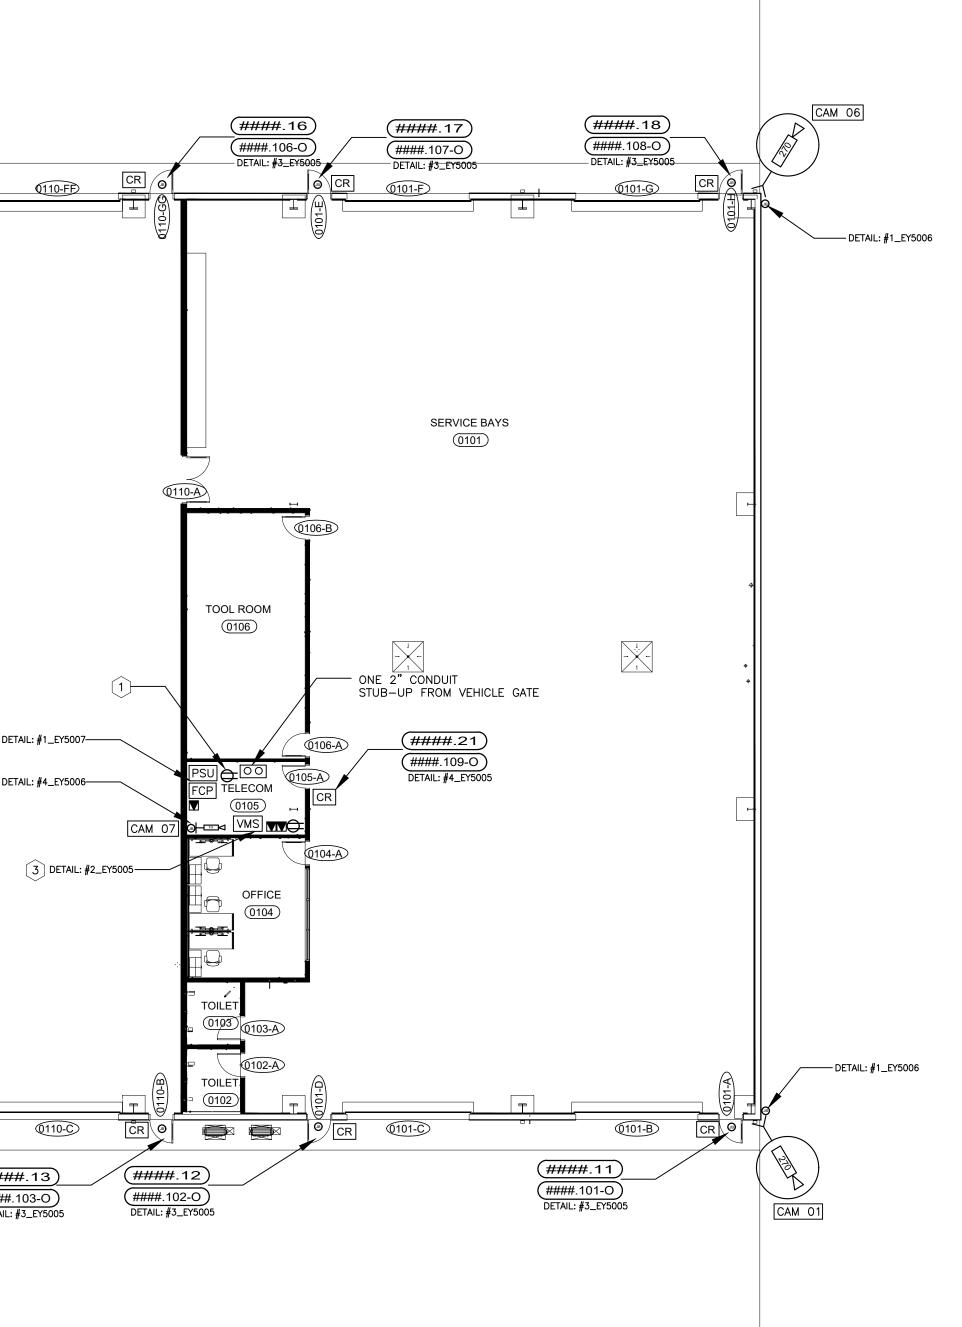

В

SEAL				
DUNN MOBILE SU				
DUNN, NC				
				[]
				UCTION
REVISION				R CONSTR
				SSUED FOR CONSTRUCTIO
DRN BY				BP
DATE				05/24/23
PROJECT NO: DRAWING NUMBER	2	00000		
CFD-PN000		-0110-0		000
DRAWN BY: CHK'D BY:	BP	0	5/24/23 5/24/23	
E-MAIL: THIS DESIGN DRAWING IS CORPORATION AND IS CO MODIFIED, COPIED, OR D INFORMATION SHOULD OI	ONSIDERED CO	SIVE PROPERT DNFIDENTIAL. I ITHOUT PRIOF	Y OF DUKE I IT SHALL NOT R APPROVAL.	ENERGY BE THIS
SHEET TITLE:	BSTAT	TION S	TORA	GE
PHYSIC	AL S	SECU	JRIT	Ϋ́
E	Y- C)11	0	

Safety Expectations: [ILLNESS] Reduce Risk

ZERO Remove Exposures to Hazards Reinforce Safe Behavior

MAILING ADDRESS: P.O. BOX 1007 CHARLOTTE, NC 28201

H


G

F

Ε

D

С

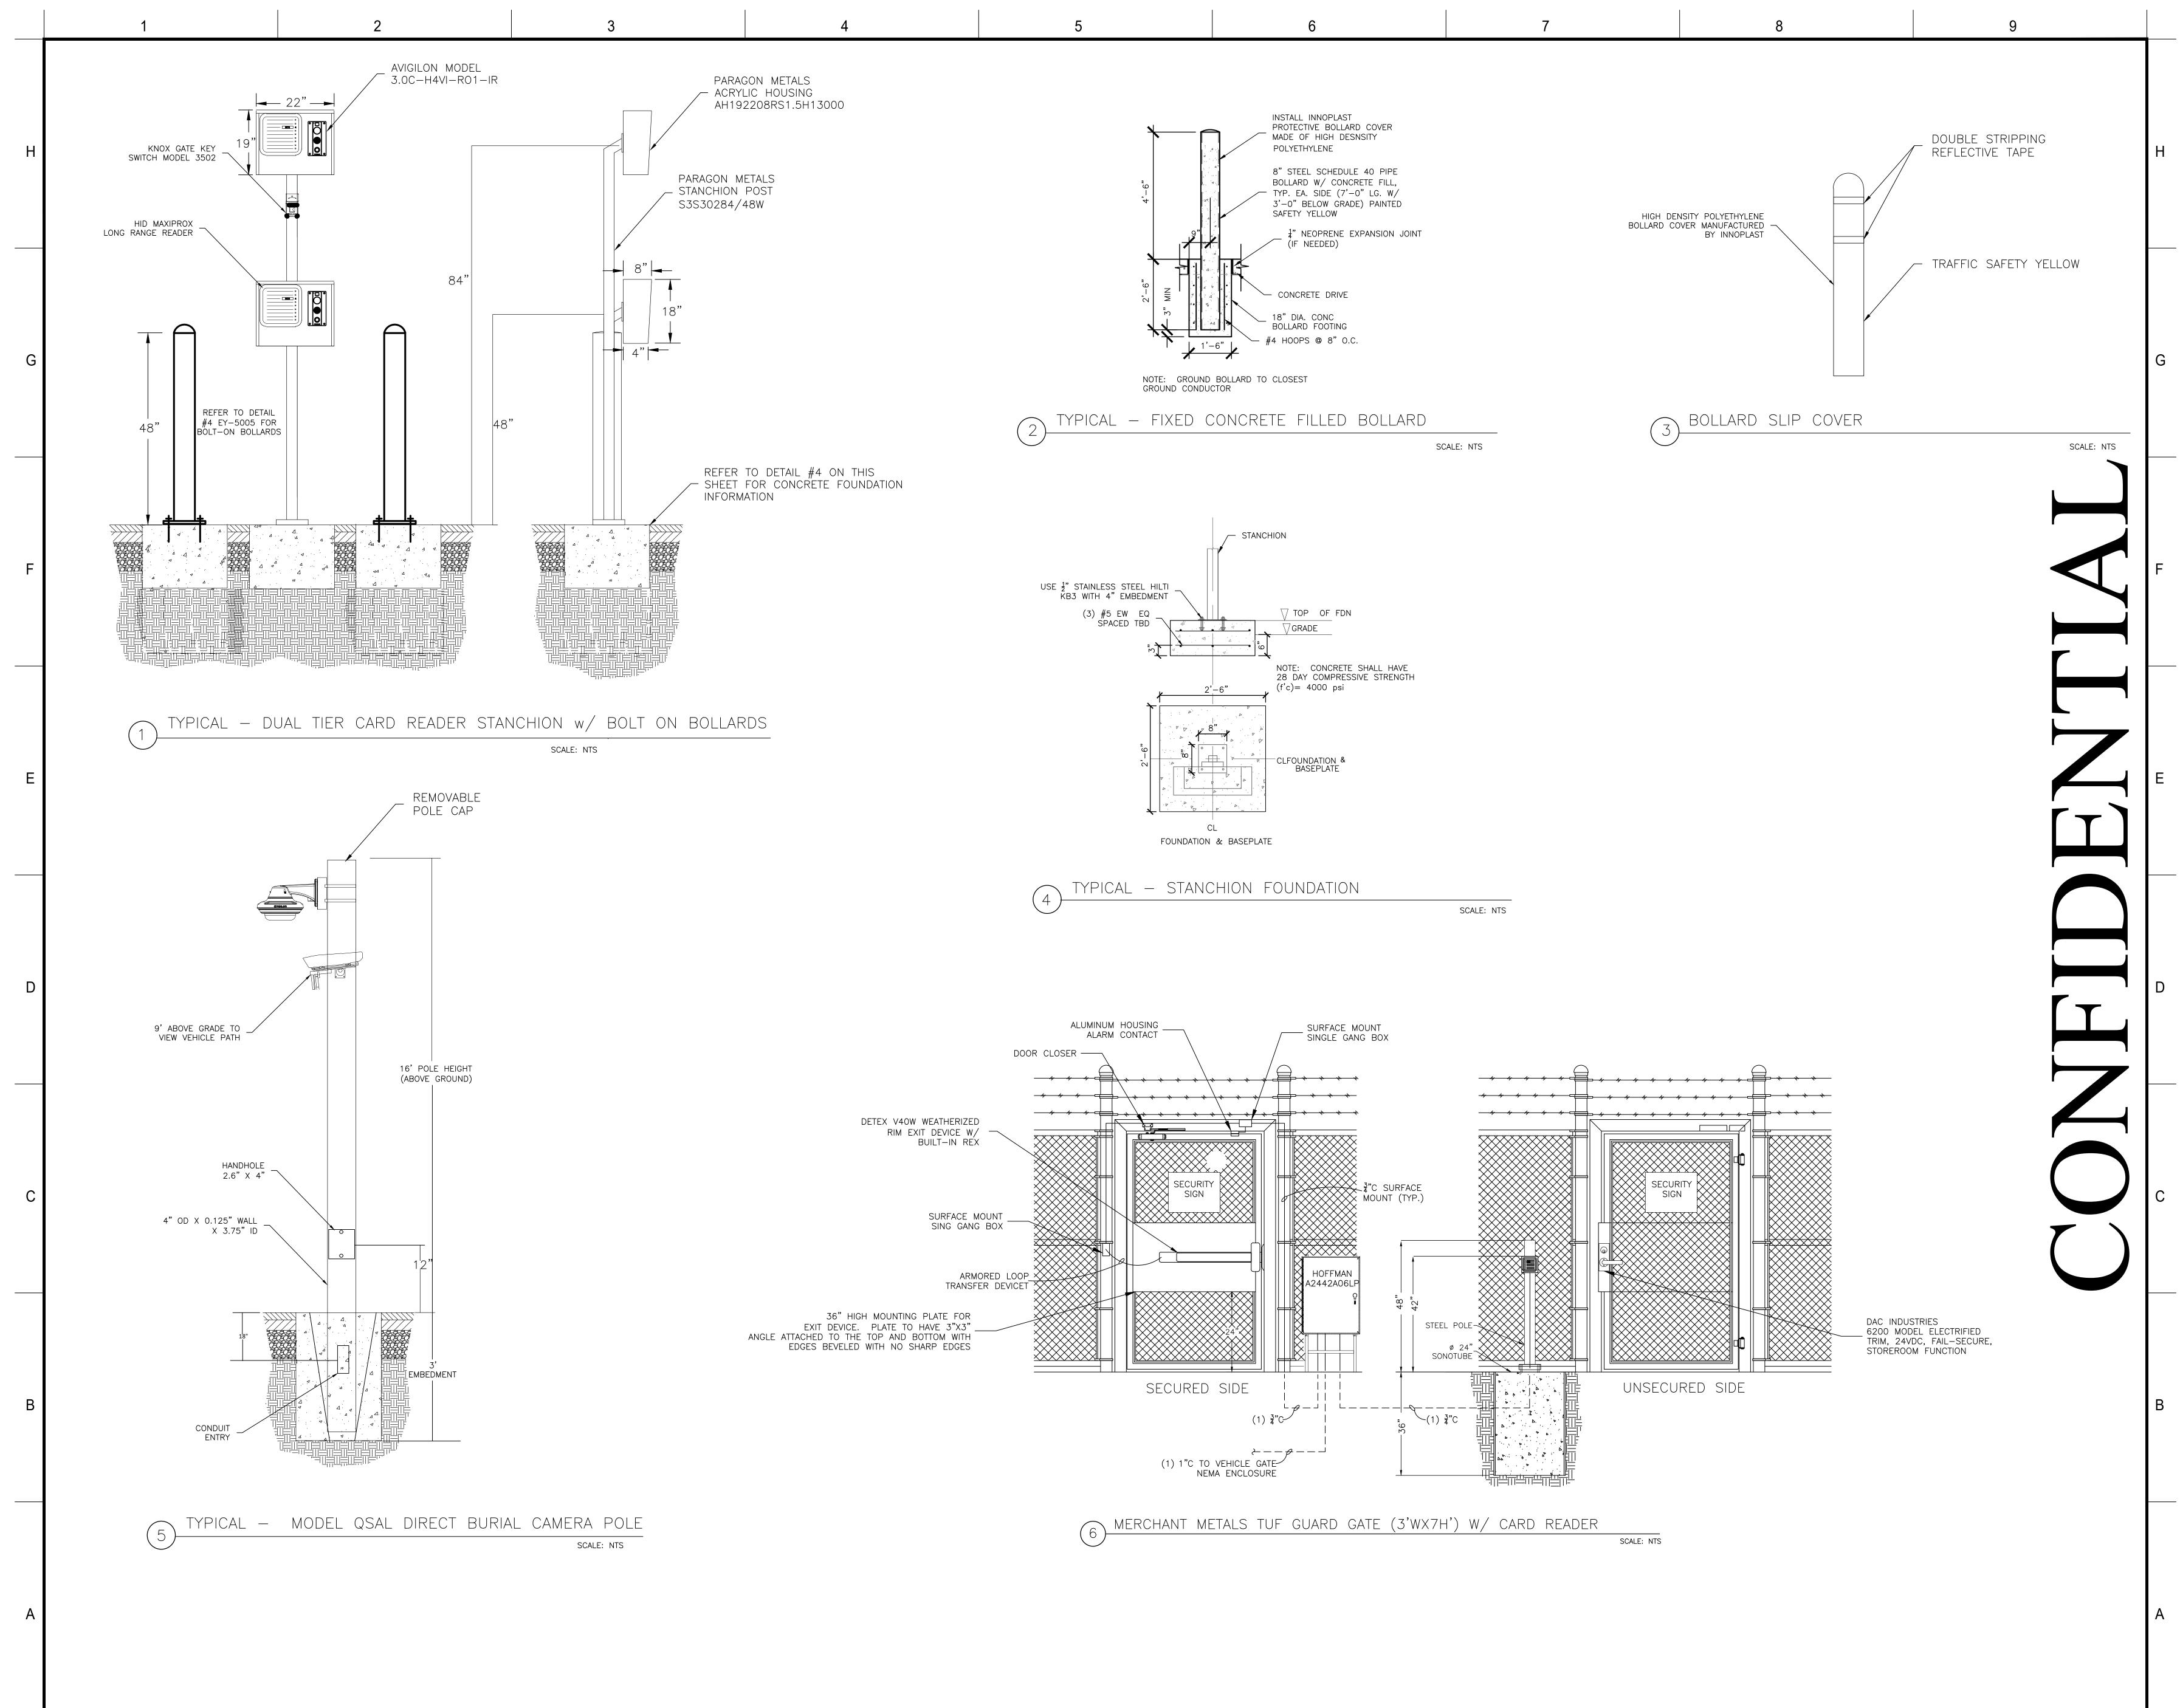

DU	JNN	, NC								
REVISION										ISSUED FOR CONSTRUCTION
DRN BY										ВР
DATE										05/24/23
MAR 4 6 6 6 6 6 6 6 6 6 6 6 6 6 6 6 6 6 6										\bigcirc
PROJECT NO: 00000										
	awing F D-				FV	50	01	იიი	າດດເ	აიი
		·1 1 N		J0-1		-50	01-			
	ECTRO		FILEN	NAME			EY-5			
	AWN E				BP			5/24		
CHK'D BY: BP 05/24/23										
E-MAIL: BPAYNTER@PAYNTERCONSULTING.COM THIS DESIGN DRAWING IS THE EXCLUSIVE PROPERTY OF DUKE ENERGY CORPORATION AND IS CONSIDERED CONFIDENTIAL. IT SHALL NOT BE MODIFIED, COPIED, OR DISTRIBUTED WITHOUT PRIOR APPROVAL. THIS INFORMATION SHOULD ONLY BE USED FOR THE SPECIFIC PROJECT INTENDED. SHEET TITLE: INSTALLATION DETAILS PHYSICAL SECURITY										
P]	ΗY	(S	IC	AI		SE	Cl	JR	TL	'Y
SH	EET N	0.								
		E	-	Y-	-5	50)()^	1	

DUNN OPERATIONS MOBILE SUBSTATION STORAGE

SEAL




MAILING ADDRESS:

CHARLOTTE, NC 28201

P.O. BOX 1007

Reduce Risk **ZERO** Remove Exposures to Hazards Reinforce Safe Behavior




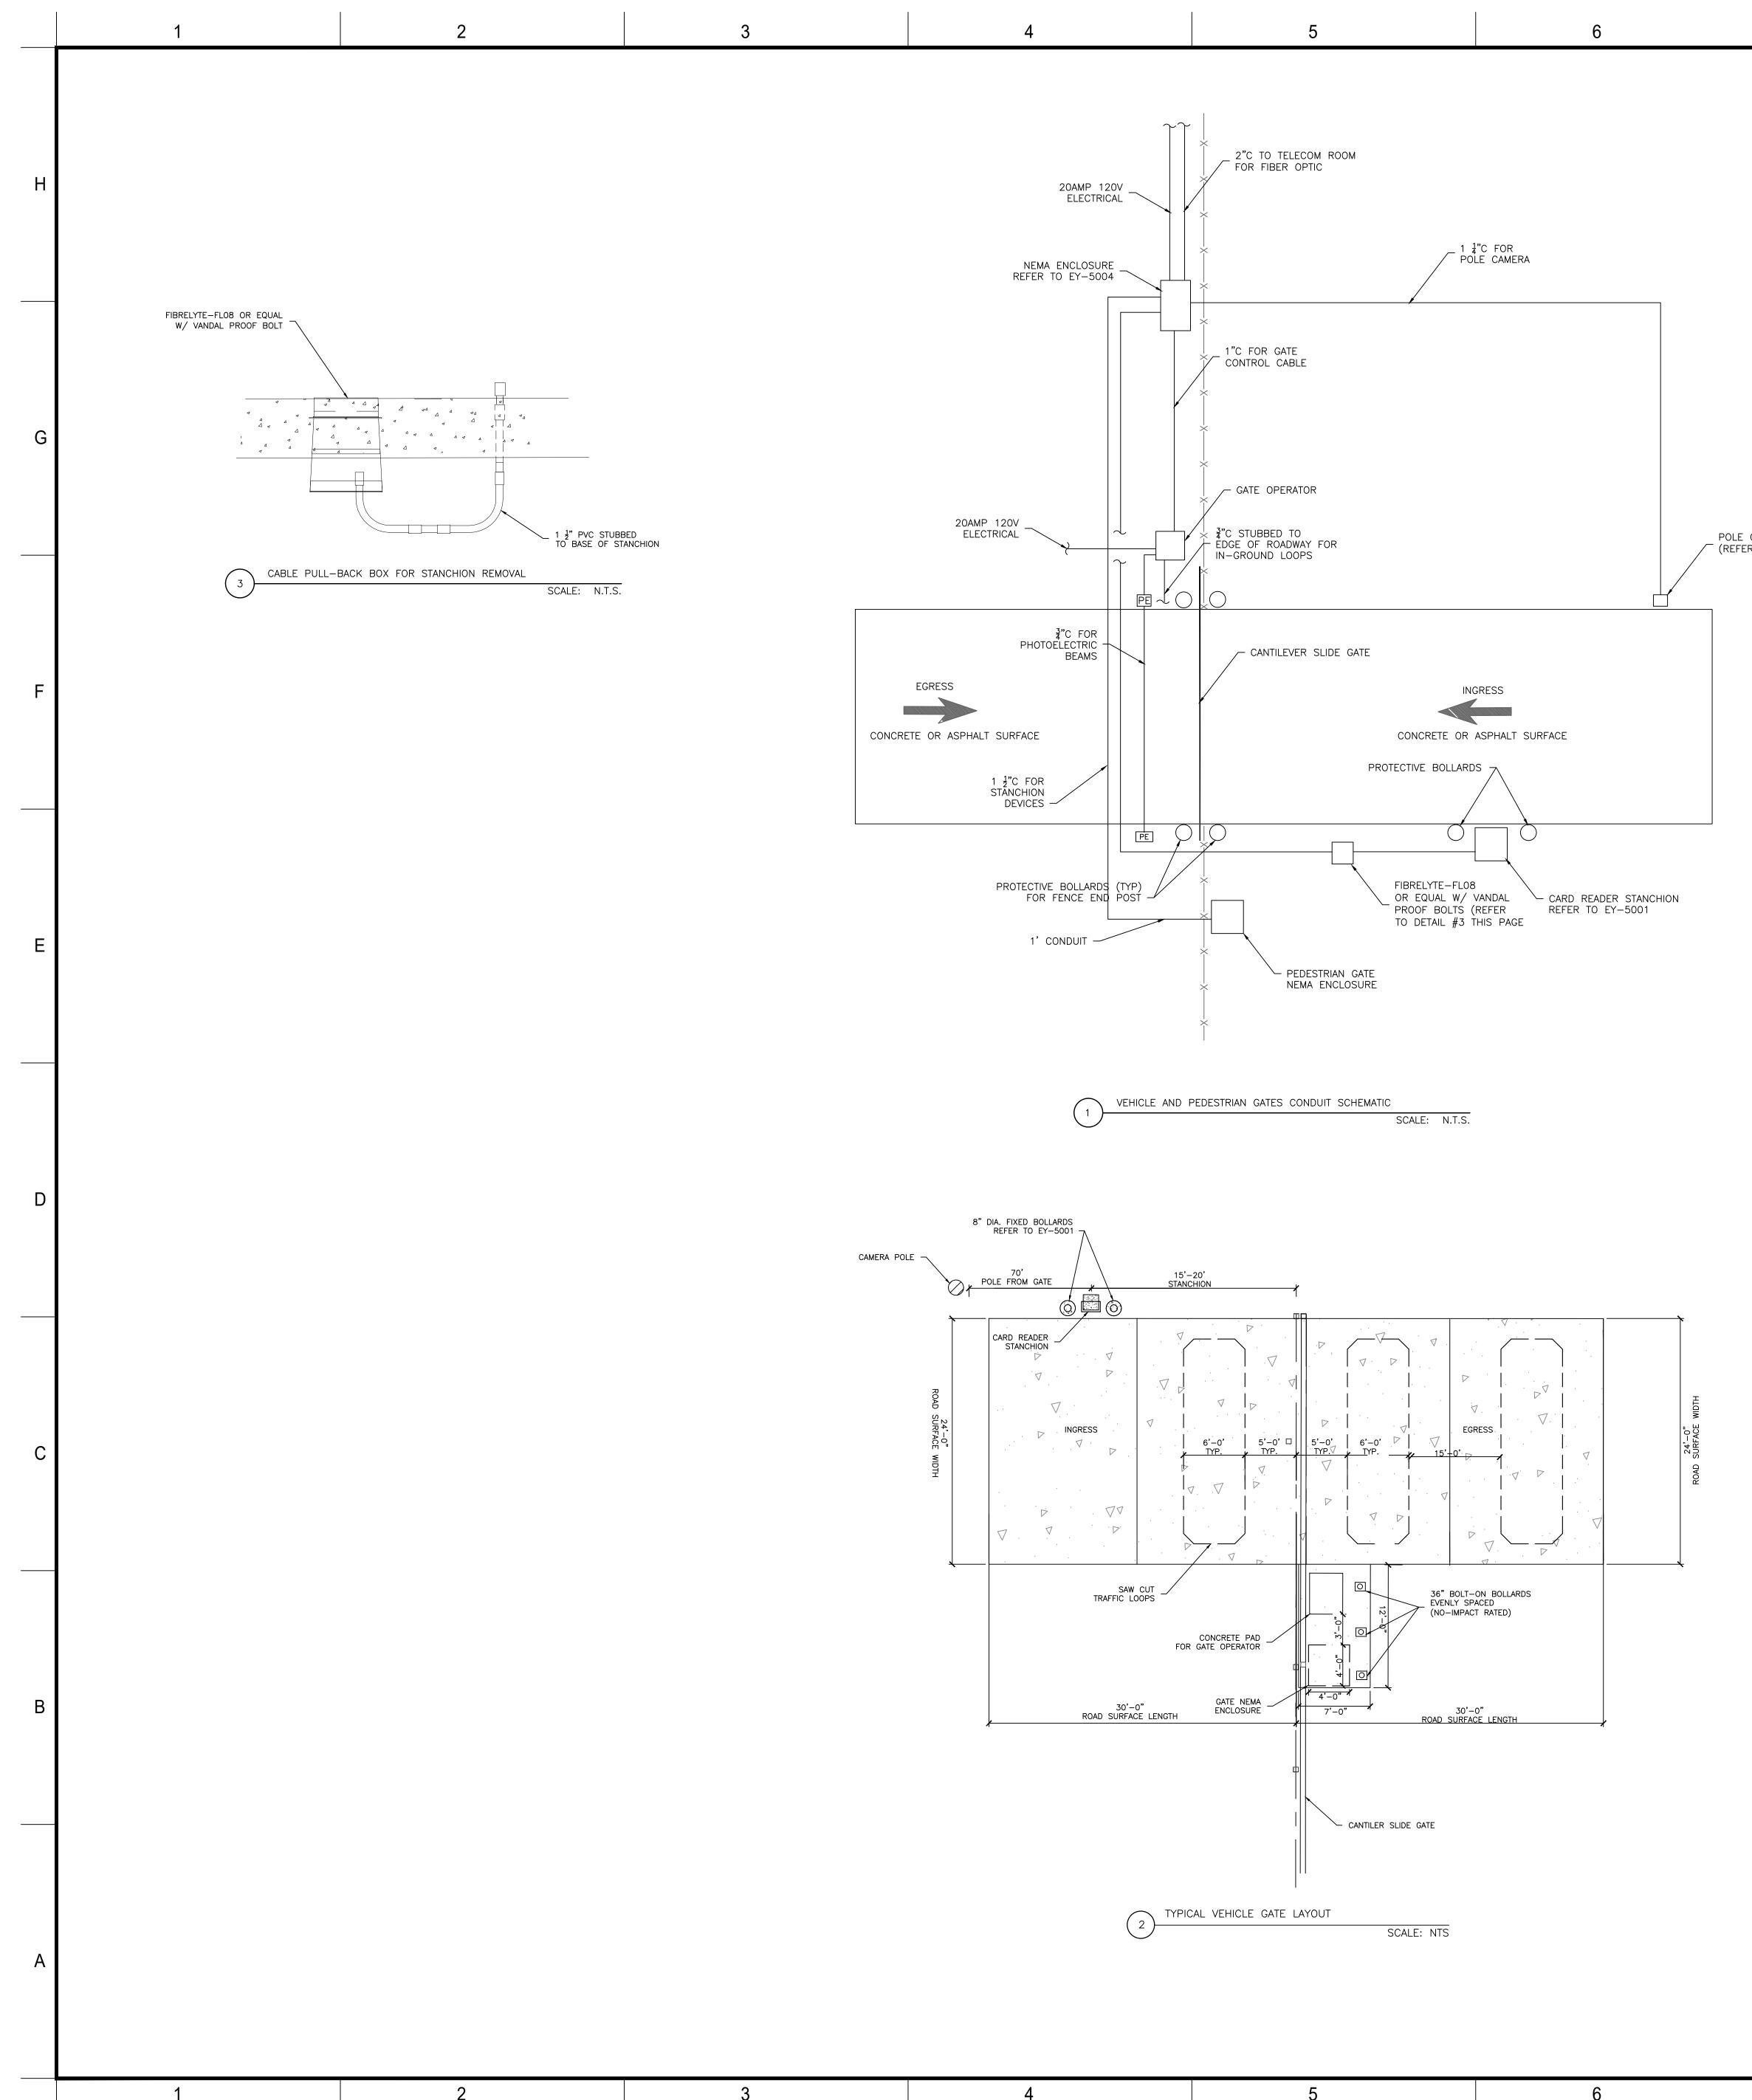

<u>GENERAL NOTES:</u>

- 2. COORDINATE UNDERGROUND CONDUITS WITH ALL FOUNDATIONS, FOOTINGS AND OTHER WORK.
- 3. ALL UNDERGROUND CONDUITS TO BE SCHEDULE 40PVC, 1 $\frac{1}{2}$ " MINIMUM SIZE OR AS NOTED ON DRAWING.

POLE CAMERA (REFER TO DETAIL PAGE)

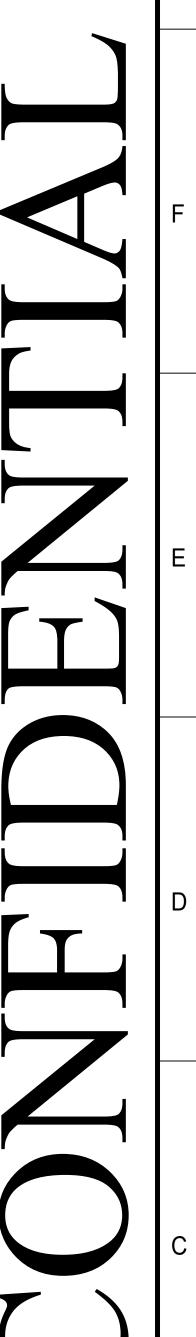


DU	JNN	, NC								
REVISION										ISSUED FOR CONSTRUCTION
DRN BY										ВР
DATE										05/24/23
MARK MARK										\bigcirc
DR	ojec ⁻ awing F D-	g nun)0-]		-50		000)000	000
ELE	ECTRO		FILE N	IAME	:		EY-5	5002		
DR	AWN I	BY:			BP		0	5/24	/23	
СН	K'D BY	<i>(</i> :			BP		0	5/24	/23	
E-MAIL: BPAYNTER@PAYNTERCONSULTING.COM										
COR MOD INFC	DESIG PORATIO FIED, O RMATIO NDED.	ON ANE) IS CO , OR D	ONSIDE	RED CO JTED W	ONFIDEN ITHOUT	NTIAL. I	T SHAL	L NOT	BE THIS
P1	HY	. .	IC.	AI			U	JR	11	Ĭ
SH	EET N	0.								
		E	-	Y.	-5	50)()2	2	

DUNN OPERATIONS MOBILE SUBSTATION STORAGE

SEAL

В

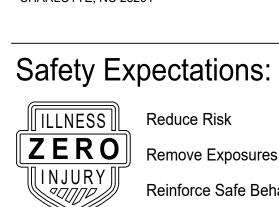


Reduce Risk **ZERO** Remove Exposures to Hazards Reinforce Safe Behavior

MAILING ADDRESS: P.O. BOX 1007 CHARLOTTE, NC 28201

Н

G



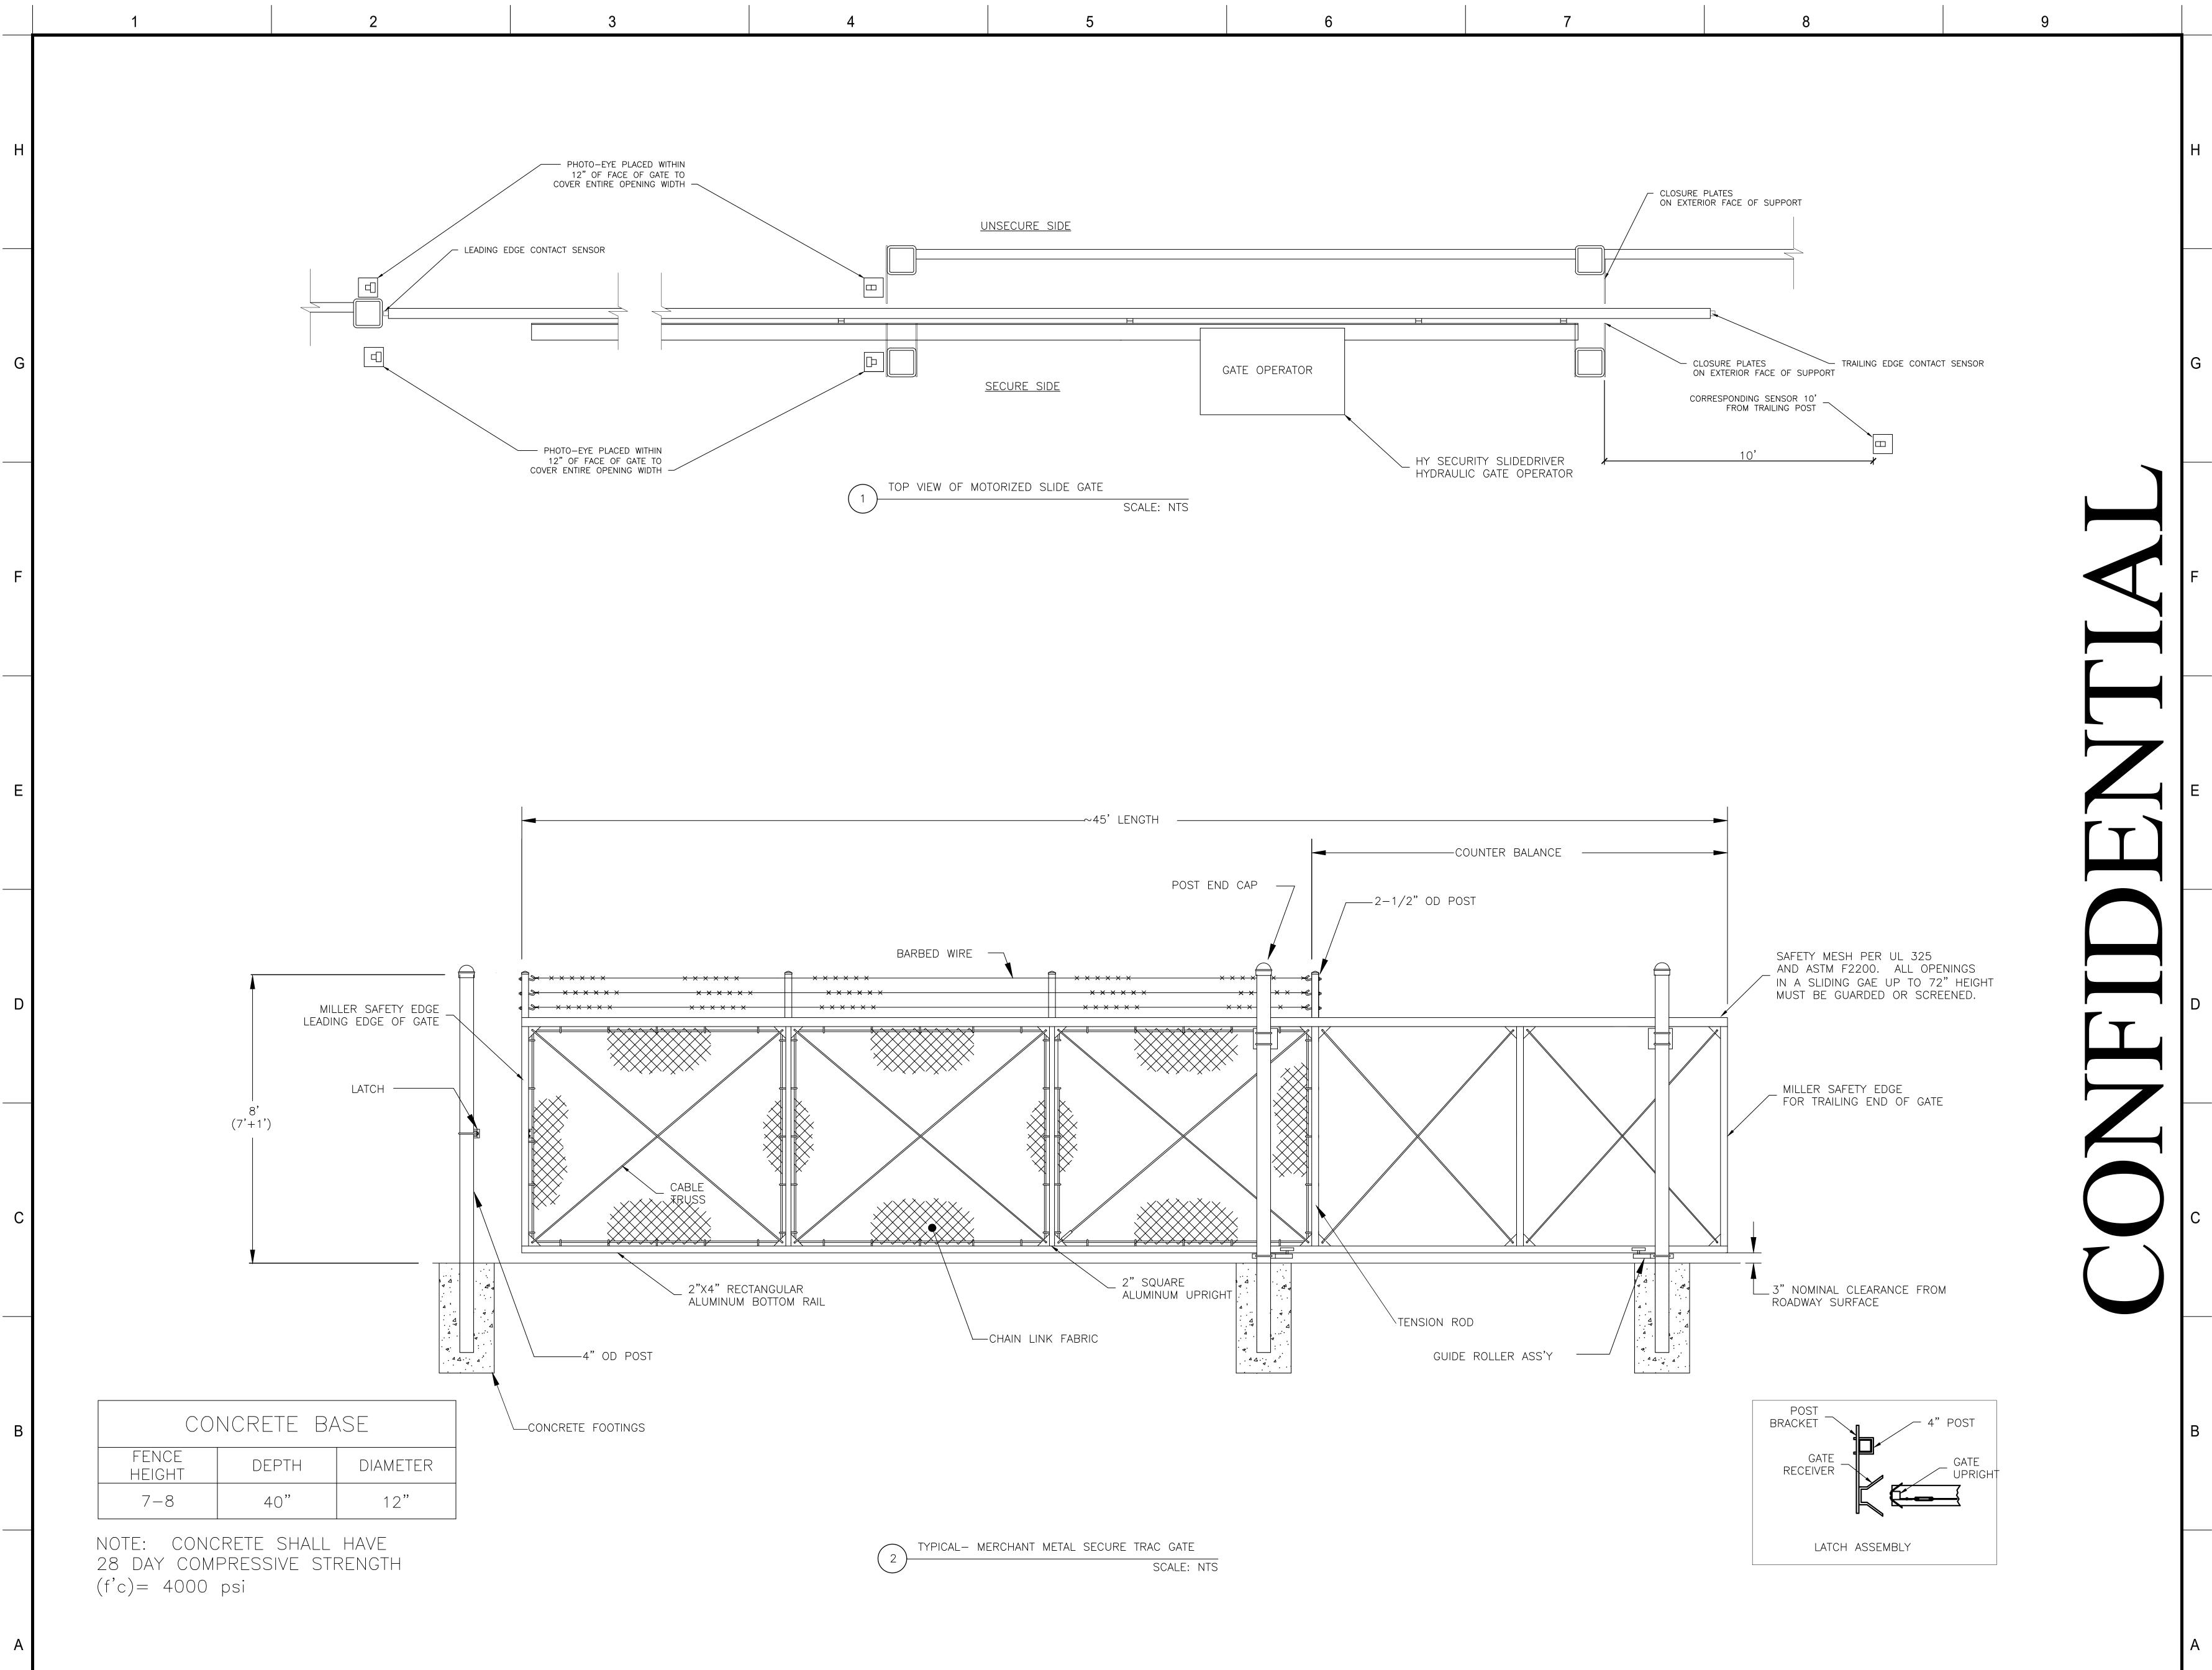




DU	JNN	, NC								
[]	1	1		1						
REVISION										ISSUED FOR CONSTRUCTION
DRN BY										ВР
DATE										05/24/23
MARK	MARK (0) (0) (1) (0) (1) (1) (1) (1) (1) (1) (1) (1) (1) (1									
	OJEC.	-			(0000	0			
	awing F D-				$\Gamma \mathbf{V}$	50	02	იიი		აიი
	Г D -	·FIN		JU-1	L I -	-30	03-			<u> </u>
ELE	ECTRO	ONIC I	FILEN	NAME	:		EY-5	5003		
DR/	AWN I	BY:			BP			5/24		
	CHK'D BY: BP 05/24/23									
E-MAIL: BPAYNTER@PAYNTERCONSULTING.COM THIS DESIGN DRAWING IS THE EXCLUSIVE PROPERTY OF DUKE ENERGY CORPORATION AND IS CONSIDERED CONFIDENTIAL. IT SHALL NOT BE MODIFIED, COPIED, OR DISTRIBUTED WITHOUT PRIOR APPROVAL. THIS										
INFC INTE	NDED.	N SHO	ULD OI	NLY BE	USED	FOR 1	THE SP	ECIFIC	PROJE	CT
IN	EET T IST HY	[A]			-					
ΓI			IC.	AI			U	JN	11	Ι
SH	EET N	0.								
		F	<u> </u>	Y.	-	5()()?	3	
				-					-	

DUNN OPERATIONS MOBILE SUBSTATION STORAGE


SEAL

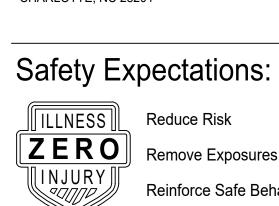

Reduce Risk **ZERO** Remove Exposures to Hazards Reinforce Safe Behavior

MAILING ADDRESS: P.O. BOX 1007 CHARLOTTE, NC 28201



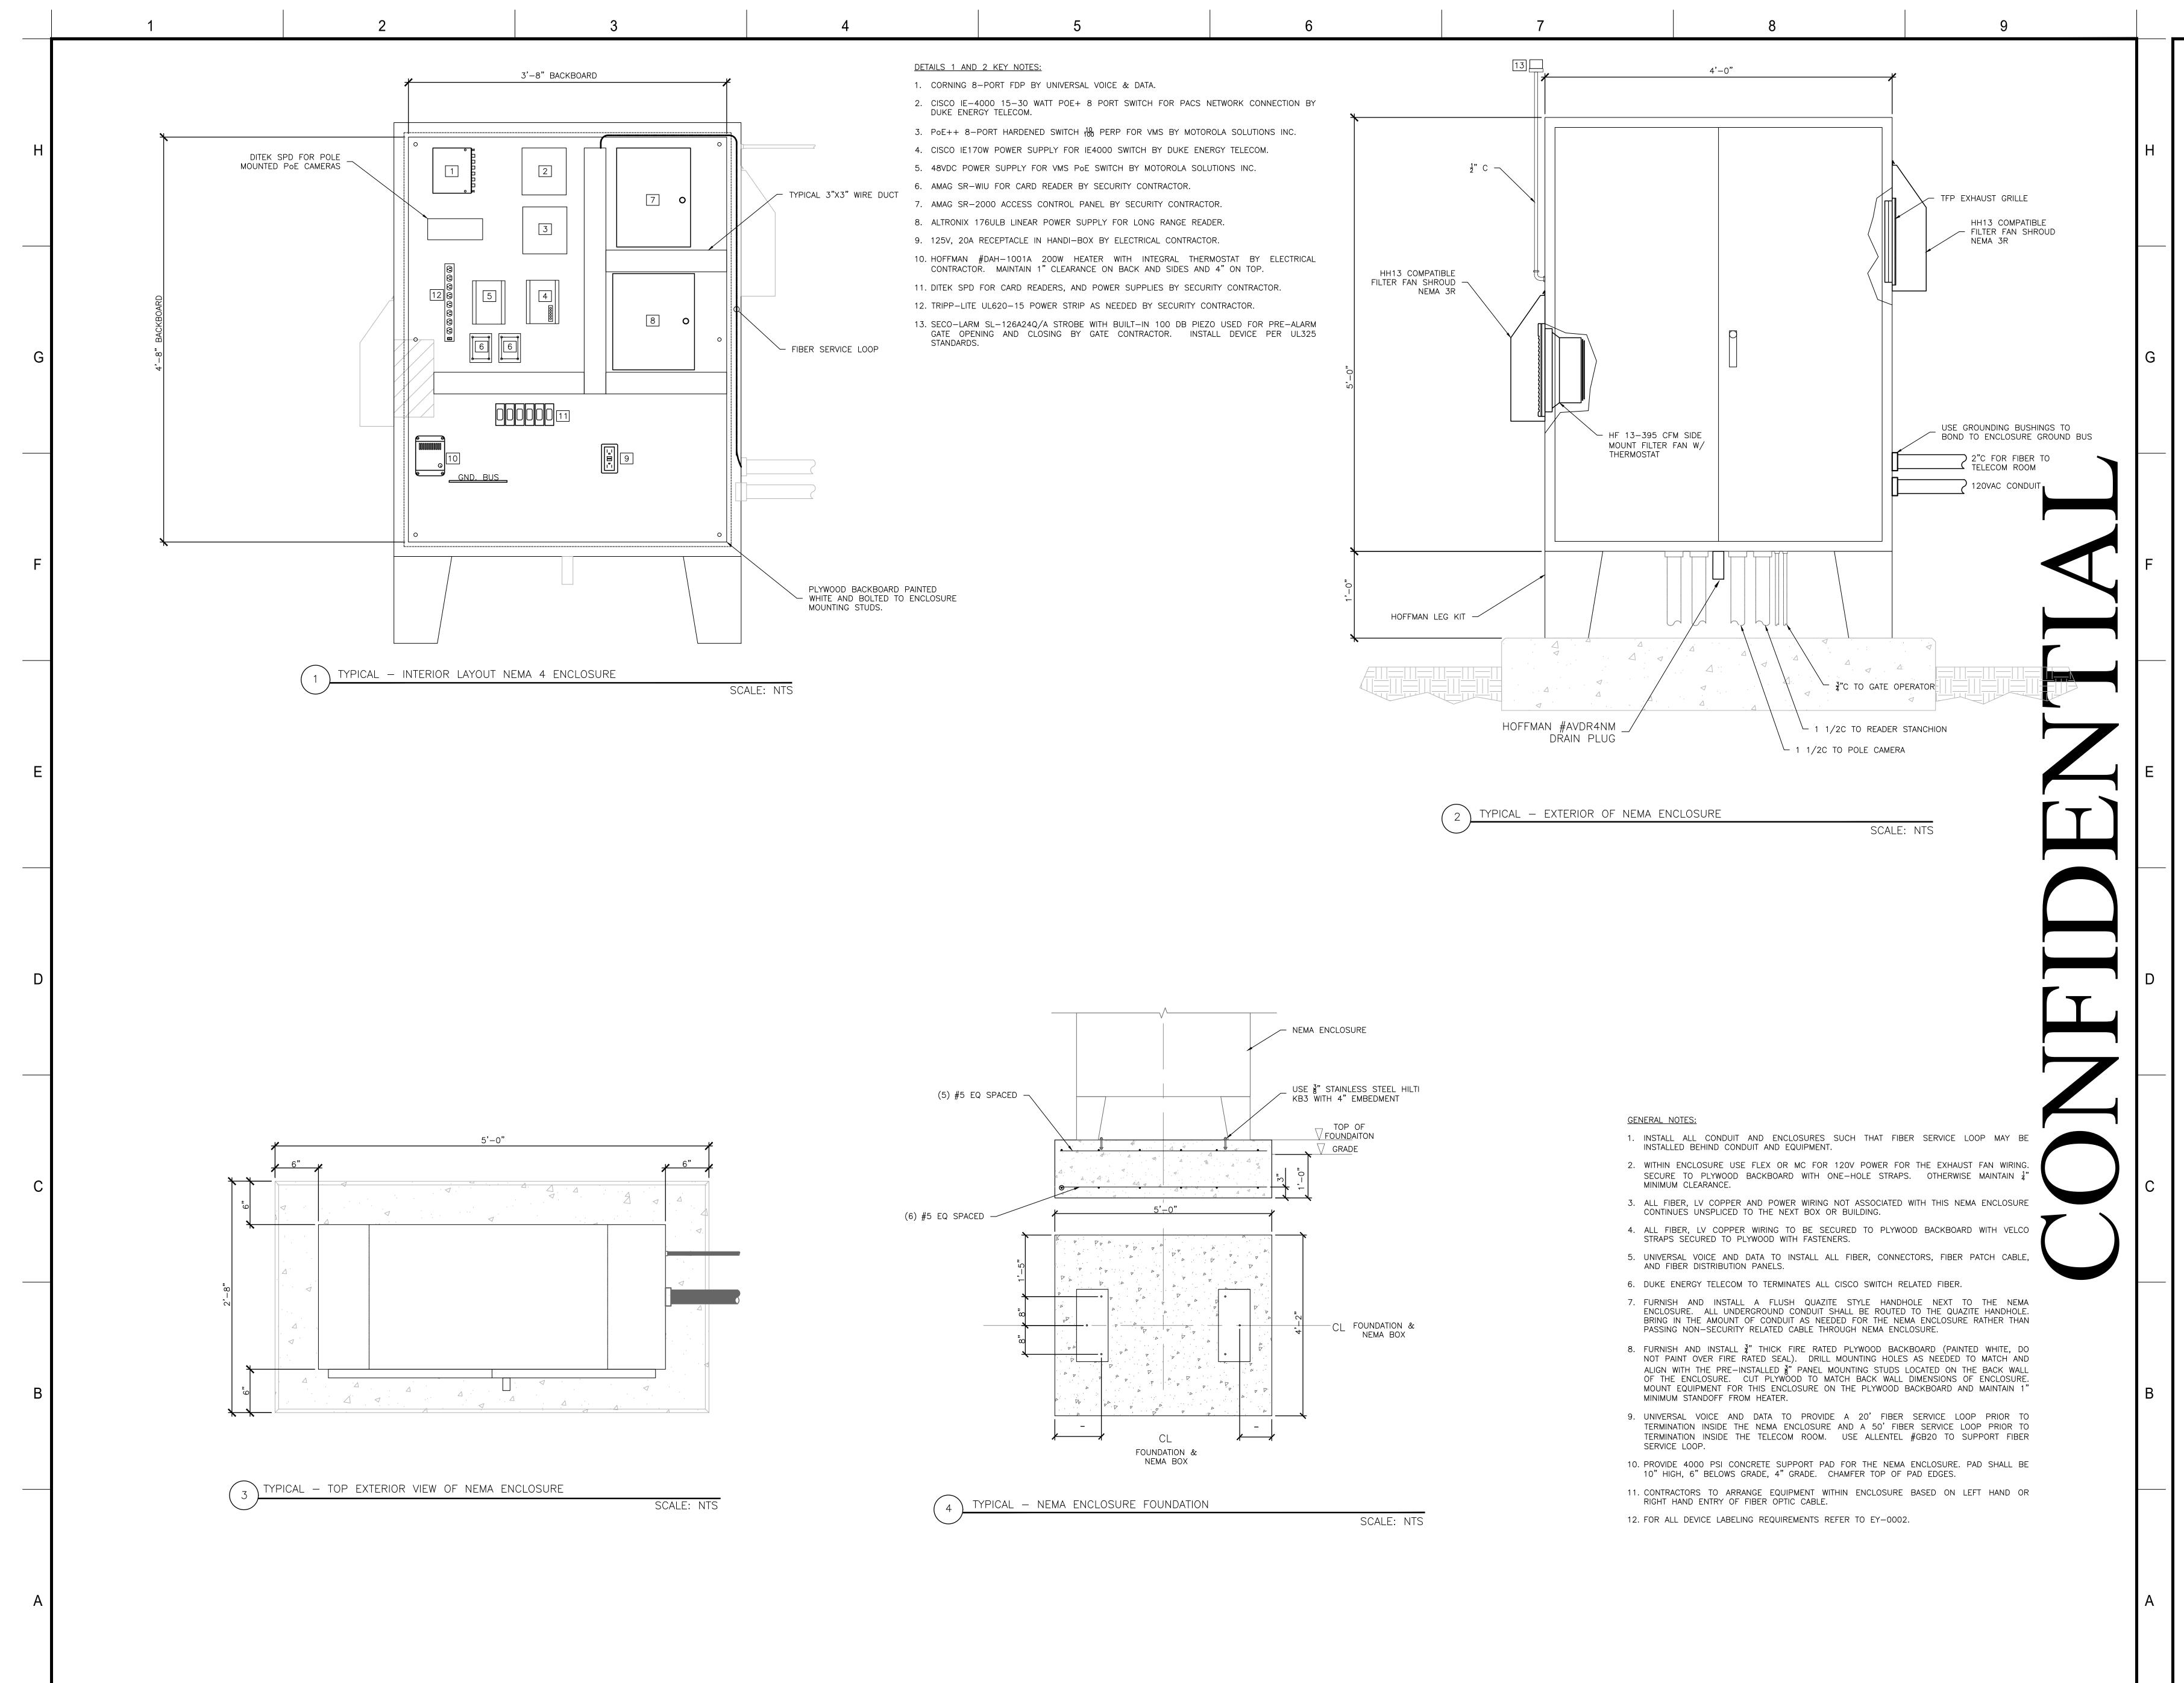

DU	JNN	, NC								
REVISION										ISSUED FOR CONSTRUCTION
DRN BY										BP
DATE										05/24/23
MARK	6	8		\bigcirc	$\overbrace{5}$	4	$\sqrt{3}$	2		\bigcirc
DR	PROJECT NO: DRAWING NUMBER CFD-PN0000-EY-5004-00000000									
ELE	ECTRO	ONIC I	FILEN	NAME	:		EY-5	5004		
DR/	AWN I	BY:			BP			5/24	•	
-	CHK'D BY: BP 05/24/23									
E-MAIL: BPAYNTER@PAYNTERCONSULTING.COM THIS DESIGN DRAWING IS THE EXCLUSIVE PROPERTY OF DUKE ENERGY CORPORATION AND IS CONSIDERED CONFIDENTIAL. IT SHALL NOT BE MODIFIED, COPIED, OR DISTRIBUTED WITHOUT PRIOR APPROVAL. THIS INFORMATION SHOULD ONLY BE USED FOR THE SPECIFIC PROJECT INTENDED. SHEET TITLE:										
	IST HY				-					
SH	EET N	0.								
		E		Y.	-5	5()()/	1	

DUNN OPERATIONS MOBILE SUBSTATION STORAGE


SEAL




Reduce Risk Remove Exposures to Hazards Reinforce Safe Behavior


MAILING ADDRESS: P.O. BOX 1007 CHARLOTTE, NC 28201



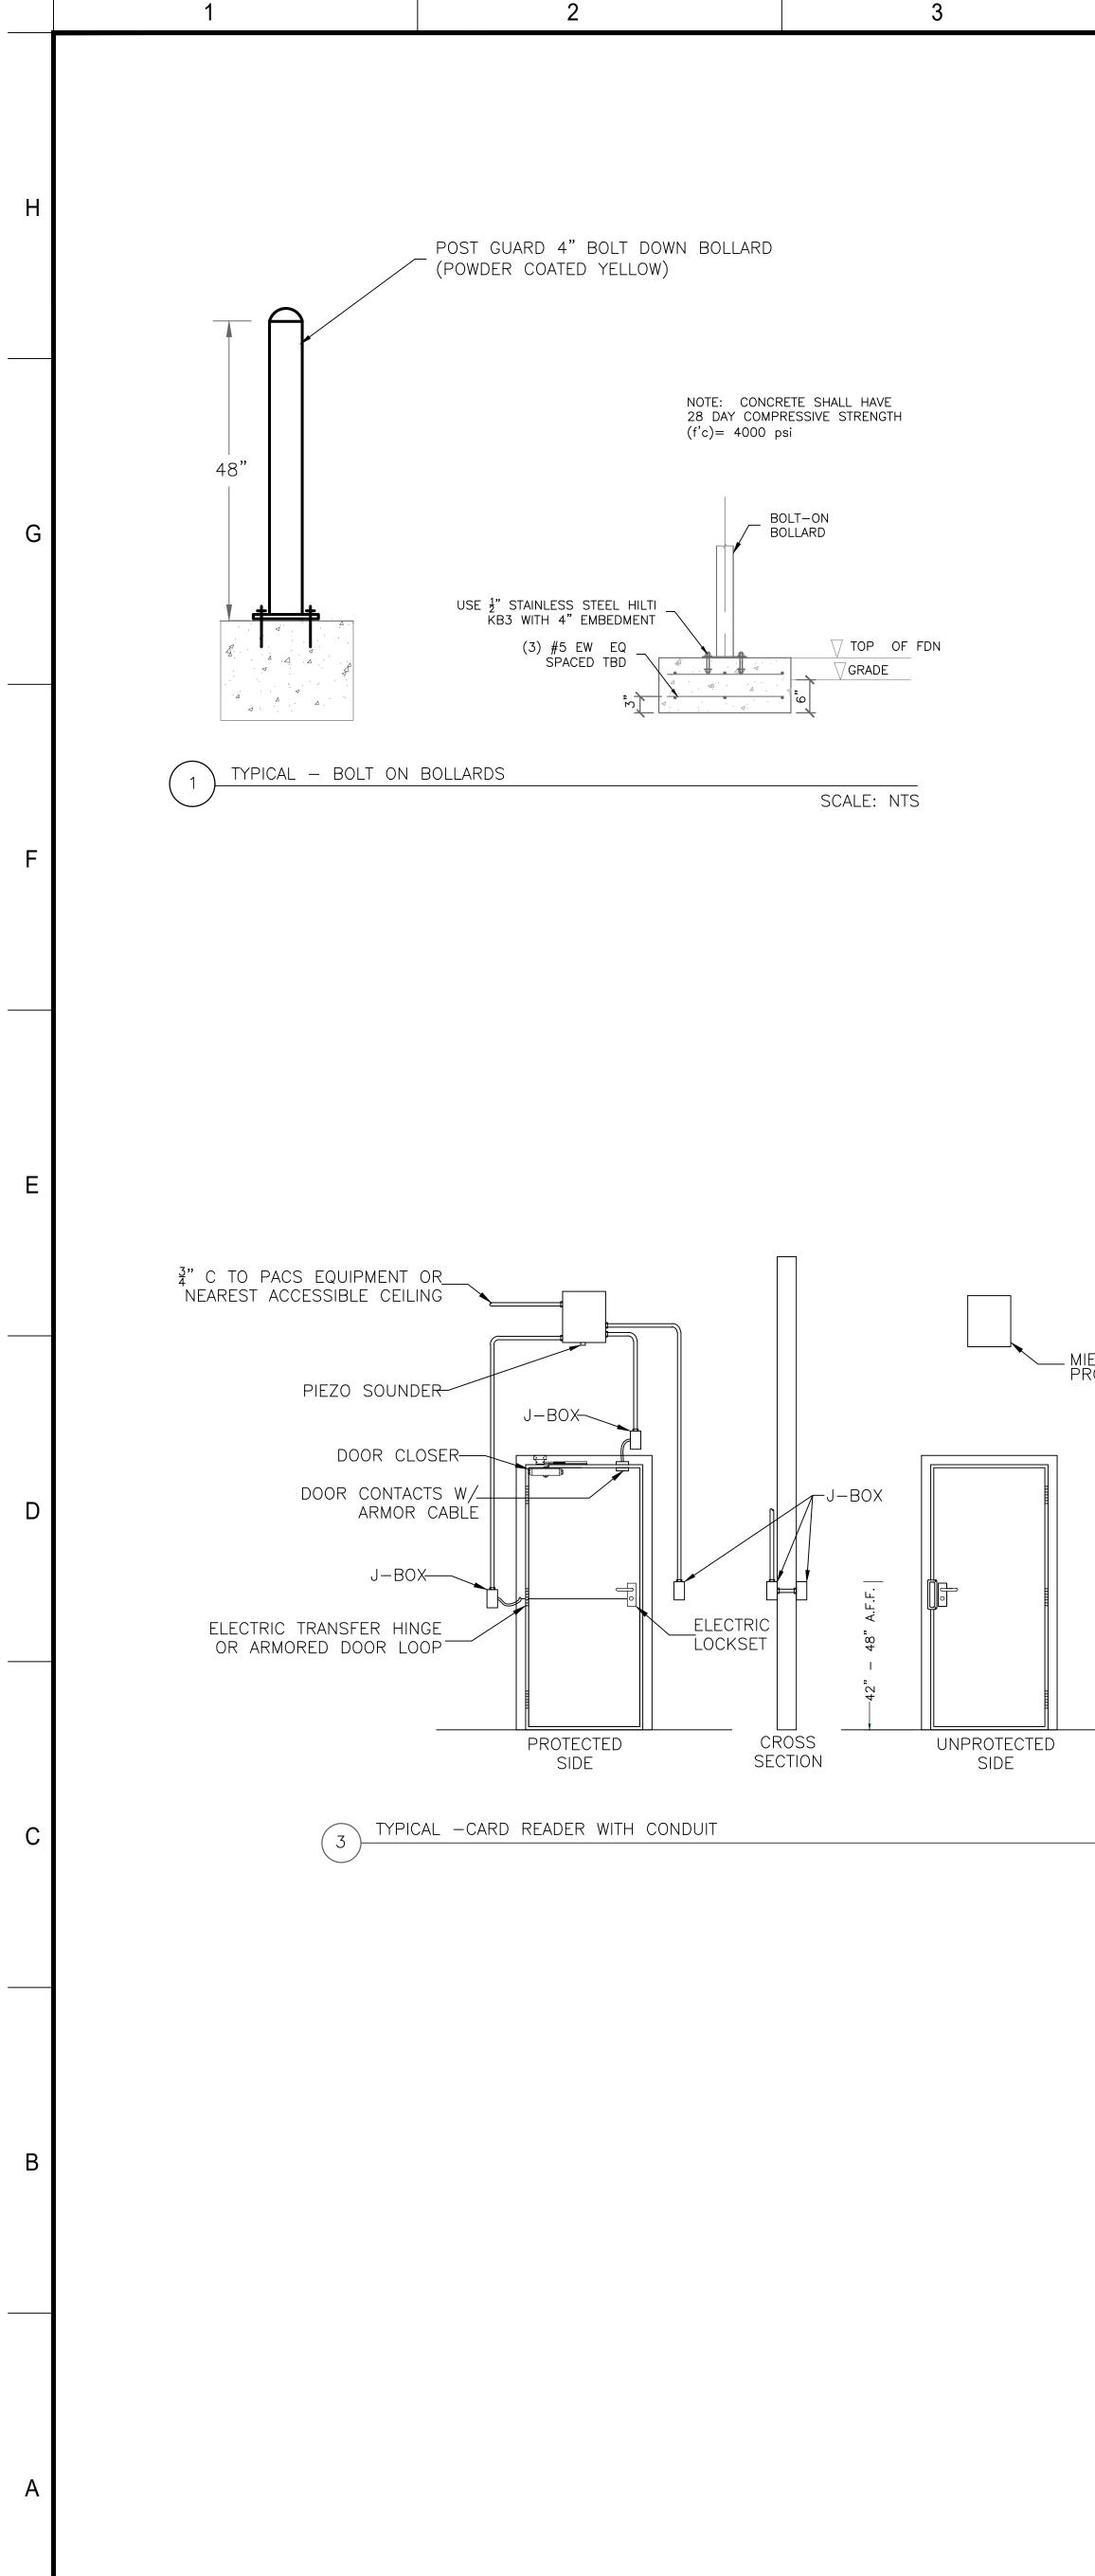

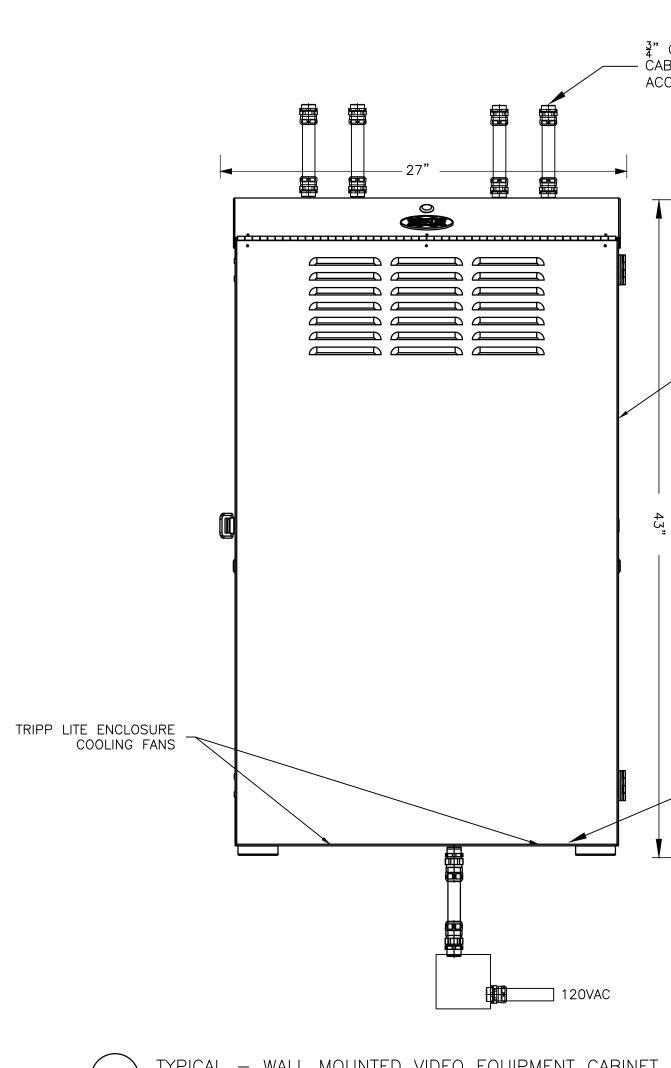




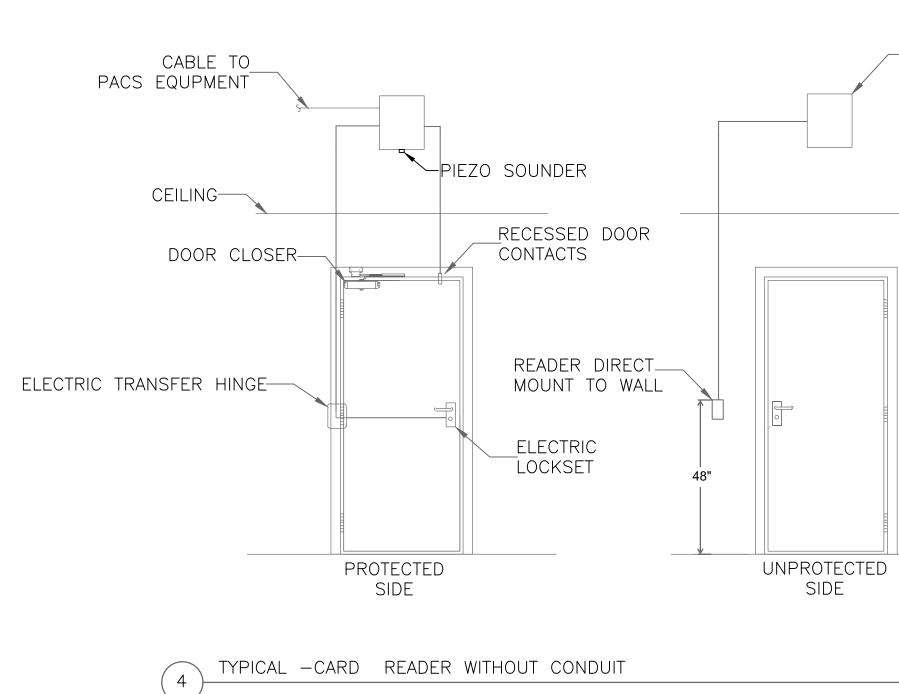

MIER PRODUCTS BW-98BPGUL PROTECTED SIDE OF DOOR

SCALE: NTS

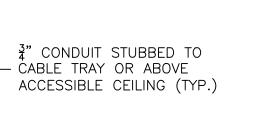

TRIPP LITE MODEL SRWF6U36 – 6U VERTICAL WALL MOUNT SERVER CABINET

QUAD OUTLET MOUNTED

SCALE: NTS

-MIER PRODUCTS BW-98BPGUL PROTECTED SIDE OF DOOR

SCALE: NTS

/-CEILING

Н

G

F

Е

D

С

В

SEAL									
DU									
MOB	ILE	SU	B2	IA	ΠŪ	VIN 2		РКА	.GE
DUNN	, NC								
									NO
7									SSUED FOR CONSTRUCTION
REVISION									FOR CON
									SSUED
DRN BY									BP
DATE									24/23
MARK	8	$\overline{\langle}$	\bigvee	$\overline{2}$	4	$\sqrt{3}$	$\boxed{2}$	$\overline{\mathbb{A}}$	05/
PROJEC [®]		MBER		(0000	0			
CFD-)00()00
				BP		EY-5 0	5/24	4/23	
CHK'D BY	/ :			BP		0	5/24	4/23	
E-MAIL:				ter@p					
THIS DESIG CORPORATIO MODIFIED, 0 INFORMATIO INTENDED.	ON ANE COPIED N SHO) IS CO , OR D	ONSIDE	RED CO JTED W	ONFIDEI /ITHOUT	NTIAL.	IT SHAI R APPR	LL NOT	be This
	[A]								
РНУ	. .	IC	AI			U	JR	11	ľ
SHEET N		- \	/	-5	57)() [-	
		· · ·	1 -			八 一	バ	<u>ן</u>	

Safety Expectations: ILLNESS INJURY


P.O. BOX 1007

CHARLOTTE, NC 28201

Reduce Risk **ZERO** Remove Exposures to Hazards Reinforce Safe Behavior

MAILING ADDRESS:

DUKE ENERGY.

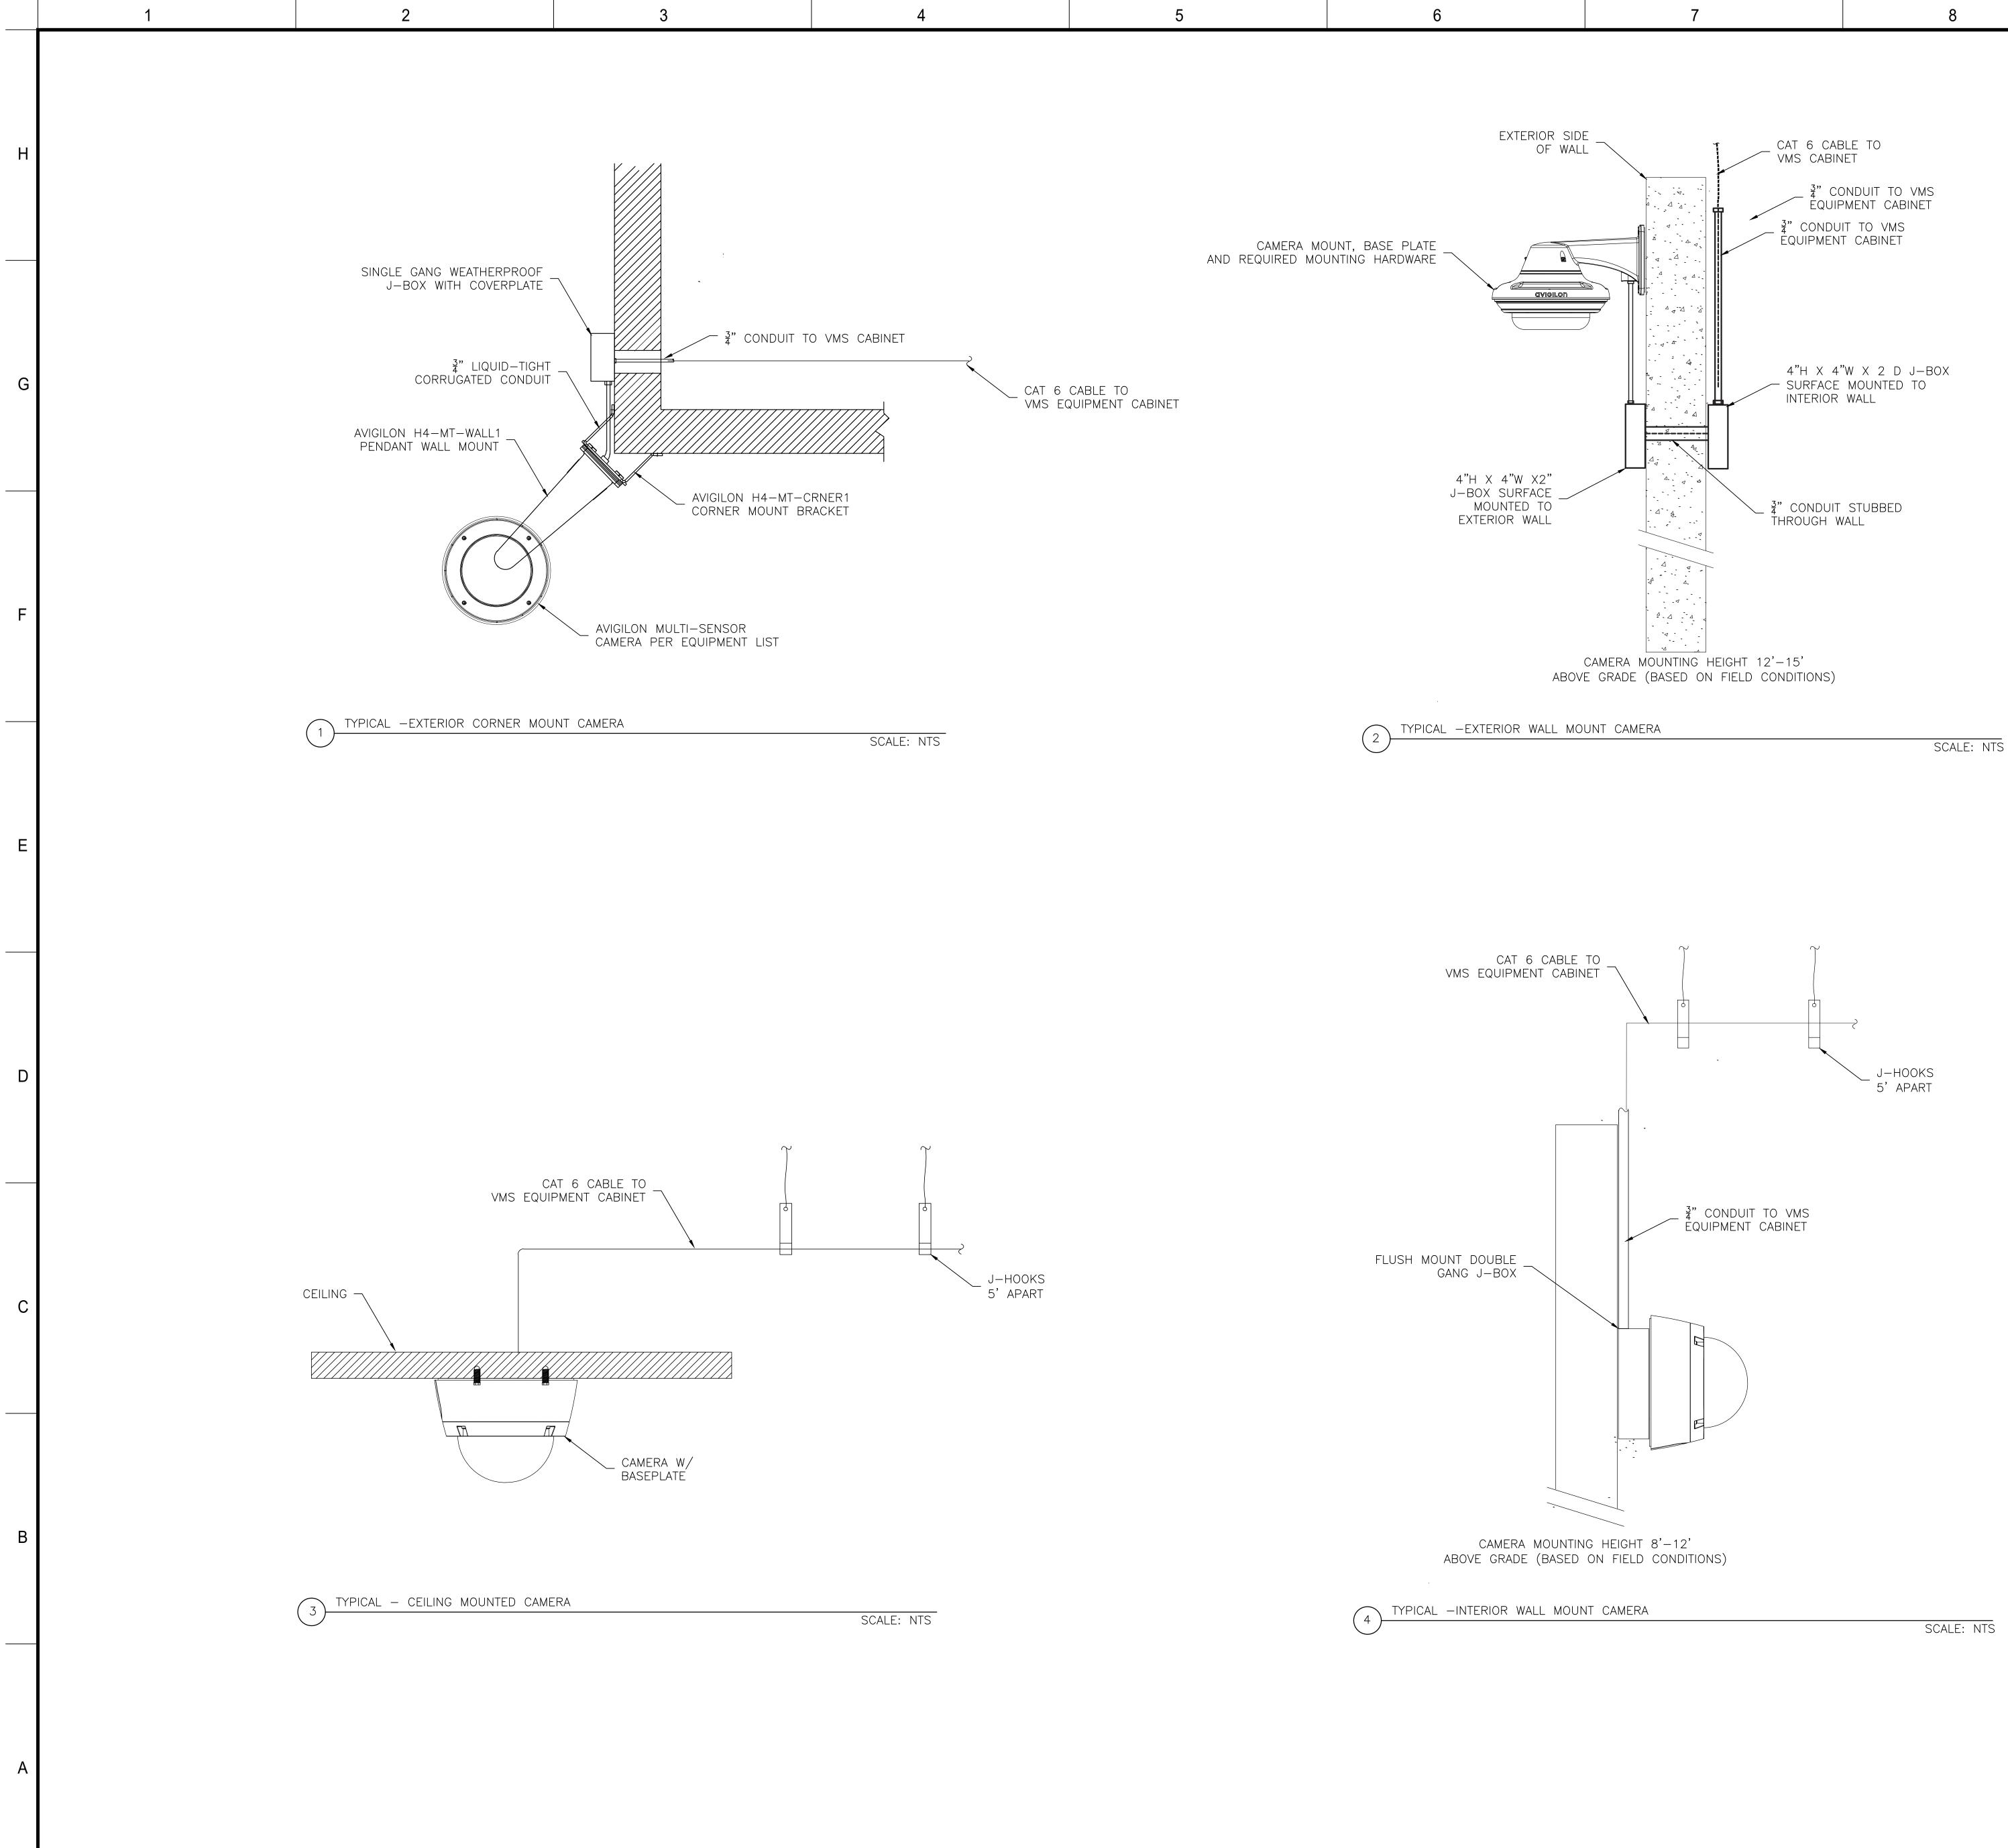

SCALE: NTS

Н

G

Е D

С

В

DU	JNN	, NC								
REVISION										ISSUED FOR CONSTRUCTION
DRN BY										ВР
DATE										05/24/23
MARK	6	8		\bigvee	$\overbrace{5}$	\bigvee	$\sqrt{3}$	\sum	$\overline{\mathbb{V}}$	\bigtriangledown
	OJEC				(0000	0			
	awing F D-				EY.	-50	06-	000)00(000
	ECTRO AWN B				BP		EY-5	5/24	1/2.3	
CHI	K'D BY	′ :			BP			5/24		
E-N	E-MAIL: BPAYNTER@PAYNTERCONSULTING.COM									
COR MOD INFC	THIS DESIGN DRAWING IS THE EXCLUSIVE PROPERTY OF DUKE ENERGY CORPORATION AND IS CONSIDERED CONFIDENTIAL. IT SHALL NOT BE MODIFIED, COPIED, OR DISTRIBUTED WITHOUT PRIOR APPROVAL. THIS INFORMATION SHOULD ONLY BE USED FOR THE SPECIFIC PROJECT INTENDED.									
IN	SHEET TITLE: INSTALLATION DETAILS PHYSICAL SECURITY									
SH	EET N	0.								
		E	-	Y.	-5	50)()6	5	

DUNN OPERATIONS MOBILE SUBSTATION STORAGE


SEAL



ZERO Remove Exposures to Hazards Reinforce Safe Behavior

MAILING ADDRESS: P.O. BOX 1007 CHARLOTTE, NC 28201




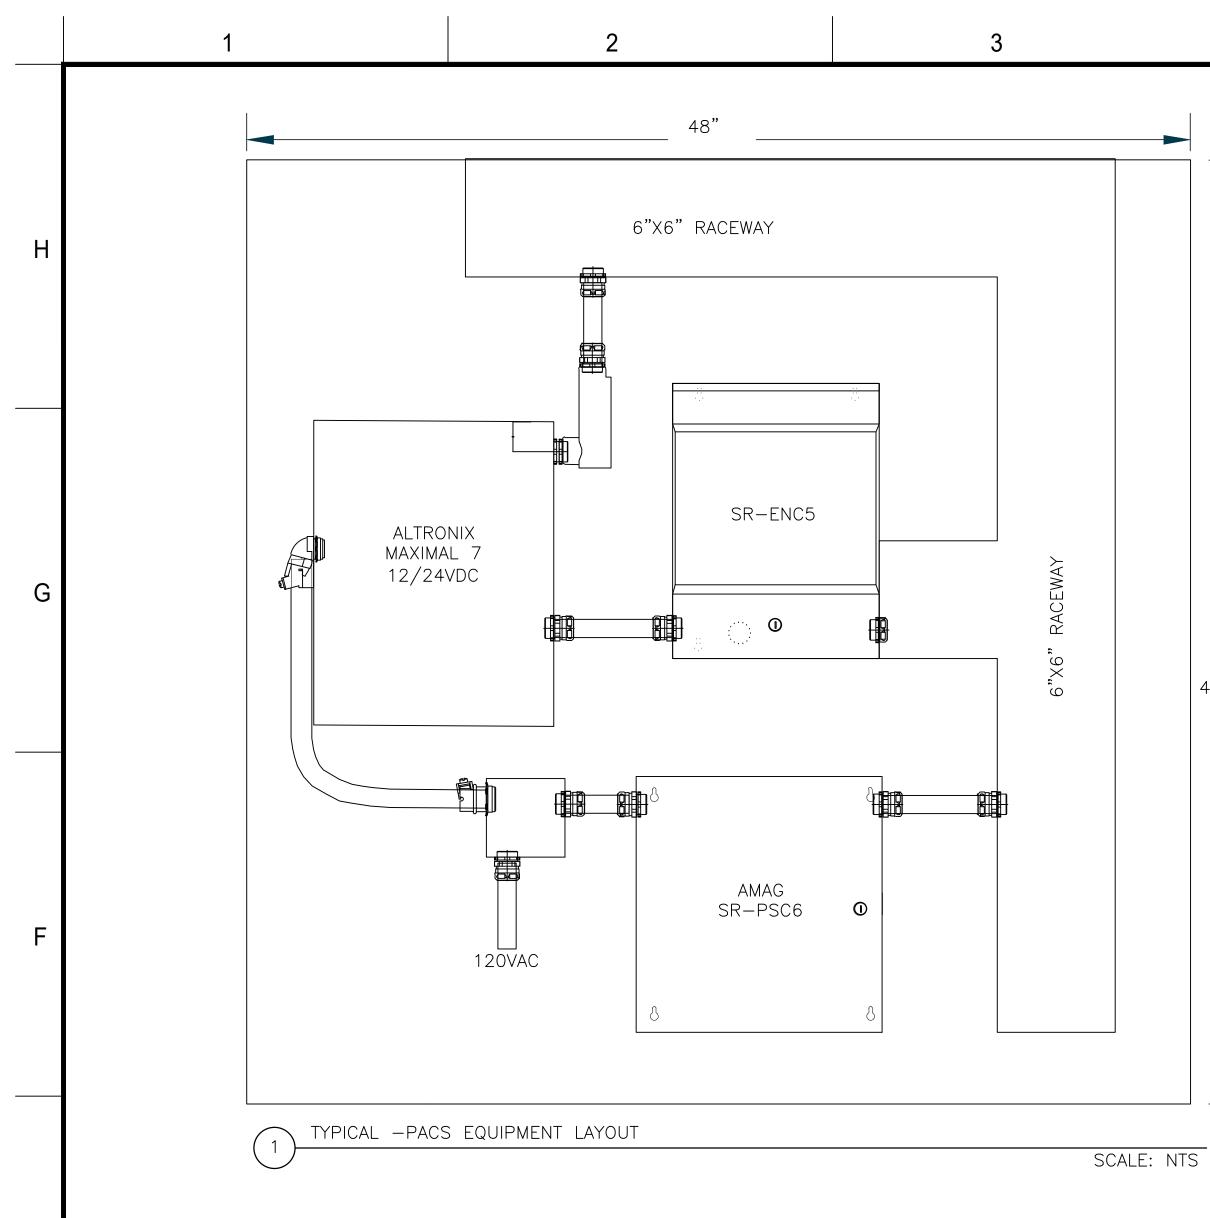


D

С

E

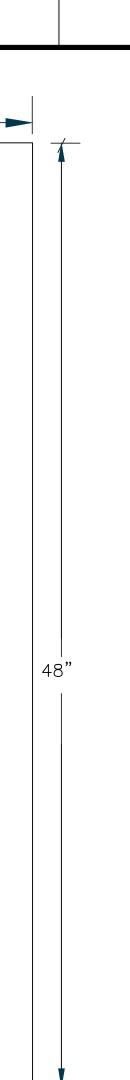

6

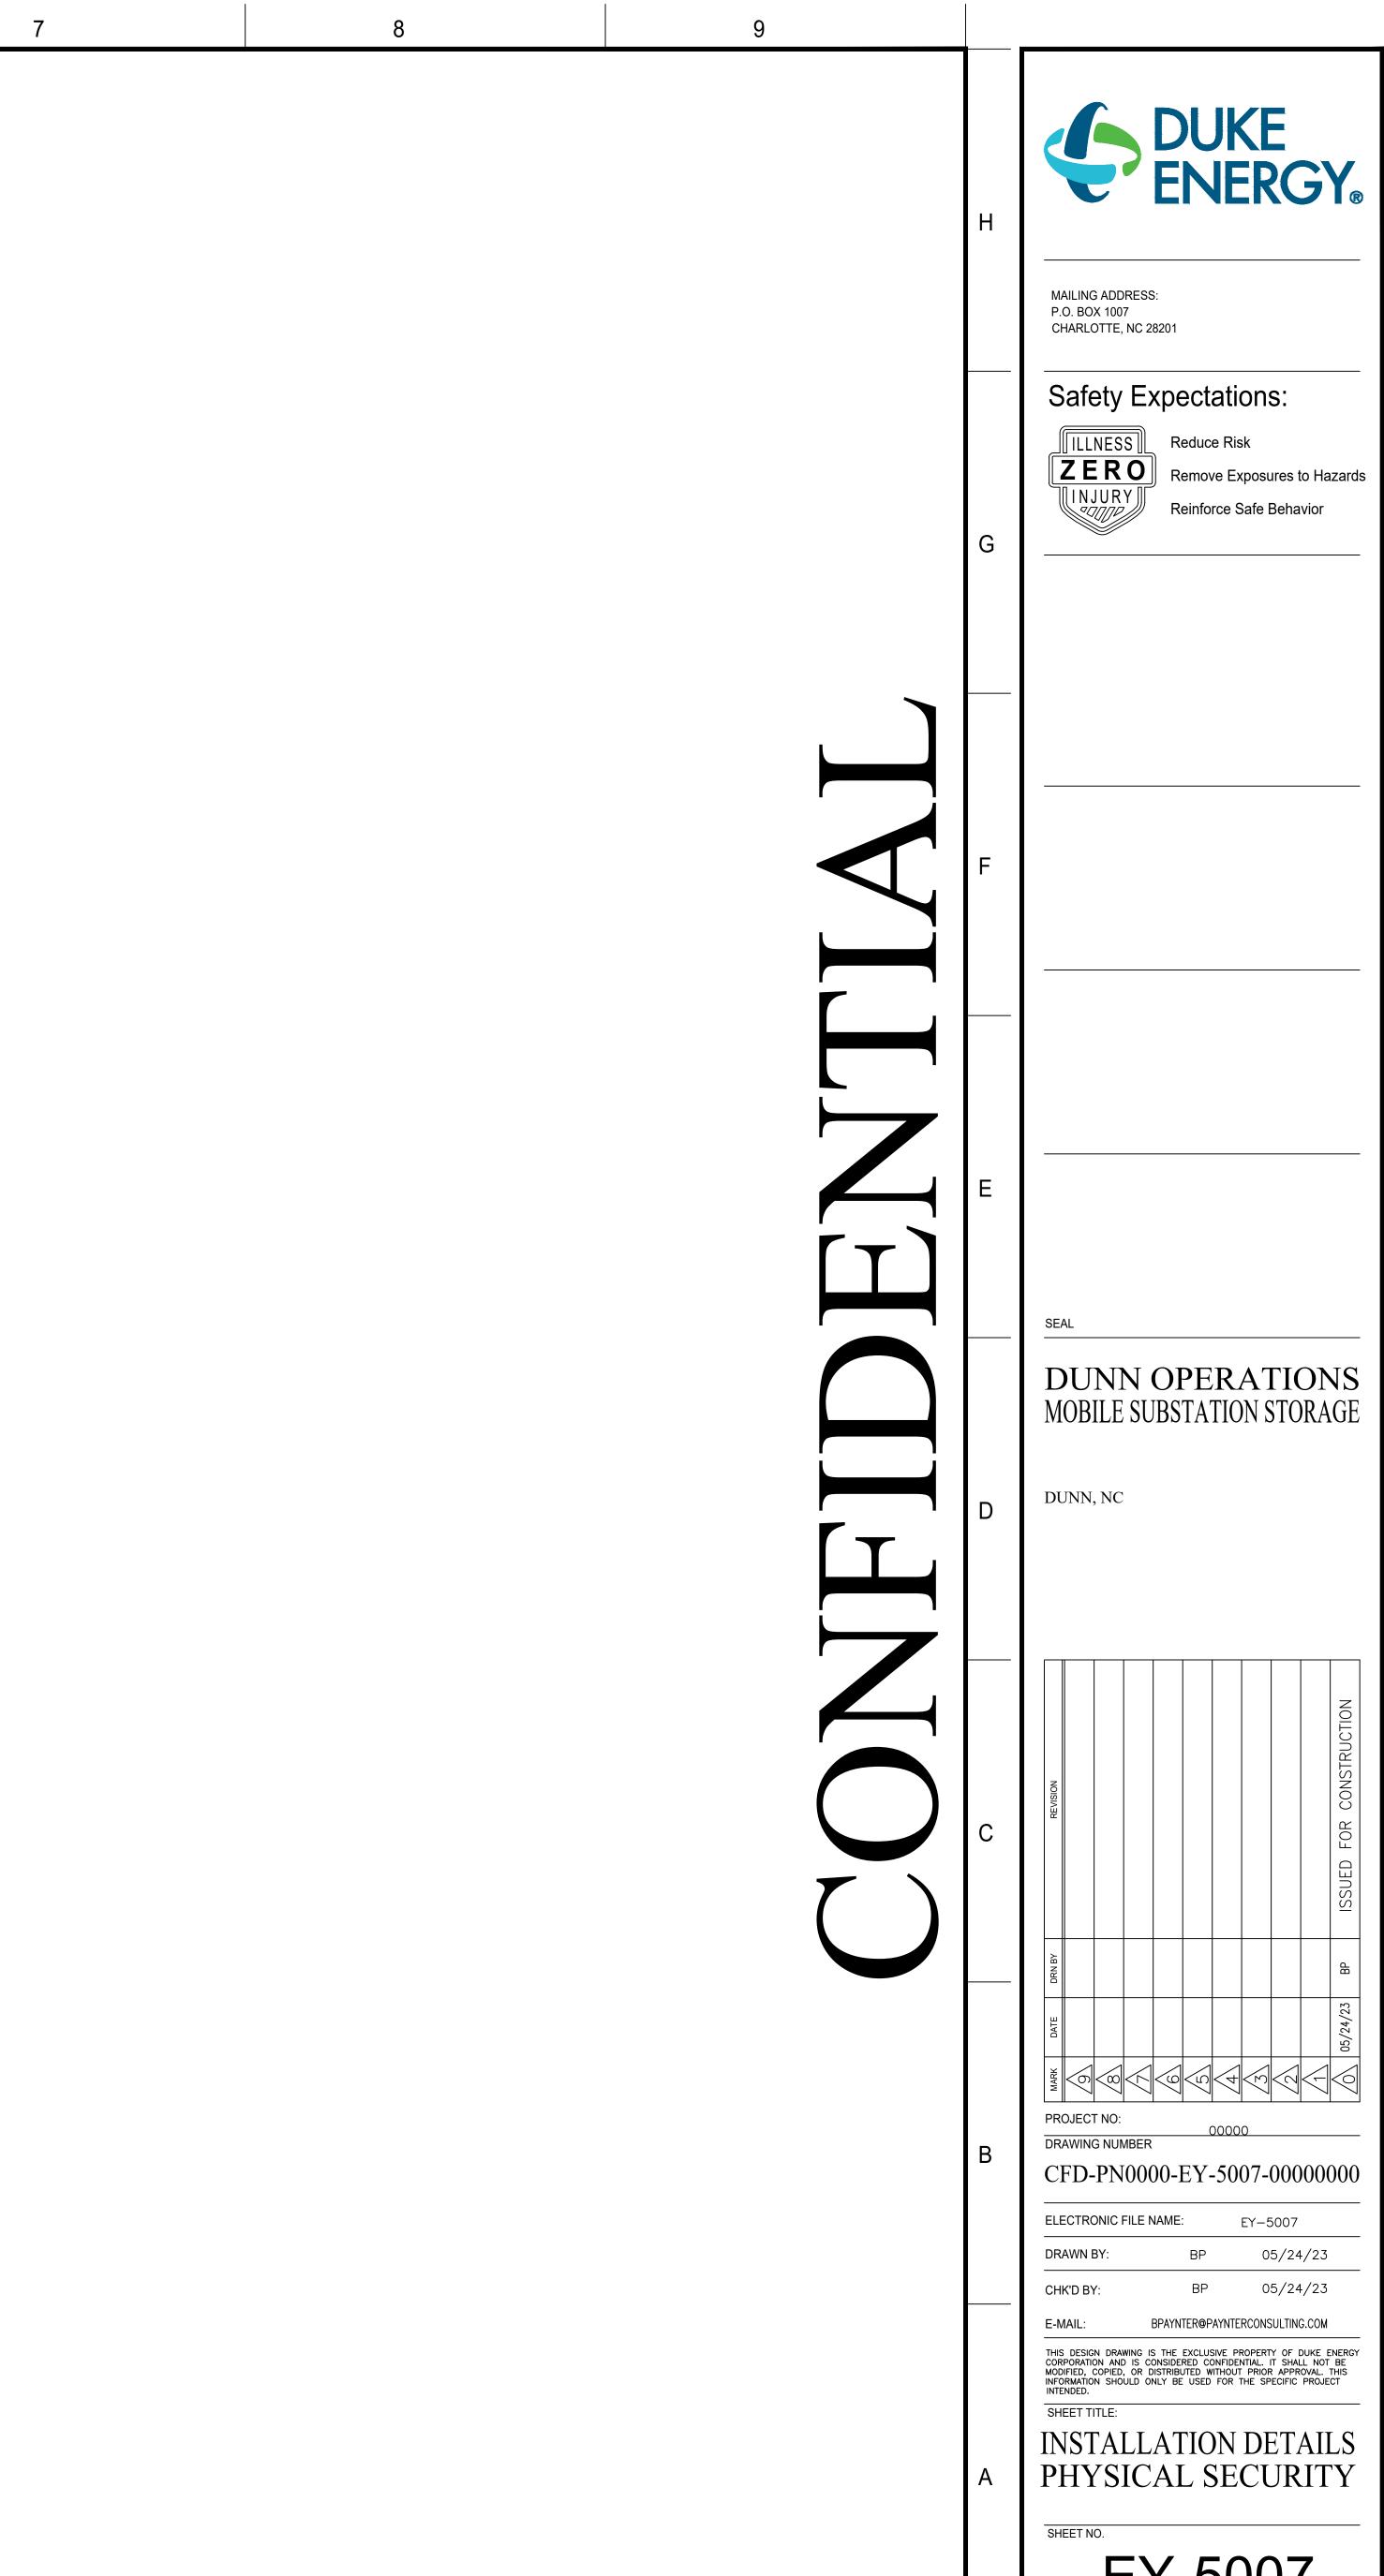


DL	DUNN, NC									
	1	I								[]
REVISION										ISSUED FOR CONSTRUCTION
DRN BY										ВР
DATE										05/24/23
MARK	6	8	$\overline{\langle}$	\bigtriangledown	$\overbrace{5}$	\checkmark	$\overline{\mathcal{A}}$	\sum	$\overline{\mathbb{V}}$	\bigtriangledown
	OJEC		10.50	-	(0000	0			
	awing F D-				EY-	-50	07-	000)000	000
ELE	ECTRO		FILE N	IAME	:		EY-5	5007		
DR	AWN I	BY:			BP			5/24	/23	
СН	K'D B`	Y:			BP		0	5/24	/23	
E-N	E-MAIL: BPAYNTER@PAYNTERCONSULTING.COM									
COR MOD INFC	THIS DESIGN DRAWING IS THE EXCLUSIVE PROPERTY OF DUKE ENERGY CORPORATION AND IS CONSIDERED CONFIDENTIAL. IT SHALL NOT BE MODIFIED, COPIED, OR DISTRIBUTED WITHOUT PRIOR APPROVAL. THIS INFORMATION SHOULD ONLY BE USED FOR THE SPECIFIC PROJECT INTENDED.									
			гт			. т			<u>А Т</u> Т	
	IST HY				-					
1]									11	T
SH	EET N	0.								
		E	<u> </u>	Y.	-5	5()()7	7	
						_	_			

<u>general notes</u>:

1. CAT 6 PATCH CABLES FOR PACS CONTROLLER TO THE DE BUSINESS NETWORK SWITCH SHALL BE FURNISHED AND INSTALLED BY UNIVERSAL VOICE AND DATA.

2

- 2. CAT 6 CABLE FROM CAMERAS TO VMS PATCH PANEL SHALL BE FURNISHED AND INSTALLED BY MOTOROLA SOLUTIONS.
- 3. NETWORK VIDEO RECORDER (NVR) SHALL BE FURNISHED AND INSTALLED BY MOTOROLA SOLUTIONS.
- VMS POE HARDENED SWITCHES IN NEMA ENCLOSURES SHALL BE FURNISHED AND INSTALLED BY MOTOROLA SOLUTIONS.
- 5. SURGE PROTECTION DEVICES FOR CAMERAS SHALL BE FURNISHED AND INSTALLED BY MOTOROLA SOLUTIONS.
- 6. FIBER OPTIC CABLE FROM VEHICLE GATE TO TELECOM ROOM SHALL BE FURNISHED AND INSTALLED BY UNIVERSAL VOICE AND DATA.
- 7. FIBER DISTRIBUTION PANELS AND CONNECTORS SHALL BE FURNISHED AND INSTALLED BY UNIVERSAL VOICE AND DATA.
- 8. LOW VOLTAGE CABLE FOR PACS EQUIPMENT SHALL BE FURNISHED AND INSTALLED BY SECURITY CONTRACTOR.
- 9. MOTOROLA SOLUTIONS SHALL FURNISH AND INSTALL SAFETY RELAY OUTPUT, FIBER/LAN CONVERTER, AND VIDEO ENCODER FOR VIDEO INTERCOM.

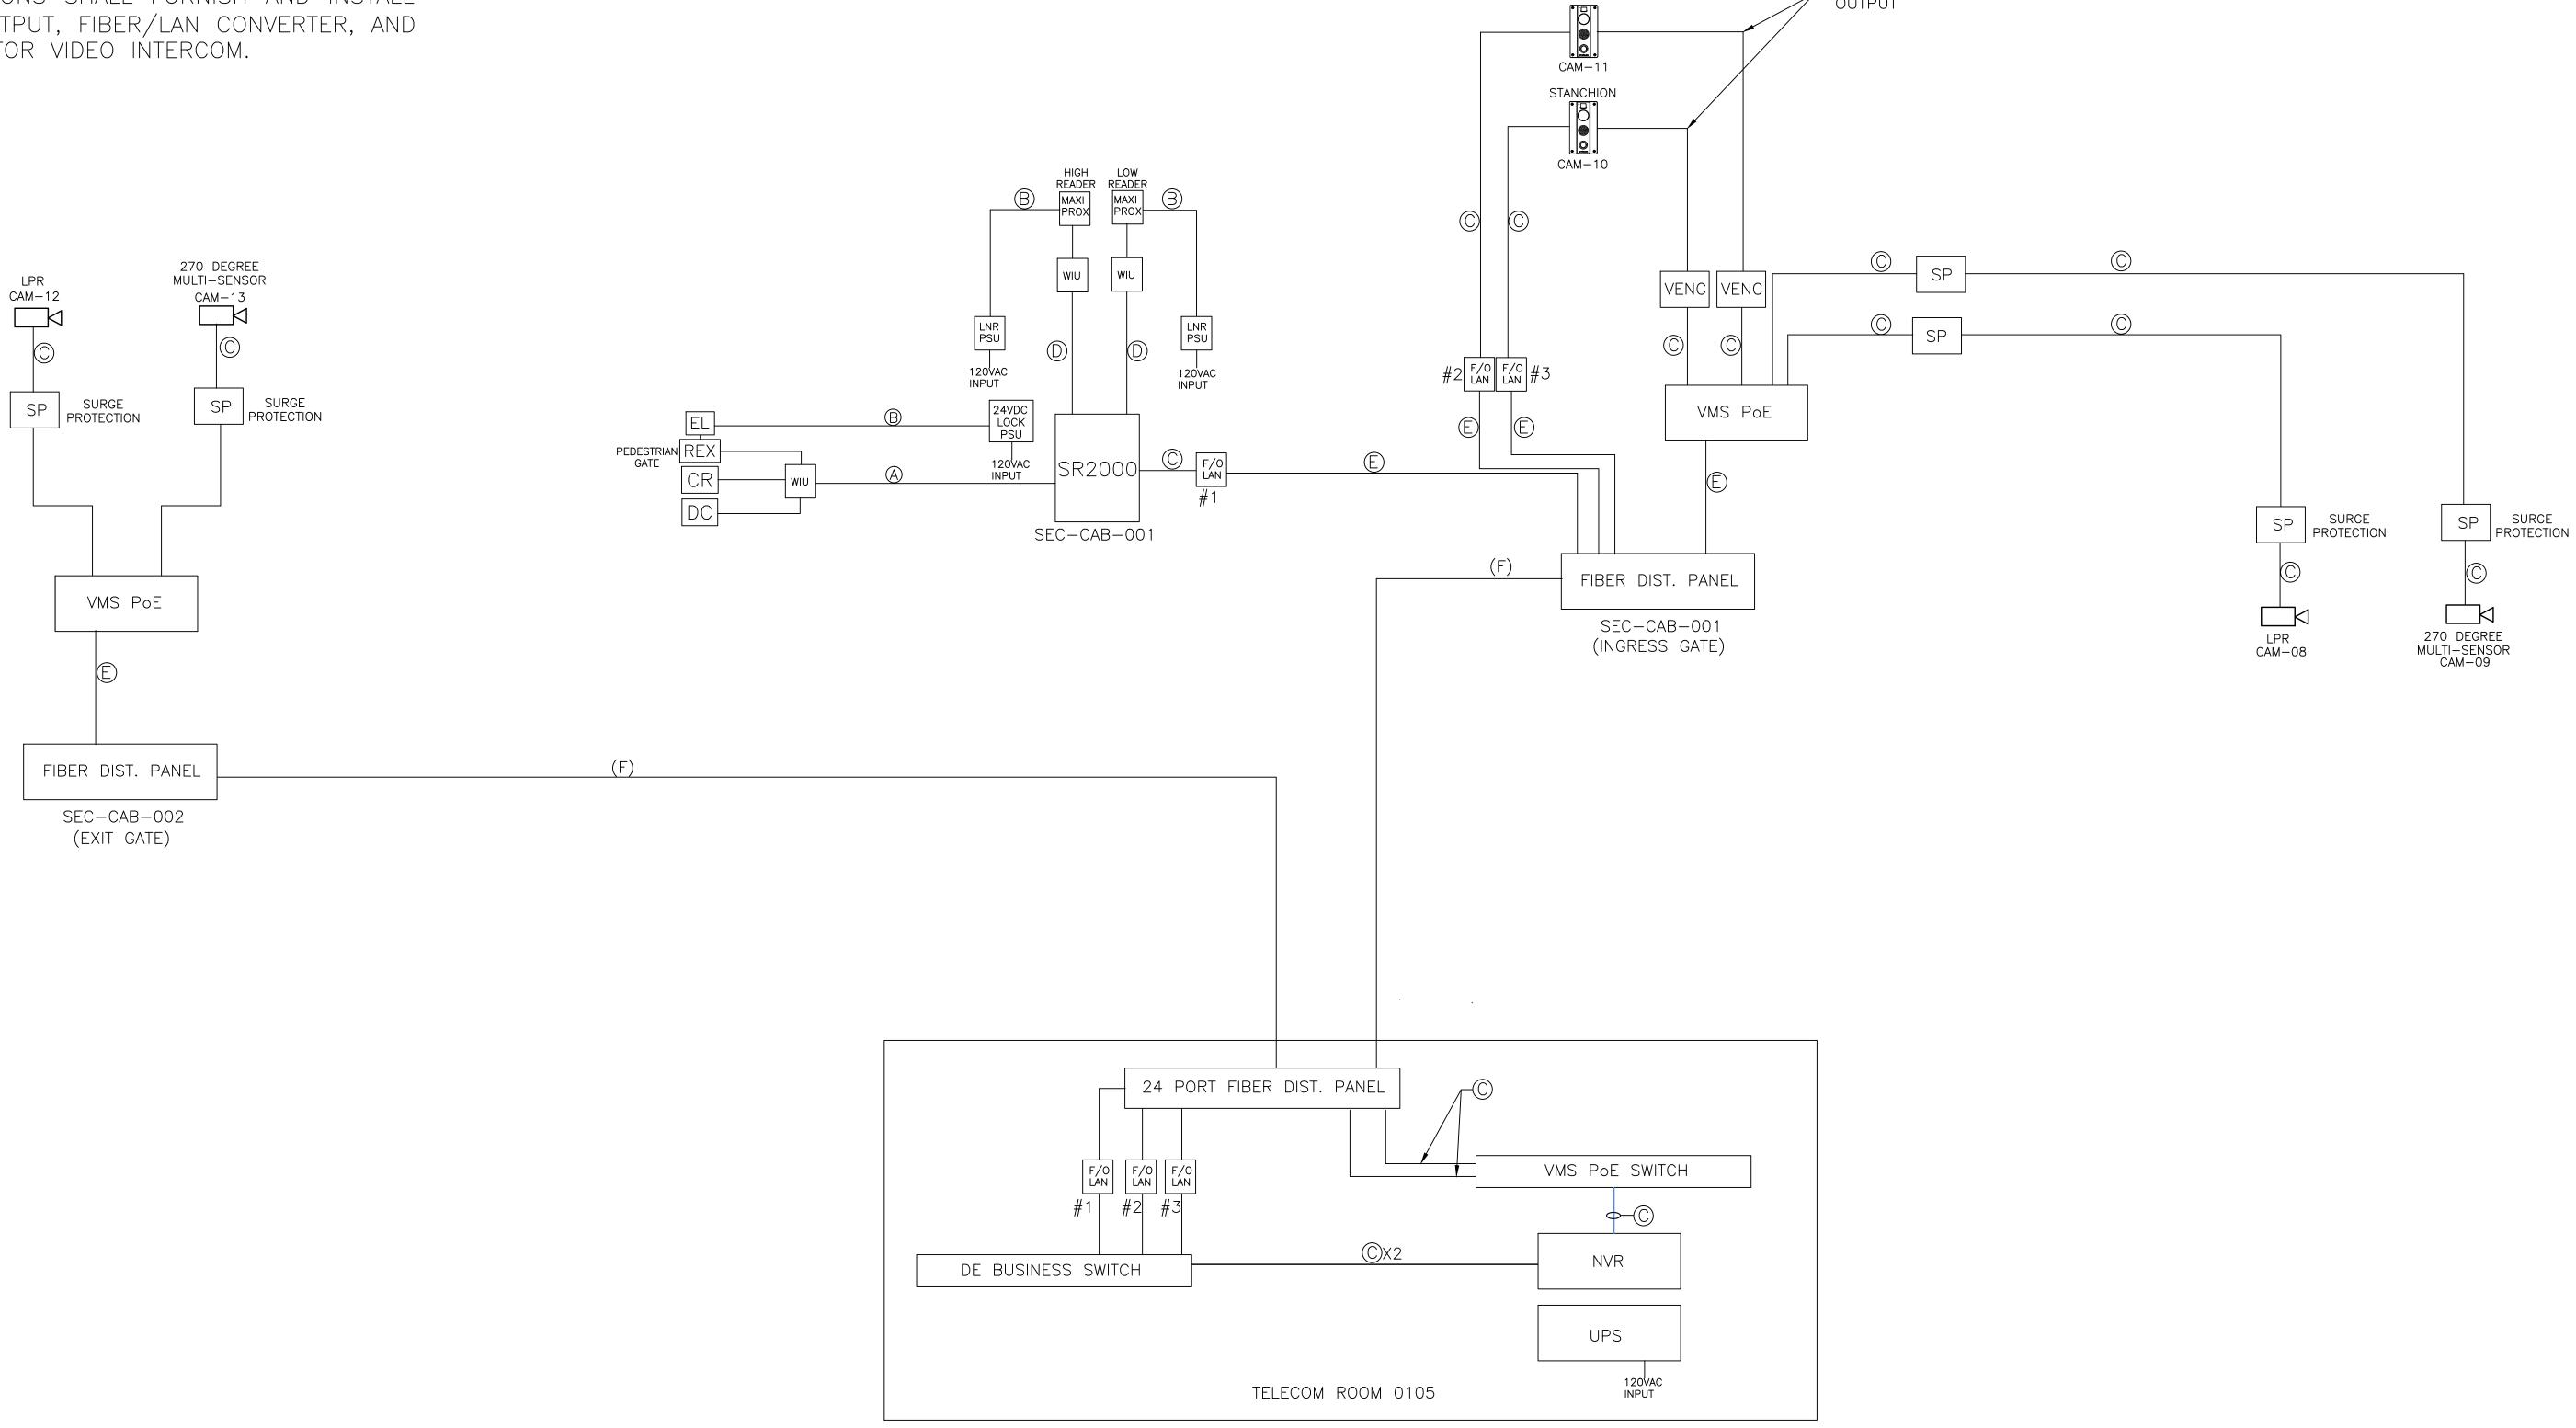

3

3

Δ

5

6

STANCHION

H

G

6

8

9

Н	

G

F

Е

D

SECURIT	Y CABLE LEGEND
A	(1) 22AWG/6C AND (1) 18AWG/2C
В	(1) 18AWG/2C
С	(1) CAT 6
D	(1) 22AWG/6C
E	(2) FIBER PATCH CABLES
F	12 OM3 (50 MICRON) MM




В

С

	DL EN	JKE IERG	Y®
MAILING ADDRE P.O. BOX 1007			
CHARLOTTE, NO		ations	
	Reduce	e Risk	
		e Exposures to ce Safe Behavi	
seal DUNN			
		$\mathbf{K} \Delta \mathbf{I} \mathbf{I}$	NIC
MOBILE S	SUBSTAT	RATIC TION STOP	
MOBILE S	SUBSTAT		
	SUBSTAT		
	SUBSTAT		
	SUBSTAT		RAGE
	SUBSTAT		
	SUBSTAT		RAGE
DUNN, NC	SUBSTAT		FOR CONSTRUCTION
DUNN, NC	SUBSTAT		RAGE
DUNN, NC	SUBSTAT		AGE ISSUED FOR CONSTRUCTION
DUNN, NC			ISSUED FOR CONSTRUCTION
DUNN, NC			AGE ISSUED FOR CONSTRUCTION
DUNN, NC			AGE 05/24/23 BP ISSUED FOR CONSTRUCTION
DUNN, NC			AGE ODDOU
DUNN, NC		TION STOP TION STOP → → → → → → → → → → → → → → → → → → →	AGE AGE ISSUED FOR CONSTRUCTION
DUNN, NC	E NAME: BP BPAYNTER@P/ G IS THE EXCLUSO R OISTRIBUTED WI	TION STOF	AGE NOLTON AGE ISSUED FOR CONSTRUCTION
DUNN, NC	E NAME: BP BPAYNTEROP/ G IS THE EXCLUSO CR DISTRIBUTED WI DONLY BE USED	TION STOF	AGE NOLLON UNCLION CONSTRUCTION
DUNN, NC		TION STOP TION STOP TION STOP	AGE NOLLON VICTION VIC

	1		2		3
Н					
G					
F					
			7 7	####.21 ER ####.109-0	
E					
D					
С					
0					
В					
А					
	1		2		3

SECURIT	Y CABLE LEGEND
A	(1) 22AWG/6C AND (1) 18AWG/2C
В	(1) 18AWG/2C
С	(1) CAT 6
D	(1) 22AWG/6C
E	(2) FIBER PATCH CABLES
F	12 OM3 (50 MICRON) MM

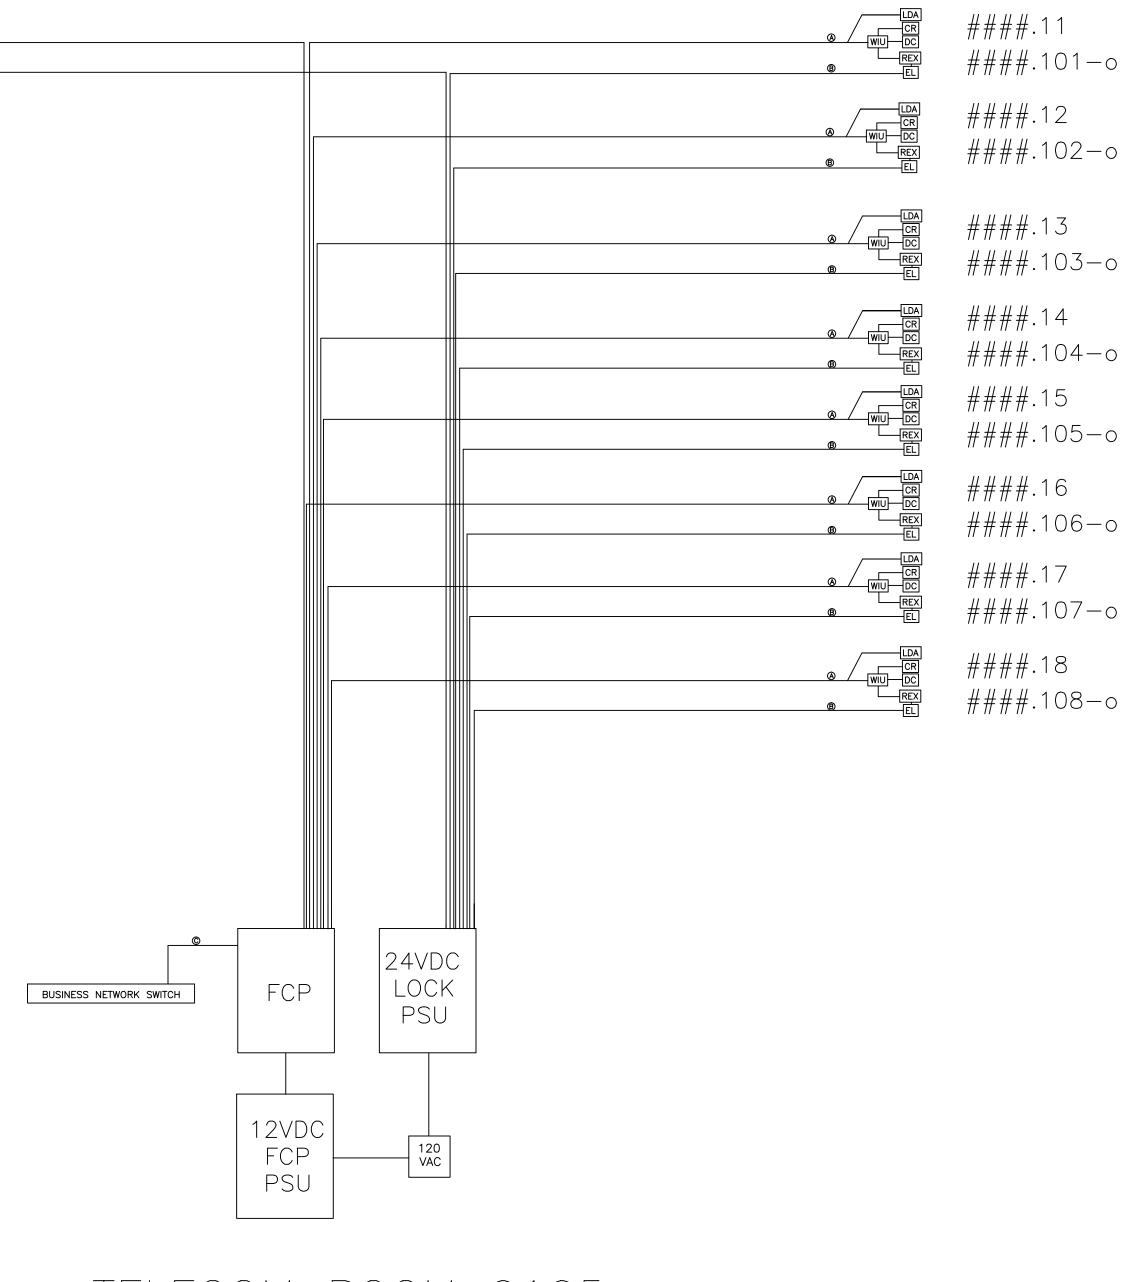



7

	9
<u>GENERAL NOTES</u>	
RISER DIAGRA	RWISE NOTED ALL CABLE SHOWN ON THE M SHALL BE FURNISHED AND INSTALLED RITY CONTRACTOR.
TELECOM ROC	DPTIC CABLE FROM EACH GATE TO THE DM SHALL BE FURNISHED AND INSTALLED RGY TELECOM SUBCONTRACTOR.
	UTION CABINETS (FDC) SHALL BE ND INSTALLED BY DUKE ENERGY TELECOM OR.
	TWORK PoE SWITCH AND EQUIPMENT RACK RNISHED AND INSTALLED BY DUKE ENERGY
	ITRACTOR SHALL FURNISH ALL PACS PMENT SHOWN ON THE RISER DIAGRAM.
	NTRACTOR SHALL FURNISH AND INSTALL MEDIA CONVERTERS SHOWN ON THE RISER
	CTION DEVICES FOR LPR CAMERAS SHALL D AND INSTALLED BY MOTOROLA

Н

G

####.11 ####.101—0 ####.13 ####.103-0 ####.14 ####.104-0 ####.15 ####.105-0 ####.16 ####.106—0 ####.17 ####.107—0

Е D С

В

	DU EN	KE ERGY®					
MAILING ADDRES P.O. BOX 1007 CHARLOTTE, NC							
Safety E	Safety Expectations:						
ILLNESS ZERO INJURY		Risk Exposures to Hazards Safe Behavior					
SEAL							
		ATIONS ON STORAGE					
DUNN, NC							
Denn, ne							
		TRUCTION					
REVISION		FOR CONS					
		SSUED FO					
<u>ک</u>							
DATE		05/24/23 BP					
MARK DA							
PROJECT NO:	<u> </u>						
		002-00000000					
ELECTRONIC FILE	NAME: BP	EY-7002 05/24/23					
CHK'D BY: E-MAIL:	BP BPAYNTER@PAYN	05/24/23 TERCONSULTING.COM					
CORPORATION AND IS MODIFIED, COPIED, OR	CONSIDERED CONFIL DISTRIBUTED WITHO	PROPERTY OF DUKE ENERGY DENTIAL. IT SHALL NOT BE DUT PRIOR APPROVAL. THIS R THE SPECIFIC PROJECT					
		GRAM NTROL SYSTEM					
SHEET NO.	Y-7	002					
	- •						

3

SECURIT	Y CABLE LEGEND
A	(1) 22AWG/6C AND (1) 18AWG/2C
В	(1) 18AWG/2C
С	(1) CAT 6
D	(1) 22AWG/6C
E	(2) FIBER PATCH CABLES
F	12 OM3 (50 MICRON) MM

Η

G

D


С

В

2


DE BUSINESS SWITCH 120VAC <u>telecom equip rack</u>


<u>telecom room 0105</u>

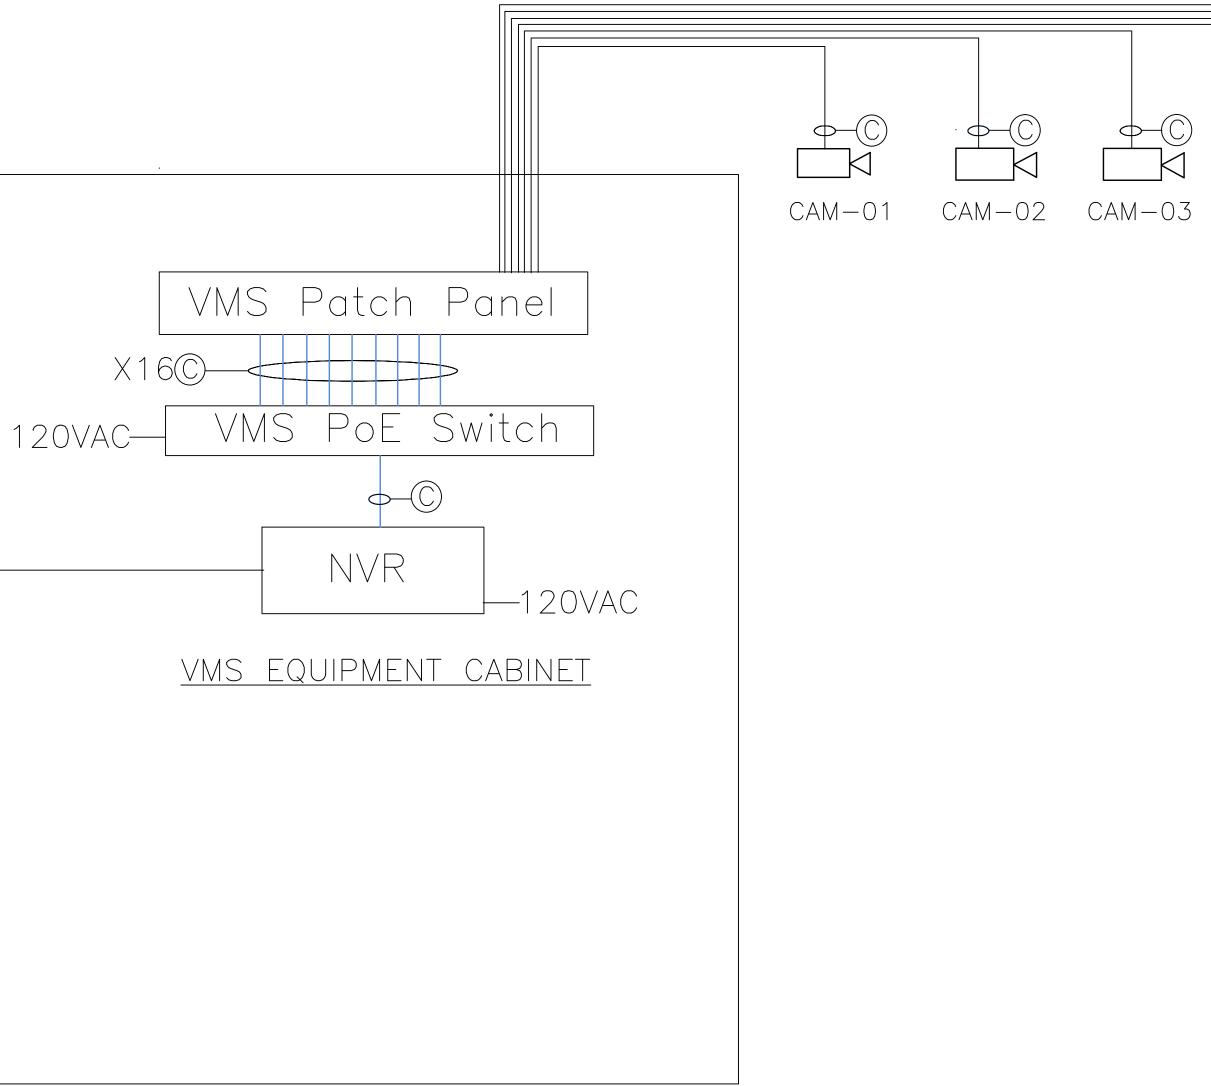

<u>GENERAL NOTES</u>:

- CAT 6 CABLE FROM CAMERAS TO PATCH PANELS SHALL BE FURNISHED AND INSTALLED BY MOTOROLA SOLUTIONS.
- 2. NVR, POE SWITCH AND VMS PATCH PANEL SHALL BE FURNISHED AND INSTALLED BY MOTOROLA SOLUTIONS.
- 3. UNLESS OTHERWISE NOTED, ALL CABLE SHOWN ON THE RISER DIAGRAM IS CAT 6.
- 4. HEAD-END VMS EQUIPMENT SHALL BE MOUNTED IN WALL MOUNTED EQUIPMENT CABINET FURNISHED AND INSTALLED BY MOTOROLA SOLUTIONS.
- 5. SURGE PROTECTION DEVICES FOR EXTERIOR CAMERAS SHALL BE FURNISHED AND INSTALLED BY MOTOROLA SOLUTIONS.

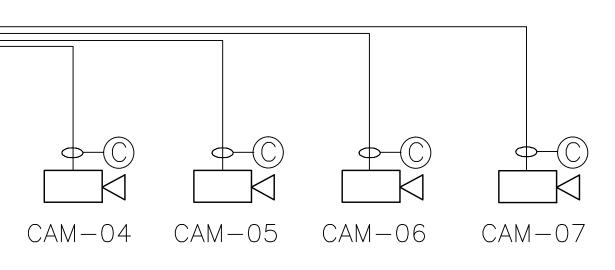

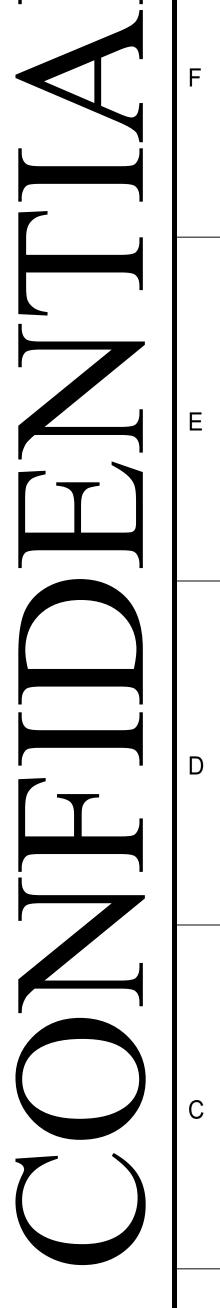

ILLNESS ZERO INJURY	Reduce Risk Remove Exposures to Reinforce Safe Behav	
SEAL		
	OPERATIC	
MOBILE SUE	STATION STO	RAGE
DUNN, NC		
		CTION
NOIS		SSUED FOR CONSTRUCTION
REVISION		FOR C
		ISSUED
AB		
DRN BY		/23 BP
ARK DATE		1 05/24/23
PROJECT NO:	00000	
DRAWING NUMBER)-EY-7003-000()0000
ELECTRONIC FILE NA	ME: EY-7003	
DRAWN BY: CHK'D BY:	BP 05/24/ BP 05/24/	
THIS DESIGN DRAWING IS T	AYNTER@PAYNTERCONSULTING.	IKE ENERGY
CORPORATION AND IS CONS MODIFIED, COPIED, OR DIST	SIDERED CONFIDENTIAL. IT SHALL RIBUTED WITHOUT PRIOR APPROV BE USED FOR THE SPECIFIC P	NOT BE /AL. THIS
RISER		
	DEO MGMT SYS	SIEM
	′-7003	
	-1000)

DUKE ENERGY®

MAILING ADDRESS: P.O. BOX 1007

CHARLOTTE, NC 28201

Safety Expectations:

Н

G

F

Е

С

В