CAITLIN CROSSING AMENITY CENTER OVERALL SITE DATA TABLE MATTHEWS ROAD, LILLINGTON, NC

TOWNSHIP NIELLS CREEK

SITE ADDRESS

CURRENT SITE OWNER (AREA / PIN / DB & PG)

CHATHAM CAPITAL GROUP LLC & EQUITY TRUST CO. (25.00 AC / 0651-62-4761 / DB 4158 PG 312) CHATHAM CAPITAL GROUP LLC & EQUITY TRUST CO. (31.397 AC / 0651-32-9794 / DB 4158 PG 102)

DEVELOPER CONTACT INFORMATION:

Maximum Blended Density for the project is 5 units per gross acre.

Driveway from Sidewalk to Garage 20' SF and 33.5' TH

Townhome satellite parking will be at 0.46 space per Townhome Unit.

Playground structure and passive lawns for informal play.

- Left and Right turn decel lanes will be provided on Matthews Road

Central amenities with pool, shelter and bathroom facilities will be provided.

20' SF and 30' TH

20' SF and 33.5' TH

Single-Family will provide at least 2 paved parking spaces. The spaces will either be within an enclosed

Townhomes provide 33.5' setback to sidewalk to allow double park car in front of garage and 1 space

5' SF and 0' TH

Townhome lot size minimum 2,190 sf Single-family lot size minimum 4,590 sf

Maximum Building height is 35 feet, maximum 3 stories.

Maximum Impervious Percentage not to exceed 54%

Perimeter 40' buffer (landscape or existing vegetation)

Sidewalks will be provided on both sides of street.

garage, driveway, or as designated parking pad.

CAROLINA LAND GROUP, LLC 341 KILMAYNE DRIVE, SUITE 201

ZONING CONDITIONS

Minimum Building Setbacks

From Buffer

Front Yard

Side Yard

Rear Yard

CARY, NC 27511

TOTAL PROJECT AREA 2.11 AC CAROLINA LAND GROUP, LLC

341 KILMAYNE DRIVE, SUITE 201, CARY, NC 27511 DEVELOPER ADDRESS

October 3, 2006

CAPE FEAR RIVER BASIN WATERSHED SUBWATERSHED NEILLS CREEK-BUIES CREEK WATERSUPPLY CLASSIFICATION WSIV-PA FEMA MAP NO. 3720064000J FEMA PANEL EFFECTIVE DATE

AUTHORITY HAVING JURISDICTION TOWN OF LILLINGTON CONDITIONAL ZONING RS10 CLUSTER CURRENT ZONING

CONDITIONAL ZONING RS10 CLUSTER PROPOSED ZONING

SETBACKS (PER ZONING CONDITIONS

SIDE STREET

SINGLE FAMILY PROJECT TOTAL

PROPOSED DENSITY 238 DUs / 56.4 AC = 4.22 DU/AC

AMENITY PARKING OUTDOOR AMUSEMENT

NO REQUIREMENT PROVIDED ACCESSIBLE PARKING PROVIDED TOTAL PARKING 28 SPACES

BICYCLE PARKING

PROPOSED DWELLING UNITS

1 PER 50 LOTS TOTAL NEIGHBORHOOD LOTS 238 REQUIRED BICYCLE PARKING 5 SPACES PROVIDED BICYCLE PARKING 6 SPACES


LANDSCAPING REQUIRED 1 LARGE TREE OR 2 SMALL TREES + 8

SHRUBS PER 20 PARKING SPACES 3 SMALL TREES

CAITLIN CROSSING AMENITY CENTER

LILLINGTON, NORTH CAROLINA

JANUARY 29, 2024

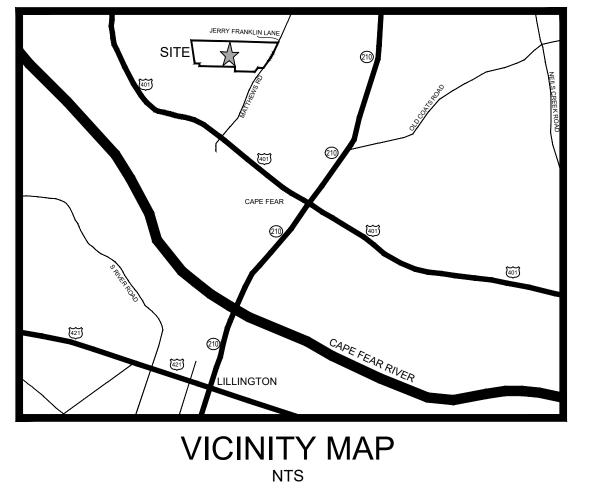

INDEX TO DRAWINGS CERTIFIED SURVEY SITE & UTILITY PLAN -GRADING PLAN -LANDSCAPE PLAN -**EROSION CONTROL DETAILS** UTILITY DETAILS -POOL HOUSE FLOOR PLAN & ROOF PLAN (BY PLANWORX)

GENERAL NOTES

- 1. BOUNDARY, TOPOGRAPHIC AND EXISTING CONDITIONS SURVEY PERFORMED BY CE GROUP, INC., AND BASED ON A SURVEY ENTITLED "TOPOGRAPHIC SURVEY" AND DATED DECEMBER 1,
- 2. WETLAND AND STREAM INFORMATION PROVIDED BY TERRACON. 3. PROPERTIES SHOWN HEREON ARE SUBJECTED TO EASEMENTS AND RESTRICTIONS OF RECORD THAT WOULD BE REVEALED BY A THOROUGH TITLE SEARCH. THIS MAP SHOULD NOT BE RELIED UPON AS A COMPLETE RECORD OF ALL SUCH EASEMENTS THAT MAY EFFECT
- 4. EXISTING UNDERGROUND STRUCTURES AND UTILITIES SHOWN ARE BASED UPON FIELD SURVEYS AND AVAILABLE RECORD DRAWINGS. THE CONTRACTOR IS RESPONSIBLE FOR FIELD VERIFYING EXISTING CONDITIONS, INCLUDING THE HORIZONTAL AND VERTICAL LOCATIONS OF ALL UTILITIES PRIOR TO STARTING CONSTRUCTION AND NOTIFY THE ENGINEER OF ANY DISCREPANCIES.
- 5. THE CONTRACTOR SHALL CONTACT 811 AT LEAST 48 HOURS PRIOR TO ANY DIGGING. 6. ALL WATER & SEWER MAINS CONSTRUCTION SHALL BE IN CONFORMANCE TO HARNETT
- REGIONAL WATER AND NCDEQ STANDARDS AND SPECIFICATIONS. 7. ALL STORM DRAINAGE CONSTRUCTION SHALL BE IN CONFORMANCE TO THE TOWN OF
- LILLINGTON AND NCDEQ STANDARDS AND SPECIFICATIONS. 8. FOR ALL WATER MAINS, AT LEAST TWO FULL JOINTS OF RESTRAINED JOINT PIPE SHALL BE INSTALLED PRIOR TO END OF PHASE LINE OR LINE TERMINUS.
- 9. ALL CONSTRUCTION WITHIN THE NCDOT R/W SHALL BE IN CONFORMANCE TO THE NCDOT STANDARDS AND SPECIFICATIONS. 10. PORTIONS OF THE SUBJECT PROPERTY ARE NOT LOCATED IN A 1% ANNUAL FLOOD HAZARD
- AREA PER FEMA FIRM PANEL MAP NUMBER 3720064000J AND DATED OCTOBER 3, 2006.
- 11. NO WETLAND AREA ALLOWED WITHIN INDIVIDUAL LOT AREA. 12. INDIVIDUAL LOT PLANS WILL NEED TO BE OBTAINED AND PERMITTED SEPARATELY.

HARNETT REGIONAL WATER GENERAL NOTES

- WATER AND SEWER WILL BE PROVIDED BY HARNETT REGIONAL WATER
- 2. WATER & SEWER MAINS WILL BE INSPECTED, OPERATED AND MAINTAINED BY HARNETT REGIONAL WATER.
- 3. APPROVAL OF THIS PLAT/PLAN DOES NOT GUARANTEE WATER CAPACITY. CURRENT/FUTURE CAPACITY MAY NOT BE AVAILABLE. THIS DEVELOPMENT MAY REQUIRE ADDITIONAL IMPROVEMENTS TO THE EXISTING WATER SYSTEM TO MEET FUTURE WATER AND SEWER DEMANDS PRIOR TO A PRELIMINARY PLAT, CONSTRUCTION PLAN AND/OR FINAL PLAT APPROVAL.
- 4. SIDEWALKS AND STREET TREES ARE TO BE MAINTAINED BY THE PROPERTY OWNERS ASSOCIATION (POA) OR ANY OTHER ASSOCIATION RESPONSIBLE FOR THE MAINTENANCE OR UPKEEP OF THE RESIDENTIAL COMMUNITY. SIDEWALK OR STREET TREE INSTALLATIONS THAT ARE DAMAGED AND/OR REMOVED BY HARNETT COUNTY DEPARTMENT OF PUBLIC UTILITLIES / HARNETT REGIONAL WATER OR ITS REPRESENTATIVES. AGENTS, OR CONTRACTORS AS A RESULT OF REPAIR/MAINTENANCE OF THE PUBLIC WATER LINE WILL BE REPLACED OR REPAIRED BY THE PROPERTY OWNERS ASSOCIATION, OR ANY OTHER ASSOCIATION RESPONSIBLE FOR THE MAINTENANCE AND/OR UPKEEP OF THE RESIDENTIAL COMMUNITY.
- 5. THE CONTRACTOR MUST COORDINATE WITH THE ENGINEER OF RECORD AND MR. CHAD EVERETTE, UTILITY CONSTRUCTION INSPECTOR HRW FOR REGULAR INSPECTION VISITATIONS
- 6. SEWER SERVICES CONNECTING TO MANHOLES MUST COME IN AT BENCH LEVEL AND SERVICE


GENERAL DEVELOPMENT NOTES

- 1. ALL OPEN SPACE, SIGNAGE, MAIL KIOSKS, DRAINAGE EASEMENTS, LANDSCAPING & PARKING LOTS NOT IN TOWN OR NCDOT PURVIEW SHALL BE MAINTAINED BY PROPERTY OWNERS ASSOCIATION.
- 2. ALL GARAGES SHALL BE FRONT LOADED. 3. ALL DRIVEWAYS SHALL BE CONCRETE AND MEET TOWN OF LILLINGTON SPECIFICATIONS.
- 4. FOUNDATION SURVEYS SHALL BE REQUIRED FOR ALL LOTS.
- 5. NO PARKING WILL BE ALLOWED IN THE PUBLIC RIGHT-OF-WAY. 6. SANITARY SEWER SERVICES FOR ALL LOTS MUST BE INSTALLED AT TIME OF OUTFALL INSTALLATION.
- 7. PUBLIC WATER AND SEWER SHALL BE PROVIDED BY HARNETT REGIONAL WATER. 8. ALL STORM PIPE SHALL BE CLASS III REINFORCED CONCRETE PIPE UNLESS OTHERWISE NOTED.

TOWN OF LILLINGTON NOTES

- 1. ALL PUBLIC FACILITIES, INCLUDING STORM DRAINAGE, SIDEWALKS, AND HANDICAP RAMPS ARE TO BE CONSTRUCTED ON ALL STREETS AS SPECIFIED BY TOWN AND NCDOT STANDARDS. THESE FACILITIES HAVE BEEN APPROVED BY THE TOWN OF LILLINGTON AND SHALL BE SO INSTALLED UNLESS A CHANGE IS APPROVED BY THE TOWN OF LILLINGTON.
- 2. OWNER HEREBY CERTIFIES AND AGREES TO TAKE SUCH ACTION AS MAY BE REQUIRED BY THE TOWN OF LILLINGTON TO CORRECT ANY ERRORS, OMISSIONS OR NON-COMPLIANCE WITH TOWN STANDARDS AND/OR CONDITIONS DESCRIBED IN THIS CONSTRUCTION PLAN, INCLUDING RESUBMISSION OR RE-EXECUTION OF THIS CONSTRUCTION PLAN WITH THE APPROPRIATE CORRECTIONS AND/OR REVISIONS.

PLANNING	DATE
PUBLIC WORKS	DATE
DRAINAGE & EROSION CONTROL	DATE

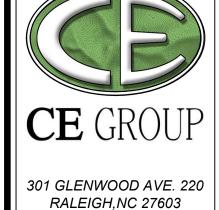

PHONE: 919-367-8790

FAX: 919-322-0032

www.cegroupinc.com


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JANUARY 29, 2024 Checked: Project No. 147-03

> Computer Dwg. Name 147-03 amenity cover

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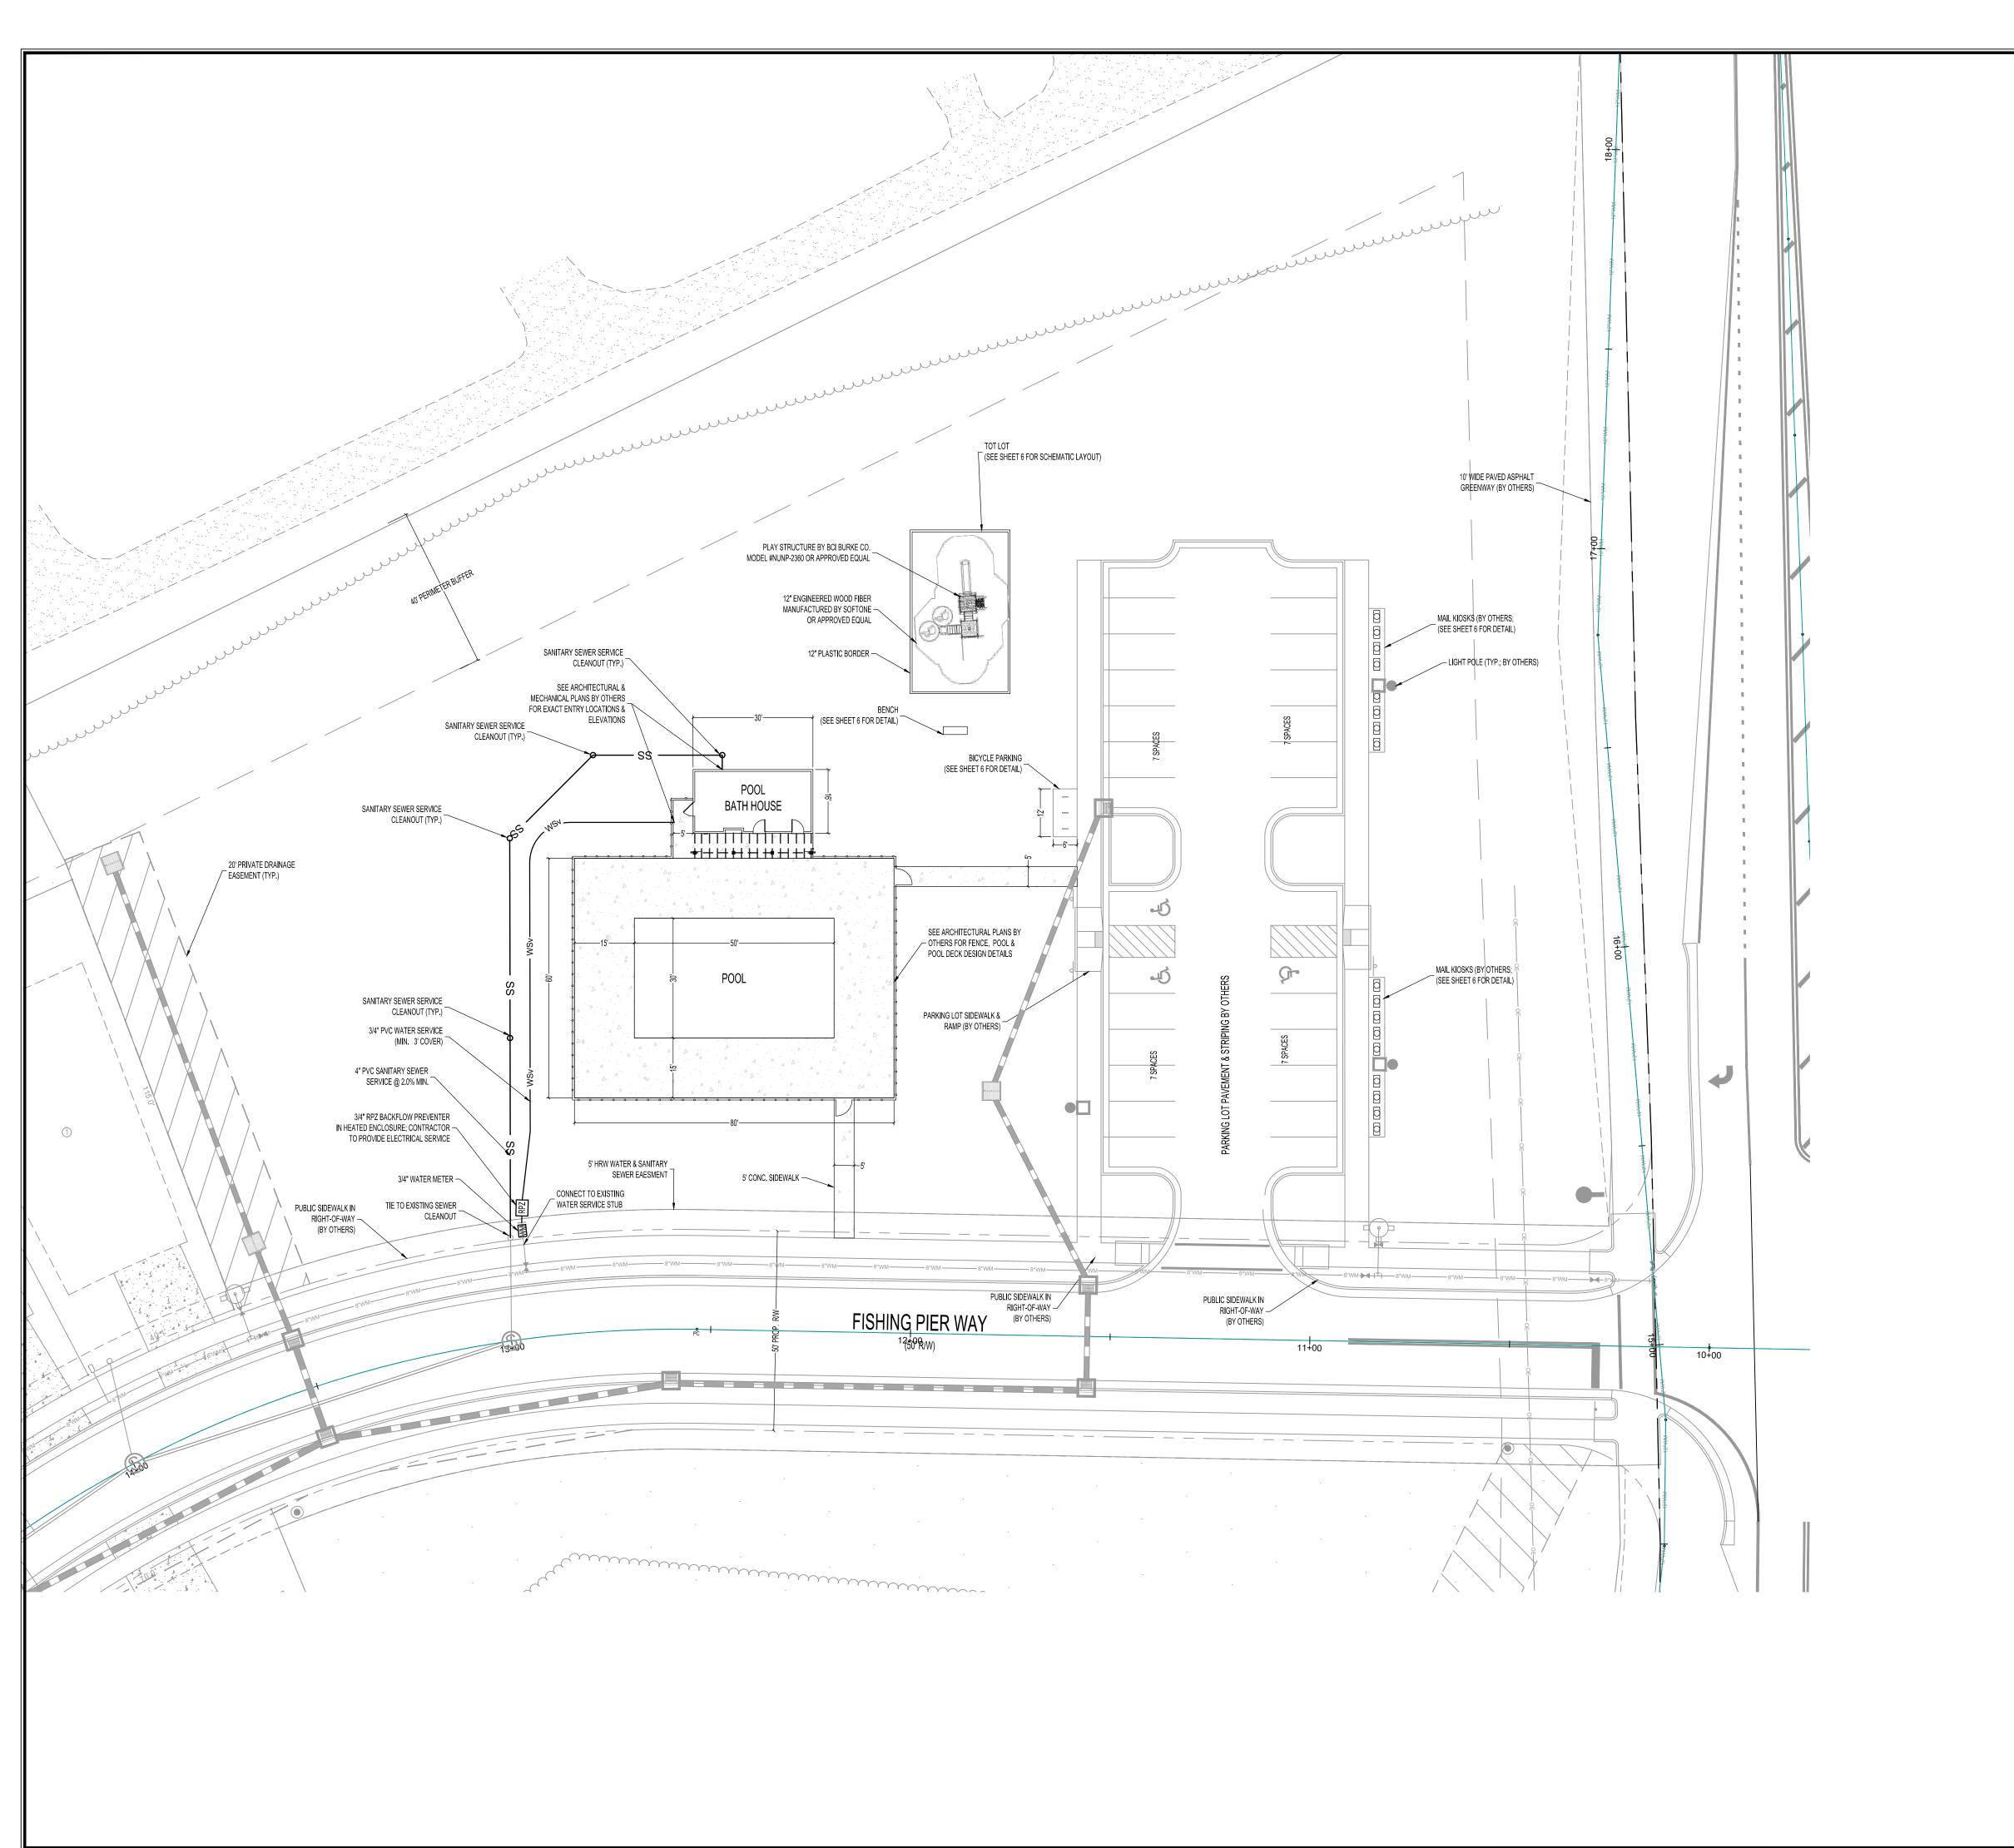
LILLINGTON, NORTH CAROLINA

JANUARY 29, 2024

######### Drawn: AJF

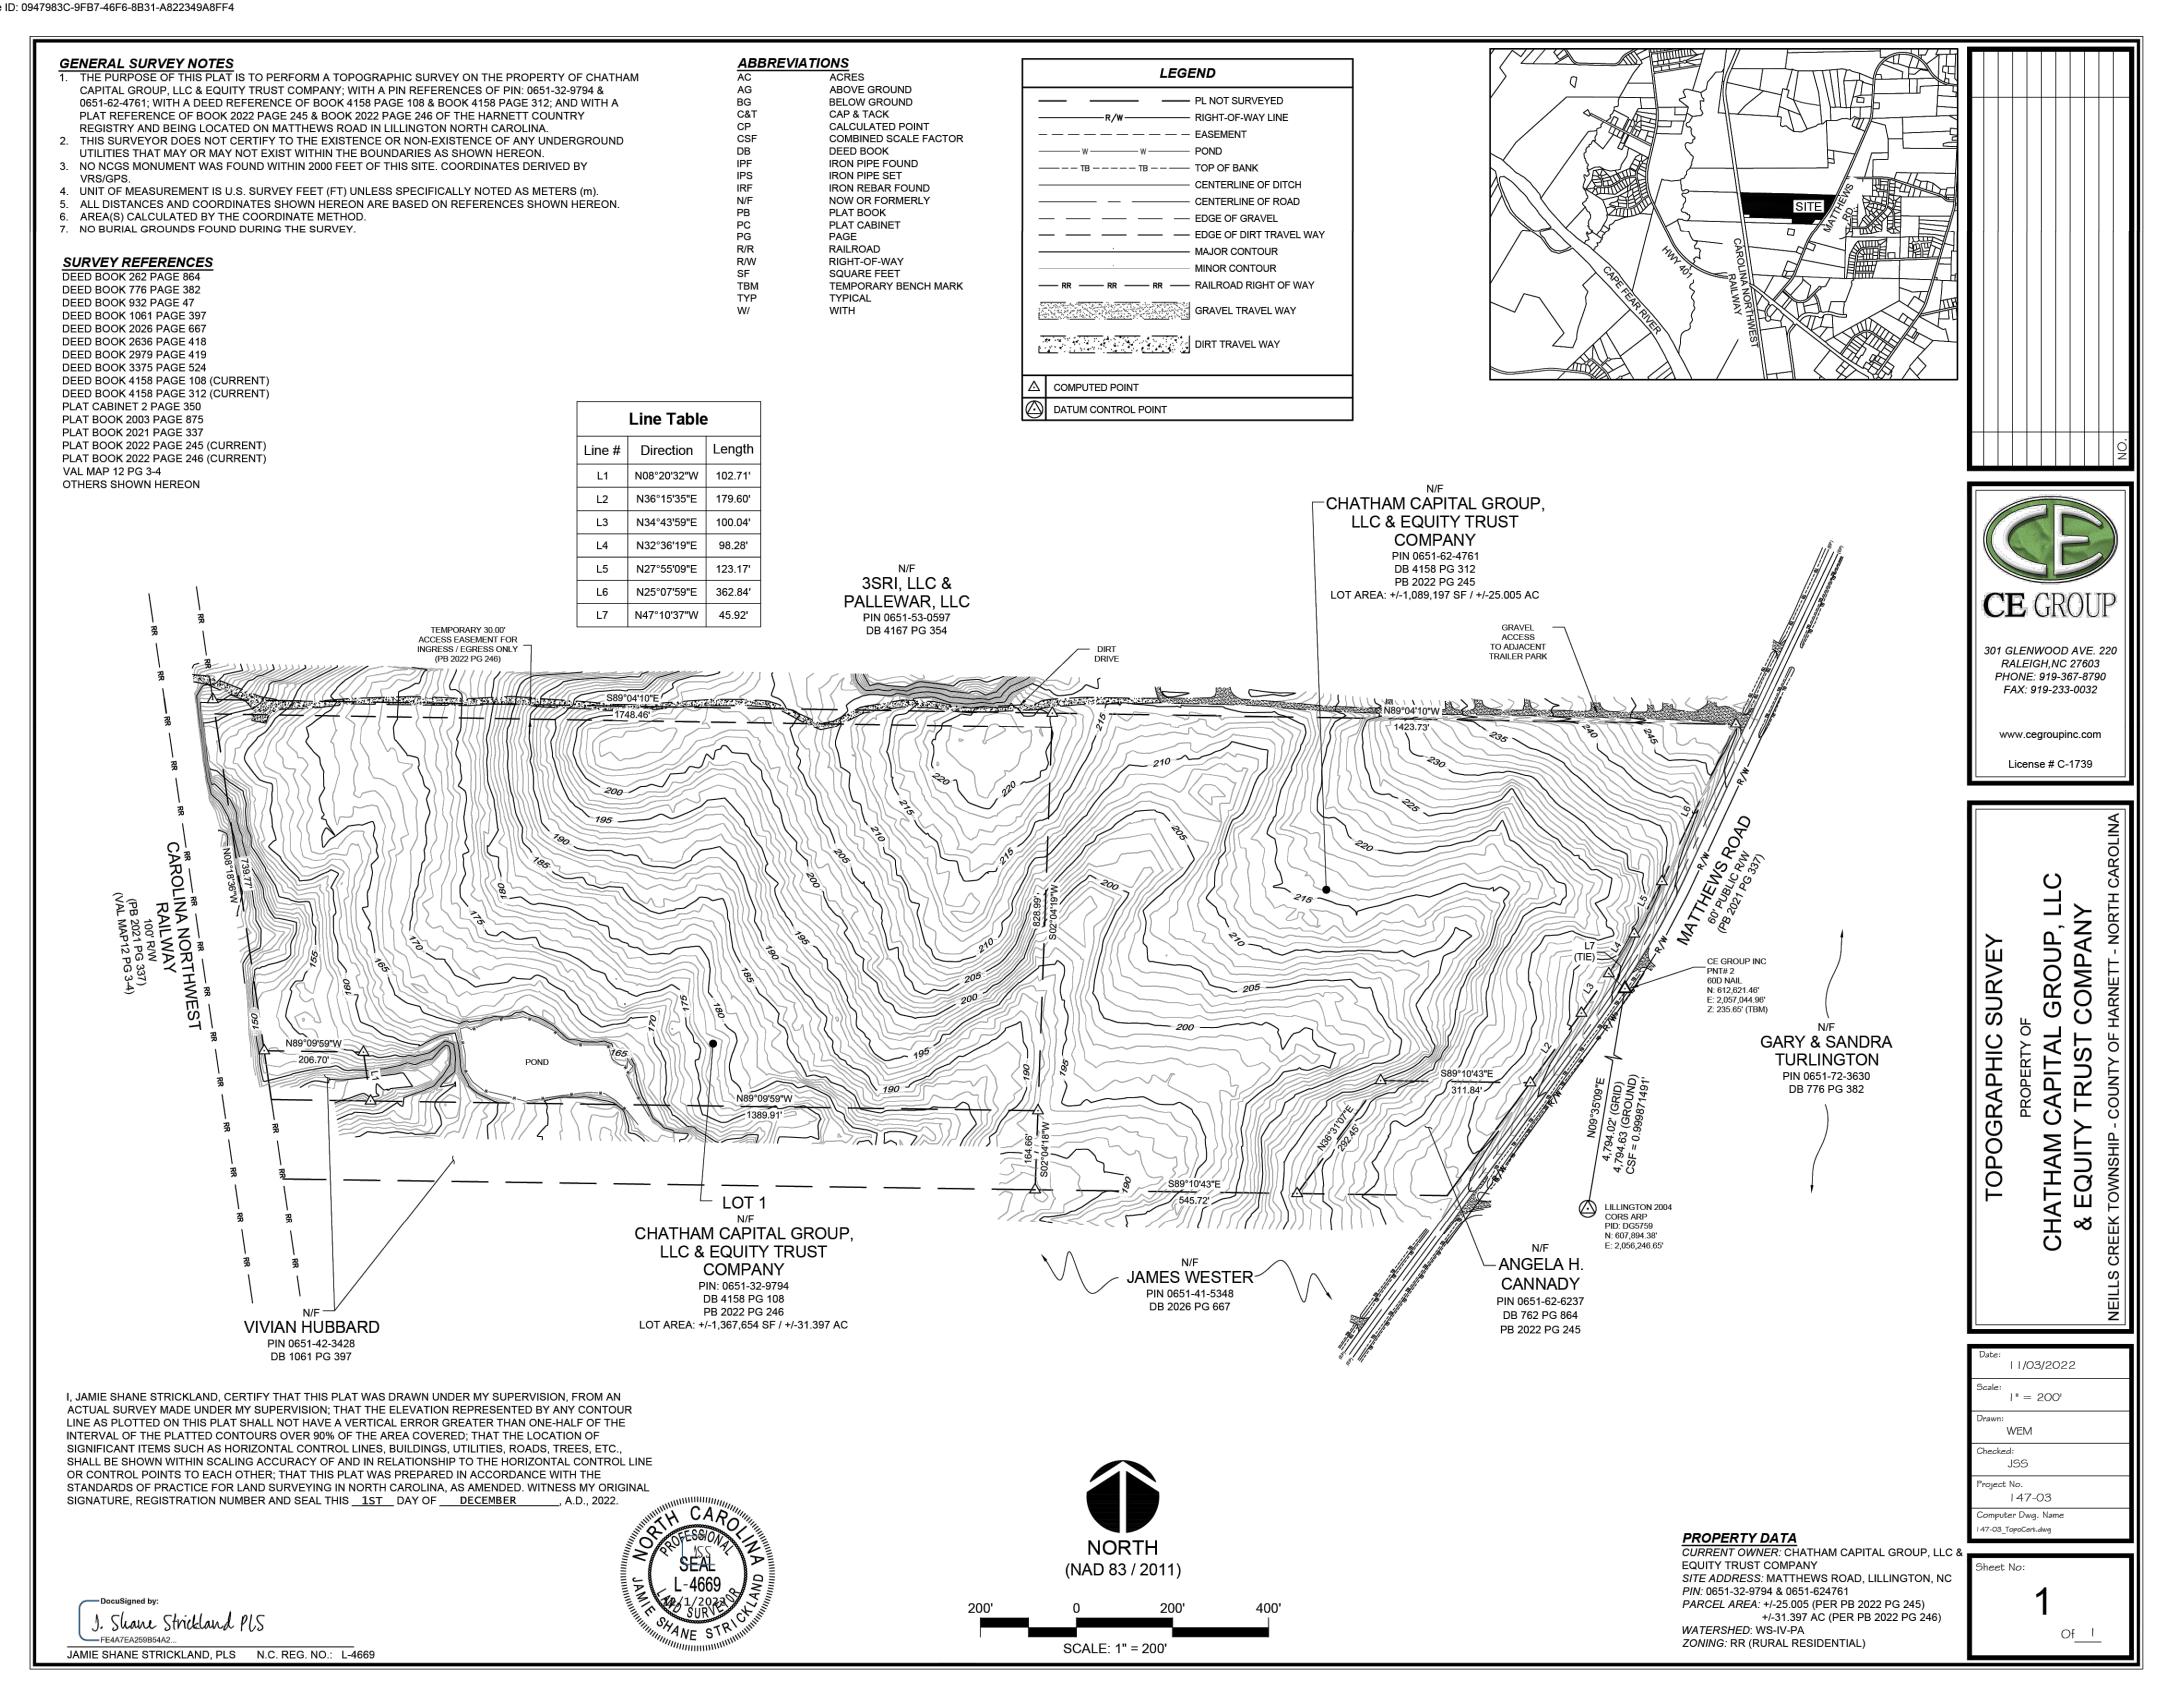Checked: AJF Project No. 147-03

Computer Dwg. Name 147-03 certified survey



CAITLIN CROSSING AMENITY CENTER OVERALL SITE DATA TABLE

OVERALL SITE DATA TABLE
SITE ADDRESS
MATTHEWS ROAD, LILLINGTON, NC

TOWNSHIP NIELLS CREEK

CURRENT SITE OWNER (AREA / PIN / DB & PG)

CHATHAM CAPITAL GROUP LLC & EQUITY TRUST CO. (25.00 AC / 0651-62-4761 / DB 4158 PG 312)
CHATHAM CAPITAL GROUP LLC & EQUITY TRUST CO. (31.397 AC / 0651-32-9794 / DB 4158 PG 102)

TOTAL SUBDIVISION AREA 56.40 AC

TOTAL PROJECT AREA

DEVELOPER

CAROLINA LAND GROUP, LLC

DEVELOPER ADDRESS

341 KILMAYNE DRIVE, SUITE 20:

DEVELOPER ADDRESS

341 KILMAYNE DRIVE, SUITE 201, CARY, NC 27511

WATERSHED

CAPE FEAR RIVER BASIN

NELLS OFFEK BUIES OFFEK

<u>SUBWATERSHED</u> NEILLS CREEK-BUIES CREEK

<u>WATERSUPPLY CLASSIFICATION</u> WSIV-PA

FEMA PANEL EFFECTIVE DATE

AUTHORITY HAVING JURISDICTION

CURRENT ZONING

October 3, 2006

TOWN OF LILLINGTON

CONDITIONAL ZONING RS10 CLUSTER

3720064000J

PROPOSED ZONING

SETBACKS (PER ZONING CONDITIONS)

TOWNHOMES SINGLE FAMILY

 SIDE
 0
 5'

 SIDE STREET
 0
 15'

 REAR
 10
 20'

 PROPOSED DWELLING UNITS
 20'

TOWNHOMES SINGLE FAMILY
PROJECT TOTAL 100 138

PROPOSED DENSITY 238 DUs / 56.4 AC = 4.22 DU/AC

AMENITY PARKING

DESIGNATION OUTDOOR AMUSEMENT

NO REQUIREMENT

PROVIDED ACCESSIBLE PARKING 3 SPACES
PROVIDED TOTAL PARKING 28 SPACES

BICYCLE PARKING

FEMA MAP NO.

DESIGNATION 1 PER 50 LOTS

TOTAL NEIGHBORHOOD LOTS 238

REQUIRED BICYCLE PARKING 5 SPACES

PROVIDED BICYCLE PARKING 6 SPACES

PARKING LANDSCAPING

LANDSCAPING REQUIRED 1 LARGE TREE OR 2 SMALL TREES + 8

SHRUBS PER 20 PARKING SPACES

1 LARGE TREES

OR 3 SMALL TREES

11 SHRUBS

GENERAL UTILITY NOTES

- EXISTING UTILITIES ARE SHOWN FROM THE BEST AVAILABLE INFORMATION AND ARE APPROXIMATE. IT IS THE CONTRACTOR'S
 RESPONSIBILITY TO VERIFY THESE AND OTHER UTILITIES PRIOR TO BEGINNING ANY DEMOLITION OR CONSTRUCTION. NOTIFY
 UTILITY LOCATING COMPANY (ONE CALL @ 1-800-632-4949) OR INDIVIDUAL UTILITY OWNERS FOR UNDERGROUND LOCATIONS
 AT LEAST 48 HOURS IN ADVANCE.
- 2. ALL MATERIALS & CONSTRUCTION METHODS SHALL BE IN ACCORDANCE WITH THE TOWN OF LILLINGTON, HARNETT REGIONAL WATER (HRW) AND NCDEQ.
- 3. ANY NECESSARY FIELD REVISIONS ARE SUBJECT TO REVIEW & APPROVAL OF AN AMENDED PLAN AND/OR PROFILE BY THE TOWN OF LILLINGTON AND HRW PRIOR TO CONSTRUCTION
- CONTRACTOR SHALL MAINTAIN CONTINUOUS WATER & SEWER SERVICE TO EXISTING RESIDENCES & BUSINESSES
 THROUGHOUT CONSTRUCTION OF PROJECT. ANY NECESSARY SERVICE INTERRUPTIONS SHALL BE PRECEDED BY A 24 HOUR
 ADVANCE NOTICE TO HRW.
- 5. CONTRACTOR IS RESPONSIBLE FOR CONTACTING THE APPROPRIATE UTILITY COMPANY TO RELOCATE ANY EXISTING UTILITY POLES AND/OR STRUCTURES AS SHOWN ON THE PLANS, OR AS NEEDED FOR CONSTRUCTION. ALL EXISTING FACILITIES WHICH CONFLICT WITH THE IMPROVEMENTS UNDER THE SCOPE OF THIS PROJECT SHALL BE RELOCATED AT THE EXPENSE OF THE APPLICANT UPON APPROVAL.
- 6. CONTRACTOR IS RESPONSIBLE FOR ANY TRAFFIC CONTROL FOR WORK WITHIN NCDOT RIGHT-OF-WAY. BEFORE DOING WORK WITHIN RIGHT-OF-WAY, CONTACT NCDOT DISTRICT OFFICE AT LEAST 48 HOURS PRIOR TO BEGINNING WORK.
- 7. CONTRACTOR TO COORDINATE UTILITY PLAN WITH ELECTRICAL PLANS, BY OTHERS, FOR ELECTRICAL AND TELECOMMUNICATIONS ROUTING AND CONNECTION INFORMATION.
- 8. CONTRACTOR TO FIELD ADJUST VALVE BOXES, CLEAN-OUTS, AND MANHOLE RIMS TO MATCH FINAL GRADES.
- 9. SEE HARNETT REGIONAL WATER DETAIL W-12 ON SHEET 8 FOR WATER SERVICE INSTALLATION.


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12. INDIVIDUAL LOT PLANS WILL NEED TO BE OBTAINED AND PERMITTED SEPARATELY.





SCALE: 1" = 20'

1" = 20'

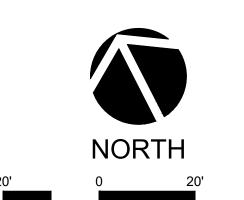Drawn:
RJH

Checked:
AJF


Project No.
147-03

Computer Dwg. Name
147-03 amenity site plan

Sheet No:

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JANUARY 29, 2024

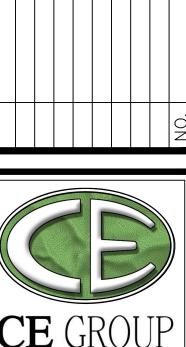

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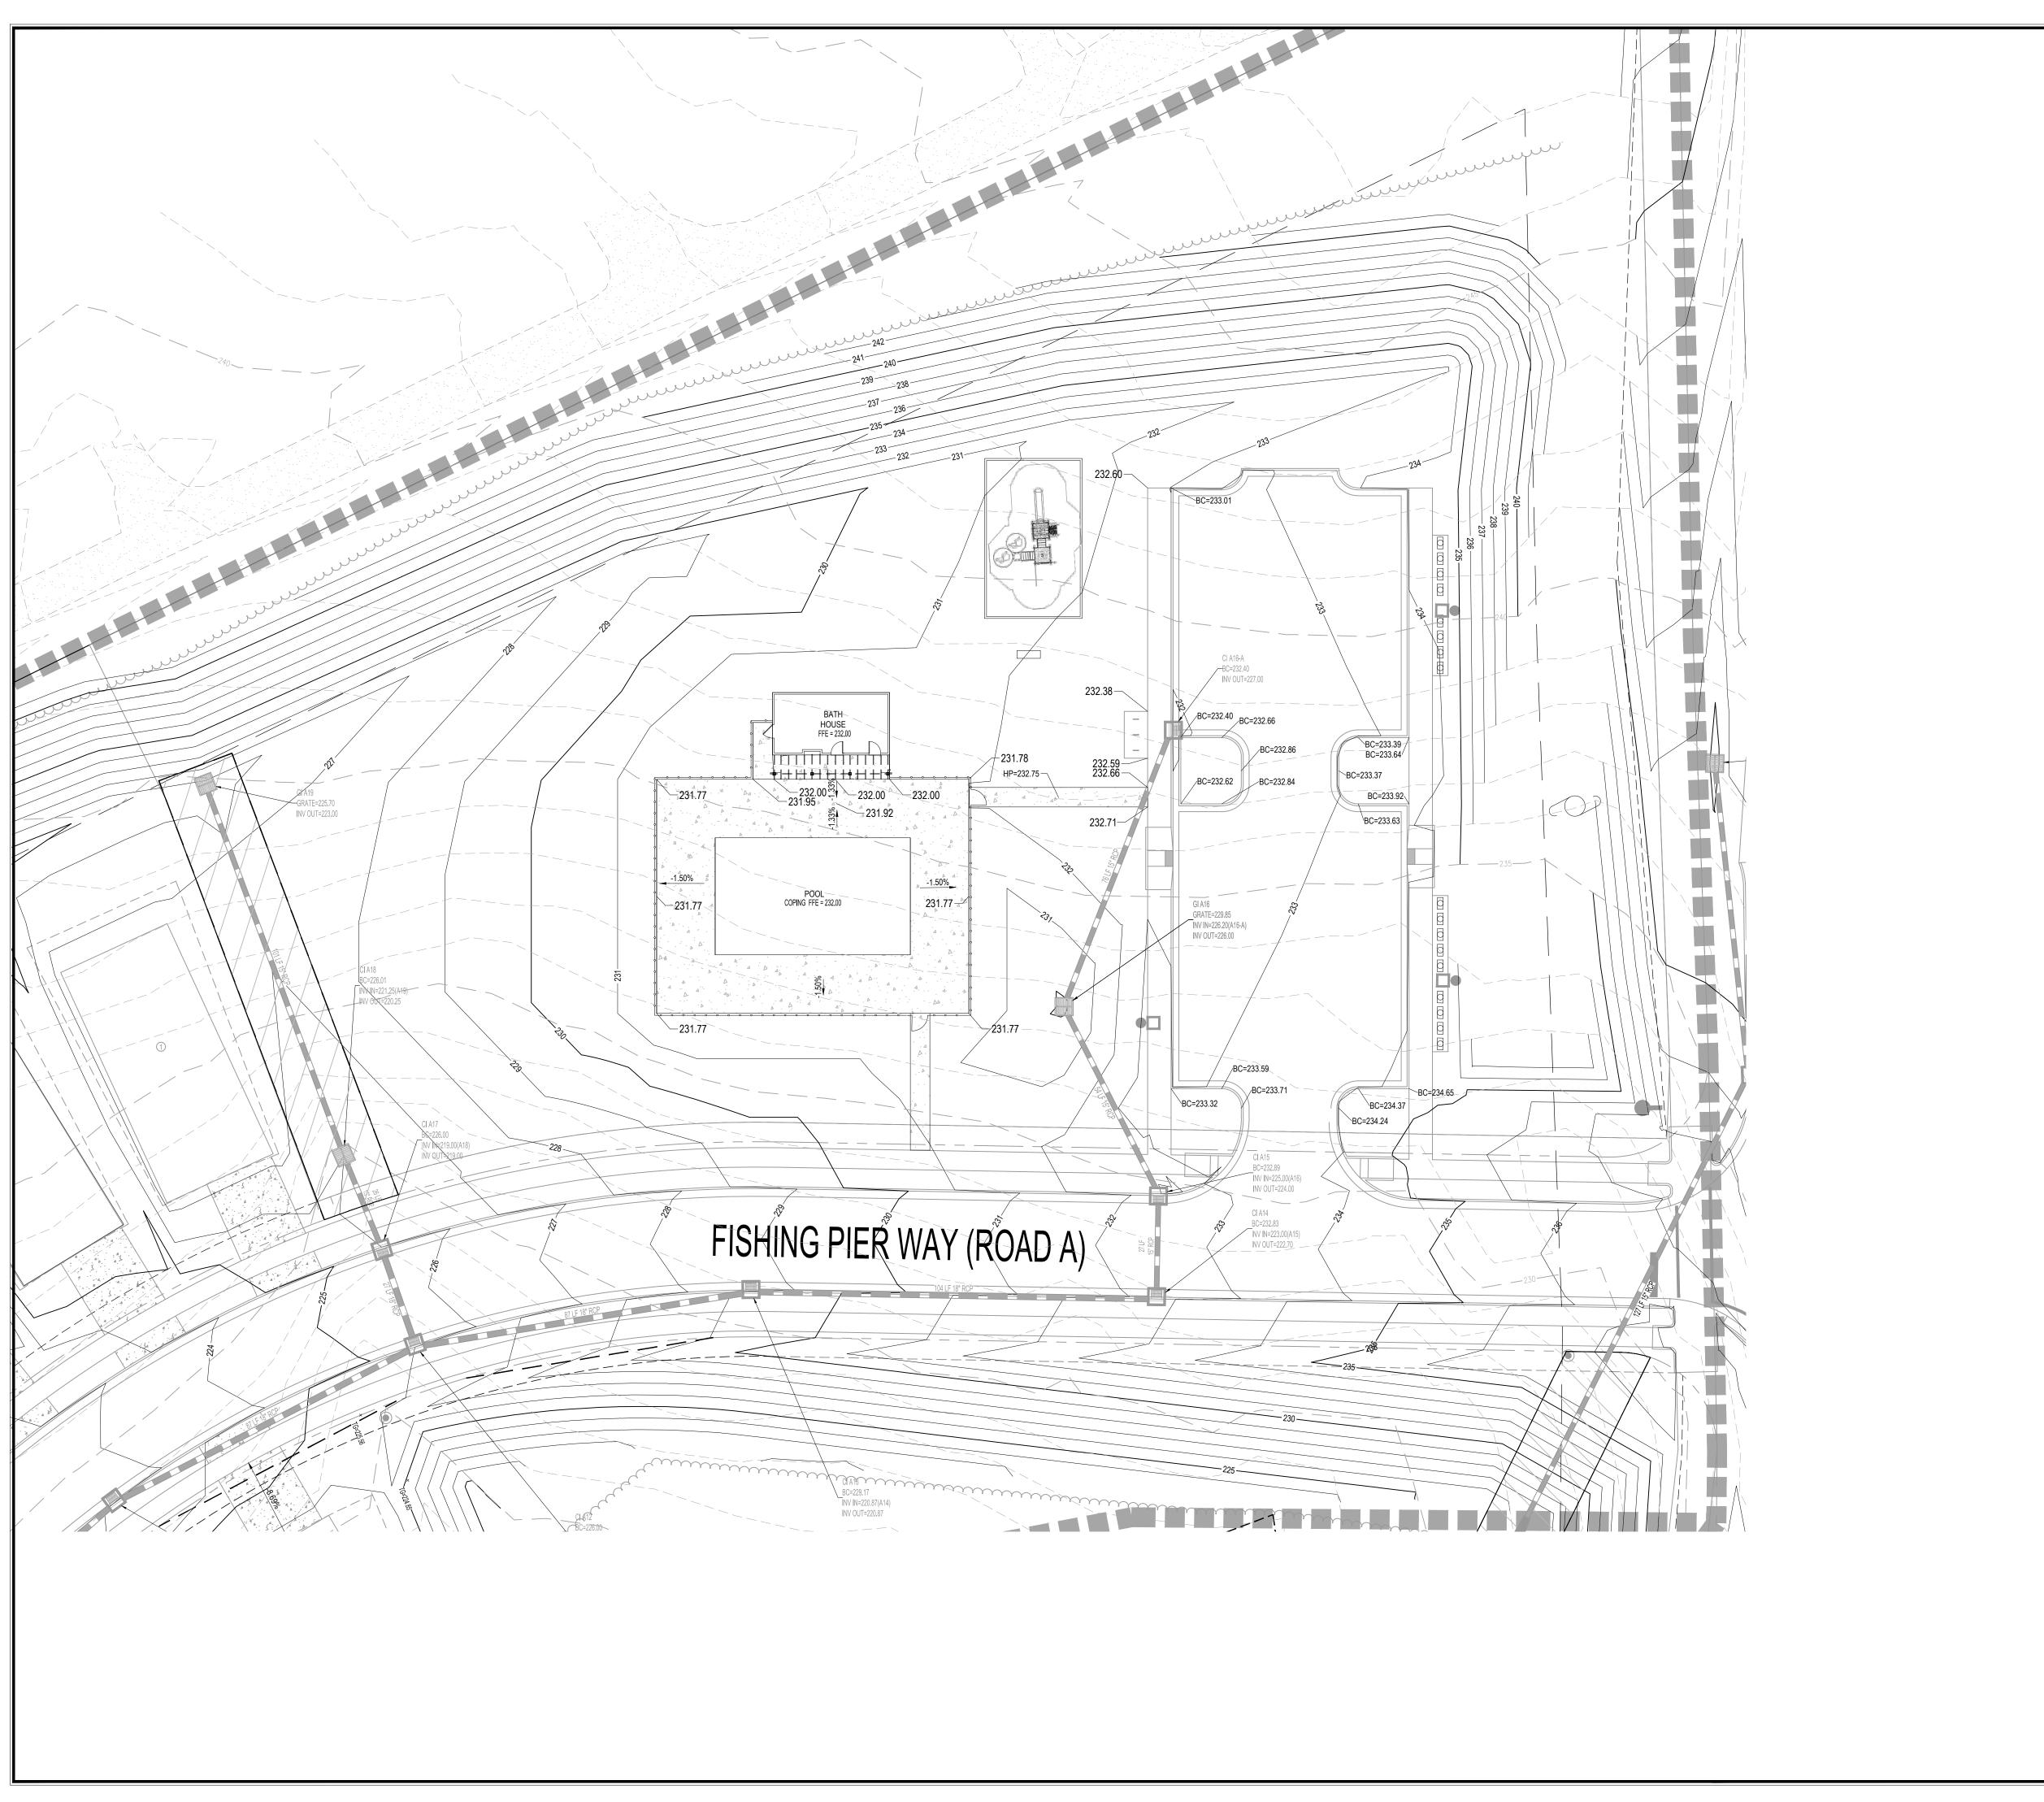
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CAROLINA

LILLINGTON, NORTH





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LILLINGTON, NORTH CAROLINA

GENERAL GRADING NOTES

- 1. STORM DRAINAGE SHOWN TO BE INSTALLED DURING SUBDIVISION CONSTRUCTION. ENSURE POSITIVE DRAINAGE TO ALL STRUCTURES. 2. POOL HOUSE DOWNSPOUTS TO SURFACE DRAIN; ENSURE POSITIVE DRAINAGE AWAY FROM
- 3. PARKING LOT AND MAIL KIOSKS TO BE INSTALLED DURING SUBDIVISION CONSTRUCTION. 4. SEE PLAYGROUND MANUFACTURER SPECIFICATIONS FOR SURFACE MATERIAL AND DRAINAGE REQUIREMENTS.

GENERAL NOTES

STRUCTURE.

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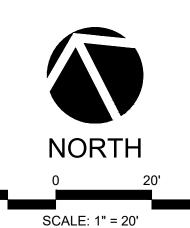
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LEGEND

- BC BACK OF CURB ELEVATION
- CI CURB INLET GI GRATE INLET
- TC TOP OF CONCRETE TG TOP OF GROUND ELEVATION
- VALLEY CURB PRIVATE DRAINAGE EASEMENT








JANUARY 29, 2024 1" = 20' RJH Checked:

AJF

CAITLIN CRC AMENITY CE GRADING I

Project No. 147-03 Computer Dwg. Name 147—03 amenity grading plan

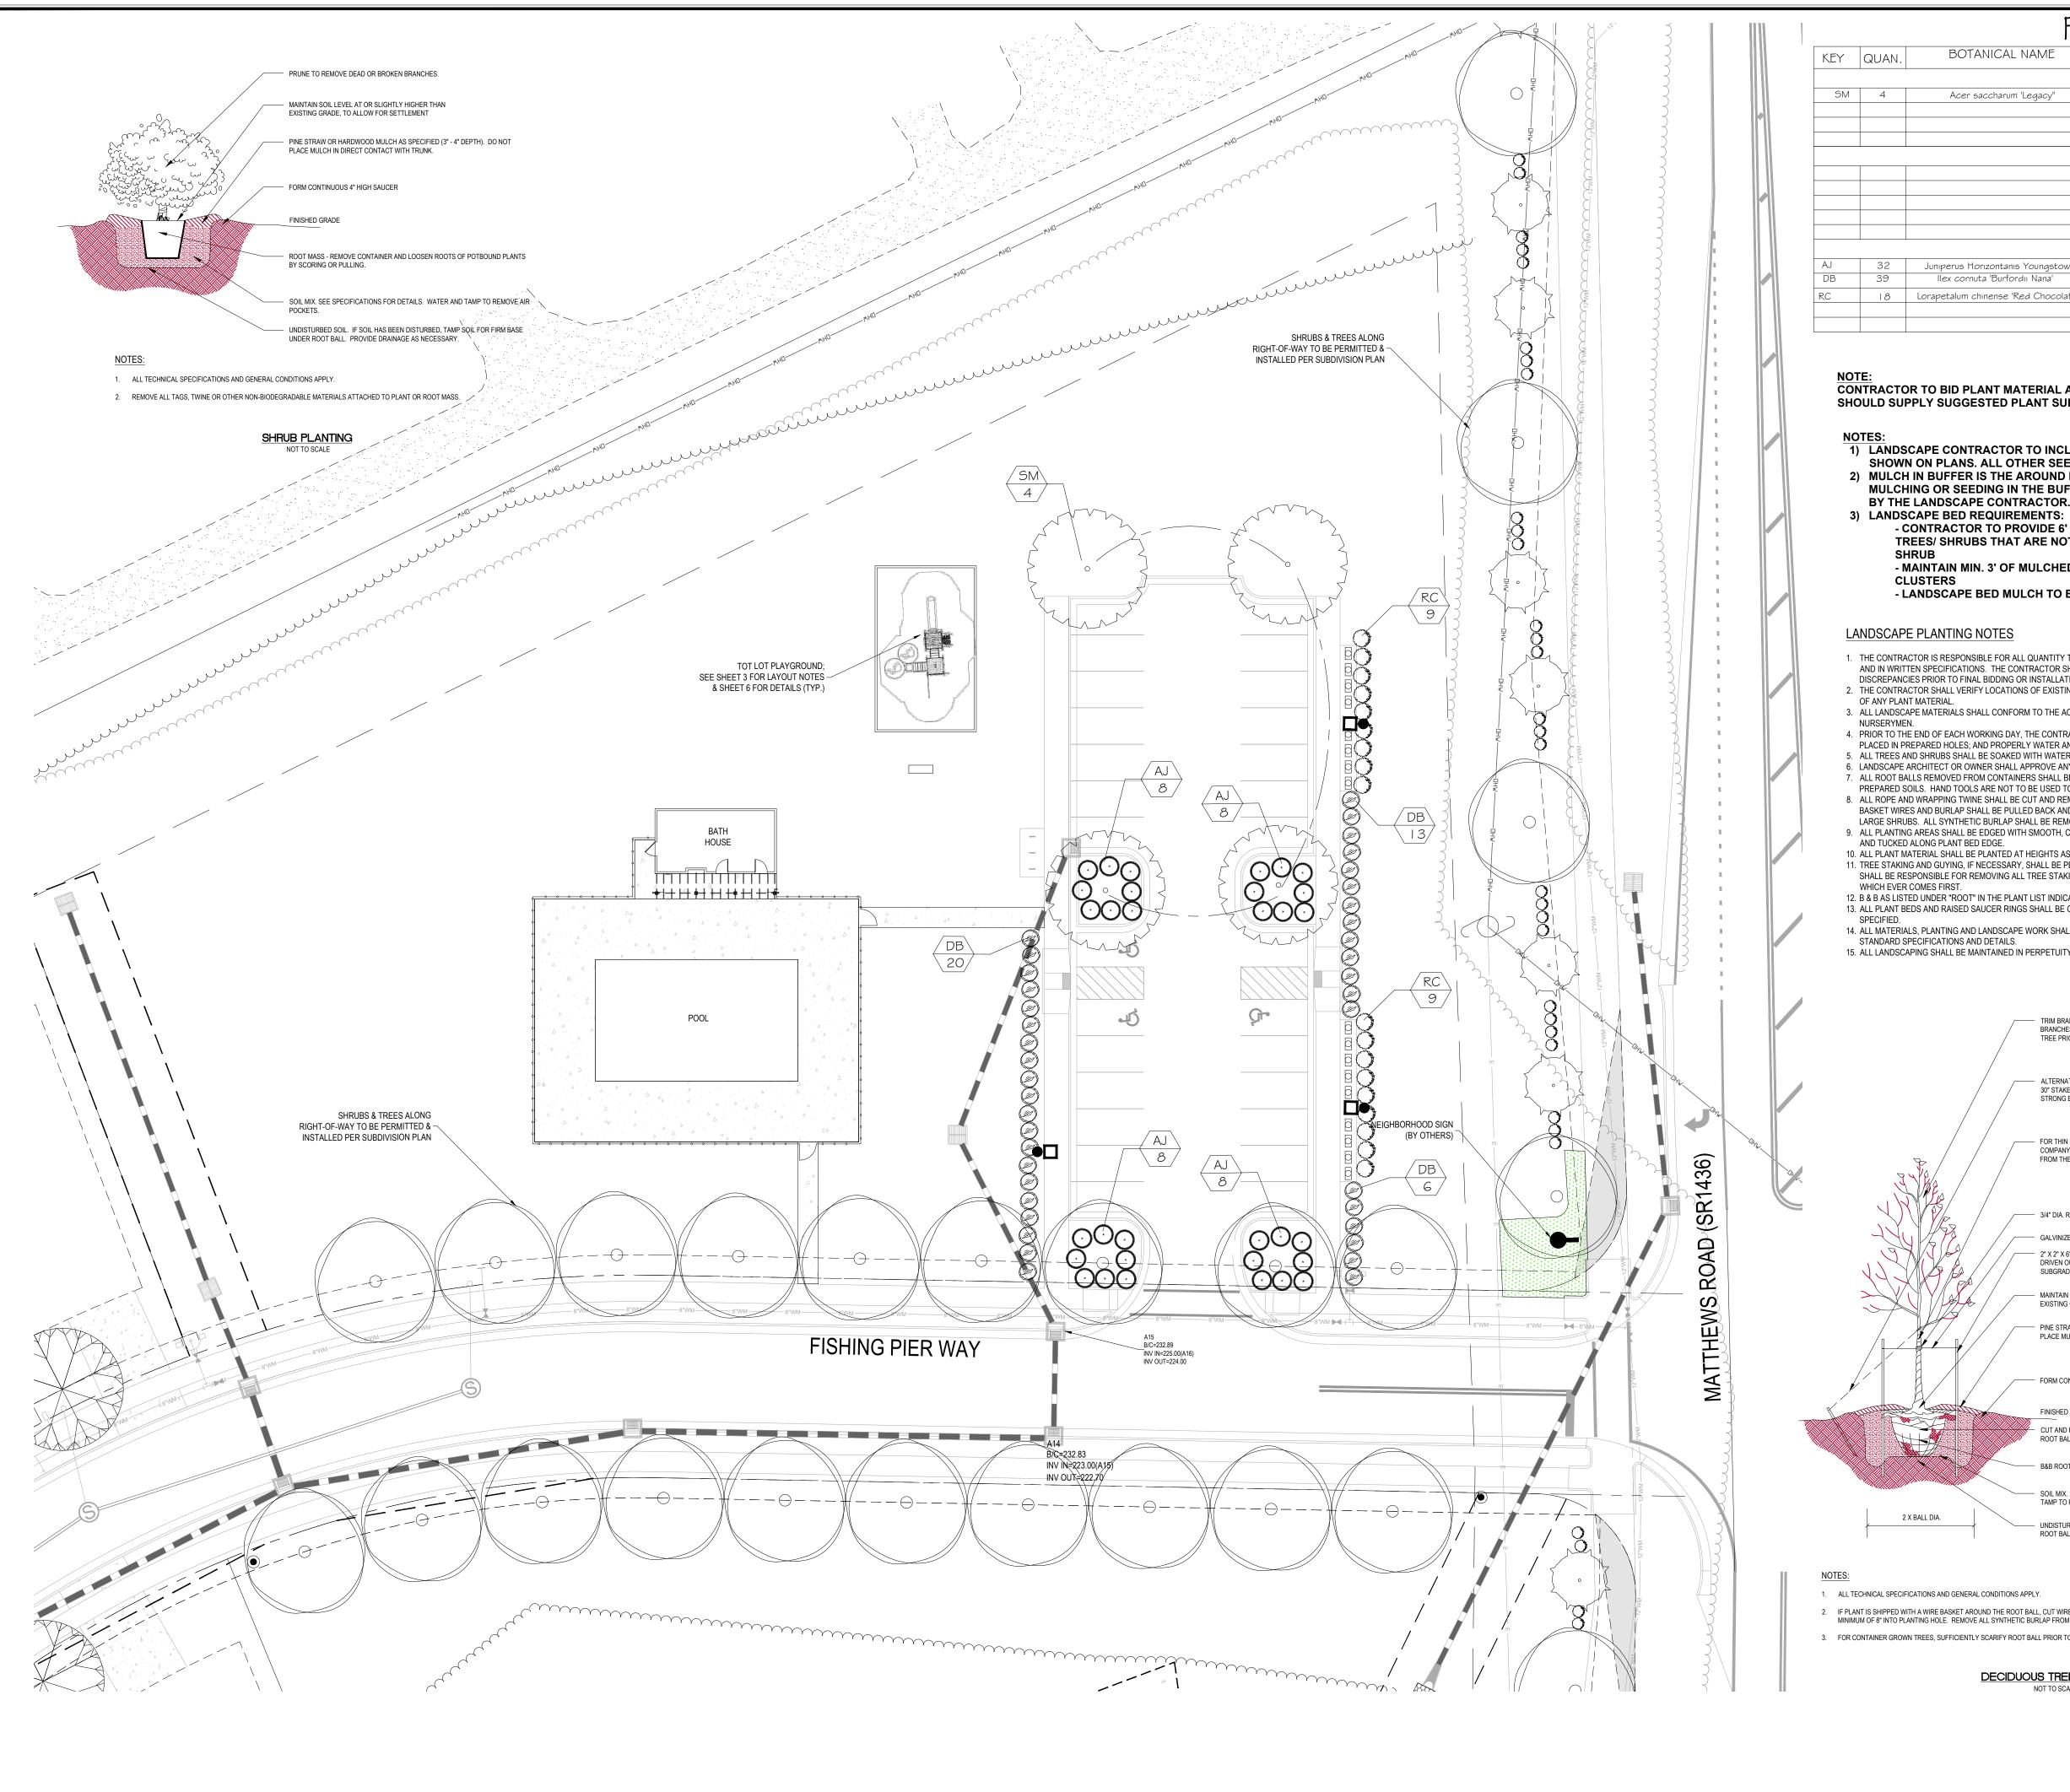



KEY	QUAN.	BOTANICAL NAME	COMMON NAME	CAL.	HT.	ROOT	REMARKS
							,
SM	4	Acer saccharum 'Legacy"	Legacy Sugar Maple	Cal 3"	12'-14' ht.	В≉В	STREET TREES ON LOT
		UND	ERSTORY TREES				
			SHRUBS				
AJ	32	Juniperus Horizontanis Youngstown	Anporra Juniper		2'- 5' ht.	3 gal.	
DB	39	llex cornuta 'Burfordıı Nana'	Dwarf Burford Holly		18"-24" ht	. 5 gal.	
RC	18	Lorapetalum chinense 'Red Chocolate'	Red Chocolate Loropetalum		18"-24"ht.	7 gal.	

CONTRACTOR TO BID PLANT MATERIAL AND SIZES SHOWN. WHEN THE BID IS SUBMITTED, CONTRACTOR SHOULD SUPPLY SUGGESTED PLANT SUBSTITUTIONS (WITH COST SAVINGS) FOR OWNER TO CONSIDER.

1) LANDSCAPE CONTRACTOR TO INCLUDE SOD/SEED ONLY WHERE SHOWN ON PLANS. ALL OTHER SEEDING BY SITE CONTRACTOR.


2) MULCH IN BUFFER IS THE AROUND EACH INDIVIDUAL PLANT, MASS MULCHING OR SEEDING IN THE BUFFER IS NOT REQUIRED TO BE BID BY THE LANDSCAPE CONTRACTOR.

- CONTRACTOR TO PROVIDE 6' DIAMETER BEDS AROUND SINGLE TREES/ SHRUBS THAT ARE NOT WITHIN 4' OF ANY OTHER TREE/ - MAINTAIN MIN. 3' OF MULCHED BED OUTSIDE ALL TREE/ SHRUB

- LANDSCAPE BED MULCH TO BE MIN. DEPTH OF 3" - 4"

LANDSCAPE PLANTING NOTES

- 1. THE CONTRACTOR IS RESPONSIBLE FOR ALL QUANTITY TAKE-OFFS AND VERIFICATION OF MATERIALS AS SHOWN ON THESE PLANS AND IN WRITTEN SPECIFICATIONS. THE CONTRACTOR SHALL NOTIFY THE OWNER AND THE LANDSCAPE ARCHITECT OF ANY
- DISCREPANCIES PRIOR TO FINAL BIDDING OR INSTALLATION. 2. THE CONTRACTOR SHALL VERIFY LOCATIONS OF EXISTING AND PROPOSED UNDERGROUND UTILITIES PRIOR TO THE INSTALLATION
- OF ANY PLANT MATERIAL. 3. ALL LANDSCAPE MATERIALS SHALL CONFORM TO THE ACCEPTED STANDARDS ESTABLISHED BY THE AMERICAN ASSOCIATION OF
- 4. PRIOR TO THE END OF EACH WORKING DAY, THE CONTRACTOR SHALL PROPERLY BACKFILL ALL PLANT MATERIAL THAT HAS BEEN PLACED IN PREPARED HOLES; AND PROPERLY WATER AND MULCH ALL PREPARED GROUNDCOVER, PERENNIAL AND ANNUAL BEDS
- 5. ALL TREES AND SHRUBS SHALL BE SOAKED WITH WATER AND MULCHED IMMEDIATELY FOLLOWING INSTALLATION. 6. LANDSCAPE ARCHITECT OR OWNER SHALL APPROVE ANY ON-SITE PLANT STORAGE AREA.
- 7. ALL ROOT BALLS REMOVED FROM CONTAINERS SHALL BE SCARIFIED BY HAND PRIOR TO PLACEMENT AND BACK FILLING WITH PREPARED SOILS. HAND TOOLS ARE NOT TO BE USED TO SCARIFY ROOT BALLS.
- 8. ALL ROPE AND WRAPPING TWINE SHALL BE CUT AND REMOVED FROM AROUND THE UPPER PARTS OF THE ROOT BALL. METAL BASKET WIRES AND BURLAP SHALL BE PULLED BACK AND TUCKED UNDER THE EDGES OF THE SAUCER RINGS ON ALL TREES AND LARGE SHRUBS. ALL SYNTHETIC BURLAP SHALL BE REMOVED FROM PLANT BALLS PRIOR TO BACKFILLING.
- 9. ALL PLANTING AREAS SHALL BE EDGED WITH SMOOTH, CONTINUOUS CURVES. PINE STRAW MULCH, IF SPECIFIED, SHALL BE ROLLED AND TUCKED ALONG PLANT BED EDGE.
- 10. ALL PLANT MATERIAL SHALL BE PLANTED AT HEIGHTS AS ILLUSTRATED IN THE PLANTING DETAILS & PLANT LIST. 11. TREE STAKING AND GUYING, IF NECESSARY, SHALL BE PERFORMED WITHIN A WEEK OF PLANTING. THE LANDSCAPE CONTRACTOR SHALL BE RESPONSIBLE FOR REMOVING ALL TREE STAKING MATERIAL AFTER THE FIRST FULL GROWING SEASON OR ONE YEAR,
- WHICH EVER COMES FIRST 12. B & B AS LISTED UNDER "ROOT" IN THE PLANT LIST INDICATES BALLED AND BURLAPPED.
- 13. ALL PLANT BEDS AND RAISED SAUCER RINGS SHALL BE GRADED TO PROVIDE ADEQUATE DRAINAGE AND SHALL BE MULCHED AS 14. ALL MATERIALS, PLANTING AND LANDSCAPE WORK SHALL CONFORM TO THE LOCAL OR COUNTY JURISDICTIONAL AUTHORITY'S
- STANDARD SPECIFICATIONS AND DETAILS. 15. ALL LANDSCAPING SHALL BE MAINTAINED IN PERPETUITY.

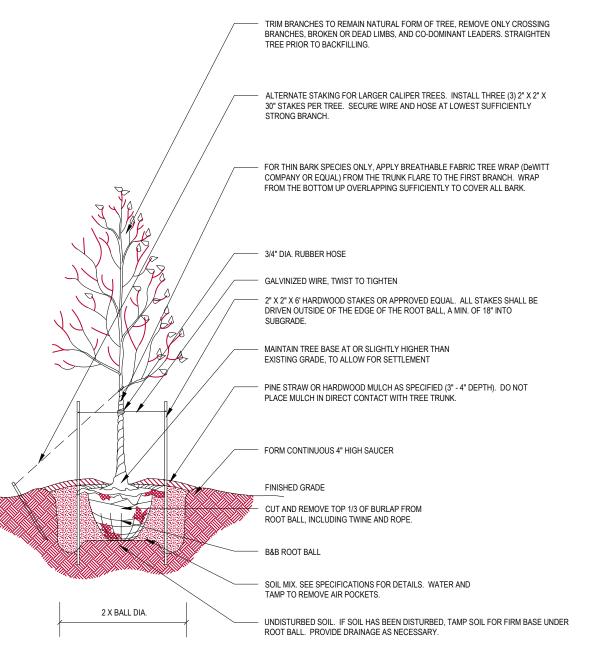

1. ALL TECHNICAL SPECIFICATIONS AND GENERAL CONDITIONS APPLY.

- 2. IF PLANT IS SHIPPED WITH A WIRE BASKET AROUND THE ROOT BALL, CUT WIRE BASKET IN SEVERAL PLACES AND FOLD DOWN A $\hbox{\tt MINIMUM OF 8"INTO PLANTING HOLE. REMOVE ALL SYNTHETIC BURLAP FROM ROOT BALL PRIOR TO BACKFILLING. }$
- 3. FOR CONTAINER GROWN TREES, SUFFICIENTLY SCARIFY ROOT BALL PRIOR TO PLANTING.

DECIDUOUS TREE PLANTING NOT TO SCALE




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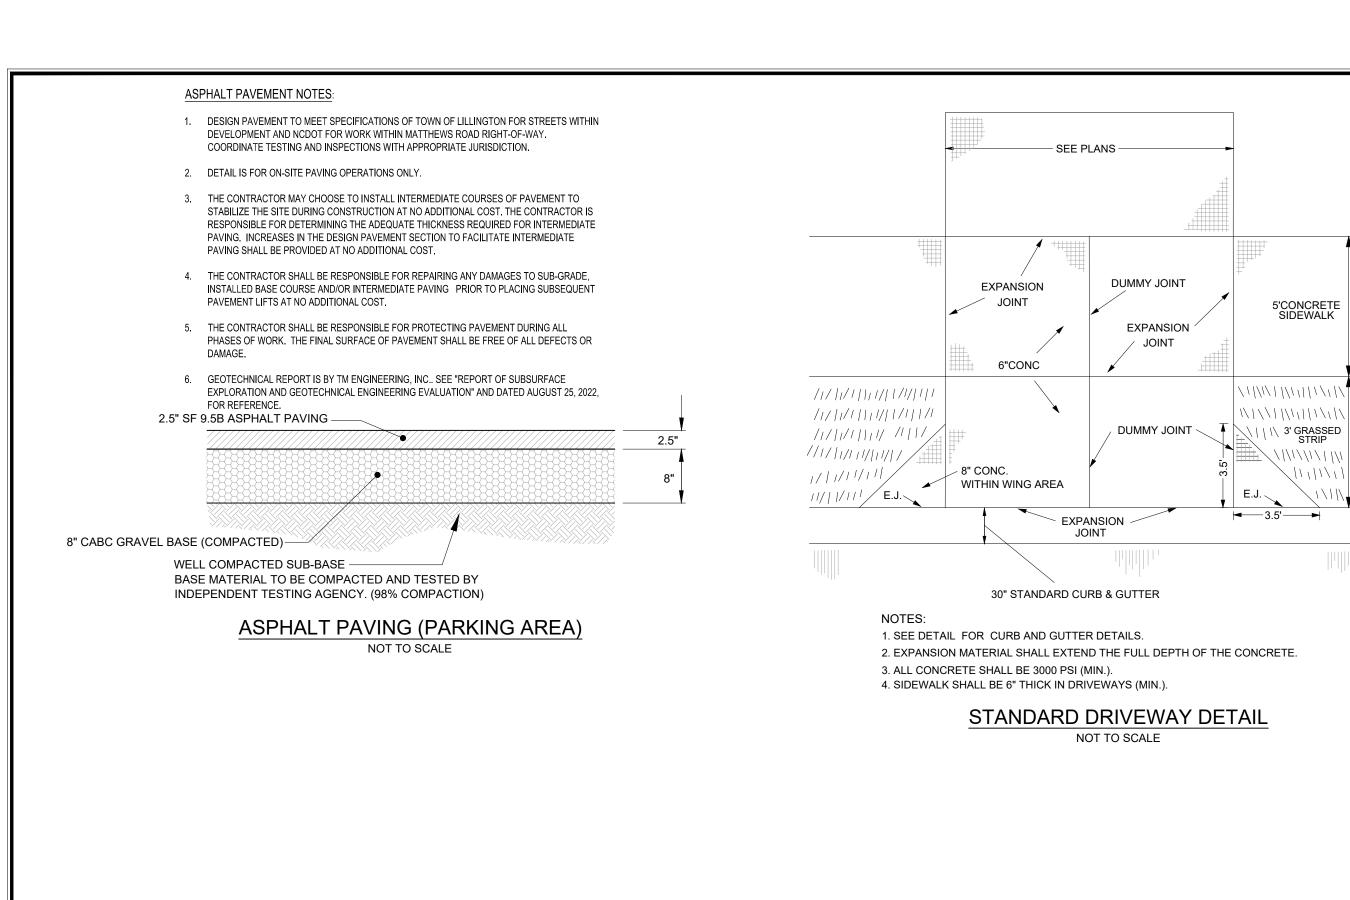



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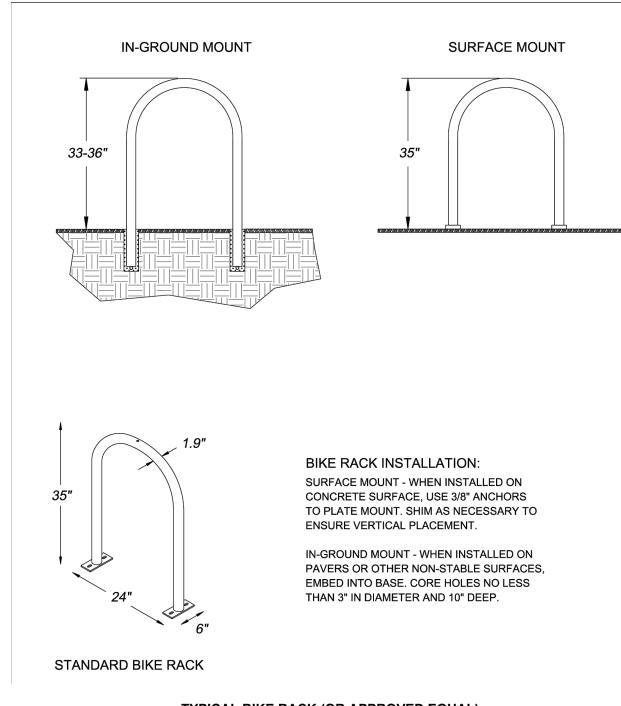
JANUARY 29, 2024 I" = 20'

RJH AJF


roject No. 147-03 omputer Dwg. Name 47-03 amenity landscape plan




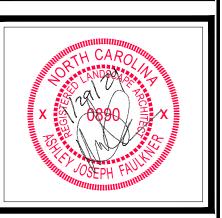

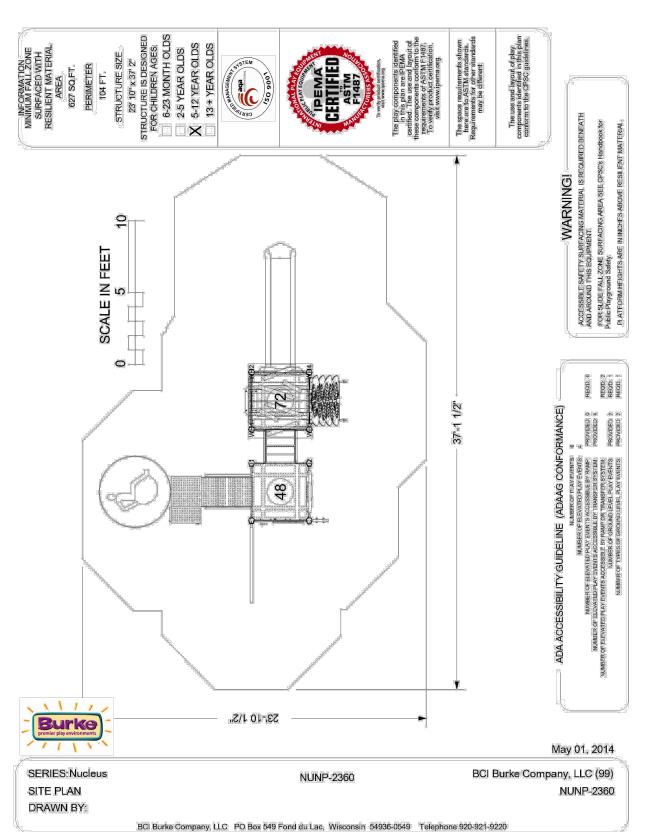

TYPICAL BIKE RACK (OR APPROVED EQUAL)

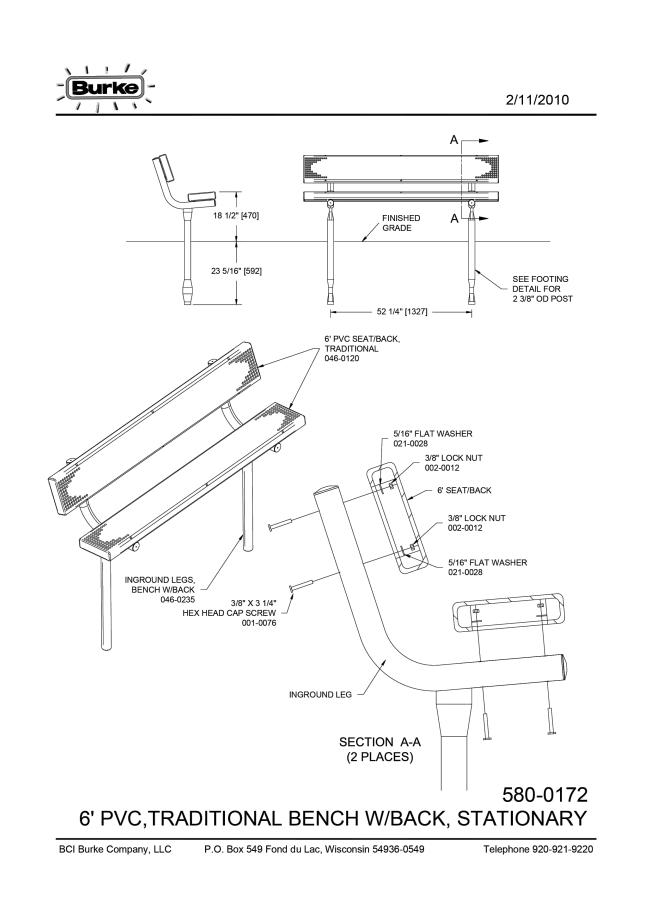

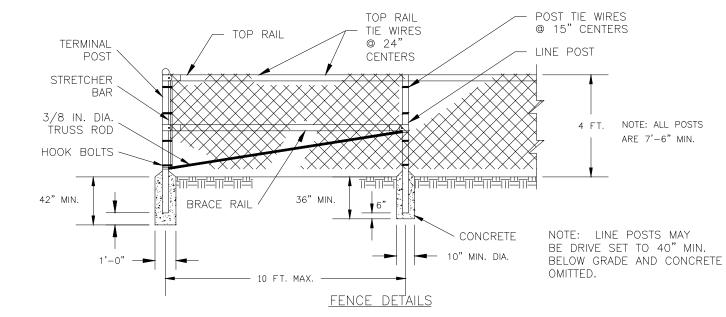


SHAPE, SIZE AND WEIGHT REQUIREMENTS FOR FENCE POSTS AND RAILS						TE FRAME MEMI SIZE AND WEIGH	
ITEM	SHAPE	OUTSIDE DIMENSIONS INCHES	WEIGHT LBS./LIN. FT.		GATE FRAME	OUTSIDE DIMENSIONS INCHES	WEIGHT LBS./LIN. FT.
** TERMINAL	ROUND	2.375	3.65		ROUND *ROUND	1.66 1.66	2.27 1.84
POSTS	*ROUND	2.375	3.12		* GRADE B HIGH STRENGTH STEEL		
LINE POSTS	ROUND *ROUND	1.90 1.90	2.72 2.28				
TOP & BRACE	ROUND	1.66	2.27		GATE POST SIZE AND WEIGHT		
RAILS	*ROUND	1.66	1.84		GATE LEAF	OUTSIDE	WEIGHT
* GRADE B HIGH STRENGTH STEEL					WIDTH OF	DIMENSIONS	LBS./LIN. FT.
** INCLUDES END, CORNER, ANGLE, INTERSECTION AND					6 FT. OR LESS	INCHES	
INTERME	DIATE BRACED F	OSTS			ROUND	2.875	5.79
					*ROUND	2.875	4.64


CONSTRUCTION NOTES

- 1. MATERIALS AND WORKMANSHIP NOT SHOWN ON THIS DRAWING SHALL CONFORM TO THE MANUFACTURER'S SPECIFICATIONS.
- 2. ALL POSTS SHALL BE INSTALLED VERTICALLY. WHERE POSTS ARE INSTALLED ON AN INCLINED SURFACE, THE ANGLE OF THE POST SHALL BE ADJUSTED SO THAT THE POST WILL BE VERTICAL.
- 3. THE FENCING SHALL BE #9 GAGE FENCE FABRIC, STANDARD 2-INCH CHAIN LINK DIAMOND MESH WITH BLACK VINYL COATING.

BLACK VINYL COATED CHAINLINK FENCE DETAIL NOT TO SCALE

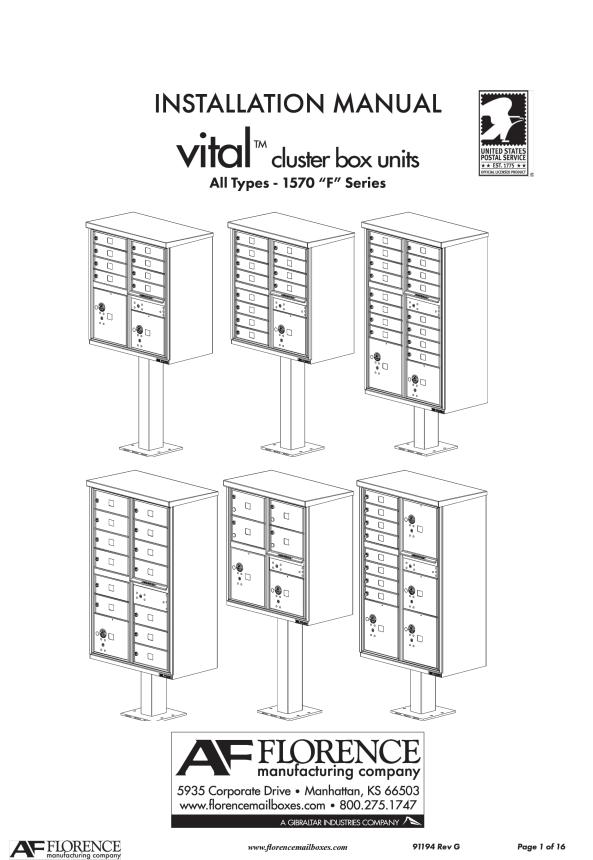



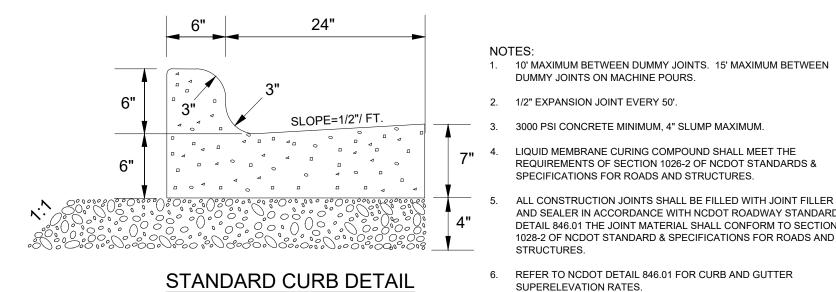

NOT TO SCALE

2. 1/2" EXPANSION JOINT EVERY 50'. 3000 PSI CONCRETE MINIMUM, 4" SLUMP MAXIMUM.


DUMMY JOINTS ON MACHINE POURS.

LIQUID MEMBRANE CURING COMPOUND SHALL MEET THE

SPECIFICATIONS FOR ROADS AND STRUCTURES. ALL CONSTRUCTION JOINTS SHALL BE FILLED WITH JOINT FILLER AND SEALER IN ACCORDANCE WITH NCDOT ROADWAY STANDARD DETAIL 846.01 THE JOINT MATERIAL SHALL CONFORM TO SECTION 1028-2 OF NCDOT STANDARD & SPECIFICATIONS FOR ROADS AND

REQUIREMENTS OF SECTION 1026-2 OF NCDOT STANDARDS &

6. REFER TO NCDOT DETAIL 846.01 FOR CURB AND GUTTER SUPERELEVATION RATES.

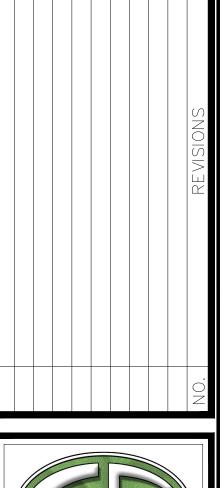

* GRADE B HIGH STRENGTH STEEL



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omputer Dwg. Name

147—03 amenity details



PARKING SPACE PAVEMENT MARKINGS 2. REFER TO MANUAL ON UNIFORM TRAFFIC CONTROL DEVICES, (MUTCD) U.S. DEPARTMENT OF TRANSPORTATION AND NORTH CAROLINA DEPARTMENT OF TRANSPORTATION SUPPLEMENT. 3. IF ACCESSIBLE ROUTE IS A RAISED SIDEWALK AREA, THEN RAMPS ARE REQUIRED AT LOADING ZONE AREA.

ADA ACCESSIBLE PARKING SPACE DETAIL NOT TO SCALE

- R7-8 or R7-8a

WHITE BACKGROUND

VAN-ACCESSIBLE SIGN AT VAN

SPACE ONLY

REQUIRED ACCESSIBLE RESERVED PARKING SIGN

FOR EXACT

SEE STANDARD NO. 50.10C FOR SUPPLEMETAL SIGN DETAIL

ONE OUT OF EVERY EIGHT (8)ACCESSIBLE SPACES, BUT

-BLUE

R7-8 HANDICAP SIGN DETAIL NOT TO SCALE

2 COATS OF TRAFFIC — PAINT

4" WIDE
PAINTED BLUE

LINES (TYP.)

RESERVED

MAXIMUM PENALTY \$250


INCREASE TO 84" WHEN

PEDESTRIAN PATH FROM

ALL 12"x18" ACCESSIBLE SIGNS (R7-8 & R7-1)
 SHALL BE MOUNTED AT 7 FEET FROM GRADE
 TO BOTTOM EDGE OF SIGN FACE (MUTCD).

5 FEET IF PLACED IN AN AREA BETWEEN SIDEWALK AND BUILDING FACE IN WHICH PEDESTRIANS ARE NOT EXPECTED TO USE.

MOUNTING HEIGHT CAN BE REDUCED TO

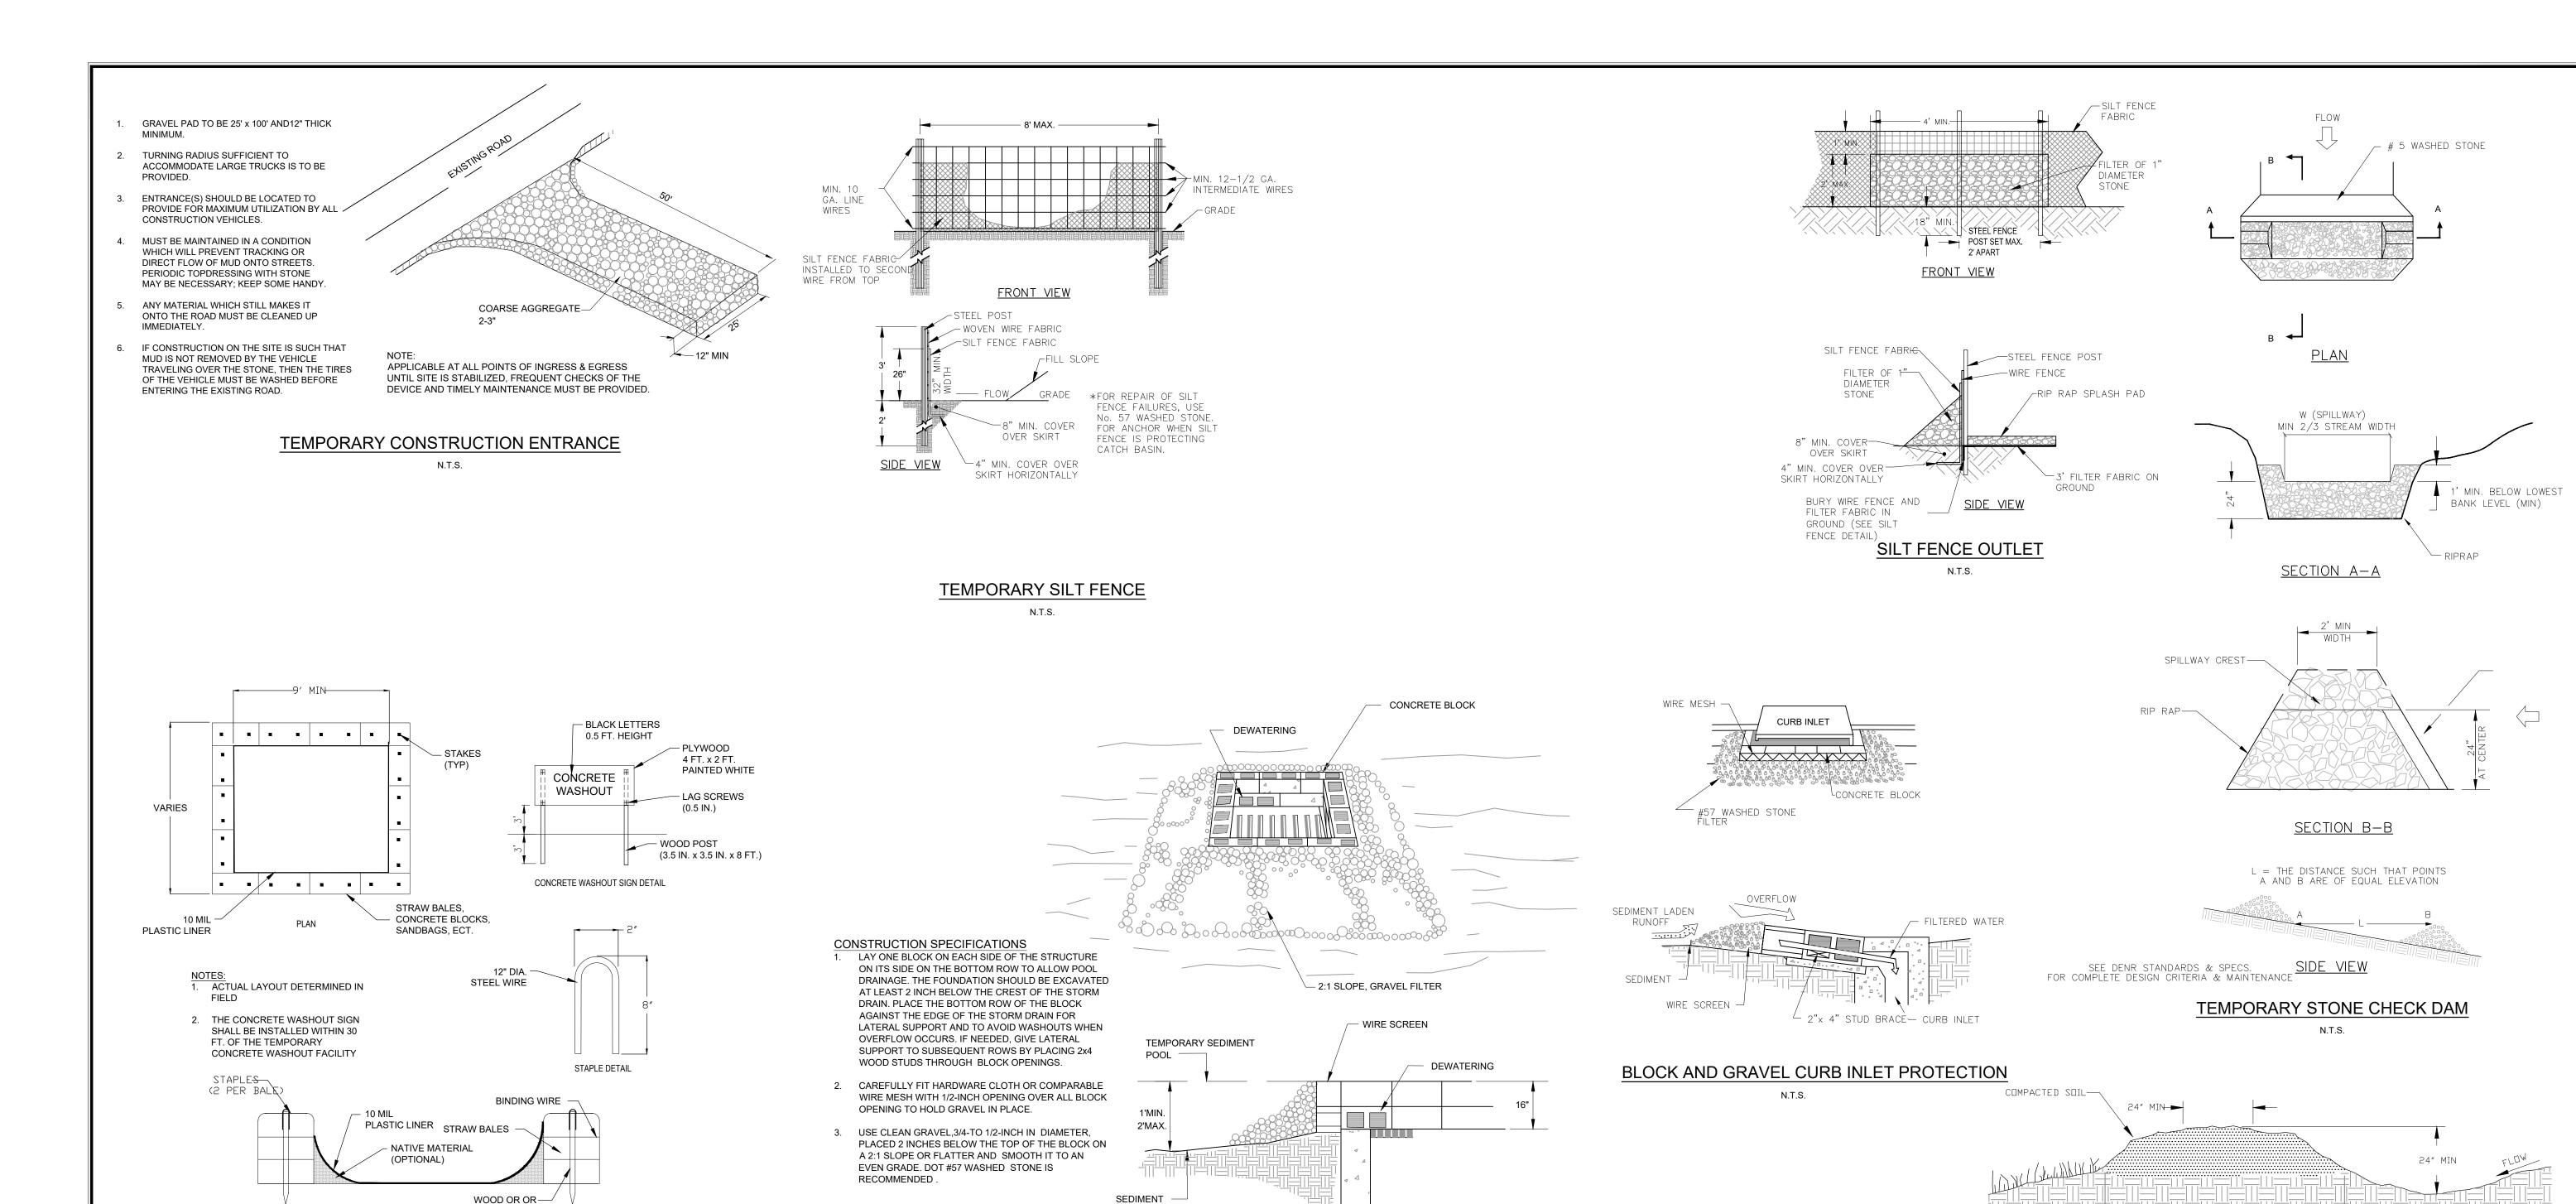

MAINTENANCE NOTES

NPDES PERMIT COMPLIANCE REQUIRES INSPECTIONS EVERY 7 CALENDAR DAYS BY A NPDES QUALIFIED INSPECTOR AND PERIODIC INSPECTIONS WITHIN 24 HOURS OF ANY RAINFALL EVENT OF 0.5 INCHES OR GREATER. THESE INSPECTIONS MAY RESULT IN RECOMMENDATIONS FOR ROUTINE MAINTENANCE OF THE SOIL EROSION CONTROL DEVICES, AS WELL AS FURTHER MAINTENANCE AS OUTLINED BELOW.

METAL STAKES (2

CONCRETE WASHOUT-ABOVE GRADE

- 1. THROUGHOUT THE CONSTRUCTION PERIOD, ALL MUD/SILT TRACKED ONTO EXISTING TOWN/STATE ROADS FROM THE SITE DUE TO CONSTRUCTION SHALL BE IMMEDIATELY REMOVED BY THE CONTRACTOR.
- 2. TEMPORARY GRAVEL CONSTRUCTION ENTRANCE/EXIT A. MAINTAIN THE GRAVEL PAD (CONSTRUCTION ENTRANCE/EXIT) IN A CONDITION TO PREVENT MUD OR SEDIMENT FROM LEAVING THE CONSTRUCTION SITE. THIS MAY REQUIRE PERIODIC TOP-DRESSING WITH 2-INCH STONE.
- B. AFTER EACH RAINFALL, INSPECT ANY STRUCTURE USED TO TRAP SEDIMENT AND CLEAN IT OUT AS NECESSARY. IMMEDIATELY REMOVE ALL OBJECTIONABLE MATERIALS SPILLED, WASHED, OR TRACKED ONTO PUBLIC ROADWAYS.

3. SEDIMENT FENCE (SILT FENCE)

- A. INSPECT SEDIMENT FENCES (SILT FENCE) AT LEAST ONCE A WEEK AND AFTER EACH RAINFALL. MAKE ANY REQUIRED REPAIRS IMMEDIATELY. SHOULD THE FABRIC OF A SEDIMENT FENCE COLLAPSE, TEAR, DECOMPOSE OR BECOME INEFFECTIVE, REPLACE IT PROMPTLY B. REMOVE SEDIMENT DEPOSITS ONCE ACCUMULATION HAS REACHED HALF OF THE HEIGHT OF THE SILT FENCE TO PROVIDE ADEQUATE STORAGE VOLUME FOR THE NEXT RAIN AND TO REDUCE PRESSURE ON THE FENCE. TAKE CARE TO AVOID UNDERMINING THE FENCE DURING CLEANOUT.
- C. REMOVE ALL FENCING MATERIALS AND UNSTABLE SEDIMENT DEPOSITS AND BRING THE AREA TO GRADE AND STABILIZE IT AFTER THE CONTRIBUTING DRAINAGE AREA HAS BEEN PROPERLY STABILIZED.

4. SEDIMENT FENCE (SILT FENCE) OUTLETS

A. INSPECT SILT FENCE OUTLETS AT LEAST WEEKLY AND AFTER EACH SIGNIFICANT ½ INCH OR GREATER) RAINFALL EVENT. CLEAR THE WIRE FENCE AND HARDWARE CLOTH OF ANY DEBRIS OR OTHER OBJECTS TO PROVIDE ADEQUATE FLOW FOR SUBSÉQUENT RAINS. TAKE CARE NOT TO DAMAGE OR UNDERCUT THE WIRE MESH OR HARDWARE CLOTH DURING SEDIMENT REMOVAL. B. REPLACE STONE AS NEEDED.

- A. INSPECT TEMPORARY DIVERSIONS ONCE A WEEK AND AFTER EVERY RAINFALL. IMMEDIATELY REMOVE SEDIMENT FROM THE FLOW AREA AND REPAIR THE DIVERSION RIDGE.
- B. CAREFULLY CHECK OUTLETS AND MAKE TIMELY REPAIRS AS NEEDED.
- WHEN THE AREA PROTECTED IS PERMANENTLY STABILIZED, REMOVE THE RIDGE AND THE CHANNEL TO BLEND WITH THE NATURAL GROUND LEVEL AND APPROPRIATELY STABILIZE IT.
- RE-FERTILIZE IF GROWTH IS NOT FULLY ADEQUATE. RESEED, RE-FERTILIZE, AND MULCH IMMEDIATELY FOLLOWING EROSION OR OTHER DAMAGE.

- PERMANENTLY STABILIZED. TO PROVE SATISFACTORY BASIN EFFICIENCY, REMOVE SEDIMENT WHEN THE VOLUME OF THE BASIN HAS BEEN

A. INSPECT, CLEAN, AND PROPERLY MAINTAIN THE EXCAVATED BASIN AFTER EVERY STORM UNTIL THE CONTRIBUTING DRAINAGE AREA HAS BEEN

B. SPREAD ALL EXCAVATED MATERIAL EVENLY OVER THE SURROUNDING LAND AREA OR STOCKPILE AND STABILIZE IT PROPERLY.

8. HARDWARE CLOTH AND GRAVEL INLET PROTECTION

- A. INSPECT INLETS AT LEAST WEEKLY AND AFTER EACH SIGNIFICANT $(\frac{1}{2}$ IN. OR GREATER) RAINFALL EVENT. B. CLEAR THE MESH WIRE OF ANY DEBRIS OR OTHER OBJECTS TO PROVIDE ADEQUATE FLOW FOR SUBSEQUENT RAINS. TAKE CARE NOT TO DAMAGE OR UNDERCUT THE WIRE MESH DURING SEDIMENT REMOVAL.
- C. REPLACE STONE AS NEEDED.

7. EXCAVATED DROP INLET PROTECTION

- 9. BLOCK AND GRAVEL INLET PROTECTION
- A. INSPECT THE BARRIER AT LEAST WEEKLY AND AFTER EACH SIGNIFICANT ($\frac{1}{2}$ IN. OR GREATER) RAINFALL EVENT AND MAKE REPAIRS AS NECESSARY. REMOVE SEDIMENT AS NECESSARY TO PROVIDE ADEQUATE STORAGE VOLUME FOR SUBSEQUENT RAINS. WHEN THE CONTRIBUTING DRAINAGE AREA HAS BEEN ADEQUATELY STABILIZED, REMOVE ALL MATERIALS AND ANY UNSUITABLE SOIL, AND EITHER SALVAGE OR DISPOSE OF IT PROPERLY. BRING THE DISTURBED AREA TO PROPER GRADE, THEN SMOOTH AND COMPACT IT. APPROPRIATELY STABILIZE ALL BARE AREAS AROUND THE INLET.

- A. INSPECT SKIMMER SEDIMENT BASINS AT LEAST WEEKLY AND AFTER EACH SIGNIFICANT (ONE-HALF INCH OR GREATER) RAINFALL EVENT AND REPAIR IMMEDIATELY. REMOVE SEDIMENT AND RESTORE THE BASIN TO ITS ORIGINAL DIMENSIONS WHEN SEDIMENT ACCUMULATES TO ONE-HALF THE HEIGHT OF THE FIRST BAFFLE. PULL THE SKIMMER TO ONE SIDE SO THAT THE SEDIMENT UNDERNEATH IT CAN BE EXCAVATED. EXCAVATE THE SEDIMENT FROM THE ENTIRE BASIN, NOT JUST AROUND THE SKIMMER OR THE FIRST CELL. MAKE SURE VEGETATION GROWING IN THE BOTTOM OF THE BASIN DOES NOT HOLD DOWN THE SKIMMER.
- B. REPAIR THE BAFFLES IF THEY ARE DAMAGED. RE-ANCHOR THE BAFFLES IF WATER IS FLOWING UNDERNEATH OR AROUND THEM. : IF THE SKIMMER IS CLOGGED WITH TRASH AND THERE IS WATER IN THE BASIN, USUALLY JERKING ON THE ROPE WILL MAKE THE SKIMMER BOB UP

SKIMMER FROM PLUGGING WITH ICE. IF ICE IS PRESENT IN THE SKIMMER BASIN, REMOVE IMMEDIATELY.

- AND DOWN AND DISLODGE THE DEBRIS AND RESTORE FLOW. IF THIS DOES NOT WORK, PULL THE SKIMMER OVER TO THE SIDE OF THE BASIN AND REMOVE THE DEBRIS. ALSO CHECK THE ORIFICE INSIDE THE SKIMMER TO SEE IF IT IS CLOGGED; IF SO REMOVE THE DEBRIS.
- D. IF THE SKIMMER ARM OR BARREL PIPE IS CLOGGED, THE ORIFICE CAN BE REMOVED AND THE OBSTRUCTION CLEARED WITH A PLUMBER'S SNAKE OR BY FLUSHING WITH WATER. BE SURE AND REPLACE THE ORIFICE BEFORE REPOSITIONING THE SKIMMER.
- E. CHECK THE FABRIC LINED SPILLWAY FOR DAMAGE AND MAKE ANY REQUIRED REPAIRS WITH FABRIC THAT SPANS THE FULL WIDTH OF THE SPILLWAY. CHECK THE EMBANKMENT, SPILLWAYS, AND OUTLET FOR EROSION DAMAGE, AND INSPECT THE EMBANKMENT FOR PIPING AND
- SETTLEMENT. MAKE ALL NECESSARY REPAIRS IMMEDIATELY. REMOVE ALL TRASH AND DEBRIS FROM THE SKIMMER AND POOL AREAS. FREEZING WEATHER CAN RESULT IN ICE FORMING IN THE BASIN. SOME SPECIAL PRECAUTIONS SHOULD BE TAKEN IN THE WINTER TO PREVENT THE

8. CHECK DAMS & WATTLES/SILT SOCKS (AND THOSE WITH WEIR)

FROSION & SEDIMENTATION CONTROL MANUAL).

- A. INSPECT CHECK DAMS AND CHANNELS AT LEAST WEEKLY AND AFTER EACH SIGNIFICANT (ONE-HALF INCH OR GREATER) RAINFALL EVENT AND REPAIR IMMEDIATELY. CLEAN OUT SEDIMENT, STRAW, LIMBS, OR OTHER DEBRIS THAT COULD CLOG THE CHANNEL WHEN NEEDED. . ANTICIPATE SUBMERGENCE AND DEPOSITION ABOVE THE CHECK DAM AND EROSION FROM HIGH FLOWS AROUND THE EDGES OF THE DAM. CORRECT ALL DAMAGE IMMEDIATELY. IF SIGNIFICANT EROSION OCCURS BETWEEN DAMS, ADDITIONAL MEASURES CAN BE TAKEN SUCH AS, INSTALLING A PROTECTIVE RIPRAP LINER IN THAT PORTION OF THE CHANNEL (PRACTICE 6.31 RIPRAP-LINED AND PAVED CHANNELS OF NCDENR
- REMOVE SEDIMENT ACCUMULATED BEHIND THE DAMS AS NEEDED TO PREVENT DAMAGE TO CHANNEL VEGETATION, ALLOW THE CHANNEL TO DRAIN THROUGH THE STONE CHECK DAM, AND PREVENT LARGE FLOWS FROM CARRYING SEDIMENT OVER THE DAM. ADD STONES TO DAMS AS NEEDED TO MAINTAIN DESIGN HEIGHT AND CROSS SECTION.

- A. INSPECT SEEDED AREAS FOR FAILURE AND MAKE NECESSARY REPAIRS AND RESEEDINGS WITHIN THE SAME SEASON, IF POSSIBLE. B. RESEEDING - IF A STAND HAS INADEQUATE COVER, RE-EVALUATE CHOICE OF PLANT MATERIALS AND QUANTITIES OF LIME AND FERTILIZER. RE-ESTABLISH THE STAND AFTER SEEDBED PREPARATION OR OVER-SEED THE STAND. CONSIDER SEEDING TEMPORARY, ANNUAL SPECIES IF THE TIME OF YEAR IS NOT APPROPRIATE FOR PERMANENT SEEDING.
- C. IF VEGETATION FAILS TO GROW, SOIL MUST BE TESTED TO DETERMINE IF ACIDITY OR NUTRIENT IMBALANCE IS RESPONSIBLE. FERTILIZATION - ON THE TYPICAL DISTURBED SITE, FULL ESTABLISHMENT USUALLY REQUIRES REFERTILIZATION IN THE SECOND GROWING SEASON. FINE TURF REQUIRES ANNUAL MAINTENANCE FERTILIZATION 9TABLE 6.12B). USE SOIL TESTS IF POSSIBLE OR FOLLOW THE GUIDELINES GIVEN FOR THE SPECIFIC SEEDING MIXTURE.

10. ROCK PIPE INLET PROTECTION

BLOCK AND GRAVEL INLET PROTECTION

- A. INSPECT ROCK PIPE INLET PROTECTION AT LEAST WEEKLY AND AFTER EACH SIGNIFICANT (1/2 INCH OR GREATER) RAINFALL EVENT AND REPAIR IMMEDIATELY. REMOVE SEDIMENT AND RESTORE THE SEDIMENT STORAGE AREA TO ITS ORIGINAL DIMENSIONS WHEN THE SEDIMENT HAS ACCUMULATED TO ONE-HALF THE DESIGN DEPTH OF THE TRAP. PLACE THE SEDIMENT THAT IS REMOVED IN THE DESIGNATED DISPOSAL AREA AND REPLACE THE CONTAMINATED PART OF THE GRAVEL FACING.
- C. AFTER ALL THE SEDIMENT-PRODUCING AREAS HAVE BEEN PERMANENTLY STABILIZED, REMOVE THE STRUCTURE AND ALL THE UNSTABLE
- SEDIMENT. SMOOTH THE AREA TO BLEND WITH THE ADJOINING AREAS AND PROVIDE PERMANENT GROUND COVER (SURFACE STABILIZATION).

A. INSPECT DEWATERING DEVICE AND STABILIZED OUTLET AT LEAST WEEKLY AND AFTER EACH SIGNIFICANT (1/2 INCH OR GREATER) RAINFALL EVENT AND REPAIR IMMEDIATELY. REMOVE ANY ACCUMULATED SEDIMENT WITHIN STONE PAD AND STABILIZED OUTLET.

- A. INSPECT SEDIMENT PIT AT LEAST WEEKLY AND AFTER EACH SIGNIFICANT (1/2 INCH OR GREATER) RAINFALL EVENT AND REPAIR IMMEDIATELY. REMOVE SEDIMENT AND RESTORE THE SEDIMENT STORAGE AREA TO ITS ORIGINAL DIMENSIONS WHEN THE SEDIMENT HAS ACCUMULATED TO
- ONE-HALF THE DESIGN DEPTH OF THE PIT. PLACE THE SEDIMENT THAT IS REMOVED IN THE DESIGNATED DISPOSAL AREA AND REPLACE THE CONTAMINATED PART OF THE WATTLE AND STONE FOR SILT FENCE OUTLET IF NECESSARY

A. INSPECT CHANNELS AT REGULAR INTERVALS AS WELL AS AFTER MAJOR RAINS, AND MAKE REPAIRS PROMPTLY. GIVE SPECIAL ATTENTION TO THE OUTLET AND INLET SECTIONS AND OTHER POINTS WHERE CONCENTRATED FLOW ENTERS. CAREFULLY CHECK STABILITY AT ROAD CROSSINGS, AND LOOK FOR INDICATIONS OF PIPING, SCOUR HOLES, OR BANK FAILURES. MAKE REPAIRS IMMEDIATELY. MAINTAIN ALL VEGETATION ADJACENT

15. ROLLED EROSION CONTROL PRODUCTS

- CONTROL PRODUCT (RECP) HAS TAKEN PLACE. IMMEDIATELY MAKE ALL NEEDED REPAIRS TO PREVENT FURTHER DAMAGE.
- B. GOOD CONTACT WITH THE GROUND MUST BE MAINTAINED, AND EROSION MUST NOT OCCUR BENEATH THE RECP. ANY AREAS OF THE RECP THAT ARE DAMAGED OR NOT IN CLOSE CONTACT WITH THE GROUND SHALL BE REPAIRED AND STAPLED.
- D. MONITOR AND REPAIR THE RECP AS NECESSARY UNTIL GROUND COVER IS ESTABLISHED.

- CHECK THE STRUCTURE FOR DAMAGE. AND RIPRAP DISPLACED FROM THE STONE HORSESHOE MUST BE REPLACED IMMEDIATELY.
- B. ANY DEWATERING FROM SEDIMENT CONTROL DEVICE MUST BE DONE WITHIN LIMITS OF DISTURBANCE AND THROUGH A FILTER BAG.
- B. AFTER ALL THE SEDIMENT-PRODUCING AREAS HAVE BEEN PERMANENTLY STABILIZED, REMOVE THE STRUCTURE AND ALL THE UNSTABLE SEDIMENT. SMOOTH THE AREA TO BLEND WITH THE ADJOINING AREAS AND PROVIDE PERMANENT GROUND COVER (SURFACE STABILIZATION).

A. INSPECT WEEKLY AND AFTER SIGNIFICANT (2" OR GREATER) RAINFALL EVENTS TO SEE IF ANY EROSION AROUND OR BELOW THE RIPRAP HAS TAKEN PLACE, OR IF STONES HAVE BEEN DISLODGED. IMMEDIATELY MAKE ALL NEEDED REPAIRS TO PREVENT FURTHER DAMAGE.

TO THE CHANNEL IN A HEALTHY, VIGOROUS CONDITION TO PROTECT THE AREA FROM EROSION AND SCOUR DURING OUT-OF-BANK FLOW.


A. INSPECT WEEKLY AND AFTER SIGNIFICANT (\$\frac{1}{2}" OR GREATER) RAINFALL EVENTS TO SEE IF ANY EROSION AROUND OR BELOW THE ROLLED EROSION

C. IF EROSION OCCURS DUE TO POORLY CONTROLLED DRAINAGE, THE PROBLEM SHALL BE FIXED AND THE ERODED AREA PROTECTED.

TEMPORARY DIVERSION BERM/SWALE

6' TYPICAL

GROUND STABILIZATION	N *		4) INSPECTIONS				
SITE AREA DESCRIPTION	STABILIZATION TIME FRAME	STABILIZATION TIME FRAME EXCEPTIONS	SAME WEEKLY INSPECTION REQUIREMENTS				
PERIMETER DIKES, SWALES,			SAME RAIN GAUGE & INSPECTIONS AFTER 0.5" RAIN EVENT INSPECTIONS ARE ONLY REQUIRED DURING "NORMAL				
DITCHES, AND SLOPES			BUSINESS HOURS"				
HIGH QUALITY WATER (HQW)	7 DAYS	NONE	 INSPECTION REPORTS MUST BE AVAILABLE ON-SITE DURING BUSINESS HOURS UNLESS A SITE-SPECIFIC EXEMPTION IS APPROVED. 				
ZONES			RECORDS MUST BE KEPT FOR 3 YEARS AND AVAILABLE ON REQUEST.				
SLOPES STEEPER THAN	7 DAYS	IF SLOPES ARE 10' OR LESS IN LENGTH AND ARE NOT STEEPER	ELECTRONICALLY-AVAILABLE RECORDS MAY BE SUBSTITUTED UNDER CERTAIN CONDITIONS.				
3:1 THAN 2:1, 14 DAYS ARE ALLOWED			5) IMPLEMENTATION OF NEW PERMIT CONDITIONS				
SLOPES 3:1 OR FLATTER 14 DAYS 7-DAYS FOR SLOPES GREATER THAN 50 FEET IN LENGTH			PROJECTS PERMITTED UNDER THE PREVIOUS PERMIT CAN CONTINUE TO FOLLOW THE PREVIOUSLY-PERMITTED CONDITIONS.				
ALL OTHER AREAS MITH		NONE (EXCEPT FOR	COMPLETE APPLICATIONS RECEIVED PRIOR TO AUGUST 3, 2011 CAN FOLLOW CONDITIONS OF APPROVED APPLICATION.				
AREAS WITH SLOPES FLATTER THAN 4:1 14 DAYS PERIMETERS AND HQW ZONES)			APPLICATIONS RECEIVED AFTER AUGUST 2, 2011 MUST COMPLY WITH NEW PERMIT CONDITIONS.				
* "EXTENSIONS OF TIME N PERMITTING AUTHOR SITE-SPECIFIC COND	ITY BASED ON WEA	ATHER OR OTHER	6) CONDITIONS IN EROSION & SEDIMENTATION CONTROL PLANS *				
IMPRACTICABLE." (SE			DESIGNATION ON THE PLANS WHERE THE 7 AND 14-DAY GROUND STABILIZATION REQUIREMENTS OF THE NPDES PERMIT APPLY				
NO PAINT OR LIQUID		M OR STORM	DESIGNATION ON THE PLANS WHERE BASINS THAT COMPLY WITH THE SURFACE-WITHDRAWAL REQUIREMENTS OF THE NPDES PERMIT				
DRAINS DEDICATED AREAS F	OR DEMOLITION CO	ONSTRUCTION AND	ARE LOCATED.				
	T BE LOCATED 50' I	FROM STORM DRAINS	7) SEDIMENT BASINS				
AVAILABLE.		BE LOCATED 50' FROM	OUTLET STRUCTURES MUST WITHDRAW FROM BASIN SURFACE UNLESS DRAINAGE AREA IS LESS THAN 1 ACRE.				
STORM DRAINS AND ALTERNATIVES AVAIL	STREAMS UNLESS		USE ONLY DWQ-APPROVED				

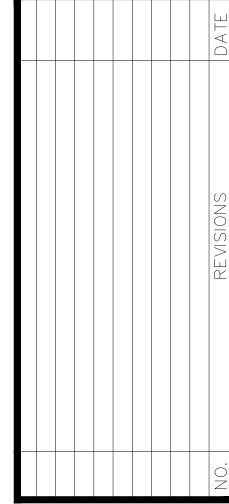




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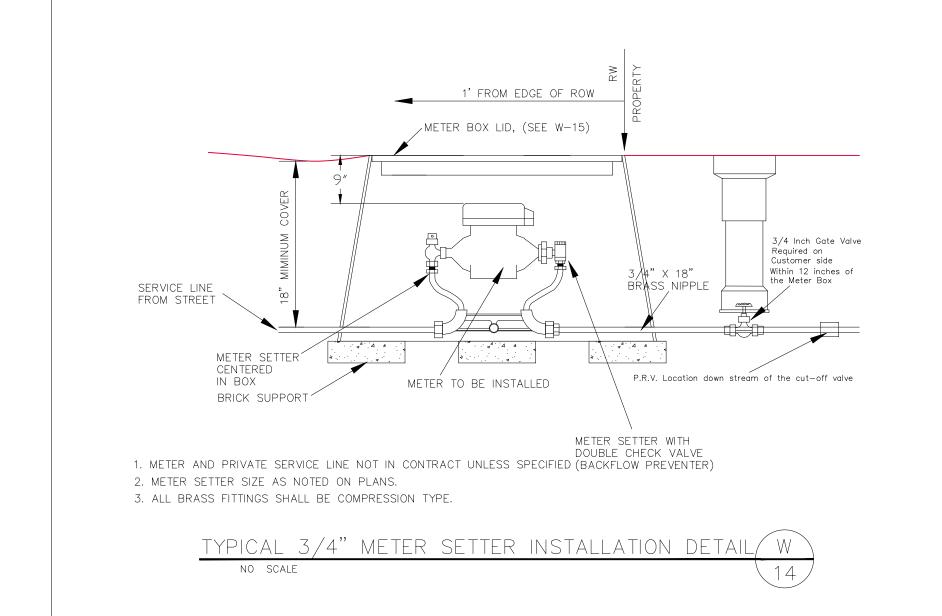
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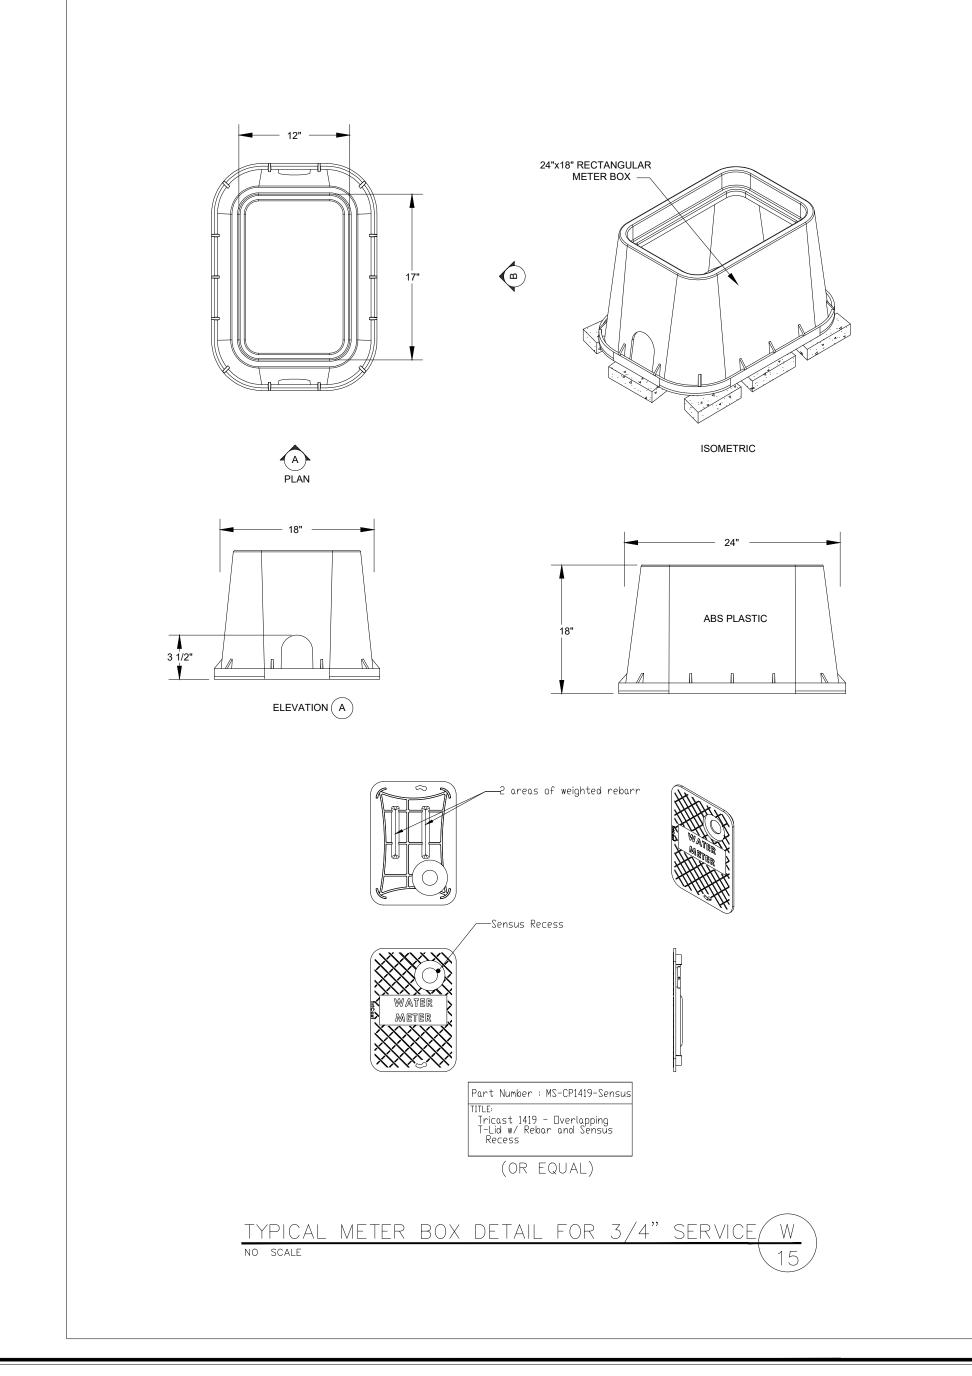
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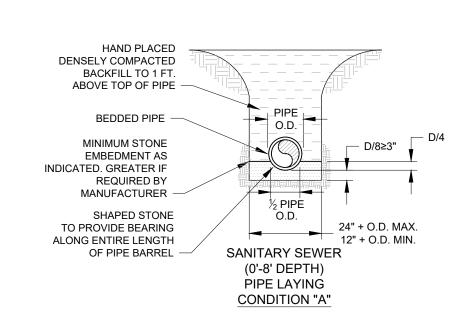
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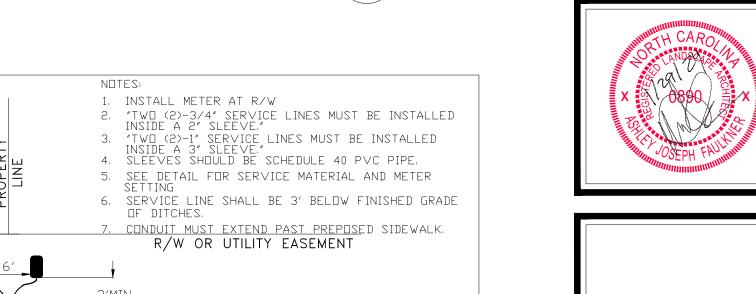
17-03 amenity details







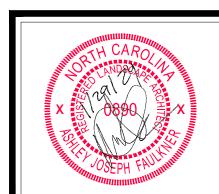

TYPICAL PIPE LAYING CONDITION DETAIL/



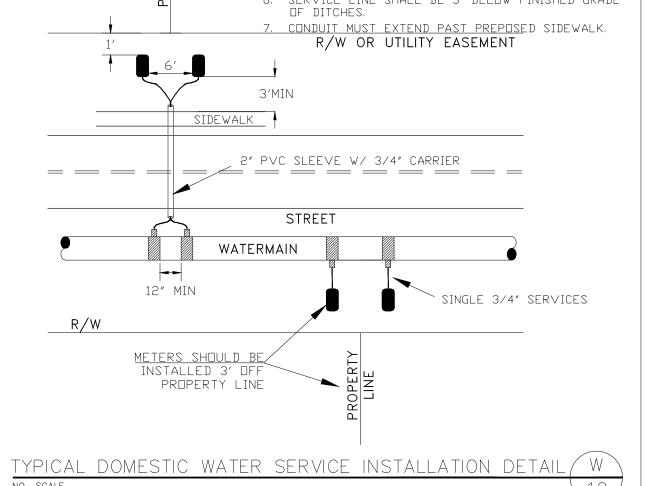

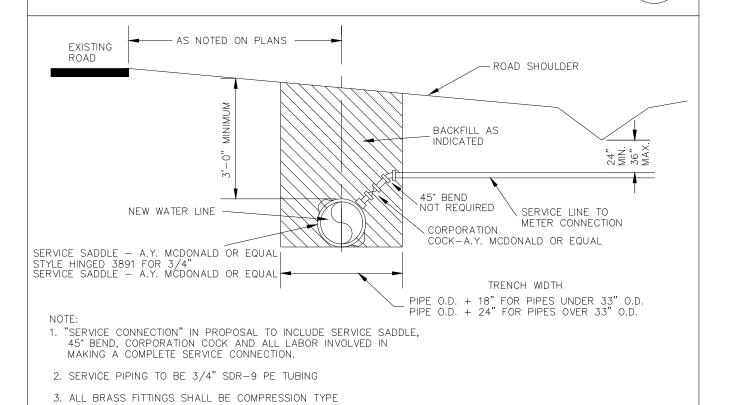

TYPICAL WATER SERVICE CONNECTION

USING TAPPING SADDLE DETAIL

NO SCALE

)rawn: RJH Checked:


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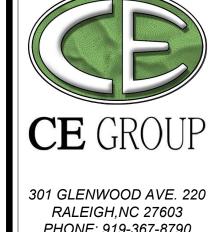
N/A

CAITLIN CROSSING AMENITY CENTER UTILITY DETAILS

Computer Dwg. Name 147-03 amenity details

JANUARY 29, 2024



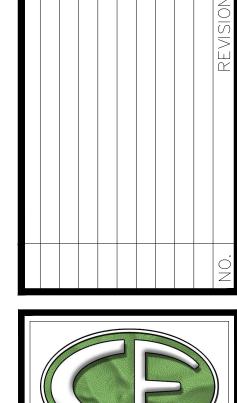

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PROJECT # 005623 DESIGN DEVELOPMENT **REVIEW SET 01-25-24**

SHEET TITLE: Pool House

Floor Plan & Roof Plan

SHEET NUMBER:

ROOF PLAN GENERAL NOTES

1. ALL DOWNSPOUTS ARE 6" AND TO TIE INTO STORM. SEE CIVIL

2. APPLY ICE+WATER SHIELD TO ALL AREAS OF ROOF NOTED BELOW: - VALLEYS. MIN. 18" EACH SURFACE - ROOF SLOPES BELOW 4:12 - ROOF/WALL INTERSECTIONS

D.S. = DOWNSPOUT T.R.B. = TO ROOF BELOW


Pool House - Roof Ventilation A Ceiling area (square footage) B Sqft. of ventilation required Formulas: B = A / 300

Builder to calculate quantities and types of vents to make up the minimum requirement. Attic ventilation shall be approximately 50% soffit, and 50% high (gable end or ridge vents).

POOL HOUSE - ROOF PLAN

8:12

SCALE: 1/4" = 1'-0"

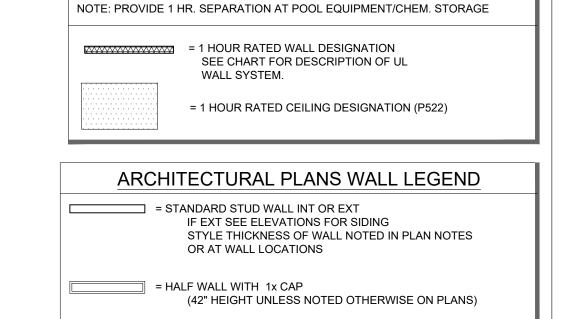

RATED WALL PLAN LEGEND

x -	_	WALL LEGEND			
SEE SHEET G020 FOR ALL ASSOCIATED WALL TYPES.					
MARK	UL WALL TYPE	DESCRIPTION			
1	U305	SINGLE 1 HOUR RATED WALL			
2	U356	1 HOUR RATED EXTERIOR WALL			
3	P522	1 HOUR RATED CEILING / ROOF SEPARATION			

MARK	UL WALL TYPE	DESCRIPTION
1	U305	SINGLE 1 HOUR RATED WALL
2	U356	1 HOUR RATED EXTERIOR WALL
3	P522	1 HOUR RATED CEILING / ROOF SEPARATION

1. ALL EXTERIOR WALLS ARE ASSEMBLY TYPE W8 AT EXTERIOR LOCATIONS INDICATED ON THE

2. ALL EXTERIOR WALLS ARE 2X6 STUDS U.N.O AND DIMENSIONED TO EXTERIOR STUD EDGE.

ALL INTERIOR WALLS ARE ASSEMBLY TYPE W1 (U.N.O) 3. ALL GYPSUM BOARD TO BE MOISTURE RESISTANT ATTIC ACCESS

ATTIC ACCESS SHALL BE PROVIDED BY BUILDER ACCORDING TO LOCAL CODE.

EXTERIOR ELEVATIONS (U.N.O). SEE G SERIES SHEETS FOR DETAILS.

1. WALL AND CEILING HEIGHTS NOTES ARE BASED ON NOMINAL WALL SIZE (I.E. A 10'-1

1/8" ACTUAL WALL HEIGHT IS LABELED 10/0 ON THE PLANS). 2. PROVIDE FULL HEIGHT FRP FINISH AT POOL EQUIPMENT AND CHEM. STORAGE ROOMS

1. ALL EXTERIOR THRESHOLDS TO BE BARRIER FREE DESIGN.

SUMP PIT, POOL EQUIPMENT ROOM SIZE / LAYOUT , FLOOR DRAINS & HOSE BIBS TO BE VERIFIED BEFORE CONSTRUCTION BEGINS TO COORDINATE WITH POOL MANUFACTURES SPECS & DRAWINGS BY OTHERS. IF NOT SUPPLIED PRIOR TO PERMITTING DRAWING RELEASE ARCHITECT HOLDS NO LIABILITY FOR FUTURE COORDINATION (TYP).

(x) DOOR SCHEDULE

3'-0"

2'-4"

3'-6"

2-2'-6"

6 2'-4" 6'-8"

POOL HOUSE - DOOR SCHEDULE

6'-8"

6'-8"

CONSTRUCTION

1 3/8"

REMARKS

INSTRUCTIONS

PUSH/PULL PLATES

DOOR HEIGHT PER MANF. SPECS.

DOOR HEIGHT PER MANF. SPECS.

ANY STRUCTURAL INFORMATION SHOWN IS FOR REFERENCE ONLY & TO BE CONFIRMED ON THE APPROPRIATE STRUCTURAL SHEETS. IF THERE ARE ANY DISCREPANCIES BETWEEN THE ARCHITECTURAL AND STRUCTURAL SHEETS, THE INFORMATION SHOWN ON THE STRUCTURAL SHEETS WILL OVERRIDE ANY ARCHITECTURAL INFORMATION SHOWN AND SHOULD BE REPORTED TO PLANWORX ARCHITECTURE, P.A., FOR CONFIRMATION BEFORE

4. MATERIALS STORED ARE CORROSIVE, IRRITANT, APPROX. 200 LBS. SOLID.

24"x24"x24" DEEP SUMP PIT W/ 6" TO S.S. VERIFY FINAL SIZE AND LOCATION WITH POOL ENGINEERS DRAWINGS.

6. 10. CHEMICAL STORAGE SPACE BASED ON MIN. OF FIVE SQFT. FOR THE FIRST 10,000 GALLONS OF POOL WATER PLUS ONE ADDITIONAL SQFT. FOR EACH ADDITIONAL 3,000 GALLONS OR PORTION THEREOF UP TO A TOTAL AREA OF 100 SQFT. STORAGE SIZE TO BE FIELD VERIFIED.

	4 A200 12'-7" SEE NO	30'-0"	8'-8 ¹ / ₂ "	8'-82"	1 A400
2B A200 "16-0" 16-0" 6-11"		T'X24" SUMP PIT FO D TO S.S. 66	8 8 9 5 7 5 11" 3 3'-6" 2'-	MEN 2x6 & WALL 0" 5'-9½" FLOOR DRAIN 36" WALL HUNG VANITY @ 34"H MAX. 6'-1½"	200 A200 A200 A200 A200 A200 A200 A200
INSTALL HAZARD SIGN AND SIGN TO LIMIT STORAGE QUANTITIES: "POOL CHEMICAL STORAGE LIMITED TO MAXIMUM 1,000 LBS SOLID OR 100 GAL. LIQUID."	9'-82"	9'-8 ¹ ₂ "	E.	9'-82"	6" SQ. POST WRAPPED (TYP)
ALL DIMENSIONS ON THIS STRING ARE TO € OF COLUMNS FIRE EXTINGUISHER	8'-1"	4'-1½" 6'- 3 A200	5'-0"	6'-1½"	<u>S</u>

- 24"X24" ATTIC ACCESS RATED SIMILAR TO SURROUNDING CEILING

8:12

RIDGE VENT

8:12

SQUARE FOOTAGE POOL EQUIPMENT ROOM = CHEM. STORAGE = BATHROOMS = 279 PORCH / SHOWER = 178 GROSS BLDG. SQ. FT. =

POOL HOUSE - FLOOR PLAN

SCALE: 1/4" = 1'-0" 1. All drawings are to be coordinated with all site information by owner and contractor, and applicable codes. 3. Planworx Architecture, P.A. is not responsible for constructed variations from the information depicted.

5. Planworx Architecture, P.A. retains ownership of all of designs depicted and implied herein. 2. Contractor is to notify architect immediately of conditions or items varying from depicted information.
4. Planworx Architecture, P.A. will not assume any liability for expenses associated with errors and omissions on these drawings unless offset by verified construction savings as a result of Planworx Architecture, P.A. will not assume any liability for expenses associated with errors and omissions on these drawings unless offset by verified construction savings as a result of Planworx Architecture, P.A. will not assume any liability for expenses associated with errors and omissions on these drawings unless offset by verified construction savings as a result of Planworx Architecture, P.A. will not assume any liability for expenses associated with errors and omissions on these drawings unless offset by verified construction savings as a result of Planworx Architecture, P.A. will not assume any liability for expenses associated with errors and omissions on these drawings unless offset by verified construction savings as a result of Planworx Architecture, P.A. will not assume any liability for expenses associated with errors and omissions on these drawings unless offset by verified construction savings as a result of Planworx Architecture, P.A. will not assume any liability for expenses associated with errors and omissions on these drawings unless offset by verified construction savings as a result of Planworx Architecture, P.A. will not assume any liability for expenses associated with errors and omissions on these drawings unless offset by verified construction of the saving and the planworx Architecture, P.A. will not assume any liability for expenses associated with errors and one saving and the planworx Architecture, P.A. will not assume any liability for expenses associated with errors and one saving and the planworx Architecture, P.A. will not assume any liability for expenses associated with errors and the planworx Architecture, P.A. will not assume any liability for expenses associated with errors and