

PLUME	BING	LEGEND	
DESCRIPTION	S`	YMBOL .	
COLD WATER			CW
HOT WATER			— нw
COLD WATER (FILTERED)		L	
RECIRCULATED WATER —	• • • •		—— HWR
VENT PIPING			v
WASTE PIPING -	NEW	EXISTING	w
CLEAN OUT IN GRADE	0	C.O.I.G.	
FLOOR CLEAN OUT	0	F.C.O.	
NON FREEZE HOSE BIBB	<del></del>	NFHB	
FLOOR DRAIN	0	F.D.	
CHECK VALVE			
BALL VALVE	M		
GATE VALVE	$\bowtie$		
SHUT-OFF VALVE	H		
DOUBLE CHECK VALVE	$\rightarrow \rightarrow \rightarrow$	-	
FIXTURE DESIGNATION	P		
MOUNTING HEIGHT	МН		
POINT OF CONNECTION NEW TO EXISTING	0		
FLOOR SINK	d		
SHOCK ABSORBER W/BALL VALVE SHUT-OFF	SA ———————————————————————————	SIZE PER MANUF. RECOMMENDATIONS	
CHANGE IN PIPE SIZE			

NOTE:

DASHED LINES REPRESENT FUTURE WALLS. INTERIOR UP-FIT WILL BE COMPLETED AT A LATER TIME.

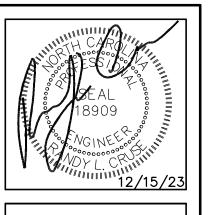


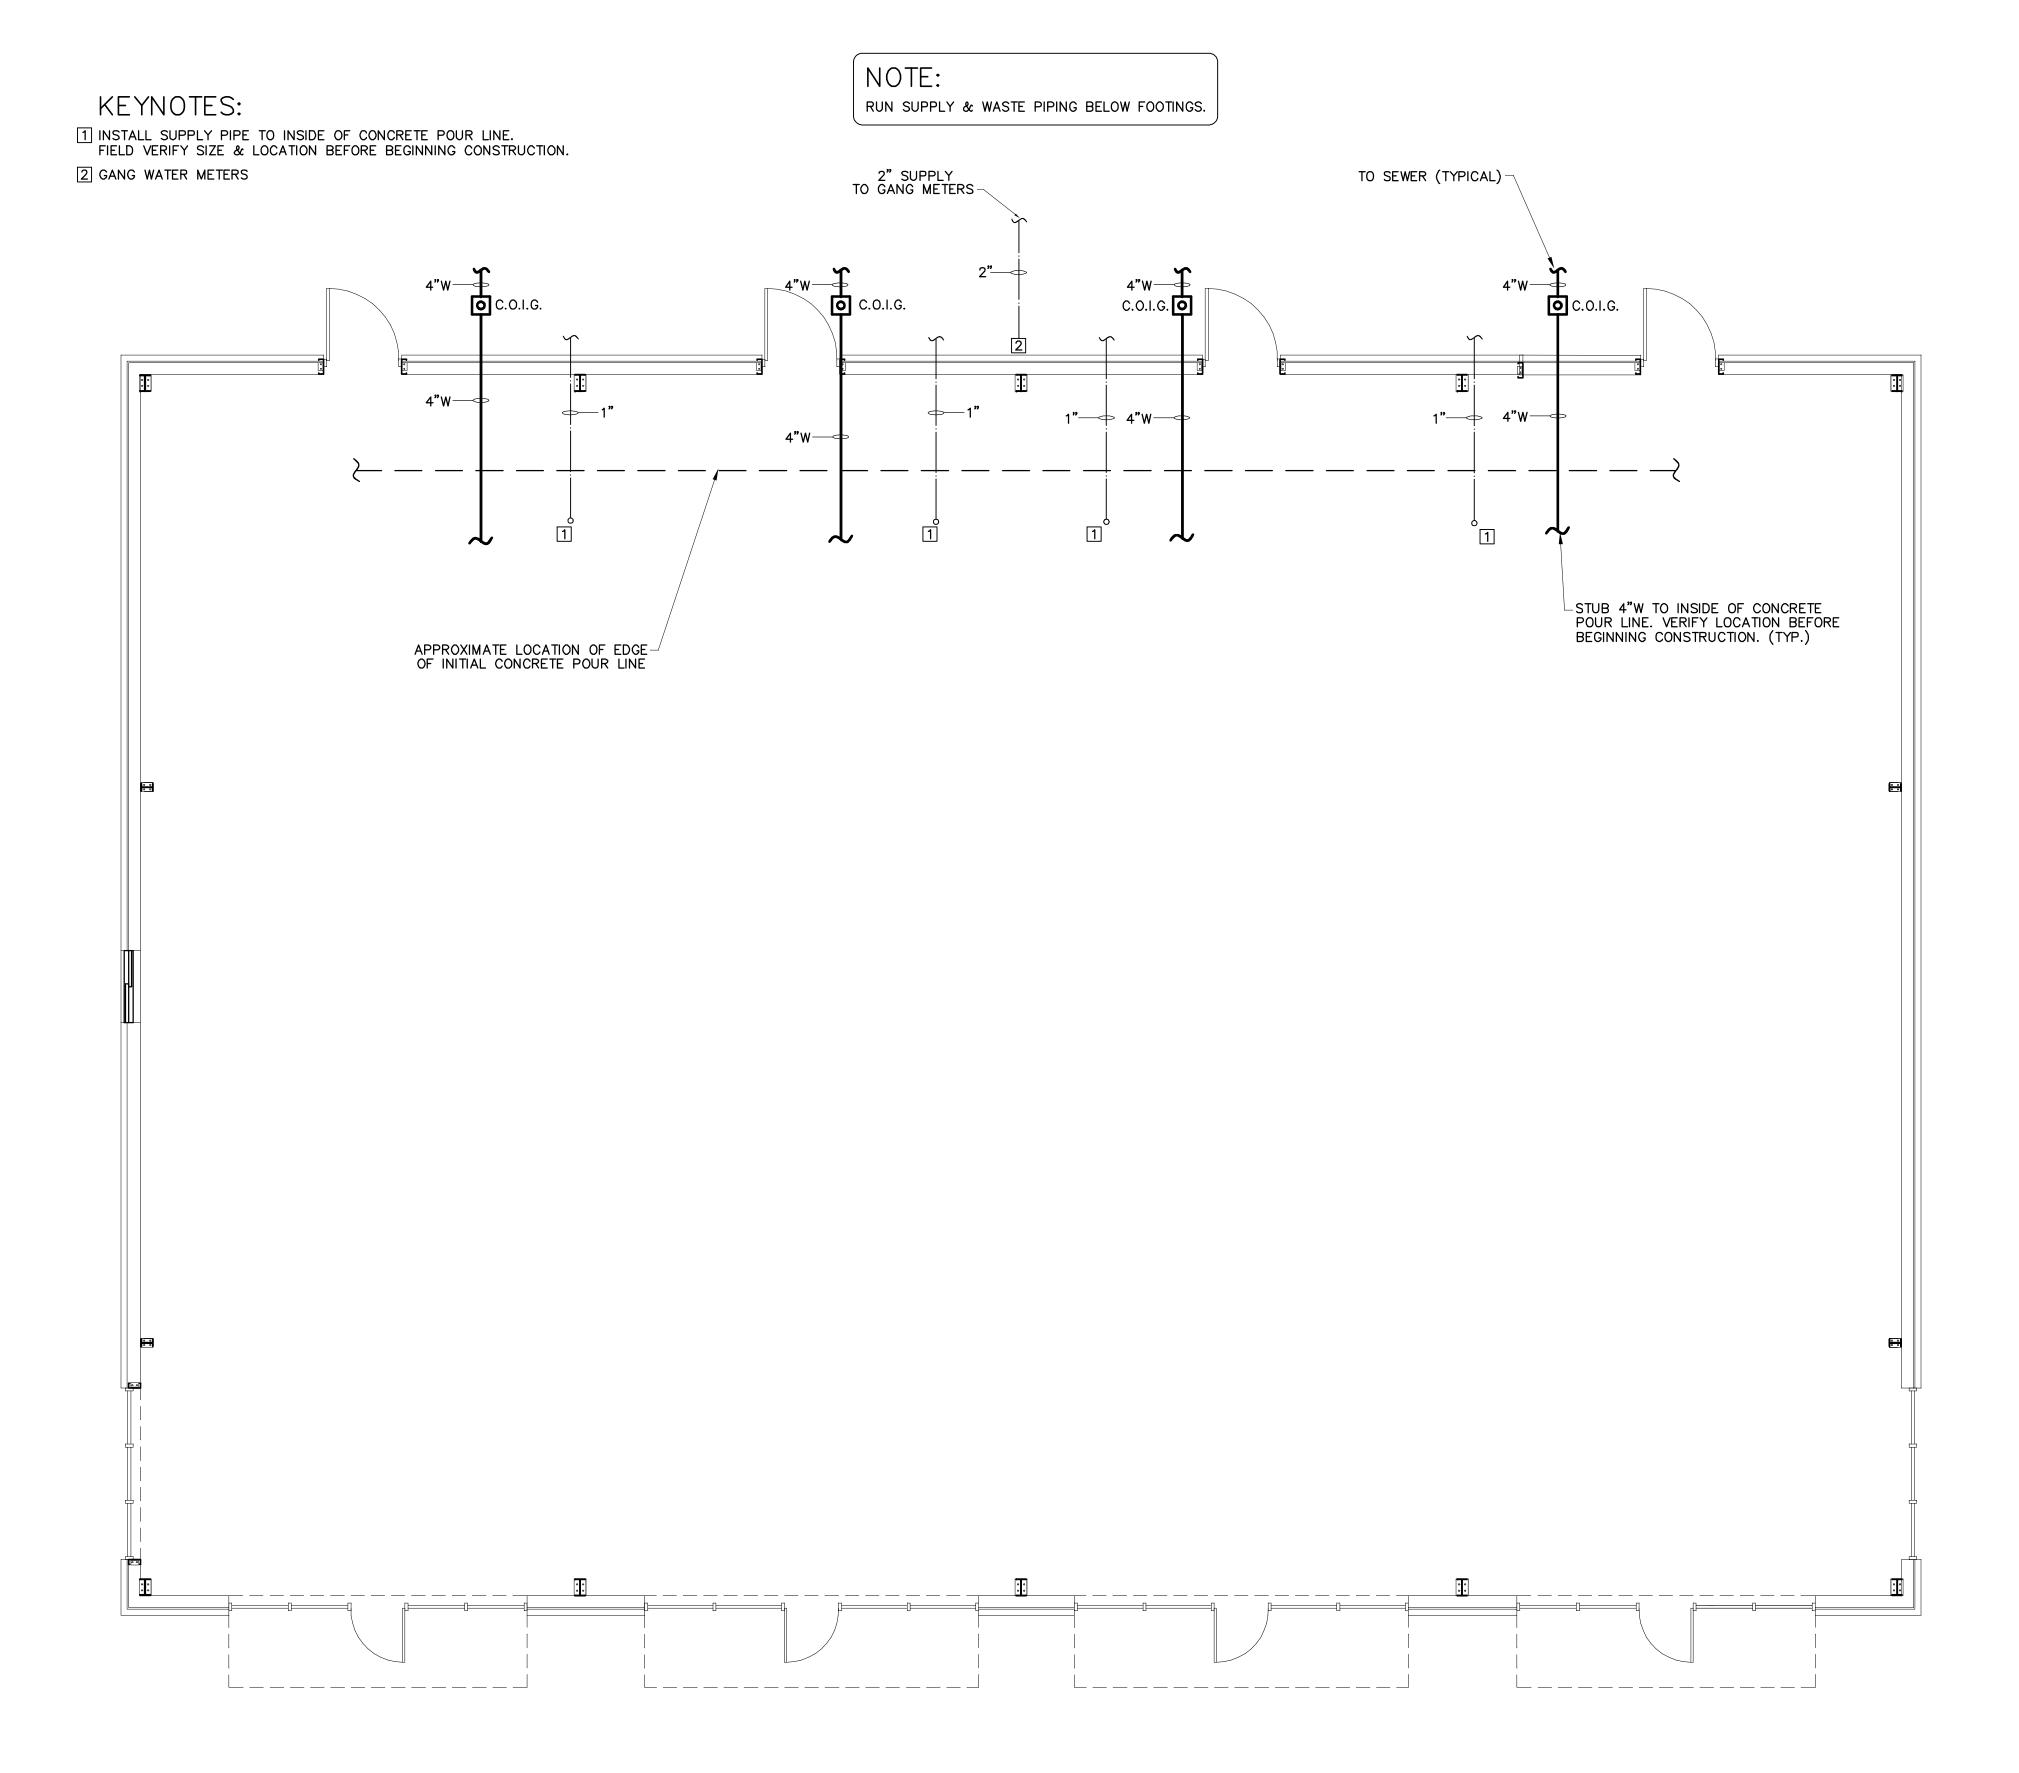

PLUMBING SUPPLY, WASTE & VENT PIPING PLAN SCALE: 3/16" = 1'-0"

BNICDING


REVISIONS

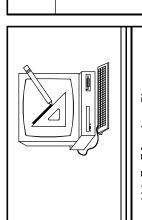

MENTS OF SERVICE AND AS SUCH THESE DRAWINGS, DESIGNS, AND DESIGN CONCEPTS PRESENTED REMAIN THE PROPERTY OF THE ENGINEER. PUBLISH OR DUPLICATE THE DRAWINGS OR DESIGNS ONLY WITH THE WRITTEN PERMISSION OF THE ENGINEER. C COPY RIGHT

DATE 12-15-23 DRAWN BY BAM JOB NO. 23-32

SHEET NO.

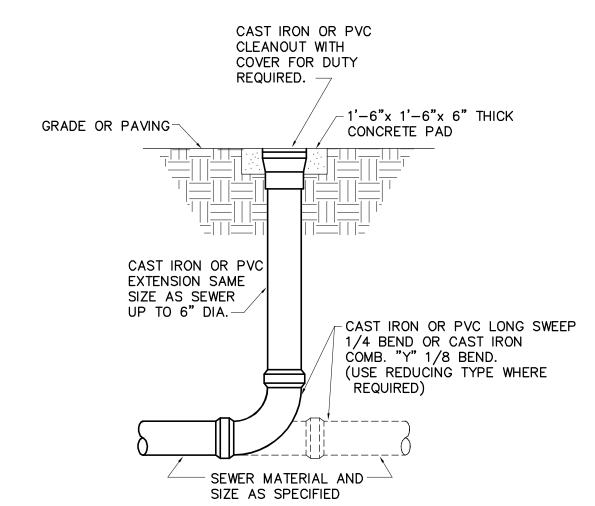

## DETAIL-CLEAN OUT AT GRADE NOT TO SCALE

## GENERAL PLUMBING NOTES

- 1. ALL WORK SHALL BE IN COMPLIANCE WITH APPLICABLE LOCAL, STATE, AND NATIONAL CODES.
- 2. CONTRACTORS SHALL COORDINATE PIPING WITH ALL OTHER TRADES.
- 3. CONTRACTOR SHALL REFER TO ARCHITECTURAL/STRUCTURAL DRAWINGS FOR DIMENSIONS.
- 4. CONTRACTOR SHALL FURNISH AND INSTALL DIELECTRIC UNIONS AT ALL CONNECTIONS BETWEEN DISSIMILAR METALS.
- 5. CONTRACTOR SHALL FURNISH AND INSTALL ESCUTCHEONS AND COVER PLATES AT ALL FINISHED WALLS, CEILINGS AND FLOOR OPENINGS.
- PIPING SHALL BE DISINFECTED IN ACCORDANCE WITH STATE AND LOCAL CODE. (REFER TO SPECIFICATIONS.)
- 7. ALL PIPING SHALL BE TESTED FOR LEAKS. IF ANY LEAKS ARE DETECTED THE PIPING SHALL BE REPAIRED, RESOLDERED OR REPLACED AND RETESTED.
- 8. ALL SOLDER SHALL BE OF THE LEAD FREE TYPE.
- WATER HEATER SHALL BE SUPPLIED WITH FACTORY INSTALLED T&P VALVES AND SHALL HAVE UNIONS AND ISOLATION VALVES.
- 10. DOMESTIC WATER SUPPLY PIPING SHALL BE COPPER OR CPVC. PEX IS ALLOWED WHERE PERMITTED BY CODE
- 11. WASTE AND VENT PIPING SHALL BE SCH. 40 PVC OR HEAVY DUTY CAST IRON UNDER TRAFFIC AREAS.
- 12. INSTALL THERMOSTATICALLY CONTROLLED MIXING VALVES AS NEEDED TO ENSURE HOT WATER

13. ALL FLOOR DRAINS & HUB DRAINS SHALL BE PROVIDED WITH TRAP PRIMER EXCEPT FLOOR DRAINS IN

- TEMPERATURE TO ALL HAND WASHING LOCATIONS DOES NOT EXCEED 110°F.
- TOILETS WHERE HOSE BIBS ARE PROVIDED. 14. HOT WATER PIPING SHALL BE INSULATED WITH 1" THICK FIBROUS GLASS INSULATION.
- COLD WATER PIPING SHALL BE INSULATED WITH 1/2" FIBROUS GLASS INSULATION. VAPOR BARRIER SHALL BE APPLIED TO EACH.