GOVERNMENTAL AGENCIES:

BUILDING DEPARTMENT Harnett County Central Permit 420 McKinney Pkwy Lillington, NC 27546 P:(910)893-7525

PLANNING AND DEVELOPMENT Harnett County Planning Services 420 McKinney Parkway Lillington, NC 27546 P:(910)893-7525

HEALTH DEPARTMENT Harnett County Health Department 307 W Cornelius Harnett Boulevard Lillington, NC 27546 P:(910)893-7550

FIRE DEPARTMENT Harnett County Fire Marshal 1005 Edwards Brothers Dr Lillington, NC 27546 P:(910)893-7580

CODE DATA:

BUILDING 2018 NORTH CAROLINA STATE BUILDING CODE **PLUMBING** 2018 NORTH CAROLINA STATE PLUMBING CODE MECHANICAL 2018 NORTH CAROLINA STATE MECHANICAL CODE **ELECTRICAL** 2017 NORTH CAROLINA STATE ELECTRICAL CODE FIRE 2018 NORTH CAROLINA STATE FIRE CODE

ENERGY 2018 NORTH CAROLINA STATE ENERGY CONSERVATION CODE

LIFE SAFETY 2010 NFPA 101 LIFE SAFETY CODE **ACCESSIBILITY** 2010 ACCESSIBILITY STANDARDS

BUILDING DATA:

INTERIOR:

OCCUPANCY CLASSIFICATION: CONSTRUCTION TYPE: II-B; UNPROTECTED

SPRINKLERS: NO STANDPIPES: FIRE DISTRICT:

AREA (EXISTING): 1945 S.F. (CONDITIONED AREA).

OCCUPANT LOAD:

KITCHEN: 1:200 SF NET 1095 SF= QUEING: 1:5 SF NET 75 SF= 1:15 SF NET 775 SF= DINING:

OVERALL:




#80419

Campbell University **Britt Hall**

NOTE:

GENERAL CONTRACTOR MUST **VERIFY UTILITIES UPDATES &** CONNECTIONS FOR RELOCATED EQUIPMENT AS WELL AS ELECTRICAL AND PLUMBING **ROUGH-INS**

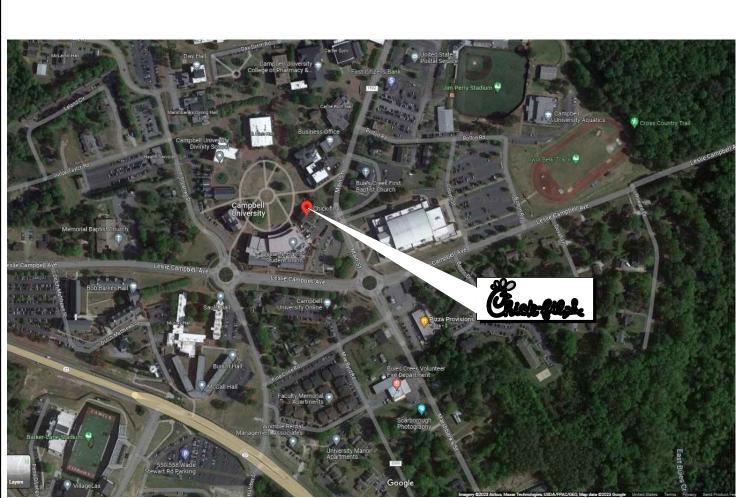

SCOPE OF WORK

- PROVIDE ALL NEW FINISHES, PLUMBING FIXTURES, AND OTHER FIXED ELEMENTS AS PART OF NEW BUILDING - RELOCATE EXISTING EQUIPMENT TO COORDINATE WITH NEW LAYOUT

SERVING AREA - PROVIDE MODIFIED FINISHES, PLUMBING FIXTURES, MODIFIED MILLWORK, AND OTHER FIXED ELEMENTS AS

PART OF NEW BUILDING ASSEMBLY

- RELOCATE EQUIPMENT TO COORDINATE WITH NEW LAYOUT

- RELOCATE EQUIPMENT TO COORDINATE WITH NEW LAYOUT

- MODIFY NEW FINISHES AND OTHER FIXED ELEMENTS AS PART OF NEW BUILDING ASSEMBLY

*NOTE: REVISION SCHEDULE ABOVE MAY NOT LIST REVISIONS TO ALL DISCIPLINES. REFER TO REVISED DRAWINGS FOR CHANGES TO SHEETS NOT LISTED HERE.

ARCHITECT:

HILL FOLEY ROSSI AND ASSOCIATES, LLC. 3680 PLEASANT HILL ROAD SUITE 200

DULUTH, GA 30096 PHONE: (770) 622-9858 FAX: (770) 622-9535 CONTACT: SAMUEL GERMANY

ELECTRICAL ENGINEER:

PAGE INTERWORKS, P.A. 923 MAIN STREET NORTH WILKESBORO, NC 28659 PHONE: (336) 667-4225 EXT. 326 CONTACT: CHRIS G. ANDERSON

KITCHEN DESIGNER:

TRIMARK STRATEGIC EQUIPMENT 3800 CAMP CREEK PARKWAY 1800, STE 114 ATLANTA, GA 30331 PHONE: (865) 466-1259 CONTACT: JESSICA DUGGAN

PLUMBING ENGINEER:


2

PAGE INTERWORKS, P.A. 923 MAIN STREET NORTH WILKESBORO, NC 28659 PHONE: (336) 667-4225 EXT. 326 CONTACT: CHRIS G. ANDERSON

ITEMS OF IMPORTANCE

NO. DESCRIPTION



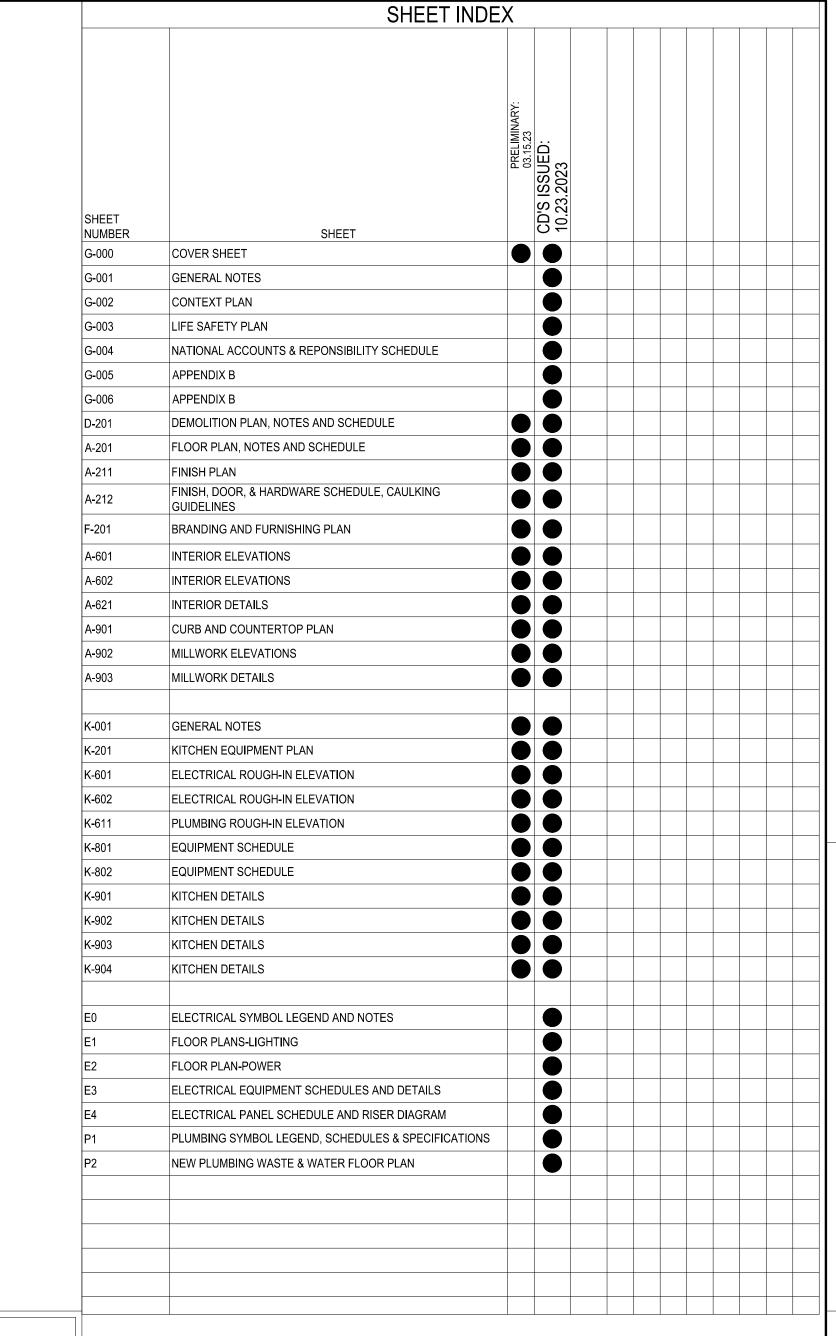





Chick-fil-A **5200 Buffington Road** Atlanta, Georgia 30349-2998



Hill Foley Rossi & Associates ARCHITECTURE + ENGINEERING 3680 Pleasant Hill Road Suite 200 Duluth, GA 30096 770.622.9858

This drawing and all reproductions thereof are the property of Hill Foley Rossi & Associates, LLC.(HFR). It is intended for the sole use of the project named hereon. Reproduction without the written consent of HFR is unlawful. All copies are to be returned to HFR upon project completion.

SEALED: 10/25/2023





BUILDING TYPE / SIZE: RELEASE:

REVISION SCHEDULE NO. DATE DESCRIPTION

CONSULTANT PROJECT # 21.554 10.25.2023 DRAWN BY produced for above named project may not be reproduced in any manner without express written or verbal consent from

COVER SHEET

AS THOSE FOUND ABOVE A CEILING, INCLUDING INTERSTITIAL SPACES.

PROTECT ALL OPENINGS

(LEVERS, PANIC HARDWARE, OR U-SHAPE DESIGNED DEVICES, ETC.)

METHODS ASTM E814 OR UL 1479 FOR FIRE RATING.

FIRE RATED AS IS THE WALL OR CEILING.

TENANT SIGNAGE, FABRIC AWNINGS AND ETC.

RECOMMENDATIONS AND PROCEDURES

22. GC to treat the soil beneath slab with termite poison unless already treated.

23. ALL MATERIALS ARE TO BE NEW UNLESS OTHERWISE NOTED.

AND S.S.P.C., SECTION 1210.1.4).

SYMBOL SCHEDULE

(# A#.#)

ABBREVIATIONS

A.B.

ARCH.

B.U. ROD

BSMT.

B.M.

BLKG.

BLDG.

C.I.P.

CLG.

CEM.

CTR.

CER.

COL.

CONC.

C.M.U.

CONST.

CONT.

CONTR.

COORD.

C.G.

DET.

DIA.

DIM.

DN.

DWG.

ELEC.

E.W.C.

ELEV.

EQ.

EQMT.

EXIST.

E.J.

FLR.

F.D.

F.R.P.

ACESS PANEL

ANCHOR BOLT

AREA DRAIN

BASEMENT

BLOCKING

BFAM

BOARD

BOTTOM

BUILDING

CEILING

CEMENT

CENTER

CERAMIC

COLUMN

CONCRETE

CENTER LINE

CERAMIC TILE

CONSTRUCTION

CONTROL JOINT

CORNER GUARD

CONTINUOUS

CONTRACTOR

COORDINATE

DETAIL

DIAMETER

DRAWING

ELECTRIC

ELEVATION

EQUIPMENT

EXPANSION JOIN

FINISH FLOOR

FLOOR DRAIN

fiberglass reinforced PANELS

EXISTING

EQUAL

FLOOR

DOWN

DIMENSION

CONCRETE MASONRY UNIT

FLECTRIC WATER COOLER

BACK-UP ROD

BENCH MARK

CAST IN PLACE

ARCHITECTURAL

ABOVE FINISHED FLOOR

ACOUSTICAL CEILING PANEL

PROVIDE ILLUMINATED EXIT SIGNS WITH BATTERY BACKUP DESIGNATING EXITS AND WAYS OF TRAVEL THERETO.

11. FIRE partition SHALL SHALL BE CONTINUOUS FROM demising wall to demising wall, FROM ANOTHER FIRE rated wall TO

BUILDING SERVICES EQUIPMENT THROUGH FIRE BARRIERS SHALL BE PROTECTED AS FOLLOWS:

ABOVE ANY DECORATIVE CEILING AND CONCEALED SPACES WITH THE FOLLOWING:

HR. FIRE Partition (coordinate rating with floor plan)

A FIRE rated wall, OR A COMBINATION THEREOF: INCLUDING CONTINUITY THROUGH ALL CONCEALED SPACES SUCH

PASSAGES OF PIPES, CONDUITS, BUS DUCTS, CABLES, WIRES, AIR DUCTS, PNEUMATIC DUCTS, AND SIMILAR

THE SPACE BETWEEN PENETRATING ITEM AND fire partition SHALL BE FILLED WITH A MATERIAL CAPABLE OF

FIRE partitions SHALL BE EFFECTIVELY AND PERMANENTLY IDENTIFIED WITH 2" STENCILING (AT 8' 0N CENTER)

MAINTAINING THE FIRE RESISTANCE RATING OF THE Wall PRODUCT. PRODUCT USED MUST MEET TEST

. REFER TO ACCESSIBILITY PLAN FOR TYPE AND LOCATIONS OF FIRE EXTINGUISHERS. ALL FIRE EXTINGUISHERS

ARE ARE TO BE MOUNTED WHERE THEY ARE READILY VISIBLE AND ACCESSIBLE. ADDITIONAL UNITS MAY BE

REQUIRED TO MEET A 75 FT. TRAVEL DISTANCE LIMITATION. INSTALL IN ACCORDANCE WITH NFPA 10 OR PER

: WHEN A BEAM OR COLUMN BECOMES PART OF A FIRE RATED WALL OR CEILING IT MUST BE PROTECTED AND BE

14. THE FLOOR ON BOTH SIDES OF A DOOR SHALL BE LEVEL AND SHALL HAVE THE SAME ELEVATION ON BOTH SIDES

15. EVERY INTERIOR AND EXTERIOR DOOR IN THE TENANT SUITE SHALL BE PROVIDED WITH HANDICAP HARDWARE

16. PROVIDE CONTINUOUS BLOCKING IN ALL STUD WALLS THAT ARE TO RECEIVE GRAB BARS, TOILET PARTITIONS

17. ALL METAL STUD GAGE DESIGN SHALL BE AS REQUIRED BY PERFORMANCE AND AS INDICATED IN THE DRAWINGS.

19. WHERE MATERIAL FASTENERS ARE NOT INDICATED, PROVIDE AS SPECIFIED BY THE MATERIAL MANUFACTURER'S

20. USE ONLY "LEAD-FREE" PIPE AND SOLDER FOR DOMESTIC WASTE SYSTEM. (SAFE DRINKING WATER ACT OF 1986

21. ALL EXTERIOR MECHANICAL OPENINGS LARGER THAN 12" x 12" SHALL BE EQUIPPED WITH BURGLAR BARS.

SHEET REFERENCE

DRAWING TITLE

REFERENCE

SECTION REFERENCE

GEN.

GYP.BD.

HDBD.

HDW.

HDWD.

H.M.

HOR.

INSUL.

MFR.

M.E.P.

MECH.

M.D.F

MTL.

MOD.

N.T.S.

O.C.

O.H.

O.D.

P.LAM.

PRFFAR

PARTITION TYPE

ENLARGED PLAN DETAIL DETAIL

GAL VANIZED

GYPSUM BOARD

HARDBOARD

HARDWARE

HARDWOOD

HORIZONTAL

INSULATION

INTERIOR

LAVATORY

LOCATION

MASONRY

MAXIMUM

MINIMUM

MODIFIED

MECHANICAL

LONG LEG HORIZONTAL

LONG LEG VERTICAL

MASONRY OPENING

MECH./ELEC./PLUMB.

MISCELLANEOUS

NOT APPLICABLE

NOT TO SCALE

ON CENTER

OPENING

OPPOSITE

OVER ALL

PAINTED

OVER HEAD

NOT IN CONTRACT

OPPOSITE HAND

OUTSIDE DIAMETER

OVERFLOW DRAIN

PLASTIC LAMINATE

PRESSURE TREATED

PREFABRICATED

MEDIUM DENSITY FIBERBOARD

MANUFACTURER

JOINT

LIGHT

HOLLOW METAL

INSIDE DIAMETER

GRID LINE

GAUGE

GENERAL

GLASS

HEIGHT

18. PROVIDE SEPARATION BETWEEN ALL DISSIMILAR METALS INCLUDING SCREWS, NAILS AND OTHER FASTENING

OF THE DOOR, FOR A DISTANCE ON EACH SIDE EQUAL TO THE WIDTH OF THE WIDEST SINGLE DOOR.

FLAME SPREAD AND SMOKE DEVELOPMENT RATINGS FOR BATT INSULATION VAPOR RETARDER SHALL BE AS FOLLOWS: FLAME SPREAD: 25 SMOKE DEVELOPMENT: 450

C. ALL LUMBER FRAMING SHALL BE MARKED WITH A GRADE STAMP.

WOOD FRAMING LUMBER (KILN DRIED TO 19% MAX. MOISTURE CONTENT): A. ROOF AND FLOOR FRAMING MEMBERS, AND WALL PLATES SHALL BE NO. 2 SOUTHERN YELLOW PINE OR B. WALL STUDS SHALL BE SPF STUD GRADE #1 OR BETTER.

WOOD STRUCTURAL PANELS SHALL BE APA RATED STRUCTURAL WOOD SHEATHING OF THICKNESS INDICATED. PROVIDE 1/8" GAP AT ALL SHEATHING PANEL EDGES. PROVIDE ONE PLYCLIP BETWEEN SUPPORTS AT ALL UNBLOCKED SHEATHING PANEL EDGES. METAL FRAMING ANCHORS AND HARDWARE SHALL BE MANUFACTURED BY SIMPSON STRONG-TIE UNLESS

APPROVED OTHERWISE. PROVIDE HOT-DIP ZINC COATED FASTENERS WHERE FRAMING IS EXPOSED TO WEATHER. INSTALL PER MANUFACTURER'S SPECIFICATIONS. ALL LUMBER IN CONTACT WITH CONCRETE, MASONRY OR EXPOSED TO WEATHER SHALL BE PRESSURE TREATED WITH WATERPROOFING TREATMENT, 28% MAX. MOISTURE CONTENT.

ALL FASTENERS USED IN OR TO COME IN CONTACT WITH PRESSURE TREATED LUMBER SHALL BE HOT DIPPED GALVANIZED, STAINLESS STEEL OR SIMPSON STRONG-TIE'S Z-MAX COATING. ALL FASTENERS INCLUDE, BUT ARE NOT LIMITED TO, ANCHOR BOLTS, MUDSILL ANCHORS, NAILS, SCREWS, ETC.

DRILL BOLT HOLES IN WOOD 1/16" LARGER THAN THE NOMINAL DIAMETER OF THE BOLT. REPAIR OVERSIZED HOLES WITH SIMPSON BP-5/8S BEARING PLATE WASHERS.

PROVIDE 2" SQUARE X 3/16" PLATE WASHERS AND NUTS FOR ALL BOLTS IN WOOD MEMBERS. RE-TORQUE NUTS 48 HOURS AFTER FIRST TIGHTENING.

8. THE NUMBER OR SPACING OF NAILS CONNECTING WOOD MEMBERS SHALL BE AS INDICATED BUT NOT LESS THAN THOSE SPECIFIED IN IBC "FASTENING SCHEDULE" TABLE 2304.9.1. POWER DRIVEN FASTENERS SHALL CONFORM TO CABO NER-272.

10. FRAMING STANDARDS: COMPLY WITH AFPA "MANUAL FOR WOOD FRAME CONSTRUCTION" AND CHAPTER 23 OF THE "INTERNATIONAL BUILDING CODE"...

THE OCCUPANCY CONTENT SHALL BE DETERMINED BY THE BUILDING DESIGNER AND CAN BE FOUND IN THE OCCUPANCY NOTES AND VERIFIED BY FIRE SERVICES.

CONTRACTOR SHALL PERMANENTLY IDENTIFY ALL FIRE RATED WALLS (AND CORRESPONDING HOURLY

RATING) REQUIRED TO HAVE PROTECTED OPENINGS, CORRIDOR PARTITIONS, SMOKE STOP PARTITIONS HORIZONTAL EXIT PARTITIONS, AND EXIT ENCLOSURES EITHER BY INSTALLING SIGNS OR BY STENCILING IN CONCEALED SPACES IN A MANNER ACCEPTABLE TO TO THE AUTHORITY HAVING JURISDICTION.

PROVIDE THERMAL AND SOUND INSULATION PER building standard REQUIREMENTS IN ACCORDANCE WITH

4. all wood shall be FIRE-RETARDANT: including but not limited to blocking and plywood. 5. PROVIDED FIRE BLOCKING IN STUD WALLS & CEILINGS SO THAT VERTICAL DISTANCE SHALL NOT EXCEED 10

6. if SPRINKLER SYSTEM IS EXISTING. GENERAL CONTRACTOR RESPONSIBLE FOR ADJUSTING SPRINKLER HEADS FOR NEW CEILING HEIGHTS AND FLOOR PLAN. ADJUSTMENTS ARE TO BE MADE BY CERTIFIED SPRINKLER SUB-CONTRACTOR. GENERAL CONTRACTOR TO COORDINATE WITH building standards.

PROVIDE PORTABLE FIRE EXTINGUISHERS AS SPECIFIED IN LIFE SAFETY NOTE #2. COOKING EQUIPMENT SHALL BE IN ACCORDANCE WITH NFPA 96 RE: MECHANICAL

9. PROVIDE HOOD SUPPRESSION SYSTEM AS SHOWN ON MECHANICAL DRAWINGS.

10. PROVIDE HVAC SYSTEM IN ACCORDANCE WITH NFPA 90 A-RE: MECHANICAL

METAL STUD SCHEDULE

DOOR REFERENCE

WINDOW REFERENCE

CEILING TYPE & HEIGHT

INTERIOR ELEVATION

PLUMBING

PLYWOOD

RECEPTACLE

REINFORCING

REQUIRED

RFD WOOD

SCHEDULE

SECTION

SHEET

SIMILAR

SQUARE

STAND PIPE

STANDARD

STRUCTURAL

TOP OF SLAB

TOP OF STEEL

TOP OF WALL

TYPICAL

"V"-GROOVE

VESTIBULE

WORK POINT

WIDE FLANGE

WITHOUT

WOOD

VERTICAL

STEEL

SYSTEM

THICK

RISER

RADIUS

ROOM

PLYWD.

R.a.P.

REINF.

REQ'D

RAD.

S.A.B.

SCHED.

SECT.

S.S.

STD.

SYS.

T.&G.

T.O.S.

T.W.

V.GR.

VERT.

VEST.

V.W.C.

V.C.T.

W.W.M.

W/O

T.O.STL.

STRUC.

BEARING - HEIGHT

11. provide CLASS A CEILING AS SPECIFIED ON THE REFLECTED CEILING PLAN AND FINISH SCHEDULE.

12. PROVIDE MINIMUM OF CLASS "C" FINISHED ON WALLS AS SPECIFIED IN FINISH SCHEDULE.

13. coordinate opening protection between food preparation and service areas with building standards.

OCCUPANT LOAD SIGN, PROVIDE 2" X 8" BLACK SIGN WITH 1/2" WHITE HELVETICS LETTERS STATING "MAXIMUM OCCUPANT LOAD XXX". (SEE cS FOR MAXIMUM OCCUPANT LOAD.)

PROVIDE #10 ABC FIRE EXTINGUISHERS SUITABLE FOR CLASS ABC FIRES USING DRY CHEMICAL. AS REQUIRED BY LOCAL AUTHORITIES. LOCATE PER LOCAL AUTHORITIES. PROVIDE #10K RATED FIRE EXTINGUISHER AS REQUIRED BY LOCAL AUTHORITIES IN THE KITCHEN.

NON-LOADBEARING 0'-0" TO 10'-0" 25 GA. @ 16" O.C. 25 GA. @ 16" O.C. 25 GA. @ 16" O.C.

NON-LOADBEARING 10'-0" TO 15'-0" 22 GA. @ 16" O.C. 22 GA. @ 16" O.C. 25 GA. @ 16" O.C.

NON-LOADBEARING | 15'-0" TO 18'-0" | 20 GA. @ 16" O.C. | 22 GA. @ 16" O.C. | 25 GA. @ 16" O.C.

NON-LOADBEARING | 18'-0" TO 20'-0" | 18 GA. @ 16" O.C. | 22 GA. @ 16" O.C. | 25 GA. @ 16" O.C.

THESE GAUGES REPRESENT INTERIOR PARTITIONS ONLY, REFER TO DRAWINGS FOR ADDITIONAL STUD

BD. BOTH SIDES | BD. ONE SIDE

STRUCTURAL NOTES

THE GENERAL CONTRACTOR SHALL VERIFY ALL DIMENSIONS AND SITE CONDITIONS AND NOTIFY ARCHITECT OF ANY DISCREPANCIES PRIOR TO PROCEEDING WITH WORK. FOR DIMENSIONS NOT SHOWN ON STRUCTURAL DRAWINGS, SEE ARCHITECTURAL DRAWINGS. COORDINATE WITH OTHER DISCIPLINE DRAWINGS FOR DRIPS, CHAMFERS, REGLETS, SLOTS,

SLEEVES, ANCHORS AND INSERTS. THE GENERAL CONTRACTOR SHALL COORDINATE ALL SIZES AND LOCATIONS OF ROOF PENETRATIONS WITH MECHANICAL AND ARCHITECTURAL DRAWINGS. PENETRATIONS GREATER THAN 12" ACROSS SHALL BE FRAMED AS SHOWN IN THE ROOF OPENING FRAMING DETAIL. DO NOT HANG OR ATTACH DUCTWORK, PIPING, LIGHTING, CONDUIT, EQUIPMENT, CEILINGS, ETC.

FROM METAL DECKING. ALL STRUCTURAL COMPONENTS ARE TO BE IN ACCORDANCE WITH THE BUILDING CODE AND 6. FASTENING

AMENDMENTS AS STATED ON THE COVER SHEET. FLOOR LOADS:

DESIGN SOIL BEARING PRESSURE = 2500 psf. SOIL BEARING PRESSURE SHALL BE VERIFIED PRIOR TO POURING SLAB. SOIL BEARING PRESSURE SHALL BE VERIFIED AND STRUCTURAL ENGINEER SHALL BE NOTIFIED IF THE ACTUAL SOIL BEARING PRESSURE IS LOWER THAN THE DESIGN SOIL PRESSURE.

PRIOR TO POURING CONCRETE, ALL DEBRIS, WATER, AND LOOSE EARTH SHALL BE REMOVED FROM THE FOUNDATION BED. THICKED SLABS UNDER BEARING WALLS AND COLUMNS SHALL BE POURED MONOLITHIC WITH SLAB. FINISH FACE OF CENTER SLAB TO BE FLUSH WITH FINISHED FACE OF EXISTING RIBBON

MINIMUM CONCRETE COMPRESSIVE STRENGTH AT 28 DAYS: SLAB ON GRADE- 3000 PSI CONCRETE PROPORTIONS SHALL CONSIST OF THE FOLLOWING MATERIALS TO ACHIEVE A MIX THAT WILL YIELD A FINISHED PRODUCT THAT WILL PRODUCE THE REQUIRED COMPRESSIVE STRENGTHS LISTED IN NOTE #1 ABOVE.

> a. PORTLAND CEMENT, ASTM C150, TYPE 1. b. FLYASH, ASTM C618, TYPE C OR F, NOT TO EXCEED 25% OF

CEMENT CONTENT BY WEIGHT. SLAG CEMENT IS NOT ALLOWED AT ANY TIME B. AGGREGATES: NORMAL WEIGHT, ASTM C33; LIGHT WEIGHT, ASTM C330. PROVIDE ALL AGGREGATE FROM A SINGLE SOURCE.

C. WATER: ASTM C94, POTABLE. D. AIR ENTRAINMENT ADMIXTURE: ASTM C260.

A. CEMENTITIOUS MATERIALS:

E. WATER REDUCING ADMIXTURE: ASTM C494, TYPE F OR G. F. CALCIUM CHLORIDE: ANY ADMIXTURE CONTAINING MORE THAN 0.1% CHLORIDE IONS, CONTENT BY WEIGHT. ARE NOT PERMITTED.

CONCRETE MIX DESIGNS MUST BE SUBMITTED TO THE E.O.R. FOR HIS APPROVAL BEFORE CONSTRUCTION BEGINS. MIX DESIGNS MUST BE SUBMITTED WITH COMPRESSIVE STRENGTH INFORMATION, FOR THAT SPECIFIC MIX, AS PER THE REQUIREMENTS OF CHAPTER 5 OF ACI-318. SUBMISSIONS WITHOUT THIS INFORMATION WILL BE STAMPED "REJECTED" & RETURNED TO THE CONTRACTOR WITHOUT E.O.R. REVIEW. THE CONTRACTOR IS RESPONSIBLE FOR SUBMITTING

THE NECESSARY INFORMATION FOR APPROVAL BEFORE CONSTRUCTION BEGINS. STRUCTURAL MEMBERS OF REINFORCED CONCRETE SHALL BE CONSTRUCTED IN ACCORDANCE WITH ACI 318-99. SLAB ON GRADE CONTROL OR CONSTRUCTION JOINTS SHALL BE LOCATED AT FULL HEIGHT

COLUMN LINES AND INTERMEDIATELY SO THAT NO JOINT SPACING SHALL EXCEED 12'-0" O.C. NOR SHALL THE LENGTH OF ANY PANEL EXCEED TWO TIMES THE WIDTH OF THAT PANEL. ALIGN JOINTS WITH JOINTS OF RIBBON SLAB WHERE POSSIBLE. FLOOR SLAB CONSTRUCTION JOINTS MAY BE DOWELED OR FORMED WITH METAL KEYWAYS. SEE

DETAIL 1/gn1.1 REINFORCING STEEL NOTES SHALL BE DETAILED, FABRICATED AND PLACED ACCORDING TO THE LATEST STANDARDS OF THE

AMERICAN CONCRETE INSTITUTE (ACI) AND THE CONCRETE REINFORCING STEEL INSTITUTE

MATERIALS REINFORCING BARS SHALL COMPLY WITH ASTM A615 GRADE 60, WELDED WIRE FABRIC SHALL COMPLY WITH ASTM A82 AND A185, REINFORCING BARS FOR WELDING SHALL COMPLY WITH

CLEAR MINIMUM COVER OF CONCRETE OVER REINFORCING BARS SHALL BE AS FOLLOWS CONCRETE PLACED AGAINST EARTH ... FORMED SURFACES EXPOSED TO EARTH ...

ALL BARS DENOTED CONTINUOUS ON PLANS, SECTIONS AND DETAILS SHALL HAVE CLASS "B" TENSION SPLICE LAPS AND CORNER BARS AND HOOKS AT DISCONTINUOUS ENDS. SPLICED BARS SHALL BE SECURELY WIRED TOGETHER. SPLICES OF ADJACENT REINFORCING BARS SHALL BE STAGGERED 24" WHEREVER POSSIBLE WELDED WIRE FABRIC, WHERE REQUIRED, SHALL BE PLACED IN THE CENTER OF THE SLAB

UNLESS NOTED OTHERWISE. LAP JOINTS ONE WIRE SPACING PLUS 2" OR A MINIMUM OF 6". EXTEND FABRIC TO WITHIN 1" OF EDGES OF SLABS ON GRADE PROVIDE ADEQUATE BOLSTERS, HIGH CHAIRS, SUPPORT BARS, ETC, TO MAINTAIN SPECIFIED

CLEARANCES FOR THE ENTIRE LENGTH OF ALL REINFORCING BARS AND WELDED WIRE FABRIC.

METAL STUD MANUFACTURER SHALL BE A MEMBER OF THE STEEL STUD MANUFACTURERS ASSOCIATION (SSMA).

METAL STUD STRENGTH CRITERIA: A. GAGES 25 THROUGH 18 - 33 KSI MIN. YIELD STRESS

B. GAGES 16 THROUGH 12 - 50 KSI MIN. YIELD STRESS C. RUNNER TRACK - 33 KSI MIN. YIELD STRESS METAL STUD MEMBER DESIGNATION:

OTHERWISE NOTED.

WEB DEPTH: 600 = 6" MEMBER TYPE: S = STUD FLANGE WIDTH: 137 = 1.37" (1 3/8") MIN. THICKNESS IN MILS. (gauge)

METAL STUDS AND ACCESSORIES SHALL HAVE A G60 GALVANIZED COATING UNLESS NOTED

FASTENERS: A. SCREW CONNECTIONS: FASTENING STUD TO STUD USE #10-16 teks #3 X 5/8" LONG BY itw BUILDEX OR APPROVED EQUAL UNLESS

FASTENING STUD TO MASONRY: USE 1/4" DIA. TAPCON SCREWS BY ITW BUILDEX OR APPROVED EQUAL. MIN, EMBEDMENT = 1"

MIN. EDGE DISTANCE = 2"

IN. SPACING BETWEEN FASTENERS = 3"

MILS

GAUGE


ACCESSIBILITY NOTES

USE 0.157" DIA. DOME HEAD nail OR APPROVED EQUAL UNLESS NOTED


All FLOOR SURFACES SHALL BE SLIP-RESISTANT.

SURFACE CROSS SLOPES SHALL NOT EXCEED 1/4-INCH PER FOOT. ABRUPT CHANGES IN LEVEL ALONG ANY ACCESSIBLE ROUTE SHALL NOT EXCEED 1/2-INCH. WHEN CHANGES IN LEVELS DO OCCUR, THEY SHALL NOT BE BEVELED WITH A SLOPE NO GREATER THAN

1:2 EXCEPT THAT LEVEL CHANGES NOT EXCEEDING 1/4-INCH MAY BE VERTICAL, WHEN CHANGES IN LEVELS GREATER THAN 1/2-INCH ARE NECESSARY, THEY SHALL COMPLY WITH THE REQUIREMENTS FOR CURB RAMPS & PEDESTRIAN RAMPS.

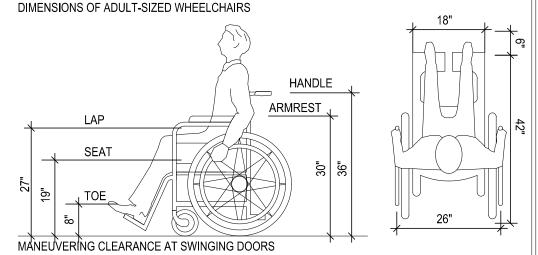

* = WHERE BOTH CLOSER AND LATCH ARE PROVIDED. 0" clearance needed where there is only a latch OR a closer or neither. ** = WHERE BOTH CLOSER AND LATCH ARE PROVIDED. 42" clearance is needed where there is only a latch OR a closer or neither.

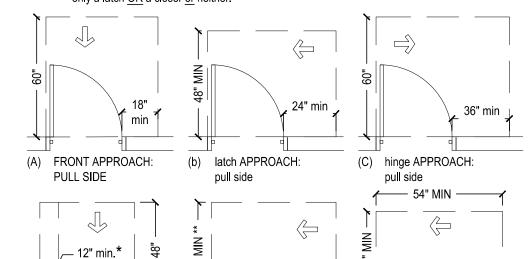

THE HEIGHT OF THE WALL JOISTS SHALL BE FABRICATED TO PROVIDE 12" OF UNPUNCHED WEB AT BEARING ENDS. PROVIDE JOIST WEB STIFFENERS PER METAL STUD MANUFACTURERS' RECOMMENDATIONS AT BEARING POINTS.

VERTICAL SPACING OF THE BRACING IS LIMITED TO A MAXIMUM OF 4'-0" THROUGHOUT

12. PROVIDE END BLOCKING WHERE JOISTS ARE NOT RESTRAINED AGAINST ROTATION. 13. PROVIDE ALL ACCESSORIES AS REQUIRED BY THE METAL STUD MANUFACTURER.

FASTENING TO CONCRETE OR MASONRY:

MIN. EMBEDMENT = $1 \frac{1}{4}$ MIN.

MIN. EDGE DISTANCE = 1/2"

FASTENERS MIN. AT THE JAMB

(1) SCREW MINIMUM AT EACH FLANGE

WALL OPENING FRAMING: ALL STUDS CUT TO CREATE WALL OPENING MUST BE REPLACED

FRACK TO STRUCTURAL STEEL

FASTENER MIN. AT JAMBS

(3) SCREWS MINIMUM

STUD TO STEEL OR CONCRETE:

WITH EQUAL FULL HEIGHT NUMBERS ON EACH SIDE OF THE OPENING.

STUD TO STUD:

CURTAIN WALL AND NON-LOADBEARING PARTITIONS:

ONE OF THE FOLLOWING METHODS:

ATTACHED AT EACH STUD.

THE HEIGHT OF THE WALL

FLOOR JOISTS ABOVE.

THE PRE-LOADED CONDITION.

LOAD BEARING WALLS

ATTACHED ON BOTH SIDES OF THE STUDS.

STUDS, AND ATTACHED AT EACH STUD.

AND ATTACHED AT EACH STUD.

STUDS, AND ATTACHED AT EACH STUD.

min. spacing between fasteners= 3"

APPROVED EQUAL UNLESS NOTED OTHERWISE.

MIN. EMBEDMENT = FULL PENETRATION

MIN. SPACING BETWEEN FASTENERS = 1

A. MINIMUM FASTENING REQUIREMENTS. UNLESS NOTED OTHERWISE

USE 0.157" DIA. DOME HEAD KNURLED SHANK FASTENER BY HILTI OR

8" O.C. TYP. W/ ADD'L FASTENERS 3" FROM END OF THE TRACK AND 2

12" O.C. TYP. W/ ADD'L FASTENER 3" FROM END OF TRACK AND (2)

USE POWDER actuated FASTENERS REFERENCED ABOVE. SEE

DETAILS FOR CONNECTIONS (MINIMUM 2 FASTENERS)

MECHANICAL BRACING OF STUDS IS NOT NECESSARY WHERE WALL SHEATHING IS

WHEN ONLY ONE FACE OF THE STUDS RECEIVE SHEATHING, PROVIDE BRACING BY

A. COLD ROLLED CHANNEL, RUN HORIZONTALLY, THROUGH STUD PUNCH OUTS AND

VERTICAL SPACING OF THE BRACING IS LIMITED TO A MAXIMUM OF 4'-0" THROUGHOUT

STUDS SHALL BE FULLY SEATED IN THE BOTTOM TRACK WITH A MAXIMUM 1/16" GAP IN

CONTRACTOR SHALL ALIGN VERTICAL STUDS IN LOAD BEARING WALLS WITH THE

A. COLD ROLLED CHANNEL, RUN HORIZONTALLY THROUGH STUD PUNCH OUTS

B. 2" WIDE 18 GAGE STEEL STRAPS RUN HORIZONTALLY, ON BOTH SIDES OF THE

LOAD BEARING WALL STUDS SHALL BE BRACED BY ONE OF THE FOLLOWING

B. 2" WIDE, 18 GAGE, STEEL STRAPS RUN HORIZONTALLY, ON BOTH SIDES OF THE

EDGE DISTANCE = 2"

<u>ASTENING TO STEEL</u>

ALL CONCRETE WORK SHALL CONFORM TO ACI 301 "SPECIFICATIONS FOR STRUCTURAL CONCRETE FOR BUILDING". THE DESIGN OF THIS BUILDING IS BASED ON ACI 318 "BUILDING

CODE REQUIREMENTS FOR REINFORCED CONCRETE." CONCRETE TEST REPORTS WILL BE AVAILABLE AT JOB AT ALL TIMES.

GENERAL CONTRACTOR TO PROVIDE 15 MIL. MIN. VAPOR BARRIER; PROVIDE MIN 6" SEAM OVERLAYS SEALED WITH VAPOR BLOCK TAPE (OR APPROVED EQUAL; MEET REQUIREMENT OF SECTION 5.8.18 OF ANSI/ASHRAE/IESNA STANDARD 90.1-2004, OVER 4" GRANULAR FILL. GENERAL CONTRACTOR TO CONFIRM IF PRE-SLAB INSPECTION IS REQUIRED by AUTHORITIES HAVING JURISDICTION: COORDINATE INSPECTION AS NECESSARY.

FLOOR SLAB SHALL BE 4" THICK CONCRETE REINFORCED WITH 6 x 6 W1.4 x W1.4 W.W.F. CENTER OF SLAB; NEW SLAB SHALL BE DOWELED TO EXISTING SLAB USING #4 DOWELS AT A MAX OF 18" O.C.: FINISHED FLOOR ELEVATION TO MATCH LEVEL OF EXISTING FLOOR. PROVIDE CONTINUOUS WATERPROOFING SILICONE BASED SEALANT AND BACKER ROD AT

ALL exterior STOREFRONT AND MASONRY JUNCTIONS AND TERMINATION'S, SEALANT SHALL PROVIDE CONCRETE SLAB CONTROL JOINTS PER 1/gn1.1.

CONDUITS AND PIPES EMBEDDED IN SLABS:

• SHALL NOT BE LARGER IN OUTSIDE DIMENSION THAN ONE-THIRD THE OVERALL THICKNESS • THEY SHALL NOT BE SPACED CLOSER THAN THREE DIAMETERS OR WIDTHS ON CENTER.

• A MINIMUM SLAB THICKNESS OF 2 1/2" MUST BE MAINTAINED OVER THE EMBEDDED ITEMS.

JOINTS AND SEALANT NOTES: PROVIDE CONTINUOUS WATERPROOFING SILICONE BASED SEALANT AND BACKER ROD AT ALL STOREFRONT AND MASONRY JUNCTIONS AND TERMINATIONS, SEALANT SHALL MATCH

PROVIDE CONTINUOUS SEALANT AND BACKER ROD AT ALL JUNCTIONS BETWEEN DISSIMILAR MATERIALS. I.E. BRICK TO E.I.F.S., STOREFRONT TO BRICK, ETC. DOW /CORNING #790. ALL METAL VENTS AND FLUES SHALL BE FLASHED WITH "PORTALS PLUS" FLASHING BOOT,

TYPICAL. SEAL ALL METAL TO METAL CONNECTIONS WITH DOW/CORNING #795. (NOTE: NO

CLEAR SILICONE SEALANT SHALL BE ALLOWED.) ALL EXTERIOR JOINTS IN THE BUILDING ENVELOPE THAT ARE SOURCES OF AIR LEAKS SHALL BE CAULKED, GASKETED, WEATHER-STRIPPED, OR OTHERWISE SEALED IN ACCORDANCE WITH SPECIFICATIONS.

SHOP DRAWING NOTES CONTRACTOR SHALL FURNISH COMPLETE AND DETAILED SHOP DRAWINGS FOR THE

FOLLOWING STRUCTURAL MATERIALS: CONCRETE MIX DESIGN

MASONRY UNITS, REINFORCING, MORTAR AND GROUT 2. UNLESS NOTED, SUBMIT SHOP DRAWINGS FOR ALL FABRICATED MATERIALS. DESIGN DRAWINGS SHALL NOT BE REPRODUCED FOR USE AS SHOP DRAWINGS. ALL SHOP DRAWINGS MUST BEAR THE REVIEW STAMP OF THE GENERAL CONTRACTOR. UNSTAMPED

SHOP DRAWINGS WILL BE REJECTED WITHOUT REVIEW. THE CONTRACTOR SHALL HAVE AN APPROVED SET OF ALL SHOP DRAWINGS AND PROOF OF WELDER CERTIFICATION AT THE JOB SITE AT ALL TIMES.

(D) FRONT APPROACH: (F) hinge APPROACH (E) latch APPROACH: Push SIDE push side \Rightarrow (G) hinge APPROACH: PHYSICALLY DISABLED.

ALL NEW PRIMARY ENTRANCES TO THE FACILITIES SHALL BE MADE ACCESSIBLE TO THE

ALL ACCESSIBLE ENTRANCES SHALL BE IDENTIFIED WITH AT LEAST ONE STANDARD SIGN AND WITH ADDITIONAL DIRECTIONAL SIGNS, AS REQUIRED, VISIBLE FROM APPROACHING PEDESTRIAN

EVERY REQUIRED ENTRANCE OR PASSAGE DOORWAY SHALL BE OF A SIZE AS TO PERMIT THE INSTALLATION OF A DOOR NOT LESS THAN 3 FEET IN WIDTH AND NOT LESS THAN 6 FEET-8 INCHES IN HEIGHT. DOORS SHALL BE CAPABLE OF OPENING AT LEAST 90 DEGREES AND SHALL BE SO MOUNTED THAT THE CLEAR WIDTH OF DOORWAY IS NOT LESS THAN 32-INCHES. LATCHING AND LOCKING DOORS THAT ARE HAND ACTIVATED AND WHICH ARE IN PATH OF TRAVEL

SHALL BE OPENABLE WITH A SINGLE EFFORT BY LEVER TYPE HARDWARE, THAT DOES NOT REQUIRE TIGHT GRASPING, PINCHING OR TWISTING OF WRIST TO OPERATE, PANIC BARS, PUSH-PULL ACTIVATING BARS, OR OTHER HARDWARE DESIGNED TO PROVIDE PASSAGE WITHOUT

REQUIRING THE ABILITY TO GRASP THE OPENING HARDWARE. REFER TO SECTION 404.2.7 OF IBC. THE FLOOR AND LANDING ON EACH SIDE OF AN ENTRANCE OR PASSAGE DOOR SHALL BE LEVEL AND CLEAR. THE LEVEL AND CLEAR AREA SHALL HAVE A LENGTH OF 60 INCHES IN THE DIRECTION OF TRAVEL AND THE LENGTH OF 48 INCHES IN OPPOSITE DIRECTION OF TRAVEL. SEE DIAGRAM "MANEUVERING CLEARANCE"

THE WIDTH OF THE LEVEL AND CLEAR AREA ON THE SIDE TO WHICH THE DOOR SWINGS SHALL EXTEND 24-INCHES PAST THE STRIKE EDGE OF THE DOOR FOR EXTERIOR DOORS AND 18-INCHES

PAST THE STRIKE EDGE FOR THE INTERIOR DOORS THE FLOOR OR LANDING SHALL BE NOT MORE THAN 1/2-INCH LOWER THAN THE THRESHOLD OF THE DOORWAY. CHANGE IN LEVEL BETWEEN 1/4- INCH AND 1/2-INCH SHALL BE BEVELED WITH A

SLOPE NO GREATER THAN 1:2 THE BOTTOM 10-INCHES OF ALL DOORS EXCEPT AUTOMATIC AND SLIDING DOORS SHALL HAVE A SMOOTH UNINTERRUPTED SURFACE TO ALLOW THE DOOR TO BE OPENED BY A WHEELCHAIR FOOTREST WITHOUT CREATING A TRAP OR HAZARDOUS CONDITION, WHERE NARROW FRAME DOORS ARE USED, A 10-INCH HIGH SMOOTH PANEL SHALL BE INSTALLED ON THE PUSHED SIDE OF

THE DOOR, WHICH WILL ALLOW THE DOOR TO BE OPENED BY A WHEELCHAIR FOOTREST WITHOUT CREATING A TRAP OR HAZARDOUS CONDITION. MAXIMUM EFFORT TO OPERATE DOORS SHALL NOT EXCEED 5 LBS. FOR EXTERIOR DOORS AND 5 LBS. FOR INTERIOR DOORS. SUCH PULL OR PUSH EFFORT BEING APPLIED AT RIGHT ANGLES TO HINGED DOORS AND AT THE CENTER PLANE OF SLIDING OR FOLDING DOORS, COMPENSATING DEVICES OR AUTOMATIC DOOR OPERATORS MAY BE UTILIZED TO MEET THE ABOVE STANDARDS. WHEN FIRE DOORS ARE REQUIRED, THE MAXIMUM EFFORT TO OPERATE THE DOOR MAY BE

INCREASED NOT TO EXCEED 15 LBS. EVERY AISLE SHALL BE NOT LESS THAN 3 FEET WIDE IF SERVING ONLY ONE SIDE, AND NOT LESS THAN 3 FEET 8 INCHES WIDE IF SERVING BOTH SIDES. SUCH MINIMUM WIDTH SHALL BE MEASURED AT THE POINT FARTHEST FROM AN EXIT, CROSS AISLE OR FOYER AND SHALL BE INCREASED BY 1 1/2 INCHES FOR EACH 5 FEET IN LENGTH TOWARD THE EXIT. CROSS AISLE OR FOYER WITH CONTINENTAL SEATING SIDE AISLES SHALL BE NOT LESS THAN 44 INCHES IN WIDTH.

16. THE CENTER OF RECEPTACLE OUTLETS SHALL BE NOT LESS THAN 15- INCHES ABOVE THE FLOOR

OR WORKING PLATFORMS. THE CENTER OF THE GRIP OF THE OPERATING HANDLE OF SWITCHES INTENDED TO BE USED BY THE OCCUPANT OF THE ROOM OR AREA TO CONTROL LIGHTING AND RECEPTACLE OUTLETS, APPLIANCES, OR COOLING, HEATING AND VENTILATING EQUIPMENT, SHALL BE 48" MAX HEIGHT FOR UNOBSTRUCTED FORWARD AND SIDE REACH. 48" MAX HEIGHT WITH 10" MAX. OBSTRUCTION

AT SIDE REACH. 46" MAX HEIGHT AT 24" MAX OBSTRUCTION AT SIDE REACH THE INTERNATIONAL SYMBOL OF ACCESSIBILITY SHALL BE THE STANDARD USED TO IDENTIFY FACILITIES THAT ARE ACCESSIBLE TO AND USABLE BY PHYSICALLY DISABLED PERSONS. THE SYMBOL SPECIFIED ABOVE SHALL CONSIST OF A WHITE FIGURE ON A BLUE BACKGROUND. THE BLUE SHALL BE EQUAL TO COLOR NO. 15090 IN FEDERAL STANDARD 595A.

19. EVERY PORTION OF EVERY BUILDING IN WHICH EQUIPMENT IS INSTALLED SHALL BE PROVIDED WITH AISLES (36" wide min.) LEADING TO AN EXIT. WHERE LOCKERS ARE PROVIDED, AT LEAST ONE AND NOT LESS THAN ONE PERCENT OF ALL

LOCKERS SHALL BE MADE ACCESSIBLE TO THE PHYSICALLY DISABLED. A PATH OF TRAVEL NOT LESS THAN 36-INCHES IN CLEAR WIDTH SHALL BE PROVIDED TO THESE LOCKERS AND A CLEAR SPACE FOR A CIRCLE WITH DIAMETER OF 60-INCHES. AT KITCHEN: SINKS, FAUCET CONTROLS AND OPERATING MECHANISMS SHALL BE OPERABLE WITH

ONE HAND AND SHALL NOT REQUIRE TIGHT GRASPING, PINCHING OR TWISTING OF THE WRIST. THE FORCE REQUIRED TO ACTIVATE CONTROLS SHALL BE NO GREATER THAN 5 LBS. LEVER-OPERATED, PUSH-TYPE AND ELECTRONICALLY CONTROLLED MECHANISMS ARE EXAMPLES OF ACCEPTABLE DESIGN. SELF-CLOSING VALVES ARE ALLOWED IF THE FAUCET REMAINS FOR AT

5200 Buffington Road Atlanta, Georgia



Hill Foley Rossi & Associates ARCHITECTURE + ENGINEERING 3680 Pleasant Hill Road Suite 200 Duluth, GA 30096 770.622.9858

his drawing and all reproductions thereof are the propert for the sole use of the project named hereon. Reproduction without the written consent of HFR is unlawful. All copies are to be returned to HFR upon project completion SEALED: 10/25/2023



0

BUILDING TYPE / SIZE

REVISION SCHEDULE NO. DATE DESCRIPTION


CONSULTANT PROJECT # 21.554 PRINTED FOR CD 10.25.2023 DRAWN BY

nformation contained on this drawing and in all digital files produced for above named project may not be reproduced in any manner without express written or verbal consent fron

GENERAL NOTES

RELEASE:

SHEET NUMBER

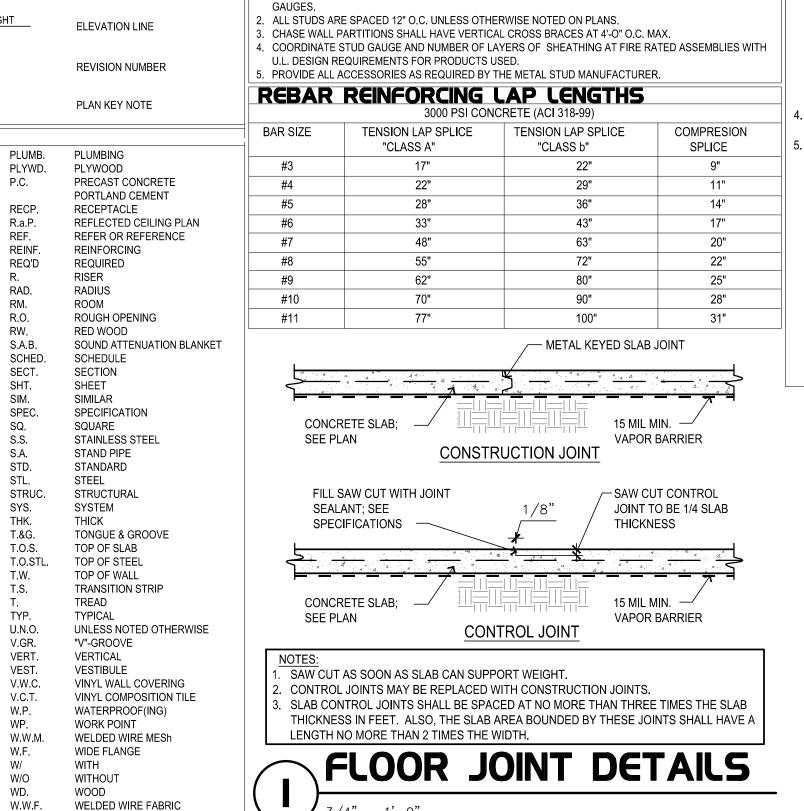

______ \vdash Chick-fil-A SPACE

CONTEXT PLAN

SCALE: NONE

3

SCOPE OF WORK

KITCHEN AREA

- PROVIDE ALL NEW FINISHES, PLUMBING FIXTURES, AND OTHER FIXED ELEMENTS AS PART OF NEW BUILDING

- RELOCATE EXISTING EQUIPMENT TO COORDINATE WITH NEW LAYOUT SERVING AREA

- PROVIDE MODIFIED FINISHES, PLUMBING FIXTURES, MODIFIED MILLWORK, AND OTHER FIXED ELEMENTS AS PART OF NEW BUILDING ASSEMBLY

- RELOCATE EQUIPMENT TO COORDINATE WITH NEW LAYOUT DINING AREA

- MODIFY NEW FINISHES AND OTHER FIXED ELEMENTS AS PART OF NEW BUILDING ASSEMBLY

- RELOCATE EQUIPMENT TO COORDINATE WITH NEW LAYOUT



Chick-fil-A 5200 Buffington Road Atlanta, Georgia 30349-2998



Hill Foley Rossi & Associates ARCHITECTURE + ENGINEERING 3680 Pleasant Hill Road Suite 200 Duluth, GA 30096 770.622.9858

© Copyright (as dated below).

This drawing and all reproductions thereof are the property of Hill Foley Rossi & Associates, LLC.(HFR). It is intended for the sole use of the project named hereon. Reproduction without the written consent of HFR is unlawful. All copies are to be returned to HFR upon project completion.

SEALED: 10/25/2023



#80419

BUILDING TYPE / SIZE: RELEASE: X X

REVISION SCHEDULE NO. DATE DESCRIPTION


CONSULTANT PROJECT #	21.5
PRINTED FOR	С
DATE	10.25.202
DRAWN BY	

Information contained on this drawing and in all digital files produced for above named project may not be reproduced in any manner without express written or verbal consent from

CONTEXT PLAN

SHEET NUMBER

G-002

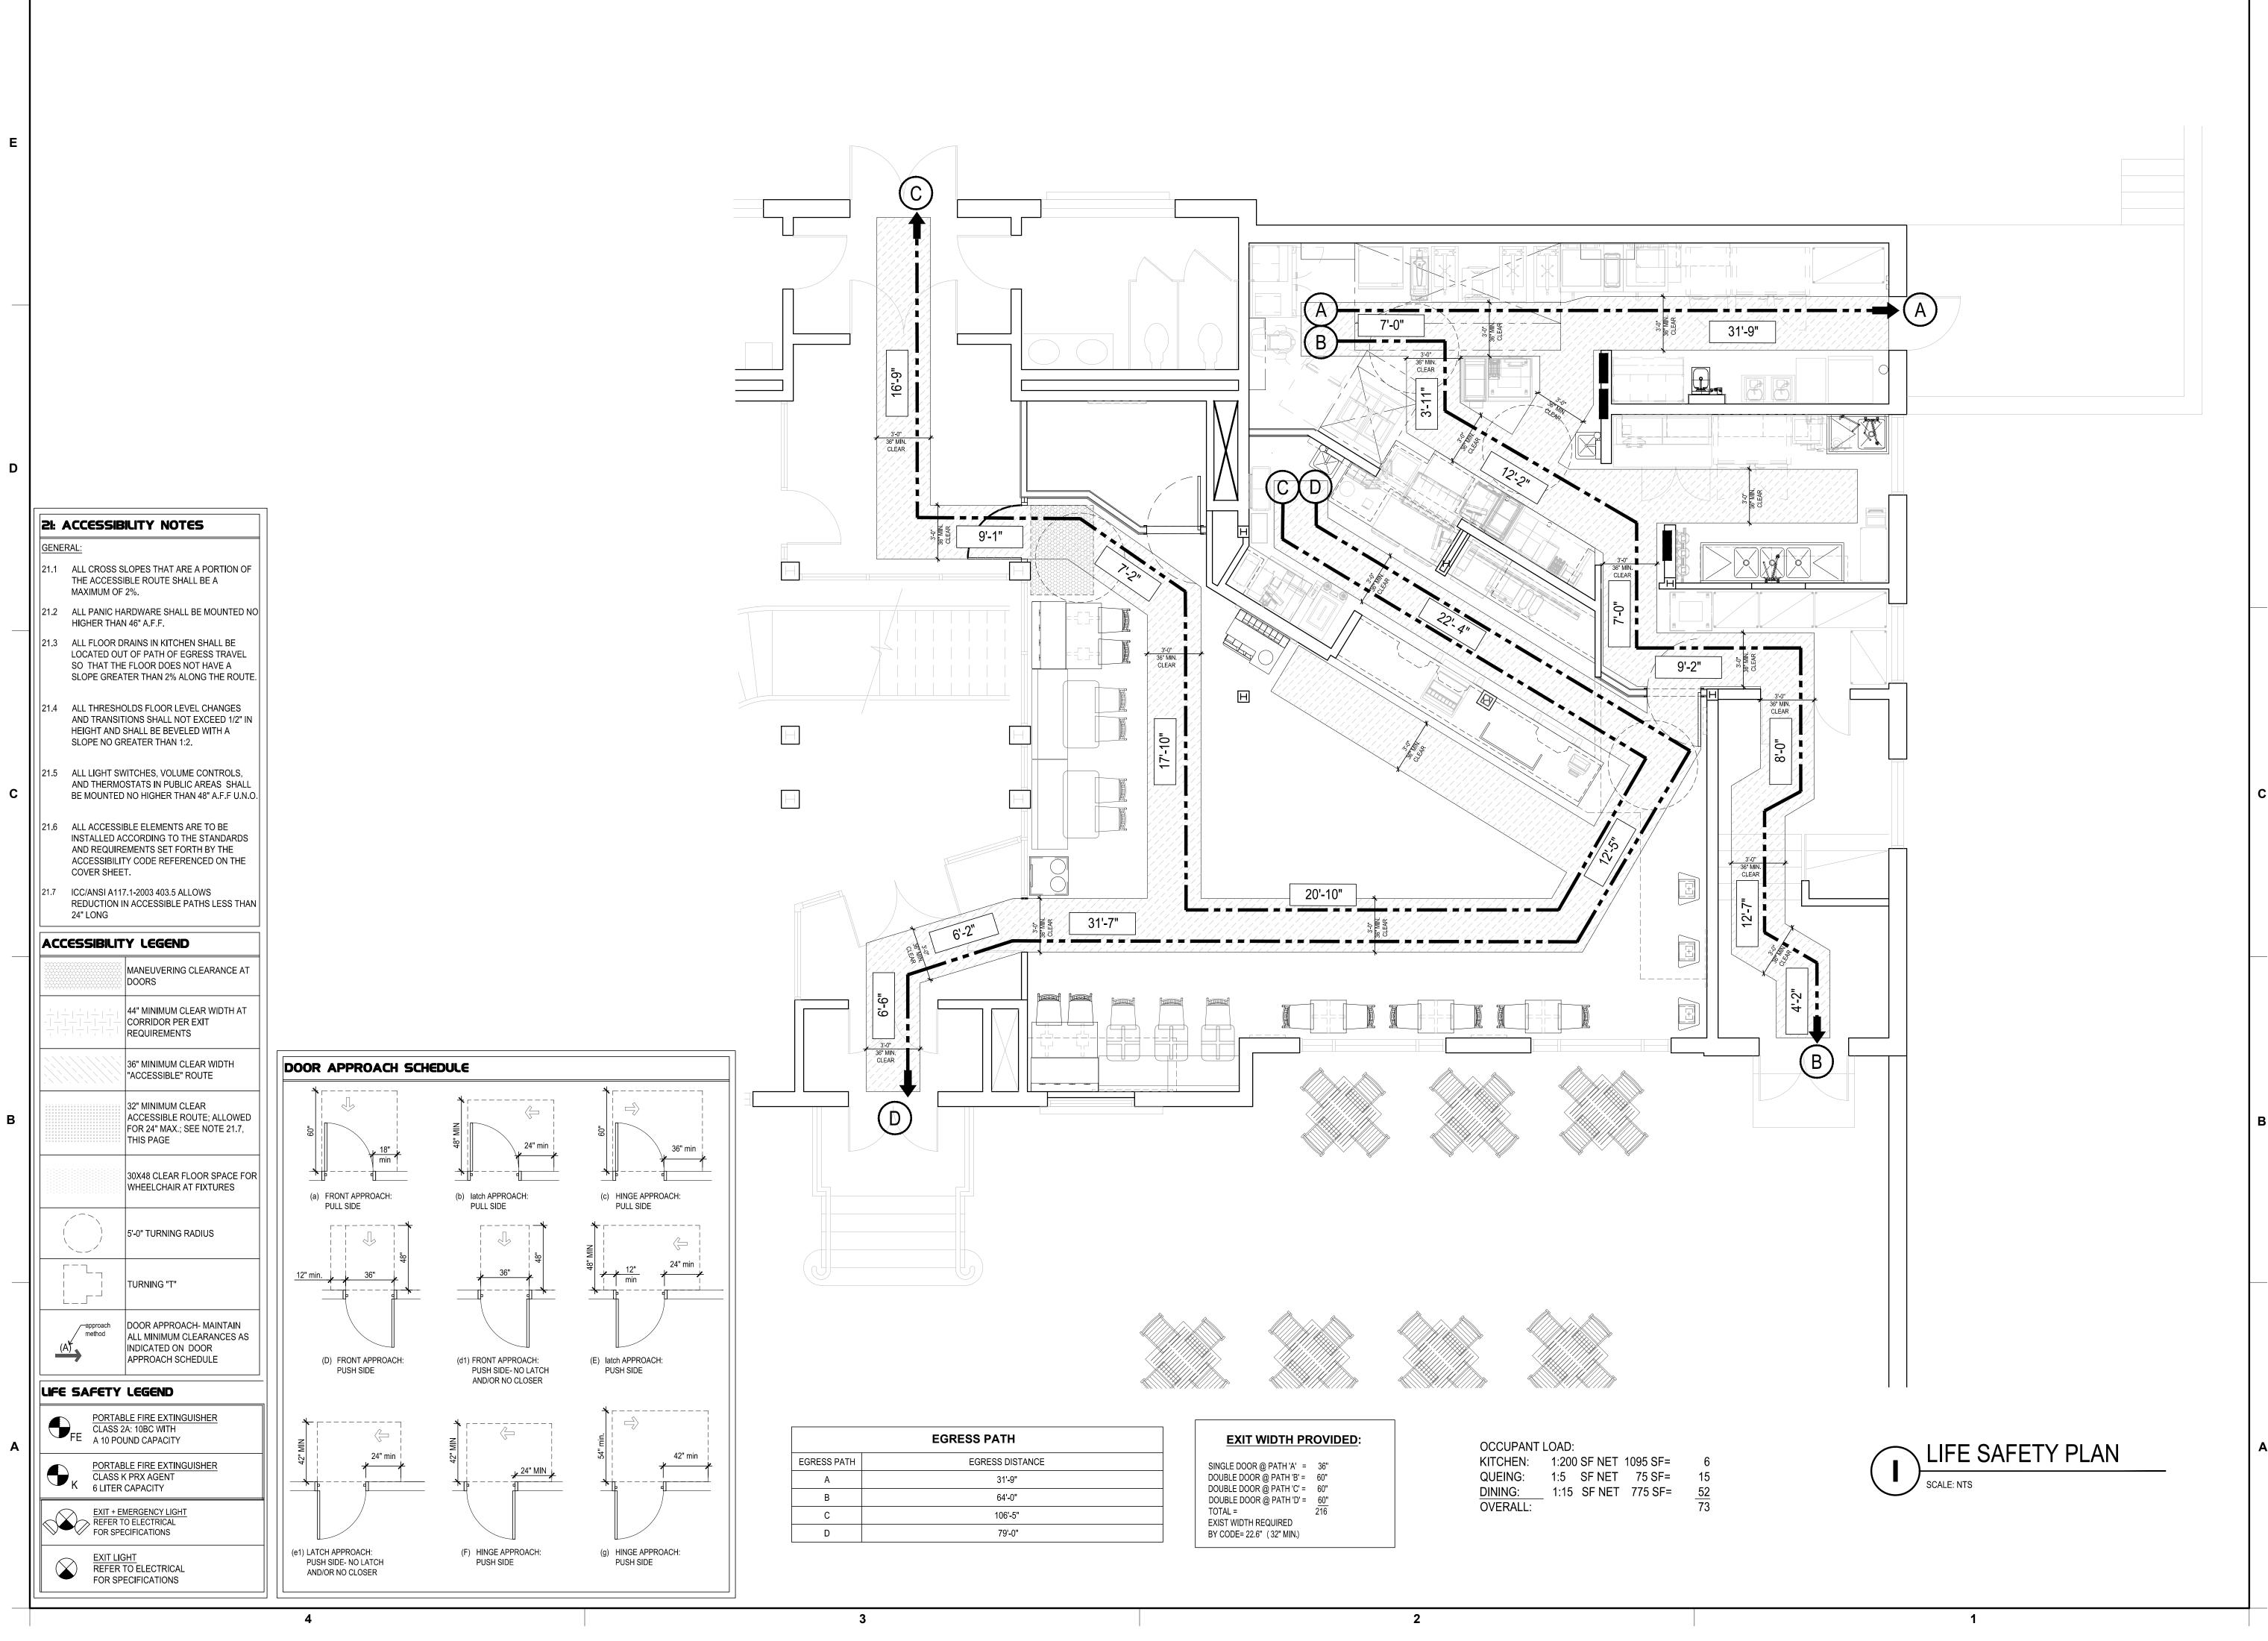







Hill Foley Rossi & Associates
ARCHITECTURE + ENGINEERING
3680 Pleasant Hill Road
Suite 200
Duluth, GA 30096
770.622.9858

© Copyright (as dated below).

This drawing and all reproductions thereof are the property of Hill Foley Rossi & Associates, LLC.(HFR). It is intended for the sole use of the project named hereon. Reproduction without the written consent of HFR is unlawful. All copies are to be returned to HFR upon project completion.

SEALED: 10/25/2023





ICK-FIL-A pbell University Hall

#80419

BUILDING TYPE / SIZE:
RELEASE:
X X X
REVISION SCHEDULE

NO. DATE DESCRIPTION

CONSULTANT PROJECT #	21.554
PRINTED FOR	CD
DATE	10.25.2023
DRAWN BY	RJD
Information contained on this drawing produced for above named project many manner without express written or	ay not be reproduced in

SHEET LIFE SAFETY PLAN

SHEET NUMBER

3-003

	CSI			ACCOL			
WT	DIVISION	VENDOR	CONTACT	PHONE	EXT	EMAIL	REMARKS
RMITE TREATMENT	C02-361	RENTOKIL	JERRY EMMERTON	704-293-1703		JERRY.EMMERTON@RENTOKIL.COM	
RIGATION	C02-810	RAINBIRD	DONN MANN	520-904-1146		DMANN@RAINBIRD.COM	
RICK	C04-810 C04-810	ACME GENERAL SHALE	MIKE HARBISON DAVID GILMORE	706-984-1446 630-962-4000		MHARBISON@BRICK.COM DAVID.GILMORE@GENERALSHALE.COM	PLANT LOCATED IN AUSTIN, TX
RICK RICK	C04-810 C04-810	HC MUDDOX MERIDIAN	DON SACKETT JAKE BRADFOR	720-323-5536 404-694-8538		DON.SACKETT@INTERSTATEBRICK.COM JAKE.BRADFOR@MERIDIANBRICK.COM	PLANT LOCATED IN SACRAMENTO, CA PLANT LOCATED IN BESSEMER, AL
RICK	C04-810 C04-810	MUTUAL MATERIALS REDLAND BRICK	GARY ZAGELOW LUKE OLIVER	800-477-7137 412-828-3956		GZAGELOW@MUTUALMATERIALS.COM LUKE.OLIVER@GLENGERY.COM	PLANT LOCATED IN BESSEMEN, AL PLANT LOCATED IN SPOKAN, WA PLANT LOCATED IN PITTSBURG, PA
KTERIOR METAL	C05-050					JDARK@DURO-LAST.COM	
	C06-170	EXCEPTIONAL METALS	JASON DARK	989-397-7481 877-371-0448		DTHOMPSON@REDBUILT.COM	METAL PARAPET COPING, FASCIA & SOFFIT AT ROOF TOWER
RUCTURAL FRAMING		RED BUILT	DAVID THOMPSON		 EVT 111	CFAORDERS@SKYLARMORGANFURNITURE.CO	
OOD (DECORATIVE)	C06-200	SKYLAR MORGAN	STEPHANIE MORGAN	404-565-0537	EXT. 111	M	,
LLWORK LLWORK	C06-220 C06-220	CLAYTON FIXTURE (CFX) FCC	JASON MOORE MICHELLE GANSKO	404-460-8043 800-322-7328	EXT 235	JASON.MOORE@ACCESSCFA.COM MICHELLE.GANSKO@FCCFURN.COM	FOR ASSISTANCE WITH DRAWINGS: ERIC CRANE (404) 684-8781 WEST REGION
OOD (WAINSCOTING) OOD (WAINSCOTING)	C06-220 C06-220	CLAYTON FIXTURE (CFX) FCC	JASON MOORE MICHELLE GANSKO	404-460-8043 800-322-7328	EXT 235	JASON.MOORE@ACCESSCFA.COM MICHELLE.GANSKO@FCCFURN.COM	FOR ASSISTANCE WITH DRAWINGS: ERIC CRANE (404) 684-8781 WEST, SOUTHWEST, AND MIDWEST REGIONS
DOFING (SINGLE PLY/METAL TRIM)	C07-530	DUROLAST	DAN ERVIN	989-758-1082		DERVIN@DURO-LAST.COM	
UIPMENT STANDS (ROOFTOP)	C07-720	AVCOA	STEVE GILINSON	954-584-6001		STEVE@AVCOAUSA.COM	
P FLUSH / CAGE DOORS	C08-110	SPECIAL-LITE W/ ZIGMAN PRODUCTS	RICK ZIEGLER	770-231-8350		ZIGMANPRODUCTS@YAHOO.COM	
OREFRONT	C08-411	KAWNEER	NORRIS MCELROY	770-235-0240		NORRIS.MCELROY@ARCONIC.COM	ALL REGIONS
OREFRONT		YKK	JAMILLA WALCOTT	678-838-6035		JAMILLAWALCOTT@YKKAP.COM	ALL REGIONS
RIVE-THRU DOOR	C08-460	TORMAX	DESHARA SOTO	210-494-3551		DSOTO@TORMAXUSA.COM	
RIVE-THRU WINDOW	C08-580	QUIK SERV	WADE ARNOLD	713-849-5882		WARNOLD@QUIKSERV.COM	
OORS AND HARDWARE OORS AND HARDWARE	C08-710 C08-710	DH PACE LOCKNET	CHARLES GIRTMAN ROB OWEN	816-221-0543 606-748-2065		CHICKFILADOORS@DHPACE.COM ROBO@LOCKNET.COM	RE: HARDWARE NOTES ON A-800 - MIDWEST, ATLANTIC, NORTHEAST REGION RE: HARDWARE NOTES ON A-800 - WEST, SOUTHWEST, SOUTHEAST REGIONS
ROUT	C09-310	CREATIVE MATERIALS CORPORATION	CRAIG LANSLEY	518-713-5372		CLANSLEY@CREATIVEMATERIALSCORP.COM	ALL REGIONS EXCEPT WEST
ROUT LE	C09-310 C09-310	DALTILE CREATIVE MATERIALS CORPORATION	TERRIE MILLER CRAIG LANSLEY	216-409-3153 518-713-5372		TERRIE.MILLER@DALTILE.COM CLANSLEY@CREATIVEMATERIALSCORP.COM	WEST REGION ONLY ALL REGIONS EXCEPT WEST
LE	C09-310	DALTILE	TERRIE MILLER	216-409-3153		TERRIE.MILLER@DALTILE.COM	WEST REGION ONLY
OORING (PLAYGROUND) OORING (PLAYGROUND)	C09-330 C09-330	PROJECT INNOVATIONS, INC. THE PLAYGROUND GUYS	PETE GRIFFIN ROB PARENT	727-938-4422 772-463-0770		PROJECT.INNOVATIONSPG@GMAIL.COM THEPGGUYS@AOL.COM	ORDER THROUGH SOFT PLAY ORDER THROUGH SOFT PLAY
P PANELS (PLAYGROUND)	C09-330	KOROGARD	MARTHA SMITH	404-771-6773		MSMITH@KOROSEAL.COM	
ILING TILE/GRID	C09-510	CERTAINTEED CORPORATIONS	BERNIE SHALVEY	704-779-7337		BERNARD.G.SHALVEY@SAINT-GOBAIN.COM	
P PANELS (KITCHEN)	C09-770	MARLITE	ANITA CRAIG	330-260-7621		ACRAIG@MARLITE.COM	
NT (INTERIOR)	C09-910	SHERWIN WILLIAMS	MATTHEW HEALD	404-323-2263		MATTHEW.J.HEALD@SHERWIN.COM	
RNER GUARDS	C10-265	KOROGARD	MARTHA SMITH	404-771-6773		MSMITH@KOROSEAL.COM	
TERIOR SIGNS TERIOR SIGNS	C10-420 C10-420	ANCHOR SIGN CHANDLER SIGNS	JOSHUA MUCKELYANEY KRISTEN HAMILTON	843-576-3275 678-725-8852		JMUCKELVANEY@ANCHORSIGN.COM KHAMILTON@CHANDLERSIGNS.COM	SOUTHWEST REGION
TERIOR SIGNS TERIOR SIGNS	C10-420 C10-420	CLAYTON SIGNS NATIONAL SIGN & MARKETNG	TODD WILLIS STEVE ROSENBLOOM	404-361-3800 909-287-7369	EXT. 426	TODDWILLIS@CLAYTONSIGNS.COM SROSENBLOOM@NSMC.COM	WEST REGION
JILDING CANOPY	C10-440	AWNEX INC.	TREY HERNDON	770-704-7140	EXT. 113	TREY@AWNEXINC.COM	MIDWEST AND NORTH EAST REGION
IILDING CANOPY IILDING CANOPY	C10-440 C10-440	CHANDLER SIGNS NATIONAL SIGN & MARKETNG	KRISTEN HAMILTON STEVE ROSENBLOOM	678-725-8852 909-287-7369		KHAMILTON@CHANDLERSIGNS.COM SROSENBLOOM@NSMC.COM	SOUTHWEST REGION WEST REGION
JILDING CANOPY RIVE-THRU ORDER AREA CANOPY (FABRIC)	C10-440 C10-440	UNISTRUCTURES, INC. SUPERIOR INNOVATION, INC.	CAROLYN WARD BRUCE BARKER	678-974-1595 615-410-5463		CHICKFILA@UNISTRUCTURES.COM BRUCE.BARKER@SIIBRANDS.COM	SOUTHEAST AND ATLANTIC REGION ARID CLIMATES ONLY
RIVE-THRU ORDER AREA CANOPY (METAL) RIVE-THRU ORDER AREA CANOPY (METAL)	C10-440 C10-440	FASHION, INC LANE SUPPLY, INC	ALLEN BELL LARRY TOLBERT	785-418-4656 704-545-7615		ABELL@FASHIONINC.COM LTOLBERT@LANESUPPLYINC.COM	NORTHEAST, ATLANTIC, AND SOUTHEAST REGIONS WEST, MIDWEST, AND SOUTHWEST REGIONS
INS EATERS	C10-440 C10-440	TOM BARROW COMPANY/ TPI TOM BARROW COMPANY/SCHWANK	SCOTT GEORGE SCOTT GEORGE	404-351-1010 404-351-1010		SGEORGE@TOMBARROW.COM SGEORGE@TOMBARROW.COM	
RDER POINT & CLEARANCE BAR RDER POINT & CLEARANCE BAR	C10-440 C10-440	CHANDLER SIGNS UNISTRUCTURES, INC.	KRISTEN HAMILTON CAROLYN WARD	678-725-8852 678-974-1595		KHAMILTON@CHANDLERSIGNS.COM CHICKFILA@UNISTRUCTURES.COM	SOUTHWEST REGION
ALL PARTITIONS (BATH)	C10-810	CLAYTON FIXTURE (CFX)	STEVE SAMUELSON	404-684-8783		CHICKFILA@CLAYTONFIXTURE.COM	FOR ASSISTANCE WITH DRAWINGS: ERIC CRANE (404) 684-8781
ALL PARTITIONS (BATH) ALL PARTITIONS (BATH) ALL PARTITIONS (BATH)	C10-810 C10-810	DH PACE FCC	CHARLES GIRTMAN MICHELLE GANSKO	816-221-0543 800-322-7328	EXT 235	CHICKFILADOORS@DHPACE.COM MICHELLE.GANSKO@FCCFURN.COM	TOTASSISTANCE WITT DIAWINGS. ENIC CITAINE (404) 004-0701
ALL PARTITIONS (BATH)	C10-810	LOCKNET	ROB OWEN	606-748-2065	LX1 200	ROBO@LOCKNET.COM	
AYGROUND EQUIPMENT	C10-900	SOFT PLAY	NED O'BRIEN	678-966-9141		N.OBRIEN@COMCAST.NET	ALL REGIONS
QUIPMENT (KITCHEN)	C11-000	STRATEGIC / TRIMARK	MITCH WELCH	404-765-8985	EXT. 3700	MWELCH@STRATEGICEQUIPMENT.COM	
DS SYSTEMS DS WIRING AND SECURITY	C11-020 C11-020	CHICK-FIL-A IT STRONG SECURITY	SCOTT SKIPPER CHRIS VERCH	404-684-8524 678-372-5949		CHRIS.VERCH@STRONGSYSTEM.COM	
DLLER SHADES	C12-500	BB COMMERCIAL	ANGELA CARSWELL	949-404-1140		ANGELA.CARSWELL@GOHFC.COM	<u> </u>
DLLER SHADES	C12-500	CWC GROUP	RICHARD PELL DEANNA MCCOY	949-404-1140 366-413-0394 951-245-5077	EXT. 116	RPELL@COMMERCIALWINDOWCOVERING.COM DEANNA.MCCOY@ROLLASHADE.COM	ADDITIONAL EMAIL : OFFICE@ROLLASHADE.COM
DELER SHADES	C12-500	ROLLASHADE			L\1. 0	JULIA.WOODWARD@CHARTER-HOUSE.COM	SOUTHEAST, SOUTHWEST, MIDWEST, ATLANTIC, AND NORTHEAST REGIONS
FERIOR SEATING/ DECOR FERIOR SEATING/ DECOR	C12-540 C12-540	CHARTER HOUSE INNOVATIONS (CHI) FCC COMMERCIAL FURNITURE	JULIA WOODWARD MICHELLE GANSKO	404-784-2960 800-322-7328	EXT 235	MICHELLE.GANSKO@FCCFURN.COM	(EXCLUDING DEX COUNTERS) WEST REGION (EXCLUDING DEX COUNTERS)
X TABLES & COUNTERS (WHEN REQD.)	C12-540	DEX INDUSTRIES	SHANNON PHILLIPS	404-753-0600		CUSTOMERSERVICE@DEXINDUSTRIES.COM	THE STATE OF THE S
TERIOR SEATING/ UMBRELLAS	C12-570	STRATEGIC / TRIMARK	HAYLEY BOYD	229-903-3678		HAYLEY.BOYD@TRIMARKUSA.COM	<u> </u>
SSAGING (INTERIOR)	C12-610	CHARTER HOUSE INNOVATIONS (CHI)	JULIA WOODWARD	404-784-2960		JULIA.WOODWARD@CHARTER-HOUSE.COM	
SSAGING (INTERIOR) ESSAGING (INTERIOR) EEL WALL FABRICATION	C12-610 C12-610	FCC COMMERCIAL FURNITURE CHARTER HOUSE INNOVATIONS (CHI)	MICHELLE GANSKO JULIA WOODWARD	800-322-7328 404-784-2960	EXT 235	MICHELLE.GANSKO@FCCFURN.COM JULIA.WOODWARD@CHARTER-HOUSE.COM	WEST REGION SOUTHEAST, SOUTHWEST, MIDWEST, ATLANTIC, AND NORTHEAST REGIONS
EEL WALL FABRICATION	C12-610	FCC COMMERCIAL FURNITURE	MICHELLE GANSKO	800-322-7328	EXT 235	MICHELLE.GANSKO@FCCFURN.COM	WEST REGION
JMBING (RESTROOM FIXTURES)	C15-100	HJC DIST. (TOTO, USA)	BARRY BRYANT	800-459-7099		BARRY.BRYANT@HJINC.COM	TOTO VALVES & FIXTURES
P SINK GRATE & TRIM	C15-405	LOWTEMP	ANGIE NORRIS	770-478-8803		ANORRIS@LOWTEMPIND.COM	
DOORS	C15-715	TOM BARROW COMPANY	SCOTT GEORGE	404-351-1010		SGEORGE@TOMBARROW.COM	
AC EQUIPMENT	C15-730	LENNOX NATIONAL ACCOUNTS	TERRY BUCHANAN	678-446-7554		TERRY.BUCHANAN@LENNOXIND.COM	
R DEVICES	C15-836	TOM BARROW COMPANY	SCOTT GEORGE	404-351-1010		SGEORGE@TOMBARROW.COM	
NS & CURBS (EXHAUST) ODS & PIN & SLEEVE BOXES	C15-836 C15-836	TOM BARROW COMPANY HALTON USA	SCOTT GEORGE PHIL MEREDITH	404-351-1010 800-442-5866		SGEORGE@TOMBARROW.COM PHIL.MEREDITH@HALTON.COM	
D AID OTABT COLLASS	C15-836	TOM BARROW COMPANY	SCOTT GEORGE	404-351-1010		SGEORGE@TOMBARROW.COM	
R-AIR START COLLARS ONTROLS	C16-200	SUNCOAST ENVIROMENTAL	JASON COX	877-544-6679		SECONTROLS@AOL.COM	

LICE			RNISHED BY		LED BY	IBILITY MATRIX	
TEM DESCRIPTION	DOES NOT APPLY	EXIST. TO REMAIN	VENDOR NATIONAL ACCOUNT GC/FSP	GC/FSP	VENDOR NATIONAL ACCOUNT	NOTES	
01 GENERAL CONSTRUCTION NEW PARTITIONS			X	Х			
STRUCT. & MISC. STEEL FRAMING GYP. BD CEILING AND SOFFITS			X	X		AS REQUIRED, FOR RTU, MUAU, HOODS	
AY-IN CEILINGS			X	Х		AO DEOLUDED	
ACCESS PANELS (IN CEILING) DOOR AND HARDWARE			X	X		AS REQUIRED	
SECURITY GRILLE PAINTING			X	X			
S.S CORNER GUARDS METAL REVEALS AND TRIM			X	X			
ROOF PENETRATIONS AND PATCHES			X	Х		LANDLORD'S ROOF CONTRACTOR MUST BE USED	
F.R.P PANELING IN KITCHEN WATERPROOF MEMBRANE			X	X			
FIRESTOPPING FLOOR TILE/BASE/GROUT			X	X		ORDER FROM NATIONAL ACCOUNT VENDOR	
WALL TILE/GROUT WAINSCOTING			X	X		ORDER FROM NATIONAL ACCOUNT VENDOR ORDER FROM NATIONAL ACCOUNT VENDOR	
MILLWORK			X X	X		ORDER FROM NATIONAL ACCOUNT VENDOR; SHOP DRAWINGS SHALL BE SUBMITTED FOR APPROVAL	
02 ELECTRICAL							
CONDUIT TO SPACE ELEC. FEEDERS TO SPACE			X	X			
ELEC. PANELS ELEC. DISCONNECT SWITCHES			X	X			
FRANSFORMERS SUB-PANELS			X	X			
DISTRIBUTION			Χ	Х			
FELE. CONDUIT & WIRING FLEC. RECEPTACLES			X	X			
EXIT & EMER LIGHTING LIGHTING FIXTURES			X	X			
BRAND LIGHTING BIGNAGE ELEC. CONNECTIONS			X	X		ORDER FROM NATIONAL ACCOUNT VENDOR	
3 FIRE ALARM/LIFE SAFETY			X				
SMOKE DETECTORS FIRE SPRINKLER SYSTEM			X	X			
SPRINKLER HEAD COVER FINISH STROBE LIGHTS			X	X		FACTORY FINISH TO MATCH CELING	
SYSTEM SPEAKERS			X	Х			
VIRING FOR ALL ABOVE FIRE EXTINGUISHERS			X	X			
SYSTEM DESIGN & PERMIT 04 MECHANICAL SYSTEMS			X	Х			j
IVAC HEATING AND COOLING EQUIPMENT DUCTWORK DISTRIBUTION			X	X		CONFIRM WITH MECH SYSTEM INCLUDING DUCT WRAP/LINER	
DIFFUSERS/RETURNS			X	Х		FACTORY FINISH TO MATCH CELING	
THERMOSTATS CONTROL WIRING			X	X			
DAMPERS EXHAUST FANS			X	X		AS REQUIRED	
MAKE UP AIR UNITS EQUIPMENT SUPPORTS AT ROOF			X	X		CURBS AND/OR PLATFORMS	
KITCHEN EXHAUST SYSTEMS/HOODS			х х	X		CONTRACTOR TO HANG HOODS/INSTALL EXHAUST FANS AND DUCTWORK. ORDER FROM NATIONAL ACCOUNT VENDOR	
D5 PLUMBING SANITARY & VENT LINES			V				
OT & COLD WATER LINES			X	X			
FLOOR SINKS & GRATES HAND SINKS			X	X			
ALL PIPING INSULATION			X	X			
WATER FILTER FOR EQUIP.			X	Х			
GREASE INTERCEPTOR WATER HEATER			X	X			
/EGETABLE PREP SINK DISHWASHING SINK			X	X			
MOP SINK 06 SECURITY & I.T.			Х	Х			
WIRE PULLS DATA WIRES			X	X		PLENUM RATED (IF NO CONDUIT REQ'D)	
JSB/DUPLEX OUTLETS			X	Х		SEE MILLWORK DRAWINGS	
CAMERAS & EQUIPMENT			X	X		TV CONNECTION TO RECEIVERS CONDUIT BY ELEC. CONTRACTOR	
COM BOX 07 P.O.S. SYSTEM/KITCHEN DISPLAY SYSTEM	/SERV	ER STA	X ATION	Х			
CONDUIT POWER/DUPLEX			X	X			
EQUIPMENT			X	Х			
JSER TERMINAL/ POS STATION RECEIPT PRINTERS			X	X			
WIRELESS ACCESS POINT DATA CABLES			X	X			
DIGITAL MENU BOARDS 8 BRAND ELEMENTS			X		Х	ORDER FROM NATIONAL ACCOUNT VENDOR	
SIGNAGE FABLES & CHAIRS			X	X		PART OF EQUIPMENT ORDER FROM NAV ORDER FROM NATIONAL ACCOUNT VENDOR	
CHI SCHEDULE ITEMS			X	X		ORDER FROM NATIONAL ACCOUNT VENDOR ORDER FROM NATIONAL ACCOUNT VENDOR	
PATIO FURNITURE 09 FOOD SERVICE/KITCHEN EQUIPMENT	Х						
CONDENSER PENETRATIONS EQUIP. FINAL CONNECTIONS			X X	X		AS REQUIRED FOR ROOF INSTALL REF. LINES & SYSTEM START-UP	
KITCHEN EQUIPMENT			X	X		GC TO DO FINAL INSTALL AND START-UPS, AFTER EQUIPMENT SET IN PLACE. SEE K SCHEDULE	
TRIMARK SCHEDULED ITEMS			X	Х		GC TO DO FINAL INSTALL AND START-UPS, AFTER EQUIPMENT SET IN PLACE. SEE K SCHEDULE	
I-BOXES AND WIRE PULLS				Х			
WALK-IN BOX & EVAPORATOR WALK-IN CONDENSER				X		UNIT AND WIRING	
WALK-IN FINAL CONNECTIONS WALK-IN CONDENSER SUPPORT				X		REF. PIPING AND SYSTEM START-UP AS REQUIRED FOR ROOF INSTALL	
BEVERAGE SYSTEM	DECE:	NCID.	ITIES	X		THE STATE OF THE PARTY OF THE P	
0 HEALTH DEPARTMENT/FSP OPERATIONS F SANITIZING EQUIPMENT	KESPO		X	Х		ORDER FROM NATIONAL ACCOUNT VENDOR	
FOR KITCHEN SINKS PEST CONTROL CONTRACT			X	X			
=			X	X			ı .







Hill Foley Rossi & Associates
ARCHITECTURE + ENGINEERING
3680 Pleasant Hill Road
Suite 200
Duluth, GA 30096
770.622.9858

© Copyright (as dated below).

This drawing and all reproductions thereof are the property of Hill Foley Rossi & Associates, LLC.(HFR). It is intended for the sole use of the project named hereon. Reproduction without the written consent of HFR is unlawful. All copies are to be returned to HFR upon project completion.

SEALED: 10/25/2023





HCK-FIL-/ mpbell University

#80419

BUILDING TYPE / SIZE: RELEASE:

NO. DATE DESCRIPTION

CONSULTANT PROJECT # 21.554

PRINTED FOR CD

DATE 10.25.2023

DRAWN BY RJD

Information contained on this drawing and in all digital files produced for above named project may not be reproduced in

any manner without express written or verbal consent from authorized project representatives.

SHEET

NATIONAL ACCOUNT AND

RESPONSIBILITY SCHEDULES

SHEET NUMBER

G-004

2018 APPENDIX B BUILDING CODE SUMMARY		STORY DESCRIPTION AND USE BLDG AREA PER TABLE 506.24 AREA FOR FRONTAGE ALLOWABLE AREA PI STORY (ACTUAL) AREA INCREASE ^{1,5} STORY OR UNLIMITED
FOR ALL COMMERCIAL PROJECTS (EXCEPT 1 AND 2-FAMILY DWELLINGS AND TOWNHOUSES)	Gross Building Area: FLOOR EXISTING (SQ NEW (SQ FT) RENO/ALTER SUB-TOTAL	1 Restaurant 1945 sq. ft.
(Reproduce the following data on the building plans sheet 1 or 2)	FT) (SQ.FT) 6 th Floor 5 th Floor	
Name of Project: Chick-fil-A at Campbell University	4 th Floor 3 rd Floor 2 nd Floor	
Address: 85 Main St., Buies Creek, NC Zip Code 27506 Owner/Authorized Agent: Phone # (_770) 622 - 9858 E-Mail _sgermany@hfraa.com	Mezzanine 1st Floor 1945 sq. ft.	Frontage area increases from Section 506.3 are computed thus: a. Perimeter which fronts a public way or open space having 20 feet minimum width = (F)
Owned By: City/County X Private State Code Enforcement Jurisdiction: City_Buies Creek County_Harnett State	Basement TOTAL 1945 sq. ft.	 b. Total Building Perimeter =(P) c. Ratio (F/P) = (F/P) d. W = Minimum width of public way = (W)
CONTACT:	ALLOWABLE AREA	e. Percent of frontage increase $I_f = 100 [F/P - 0.25] \times W/30 = $ (%) Unlimited area applicable under conditions of Section 507.
DESIGNER FIRM NAME LICENSE# TELEPHONE# E-MAIL Architectural Hill Foley Rossi Mike Rossi 15519 (770)407-6902 mrossi@hfraa.com	Primary Occupancy Classification: <u>SELECT ONE</u> Assembly A-1 A-2 A-3 A-4 A-5	 Maximum Building Area = total number of stories in the building x D (maximum 3 stories) (506.2). The maximum area of open parking garages must comply with Table 406.5.4 Frontage increase is based on the unsprinklered area value in Table 506.2.
Civil Not Applicable () Electrical Page Interworks, P.A. Jamie M. Pardue 46047 (336_)667-4225	Business Educational	
Fire Alarm Not Applicable () Plumbing Page Interworks, P.A. Ryan J. Crawford 42587 (336)667-4225 Mechanical Not Applicable ()	Factory F-1 Moderate F-2 Low Hazardous H-1 Detonate H-2 Deflagrate H-3 Combust H-4 Health H-5 HPM Institutional I-1 Condition 1 2	ALLOWABLE HEIGHT ALLOWABLE SHOWN ON PLANS CODE REFERENCE
Sprinkler-Standpipe Not Applicable () Structural Not Applicable ()	1-2 Condition 1	Building Height in Feet (Table 504.3) Building Height in Feet (Table 504.3)
Retaining Walls >5' High Not Applicable () Other Not Applicable () ("Others" should include firms and individuals such as truss, precast, pre-engineered, interior designers, etc.)	☐ 1-4 Mercantile ☐ Residential ☐ R-1 ☐ R-2 ☐ R-3 ☐ R-4	Building Height in Stories (Table 504.4) existing Provide code reference if the "Show on Plans" quantity is not based on Table 504.3 or 504.4.
2018 NC CODE FOR: New Construction Addition X Renovation	Storage S-1 Moderate S-2 Low High-piled Parking Garage Open Enclosed Repair Garage	 The maximum height of air traffic control towers must comply with Table 412.3.1 The maximum height of open parking garages must comply with Table 406.5.4
☐ 1 st Time Interior Completion ☐ Shell/Core	Utility and Miscellaneous Accessory Occupancy Classification(s): Not Applicable	
☐ Phased Construction – Shell/Core ☐ Renovation	Incidental Uses (Table 509): Not Applicable Special Uses (Chapter 4 – List Code Sections) Not Applicable Special Provisions: (Chapter 5 – List Code Sections): Not Applicable	
2018 NC EXISTING BUILDING CODE: Prescriptive Repair Chapter 14 Alteration: Level I Level II Level III	Special Provisions: (Chapter 5 – List Code Sections): Not Applicable Mixed Occupancy: No X Yes Separation: Hr. Exception: X Non-Separated Use (508.3)	
Historic Property Change of Use CONSTRUCTED:(date) N/A ORIGINAL OCCUPANCY(S) (Ch. 3): N/A	The required type of construction for the building shall be determined by applying the height and area limitations for each of the applicable occupancies to the entire building. The most restrictive type of construction, so	
RENOVATED: (date)CURRENT OCCUPANCY(S) (Ch. 3): RISK CATEGORY (table 1604.5) Current: I III III IV	determined, shall apply to the entire building. Separated Use (508.4) - See below for area calculations for each story, the area of the occupancy shall be such that the sum of the	
Proposed: I X II III IV	ratios of the actual floor area of each use divided by the allowable floor area for each use shall not exceed 1. Actual Area of Occupancy A + Actual Area of Occupancy B	
BASIC BUILDING DATA Construction Type: ☐ I-A ☐ II-A ☐ III-A ☐ IV ☐ V-A ☐ V-B ☐ V-B		
Sprinklers: X No Partial Yes X NFPA 13 NFPA 13R NFPA 13D		
Standpipes:		
Special Inspections Required: X No Yes		
2018 NC Administrative Code and Policies Appendix B for Building	2018 NC Administrative Code and Policies Appendix B for Building	2018 NC Administrative Code and Policies Appendix B for Building
2018 NC Administrative Code and Policies Appendix B for Building	2018 NC Administrative Code and Policies Appendix B for Building	2018 NC Administrative Code and Policies Appendix B for Building
2018 NC Administrative Code and Policies Appendix B for Building	2018 NC Administrative Code and Policies Appendix B for Building	2018 NC Administrative Code and Policies Appendix B for Building
2018 NC Administrative Code and Policies Appendix B for Building FIRE PROTECTION REQUIREMENTS BUILDING ELEMENT FIRE RATING DETAIL# DESIGN# DESIGN# DESIGN#		(SECTION 1106) LOT OR PARKING TOTAL # OF PARKING SPACES # OF ACCESSIBLE SPACES PROVIDED TOTAL #
FIRE PROTECTION REQUIREMENTS	LIFE SAFETY SYSTEM REQUIREMENTS	(SECTION 1106)
FIRE PROTECTION REQUIREMENTS BUILDING ELEMENT FIRE RATING DETAIL # DESIGN # FOR SEPARATION REQ'D PROVIDED AND FOR RATED FOR DISTANCE (W/* SHEET # RATED PENETRATION RATED	LIFE SAFETY SYSTEM REQUIREMENTS Emergency Lighting: No X Yes Exit Signs: No X Yes Fire Alarm: No X Yes	(SECTION 1106) LOT OR PARKING TOTAL# OF PARKING SPACES # OF ACCESSIBLE SPACES PROVIDED TOTAL# AREA REQUIRED PROVIDED REGULAR WITH 5' ACCESS AISLE 132" ACCESS 8' ACCESS AISLE AISLE AISLE NA NA NA NA NA NA NA NA NA N
FIRE PROTECTION REQUIREMENTS BUILDING ELEMENT FIRE RATING DETAIL # DESIGN # FOR SEPARATION DISTANCE (FEET) REDUCTION) Structural Frame, FIRE PROTECTION REQUIREMENTS DESIGN # FOR RATED FOR RATED PENETRATION RATED JOINTS	LIFE SAFETY SYSTEM REQUIREMENTS Emergency Lighting: No X Yes Exit Signs: No X Yes	(SECTION 1106) LOT OR PARKING TOTAL # OF PARKING SPACES # OF ACCESSIBLE SPACES PROVIDED TOTAL # ACCESSIBLE PROVIDED PROVIDED REGULAR WITH VAN SPACES WITH ACCESSIBLE PROVIDED AISLE AISLE AISLE
FIRE PROTECTION REQUIREMENTS BUILDING ELEMENT FIRE SEPARATION DISTANCE (FEET) Structural Frame, including columns, girders, trusses Bearing Walls NA NA NA Exterior North East	LIFE SAFETY SYSTEM REQUIREMENTS Emergency Lighting: No X Yes Exit Signs: No X Yes Fire Alarm: No X Yes Smoke Detection Systems: No X Yes Partial Carbon Monoxide Detection: No Yes	(SECTION 1106) LOT OR PARKING TOTAL # OF PARKING SPACES # OF ACCESSIBLE SPACES PROVIDED TOTAL # ACCESSIBLE SPACES WITH VAN SPACES WITH ACCESSIBLE SPACES AISLE TOTAL PLUMBING FIXTURE REQUIREMENTS
FIRE PROTECTION REQUIREMENTS BUILDING ELEMENT FIRE SEPARATION DISTANCE (FEET) Structural Frame, including columns, girders, trusses Bearing Walls NA NA NA NA NA NA NA NA NA N	LIFE SAFETY SYSTEM REQUIREMENTS Emergency Lighting: No X Yes Exit Signs: No X Yes Fire Alarm: No X Yes Smoke Detection Systems: No X Yes Partial Carbon Monoxide Detection: No Yes LIFE SAFETY PLAN REQUIREMENTS Life Safety Plan Sheet #: G-003	(SECTION 1106) LOT OR PARKING TOTAL # OF PARKING SPACES # OF ACCESSIBLE SPACES PROVIDED TOTAL # ACCESSIBLE PROVIDED S'ACCESS AISLE AISLE AISLE AISLE AISLE PROVIDED PROVIDED PROVIDED PROVIDED PROVIDED PROVIDED PROVIDED OTAL # ACCESSIBLE PROVIDED AISLE AISLE AISLE AISLE PROVIDED PROVIDED USE WATERCLOSETS URINALS LAVATORIES SHOWERS DRINKING FOUN
FIRE PROTECTION REQUIREMENTS BUILDING ELEMENT SEPARATION REQ'D PROVIDED * RATED FOR RATED FOR RATED ASSEMBLY SET	LIFE SAFETY SYSTEM REQUIREMENTS Emergency Lighting: No X Yes Exit Signs: No X Yes Fire Alarm: No X Yes Smoke Detection Systems: No X Yes Partial Carbon Monoxide Detection: No Yes LIFE SAFETY PLAN REQUIREMENTS Life Safety Plan Sheet #: G-003	(SECTION 1106) LOT OR PARKING AREA REQUIRED PROVIDED REGULAR WITH S'ACCESSIBLE SPACES WITH S'ACCESS AISLE AISLE AISLE AISLE PROVIDED PROVIDED REGULAR WITH S'ACCESS 8'ACCESS 8'ACCESS AISLE AISLE AISLE NA PLUMBING FIXTURE REQUIREMENTS (TABLE 2902.1) USE WATERCLOSETS URINALS LAVATORIES SHOWERS DRINKING FOUN REGULAR ACCESSIBLE PROVIDED VISE WATERCLOSETS WITH ACCESSIBLE SPACE SHOWERS DRINKING FOUN REGULAR ACCESSIBLE PROVIDED ACCESSIBLE PROVIDED ACCESSIBLE PROVIDED ACCESSIBLE AISLE AISLE ACCESSIBLE PROVIDED ACCESSIBLE PROVIDED ACCESSIBLE PROVIDED ACCESSIBLE PROVIDED ACCESSIBLE PROVIDED ACCESSIBLE PROVIDED AISLE AISLE AISLE ACCESSIBLE PROVIDED ACCESSIBLE SPACES WITH ACCESSIBLE SP
FIRE PROTECTION REQUIREMENTS BUILDING ELEMENT	LIFE SAFETY SYSTEM REQUIREMENTS Emergency Lighting:	(SECTION 1106) LOT OR PARKING TOTAL # OF PARKING SPACES # OF ACCESSIBLE SPACES PROVIDED TOTAL # ACCESSIBLE SPACES WITH STACESS 132" ACCESS AISLE AISLE AISLE AISLE NA PLUMBING FIXTURE REQUIREMENTS (TABLE 2902.1) USE WATERCLOSETS URINALS LAVATORIES SHOWERS DRINKING FOUN MALE FEMALE UNISEX / TUBS REGULAR ACCESSIBLE PROVIDED **TOTAL # ACCESSIBLE SPACES PROVIDED TOTAL # ACCESSIBLE PROVIDED TOTAL # ACCESSIBLE PROVIDED **TOTAL # ACCESSIBLE PROVIDED TOTAL # ACCESSIBLE PROVIDED **TOTAL # ACCESSIBLE PROVIDED **TOTAL # ACCESSIBLE PROVIDED TOTAL # ACCESSIBLE PROVIDED **TOTAL # ACCESSIBLE PROVIDED TOTAL # ACCESSIB
BUILDING ELEMENT SEPARATION DISTANCE (FEET) PROVIDED (W/* RATED DISTANCE (FEET) PROVIDED (F	LIFE SAFETY SYSTEM REQUIREMENTS Emergency Lighting: No Yes Exit Signs: No Yes Fire Alarm: No Yes Smoke Detection Systems: No Yes Partial Carbon Monoxide Detection: No Yes LIFE SAFETY PLAN REQUIREMENTS Life Safety Plan Sheet #: G-003 Fire and/or smoke rated wall locations (Chapter 7) Assumed and real property line locations (if not on the site plan) Exterior wall opening area with respect to distance to assumed property lines (705.8) Occupancy types for each area as it relates to occupant load calculation (Table 1004.1.2) Occupant loads for each area Exit access travel distances (1017) Common path of travel distances (1006.2.1 & 2006.3.2(1))	(SECTION 1106) LOT OR PARKING AREA REQUIRED PROVIDED REGULAR WITH S'ACCESSIBLE SPACES WITH S'ACCESS AISLE AISLE AISLE AISLE PROVIDED PROVIDED REGULAR WITH S'ACCESS 8'ACCESS 8'ACCESS AISLE AISLE AISLE NA PLUMBING FIXTURE REQUIREMENTS (TABLE 2902.1) USE WATERCLOSETS URINALS LAVATORIES SHOWERS DRINKING FOUN REGULAR ACCESSIBLE PROVIDED VISE WATERCLOSETS WITH ACCESSIBLE SPACE SHOWERS DRINKING FOUN REGULAR ACCESSIBLE PROVIDED ACCESSIBLE PROVIDED ACCESSIBLE PROVIDED ACCESSIBLE AISLE AISLE ACCESSIBLE PROVIDED ACCESSIBLE PROVIDED ACCESSIBLE PROVIDED ACCESSIBLE PROVIDED ACCESSIBLE PROVIDED ACCESSIBLE PROVIDED AISLE AISLE AISLE ACCESSIBLE PROVIDED ACCESSIBLE SPACES WITH ACCESSIBLE SP
BUILDING ELEMENT	LIFE SAFETY SYSTEM REQUIREMENTS Emergency Lighting: No X Yes Exit Signs: No X Yes Fire Alarm: No X Yes Smoke Detection Systems: No X Yes Smoke Detection Systems: No X Yes Partial Carbon Monoxide Detection: No Yes LIFE SAFETY PLAN REQUIREMENTS Life Safety Plan Sheet #: G-003 Fire and/or smoke rated wall locations (Chapter 7) Assumed and real property line locations (if not on the site plan) Exterior wall opening area with respect to distance to assumed property lines (705.8) Coccupant loads for each area as it relates to occupant load calculation (Table 1004.1.2) Coccupant loads for each area Exit access travel distances (1017) Common path of travel distances (1006.2.1 & 2006.3.2(1)) Dead end lengths (1020.4) Clear exit widths for each exit door	(SECTION 1106) LOT OR PARKING AREA REQUIRED PROVIDED REGULAR WITH VAN SPACES WITH ACCESSIBLE S'ACCESS AISLE AISLE AISLE AISLE AISLE PROVIDED PROVIDED REGULAR WITH VAN SPACES WITH ACCESSIBLE PROVIDED AISLE AISLE AISLE PROVIDED PROVIDED AISLE AISLE AISLE PROVIDED AISLE
FIRE PROTECTION REQUIREMENTS BUILDING ELEMENT FIRE RATING PROVIDED AND SHEET # AND AND SHEET # ASSEMBLY FOR PROTECTION SHEET # AND ASSEMBLY STRUCTURE STRUCTU	LIFE SAFETY SYSTEM REQUIREMENTS Emergency Lighting:	(SECTION 1106) LOT OR PARKING TOTAL # OF PARKING SPACES # OF ACCESSIBLE SPACES PROVIDED ACCESSIBLE SPACES WITH VAN SPACES WITH VAN SPACES WITH ACCESSIBLE PROVIDED ASSET ASSE
FIRE PROTECTION REQUIREMENTS BUILDING ELEMENT	LIFE SAFETY SYSTEM REQUIREMENTS Emergency Lighting: No X Yes Exit Signs: No X Yes Fire Alarm: No X Yes Smoke Detection Systems: No X Yes Smoke Detection Systems: No X Yes Partial	(SECTION 1106) LOT OR PARKING TOTAL # OF PARKING SPACES # OF ACCESSIBLE SPACES PROVIDED ACCESSIBLE SPACES WITH ACCESSIBLE SPROVIDED AISLE AISLE AISLE AISLE NA
FIRE PROTECTION REQUIREMENTS BUILDING ELEMENT SEPARATION REQ'D REQ'D PROVIDED SIGN FOR POR PORT RATED STANCE (FEET) SEPARATION REQ'D REQ'D SHEET ASSEMBLY STRUCTURE Frame, including columns, girders, trusses Bearing Walls NA NA Reg'D REQ'D REQUIREMENT SHEET ASSEMBLY SHEET ASSEMBLY SHEET BESIGN FOR RATED FOR RATED ASSEMBLY FOR RATED ASSEMBLY FOR RATED ASSEMBLY FOR RATED SHEET BOUNTS IN STRUCTURE FROM THE PROVIDED SHEET ASSEMBLY FOR RATED ASSEMBLY FOR RATED ASSEMBLY FOR RAT	LIFE SAFETY SYSTEM REQUIREMENTS Emergency Lighting:	(SECTION 1106) LOT OR PARKING TOTAL # OF PARKING SPACES # OF ACCESSIBLE SPACES PROVIDED ACCESSIBLE SPACES WITH ACCESSIBLE SPROVIDED AISLE AISLE AISLE AISLE NA
FIRE PROTECTION REQUIREMENTS BUILDING ELEMENT	LIFE SAFETY SYSTEM REQUIREMENTS Emergency Lighting: No Yes Yes No Yes Yes Fire Alarm: No Yes Yes Smoke Detection Systems: No Yes Partial Carbon Monoxide Detection: No Yes Partial LIFE SAFETY PLAN REQUIREMENTS Life Safety Plan Sheet #: G-003 Fire and/or smoke rated wall locations (Chapter 7) Assumed and real property line locations (if not on the site plan) Exterior wall opening area with respect to distance to assumed property lines (705.8) Occupancy types for each area as it relates to occupant load calculation (Table 1004.1.2) Occupant loads for each area Exit access travel distances (1017) Common path of travel distances (1006.2.1 & 2006.3.2(1)) Dead end lengths (1020.4) Clear exit widths for each exit door Maximum calculated occupant load capacity each exit door can accommodate based on egress width (1005.3) Actual occupant load for each exit door A separate schematic plan indicating where fire rated floor/ceiling and/or roof structure is provided for purposes of occupancy separation and supporting construction for a fire barrier/fire partition/smoke barrier. Location of doors with panic hardware (1010.1.10) Location of doors with planic hardware (1010.1.10) Location of doors with delayed ggress locks and the amount of delay (1010.1.9.7) Location of doors equipped with hold-open devices Location of each fire area (202)	(SECTION 1106) LOT OR PARKING TOTAL # OF PARKING SPACES # OF ACCESSIBLE SPACES PROVIDED ACCESSIBLE SPACES WITH ACCESSIBLE SPROVIDED AISLE AISLE AISLE AISLE NA
BUILDING ELEMENT FIRE SEPARATION DESIGN # FOR SEPARATION DESIGN # FOR STREET SEPARATION DESIGN # FOR STREET SEPARATION DESIGN # FOR STREET SEPARATION STRUCTURES STRUCTURES STRUCTURES SEPARATION SERVICE SEPARATION SERVICE SEPARATION SERVICE	LIFE SAFETY SYSTEM REQUIREMENTS Emergency Lighting:	(SECTION 1106) LOT OR PARKING TOTAL # OF PARKING SPACES # OF ACCESSIBLE SPACES PROVIDED TOTAL # ACCESSIBLE SPACES NOTH ACCESSIBLE ACCESS BY ACCESS ALSLE AL
RELIDING ELEMENT	LIFE SAFETY SYSTEM REQUIREMENTS Emergency Lighting:	(SECTION 1106) LOT OR PARKING TOTAL # OF PARKING SPACES # OF ACCESSIBLE SPACES PROVIDED ACCESSIBLE SPACES WITH ACCESSIBLE SPROVIDED AISLE AISLE AISLE AISLE NA
BUILDING ELEMENT SEPARATION REQUIREMENTS FIRE SEPARATION REQUIREMENTS SEPARATION REQUIREMENTS SEPARATION REQUIREMENTS SETURE PROVIDED (W	LIFE SAFETY SYSTEM REQUIREMENTS Emergency Lighting:	(SECTION 1106) LOT OR PARKING TOTAL # OF PARKING SPACES # OF ACCESSIBLE SPACES PROVIDED ACCESSIBLE SPACES WITH ACCESSIBLE SPROVIDED AISLE AISLE AISLE AISLE NA
BUILDING ELEMENT FIRE SEPARATION REQUIREMENTS	LIFE SAFETY SYSTEM REQUIREMENTS	(SECTION 1106) LOT OR PARKING TOTAL # OF PARKING SPACES # OF ACCESSIBLE SPACES PROVIDED ACCESSIBLE SPACES WITH ACCESSIBLE SPROVIDED AISLE AISLE AISLE AISLE NA
FIRE PROTECTION REQUIREMENTS DUILDING PROPERTY PRO	LIFE SAFETY SYSTEM REQUIREMENTS Emergency Lighting:	(SECTION 1106) LOT OR PARKING TOTAL # OF PARKING SPACES # OF ACCESSIBLE SPACES PROVIDED TOTAL # ACCESSIBLE SPACES NOTH ACCESSIBLE ACCESS BY ACCESS ALSLE AL
FIRE PROTECTION REQUIREMENTS MULLIPING ELEMENT FIRE RATING BOYDED DESIGN # FOR SHEET # AND FOR SHEET # ASSEMBLY DISTRATION RATIDD JOINTS	LIFE SAFETY SYSTEM REQUIREMENTS	(SECTION 1106) LOT OR PARKING TOTAL # OF PARKING SPACES # OF ACCESSIBLE SPACES PROVIDED ACCESSIBLE SPACES WITH ACCESSIBLE SPROVIDED AISLE AISLE AISLE AISLE NA
BULLINING ELEMINY SIPRALTION SIPRALTION SIPRALTION OBSTANCE (PET) SIGNATION OBSTANCE (PET) SIGNATION OBSTANCE (PET) SIPRALTION OBSTANCE (PET) SIPRALTION OBSTANCE (PET) SIPRALTION OBSTANCE (PET) SIPRALTION OBSTANCE REPUCTION) SHEET # SASEMBLY FENETRATION OBSTANCE REPUCTION) SHEET # SASEMBLY FENETRATION OBSTANCE REPUCTION) SHEET # SASEMBLY FENETRATION OBSTANCE OBSTANCE OBSTANCE REPUCTION) SHEET # SASEMBLY FENETRATION OBSTANCE OB	LIFE SAFETY SYSTEM REQUIREMENTS	(SECTION 1106) LOT OR PARKING TOTAL # OF PARKING SPACES # OF ACCESSIBLE SPACES PROVIDED ACCESSIBLE SPACES WITH ACCESSIBLE AISLE AIS








Hill Foley Rossi & Associates
ARCHITECTURE + ENGINEERING
3680 Pleasant Hill Road
Suite 200
Duluth, GA 30096
770.622.9858

© Copyright (as dated below).

This drawing and all reproductions thereof are the property of Hill Foley Rossi & Associates, LLC.(HFR). It is intended for the sole use of the project named hereon. Reproduction without the written consent of HFR is unlawful. All copies are to be returned to HFR upon project completion.

SEALED: 10/25/2023

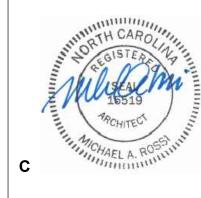



27506

K-FIL-A ell University

Britt Hall
85 Main St

#8041
BUILDING TYPE / SIZE:

RELEASE:

REVISION SCHEDULE

REVISION SCHEDULE

NO. DATE DESCRIPTION

CONSULTANT PROJECT # 21.554

PRINTED FOR CD

DATE 10.25.2023

DRAWN BY

Information contained on this drawing and in all digital files produced for above named project may not be reproduced in any manner without express written or verbal consent from authorized project representatives.

SHEET

APPENDIX B

SHEET NUMBER

G-005

2018 APPENDIX B **ENERGY SUMMARY** MECHANICAL DESIGN **ENERGY REQUIREMENTS:** The following data shall be considered minimum and any special attribute required to meet the North Carolina Energy 2018 APPENDIX B Conservation Code shall also be provided. Each Designer shall furnish the required portions of the project information for BUILDING CODE SUMMARY FOR ALL COMMERCIAL PROJECTS MECHANICAL SUMMARY the plan data sheet. If performance method, state the annual energy cost for the standard reference design vs annual energy STRUCTURAL DESIGN cost for the proposed design. (PROVIDE ON THE STRUCTURAL SHEETS IF APPLICABLE) MECHANICAL SYSTEMS, SERVICE SYSTEMS AND EQUIPMENT Existing building envelope complies with code:
No X Yes (The remainder of this section is not applicable) Thermal Zone **DESIGN LOADS:** Exempt Building: No Yes (Provide Code or Statutory reference): winter dry bulb: summer dry bulb: Climate Zone: 3A 4A 5A Seismic (I_E) **Interior design conditions** Method of Compliance: Energy Code Performance Prescriptive winter dry bulb: ASHRAE 90.1 Performance ☐ Prescriptive summer dry bulb: (If "Other" specify source here) relative humidity: THERMAL ENVELOPE (Prescriptive method only) **Building heating load: Ground Snow Load:** Roof/ceiling Assembly (each assembly) Description of assembly: U-Value of total assembly: R-Value of insulation: Skylights in each assembly: Provide the following Seisn Site Classification (2 Size category. If oversized, state reason.: Data Source: Bearing Wall Dual w/Special Moment Frame Basic structural system Size category. If oversized, state reason.: Building Frame Dual w/Intermediate R/C or Special Steel ☐ Moment Frame ☐ Inverted Pendulum List equipment efficiencies: U-Value of assembly: Simplified **Analysis Procedure:** ☐ Equivalent Lateral Force ☐ Dynamic Solar heat gain coefficient: Architectural, Mechanical, Components anchored? Yes No Projection factor: LATERAL DESIGN CONTROL: Earthquake Wind Wind Door R-Values: **SOIL BEARING CAPACITIES:** Walls below grade (each assembly) Field Test (provide copy of test report) Not Available Description of assembly: Presumptive Bearing capacity _____ Not Applicable U-Value of total assembly: Pile size, type, and capacity

Not Applicable R-Value of insulation: Floors over unconditioned space (each assembly) Description of assembly: U-Value of total assembly: R-Value of insulation: Floors slab on grade Description of assembly: U-Value of total assembly: R-Value of insulation: Horizontal/Vertical requirement: Slab Heated: 2018 NC Administrative Code and Policies 2018 NC Administrative Code and Policies Appendix B for Building 2018 NC Administrative Code and Policies Appendix B for Building 2018 APPENDIX B BUILDING CODE SUMMARY FOR ALL COMMERCIAL PROJECTS ELECTRICAL DESIGN (PROVIDE ON THE ELECTRICAL SHEETS IF APPLICABLE) ELECTRICAL SUMMARY ELECTRICAL SYSTEM AND EQUIPMENT **Method of Compliance:** Energy Code: Prescriptive Performance total exterior wattage specified vs. allowed Additional Efficiency Package Options (When using the 2018 NCECC; not required for ASHRAE 90.1) C406.2 More Efficient Mechanical Equipment C406.3 Reduced Lighting Power Density C406.4 Enhanced Digital Lighting Controls C406.5 On-Site Renewable Energy C406.6 Dedicated Outdoor Air System C406.7 Reduced Energy Use in Service Water Heating

D

2018 NC Administrative Code and Policies

Appendix B for Building

BUILDING CODE SUMMARY FOR ALL COMMERCIAL PROJECTS

(PROVIDE ON THE MECHANICL SHEETS IF APPLICABLE)

Appendix B for Building



Chick-fil-A **5200 Buffington Road** Atlanta, Georgia 30349-2998



Hill Foley Rossi & Associates ARCHITECTURE + ENGINEERING 3680 Pleasant Hill Road Suite 200 Duluth, GA 30096 770.622.9858

© Copyright (as dated below). This drawing and all reproductions thereof are the property of Hill Foley Rossi & Associates, LLC.(HFR). It is intended for the sole use of the project named hereon. Reproduction without the written consent of HFR is unlawful. All copies are to be returned to HFR upon project completion. SEALED: 10/25/2023





206

2

C

BUILDING TYPE / SIZE:

RELEASE:

REVISION SCHEDULE NO. DATE DESCRIPTION

CONSULTANT PROJECT # 21.554 PRINTED FOR CD DATE 10.25.2023

Information contained on this drawing and in all digital files produced for above named project may not be reproduced in any manner without express written or verbal consent from authorized project representatives.

APPENDIX B


SHEET NUMBER

GENERAL NOTES 1.4 IT SHALL BE THE RESPONSIBILITY OF PRIOR TO START OF CONSTRUCTION, GENERAL CONTRACTORS AND SUBCONTRACTOR/TRADE TO COORDINATE SUBCONTRACTORS SHALL VISIT THE SITE TO WITH THE OTHER SUBCONTRACTORS/TRADES. FIELD VERIFY EXISTING CONDITIONS WITH FAILURE TO DO SO, WILL NOT CONSTITUTE RESPECT TO THE CONSTRUCTION DOCUMENTS. GROUNDS FOR A CHANGE ORDER. EXISTING CONDITIONS INCLUDE BUT ARE NOT GENERAL CONTRACTOR TO PATCH AND LIMITED TO LOCATIONS (DIMENSIONS BOTH REPAIR TO "LIKE NEW" ANY AREA THAT IS VERTICALLY AND HORIZONTALLY), SIZES, AND DISTURBED DURING DEMOLITION AND CONSTRUCTION MAKE-UP OF : CONSTRUCTION. STRUCTURAL COLUMNS AND JOISTS AS NECESSARY, THE CONTRACTOR SHALL DEMISING WALLS PROVIDE ADEQUATE BRACING AND SHORING ALL UTILITIES G.C. IS TO NOTIFY ARCHITECT AND PROJECT FOR ALL WORK DURING THE CONSTRUCTION MANAGER IF ANY DIMENSIONS DO NOT MATCH THOSE SHOWN OR IF THERE ARE ANY COORDINATE REUSE, RELOCATION, OR DISCREPANCIES OR CONFLICTS WITH THE DISPOSAL OF EXISTING EQUIPMENT WITH CONSTRUCTION DRAWINGS AS SOON AS PROJECT AND FACILITIES MANAGERS AND POSSIBLE. KITCHEN SHEETS. WHERE EQUIPMENT IS TO BE RELOCATED OR REUSED, EQUIPMENT IS TO 2 ALL WORK SHALL BE IN COMPLIANCE WITH BE CLEANED TO "LIKE NEW" CONDITION AND RECOGNIZED INDUSTRY STANDARDS, STORED UNTIL REINSTALLATION. CRAFTSMANSHIP STANDARDS, MANUFACTURERS RECOMMENDATIONS AND ALL MATERIALS ARE TO BE NEW UNLESS ALL OTHER APPLICABLE CODES. THE OTHERWISE NOTED. ARCHITECT DOES NOT GUARANTEE THE 1.9 PROVIDE SEPARATION BETWEEN ALL PERFORMANCE OF THE PROJECT IN ANY DISSIMILAR METALS INCLUDING SCREWS, NAILS RESPECT OTHER THAN THAT OUR AND OTHER FASTENING DEVICES. ARCHITECTURAL WORK AND JUDGMENT RENDERED MEET THE STANDARDS OF CARE 1.10 WHERE MATERIAL FASTENERS ARE NOT OF OUR PROFESSION. INDICATED, PROVIDE AS SPECIFIED BY THE MATERIAL MANUFACTURER'S THE CONTRACTOR SHALL BE RESPONSIBLE RECOMMENDATIONS AND PROCEDURES. FOR BUILDING THIS PROJECT IN ACCORDANCE PER VUSBC 906.1, DURING DEMOLITION AND WITH THE DRAWINGS AND SPECIFICATIONS CONSTRUCTION, NO LESS THAN ONE (I) UNLESS A WRITTEN NOTIFICATION FROM THE APPROVED PORTABLE FIRE EXTINGUISHER OWNER OR ARCHITECT TO THE CONTRARY IS SHALL BE PRESENT ON SITE. RECEIVED. DEMOLITION NOTES COORDINATE ALL DEMOLITION WITH 2.5 GENERAL CONTRACTOR SHALL MANAGE FACILITIES MANAGEMENT CONSTRUCTION DEBRIS AND GNERAL ALL DEMOLITION WORK TO COMPLY WITH CONSTRUCTION WASTE IN ACCORDANCE CONSTRUCTION PROCEDURES AND WITH THE ASSOCIATED STANDARD REGULATIONS AS SET FORTH BY LOCATION IN OPERATING PROCEDURES ON TEH WHICH WORK IS BEING DONE. ENVIRONMENTAL RESOURCES WEBSITE. 2.2 COVER RETURN AIR DUCTS AS NECESSARY GENERAL CONTRACTOR TO REMOVE AND/OR BEFORE AND DURING CONSTRUCTION. RELOCATE ANY FIRE EQUIPMENT AS 2.3 DO NOT ABANDON ANY UTILITIES WITHIN NECESSARY TO SATISFY LOCAL SPACE. REMOVE ALL UTILITIES CONNECTED JURISDICTION FOR LENGTH OF DEMOLITION TO ITEMS TO BE DEMOLISHED UNLESS AND CONSTRUCTION PROCESS. OTHERWISE NOTED. COORDINATE WITH FIELD LIQUID WASTE MUST NOT BE DISPOSED OF IN CONDITIONS AND PROJECT AND FACILITY GENERAL TRASH, THE GROUND, OR IN THE MANAGERS. STORM SEWER. 2.8 ONLY EPA CERTIFIED TECHNICIANS WILL BE 2.4 CAP AND SEAL OFF ANY PLUMBING ALLOWED TO MAINTAIN, SERVICE, REPAIR, PENETRATIONS AS NECESSARY. DO NOT AND DISPOSE OF EQUIPMENT CONTAINING ABANDON ANY UTILITIES OR MATERIALS REFRIGERANT. TECHNICIANS MUST FOLLOW WITHIN SPACE - REMOVE BACK TO THE THE REQUIRED PRACTICES PERTAINING TO SOURCE. MAINTENANCE, REPAIR, AND DISPOSAL OF REFRIGERATION AND AIR CONDITIONING EQUIPMENT PROCIDED IN 40 CFR 82 SUBPART F ON REFRIGERANT AND EMISSIONS REDUCTIONS. KEY NOTES - DEMOLITION PLAN ALL EXISTING EQUIPMENT TO BE REMOVED II EXISTING HOOD / MECHANICAL UNIT ABOVE TO REMAIN, MODIFY ANSUL HEADS AS DURING DEMOLITION. EQUIPMENT NUMBERED IS INTENDED FOR REUSE, STORE DURING REQUIRED PER EQUIPMENT PLAN. CLEAN & DEMOLITION AND CONSTRUCTION, CLEAN TO SERVICE AS NECESSARY TO "LIKE NEW" "LIKE NEW" CONDITION. WHERE REMOVED CONDITION. PROTECT DURING DEMOLITION OR RELOCATED, REMOVE ASSOCIATED AND CONSTRUCTION ELECTRICAL BACK TO SOURCE U.N.O. 12 EXISTING LIGHT FIXTURES ABOVE TO ALL HVAC DIFFUSERS TO BE REUSED. REMAIN U.NO., RE-LAMP AS NECESSARY TO REMOVE DURING DEMOLITION, REPLACE IN RETURN TO "LIKE NEW" CONDITION NEW LOCATION DURING CONSTRUCTION. EXISTING FLOOR DRAINS AND SINKS TO 13 REMOVE "EXPRESS" FROM EXISTING SIGN, REMAIN UNLESS NOTED OTHERWISE. REFER PATCH AND REPAIR FINISHES WHERE ALSO TO PLUMBING SHEETS FOR RELOCATED AND NEW UNITS ALL EXISTING LIGHTING TO BE REUSED. 14 EXISTING MILLWORK CURB AND CABINETRY REMOVE DURING DEMOLITION, REPLACE IN TO BE REMOVED, PROTECT EXISTING NEW LOCATION DURING CONSTRUCTION. COUNTERTOP ABOVE, PREPARE FLOORING PLAN NOTES: VOID AND ADJACENT CABINETRY TO RECEIVE NEW FINISHES EXISTING COLUMN TO REMAIN, PROTECT 15 EXISTING ELECTRICAL PANEL TO REMAIN DURING DEMOLITION AND CONSTRUCTION. G.C. TO VERIFY SIZE AND LOCATION PRIOR 6 EXISTING ANSUL CABINET / PULL TO REMAIN TO START OF CONSTRUCTION, NOTIFY ARCHITECT AND PROJECT AND FACILITIES 17 EXISTING STOREFRONT SYSTEM TO BE MANAGERS OF ANY DISCREPANCIES REMOVED, PREPARE FOR NEW WALL / 2 EXISTING WALL TO REMAIN, PROTECT STOREFRONT, REFER ALSO TO FLOOR PLAN DURING DEMOLITION AND CONSTRUCTION. PATCH AND REPAIR AS NECESSARY TO 18 REMOVE EXISTING FLOORING FINISH AND RETURN TO "LIKE NEW" CONDITION PREPARE FOR NEW FLOORING FINISH, REFER ALSO TO FINISH PLAN 3 EXISTING WALL TO BE REMOVED TO EXTENTS SHOWN, PROTECT ALL OTHER 19 REMOVE EXISTING CEILING FINISH IN AREA WALLS DURING DEMOLITION INDICATED, PREPARE FOR NEW CEILING 4 EXISTING FINISHES TO BE REMOVED, G.C. TO CONFIRM SUBSTRATE FOR NEW FINISH INSTALLATION, REPLACE AS NECESSARY TO | 20 REMOVE EXISTING DOOR, COORDINATE MATCH CALL OUT ON FINISH PLAN. DISPOSAL WITH FACILITIES MANAGEMENT 21 REMOVE NOTED FIXTURE, PATCH AND 5 EXISTING STAINLESS STEEL PANELS TO REPAIR CEILING FINISH AS NEEDED REMAIN. PROVIDE NEW STAINLESS STEEL END-CAPS AND CORNER TRIM PIECES THAT RUN CONTINUOUSLY FROM THE TOP OF 22 RELOCATE EXISTING WALL-MOUNTED PICKUP SIGN, PATCH & REPAIR FINISHES WALL BASE TO THE CEILING. REMOVE AND WHERE REMOVED, SEE A-201 FOR NEW REPLACE ANY DAMAGED WITH NEW PIECES. 6 EXISTING MILLWORK TO REMAIN U.N.O., 23 EXISTING MILLWORK CURB AND CABINETRY PATCH AND REPAIR LAMINATES, BASE TILE, TO BE REMOVED, PREPARE FLOORING VOID AND TRIMS TO RETURN TO "LIKE NEW" AND ADJACENT CABINETRY TO RECEIVE CONDITION NEW FINISHES 7 EXISTING DOOR TO REMAIN, PROTECT 24 EXISTING COUNTER TO BE REMOVED, REFER DURING DEMOLITION AND CONSTRUCTION ALSO TO MILLWORK PAGES 8 EXISTING FLOOR SINK & FLOOR DRAIN TO REMAIN, CLEAN PLUMBING LINE, PROTECT DURING DEMOLITION AND CONSTRUCTION EXISTING PLUMBING FIXTURE TO REMAIN, PROTECT DURING DEMOLITION AND CONSTRUCTION, CLEAN TO "LIKE NEW" CONDITION

O REMOVE / RELOCATE EXISTING SEATING AND ASSOCIATED ELEMENTS, REFER ALSO TO

F-20I, COORDINATE RELEVANT DISPOSAL

WITH FACILITIES MANAGEMENT

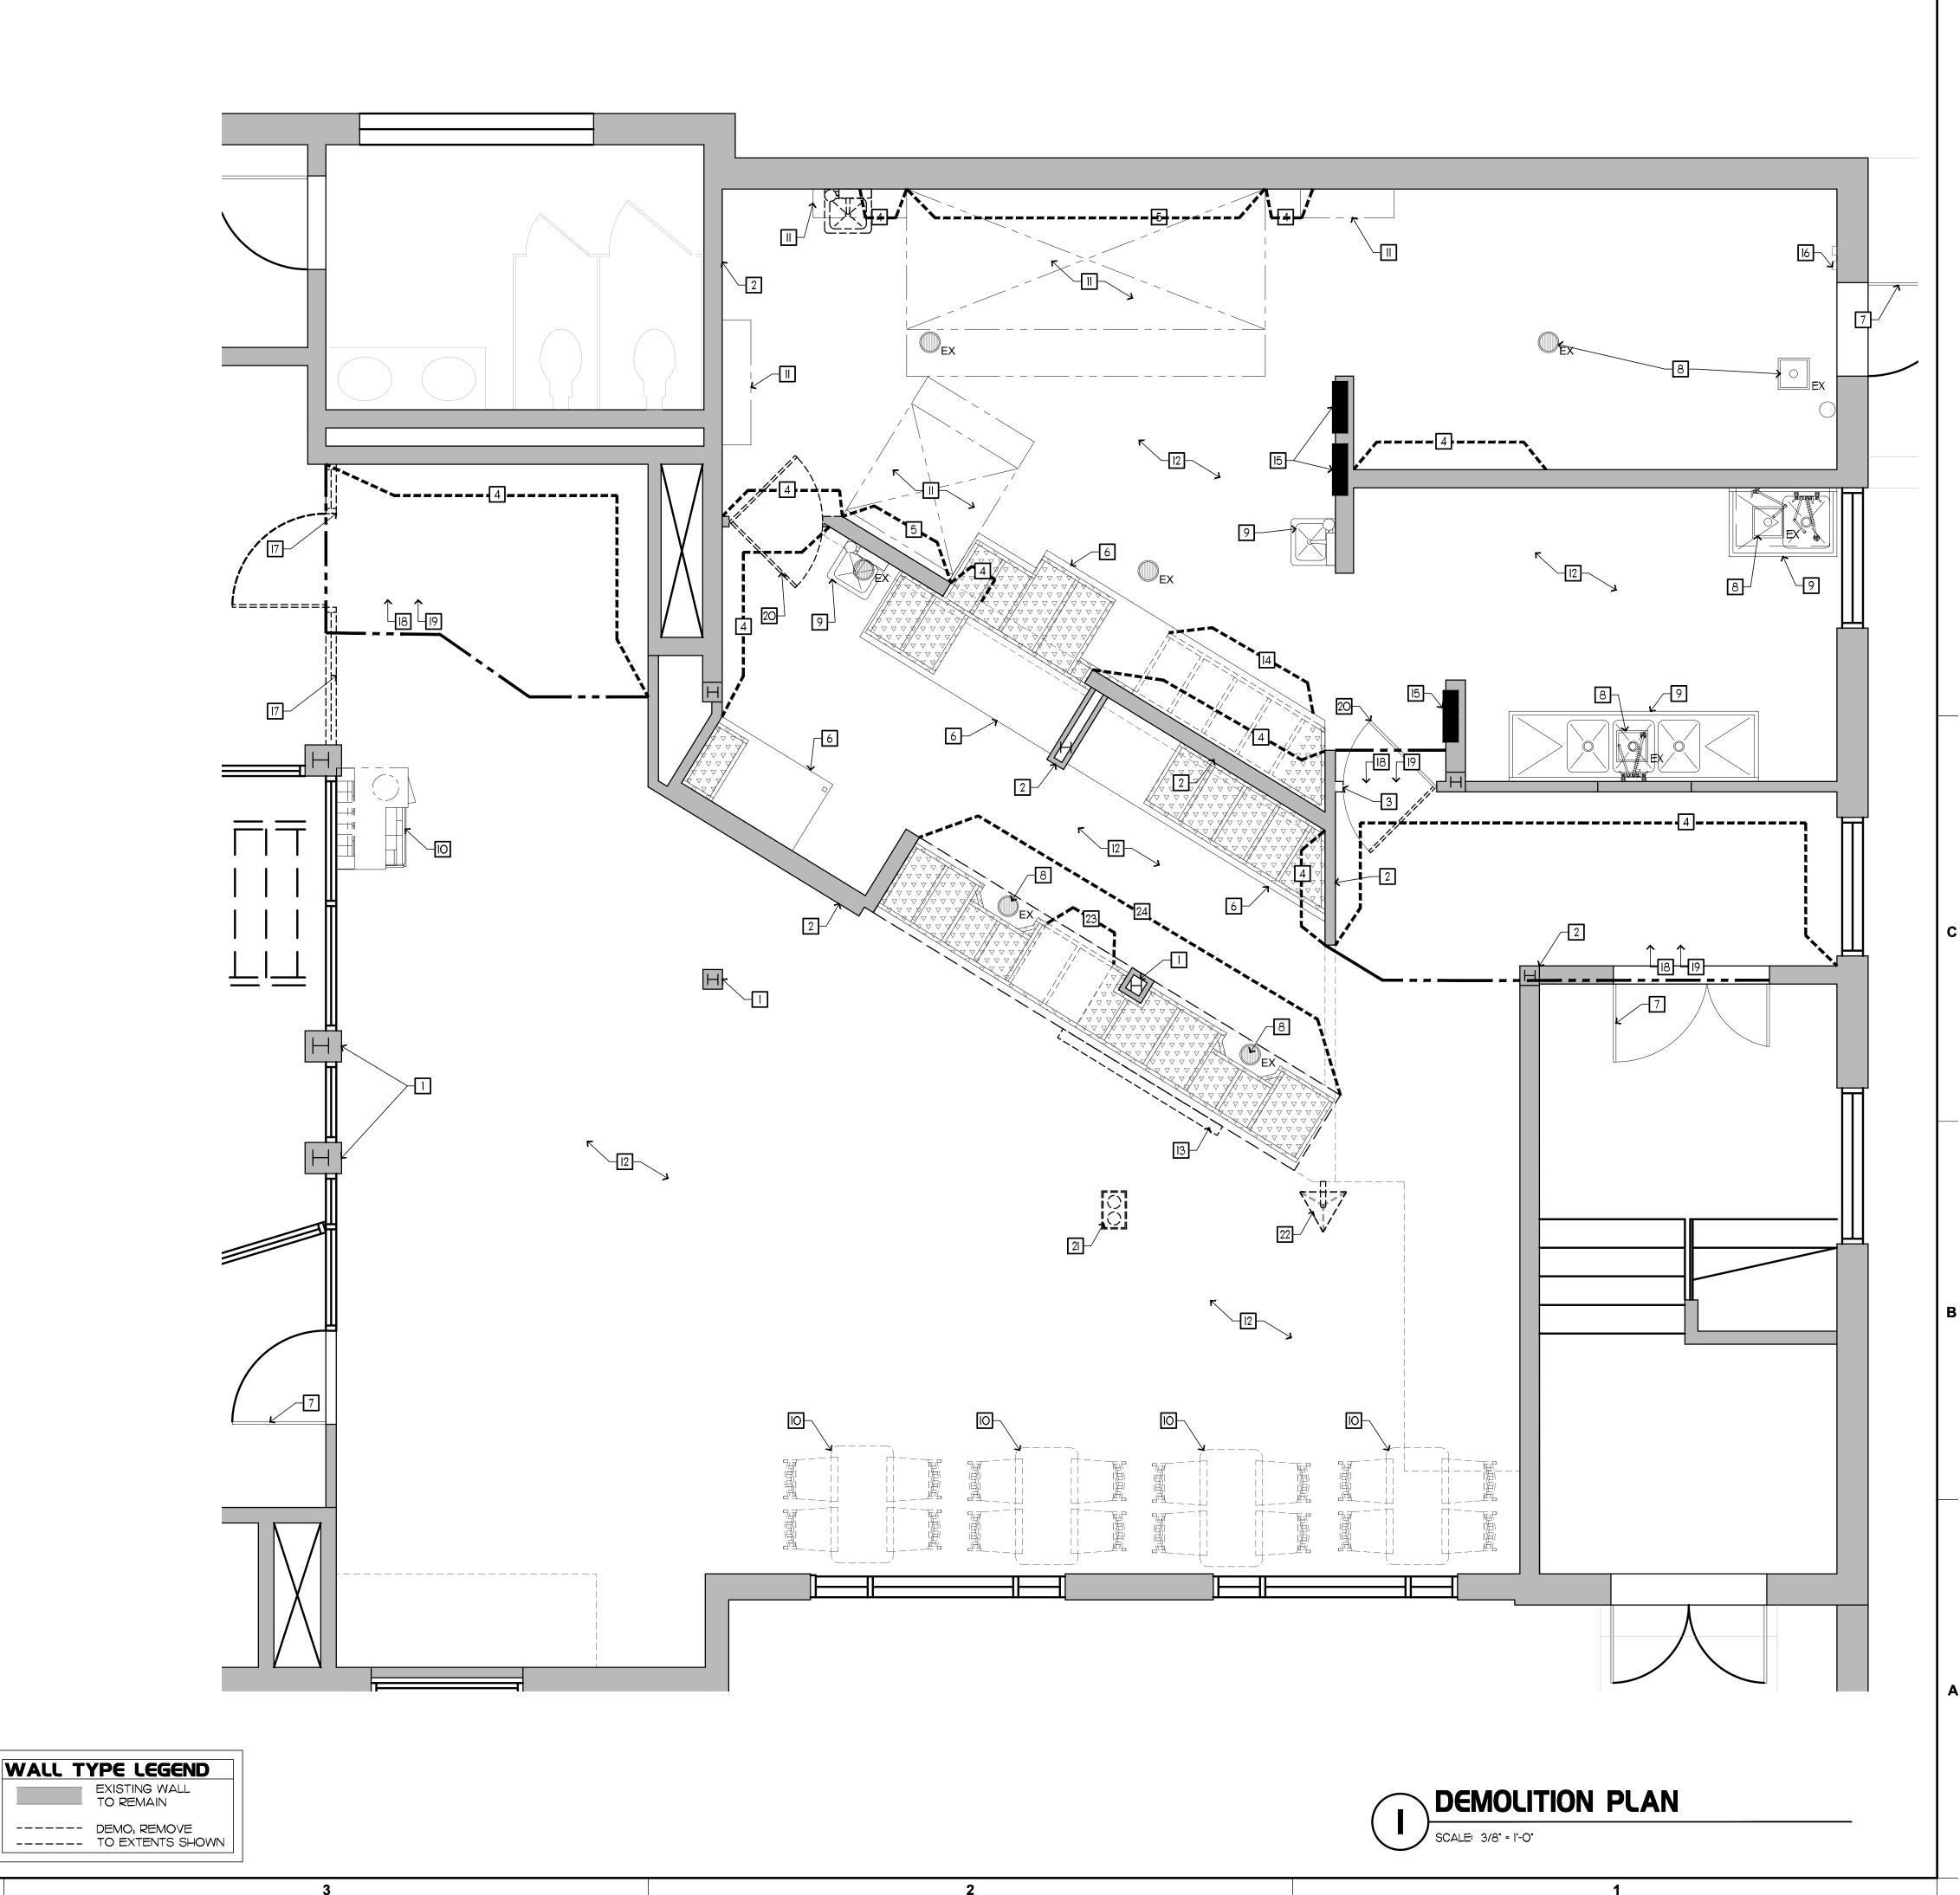





Chick-fil-A **5200 Buffington Road** Atlanta, Georgia 30349-2998



Hill Foley Rossi & Associates ARCHITECTURE + ENGINEERING 3680 Pleasant Hill Road Suite 200 Duluth, GA 30096 770.622.9858

© Copyright (as dated below) This drawing and all reproductions thereof are the propert for the sole use of the project named hereon. Reproduction without the written consent of HFR is unlawful. All copies are to be returned to HFR upon project completion SEALED: 10/25/2023



CERT. NO.

#80419

BUILDING TYPE / SIZE:


RELEASE:


REVISION SCHEDULE NO. DATE DESCRIPTION

CONSULTANT PROJECT # 21.554 PRINTED FOR 10.25.2023 DRAWN BY Information contained on this drawing and in all digital files

produced for above named project may not be reproduced in any manner without express written or verbal consent from authorized project representatives. DEMOLITION PLAN, NOTES AND SCHEDULE

D-201

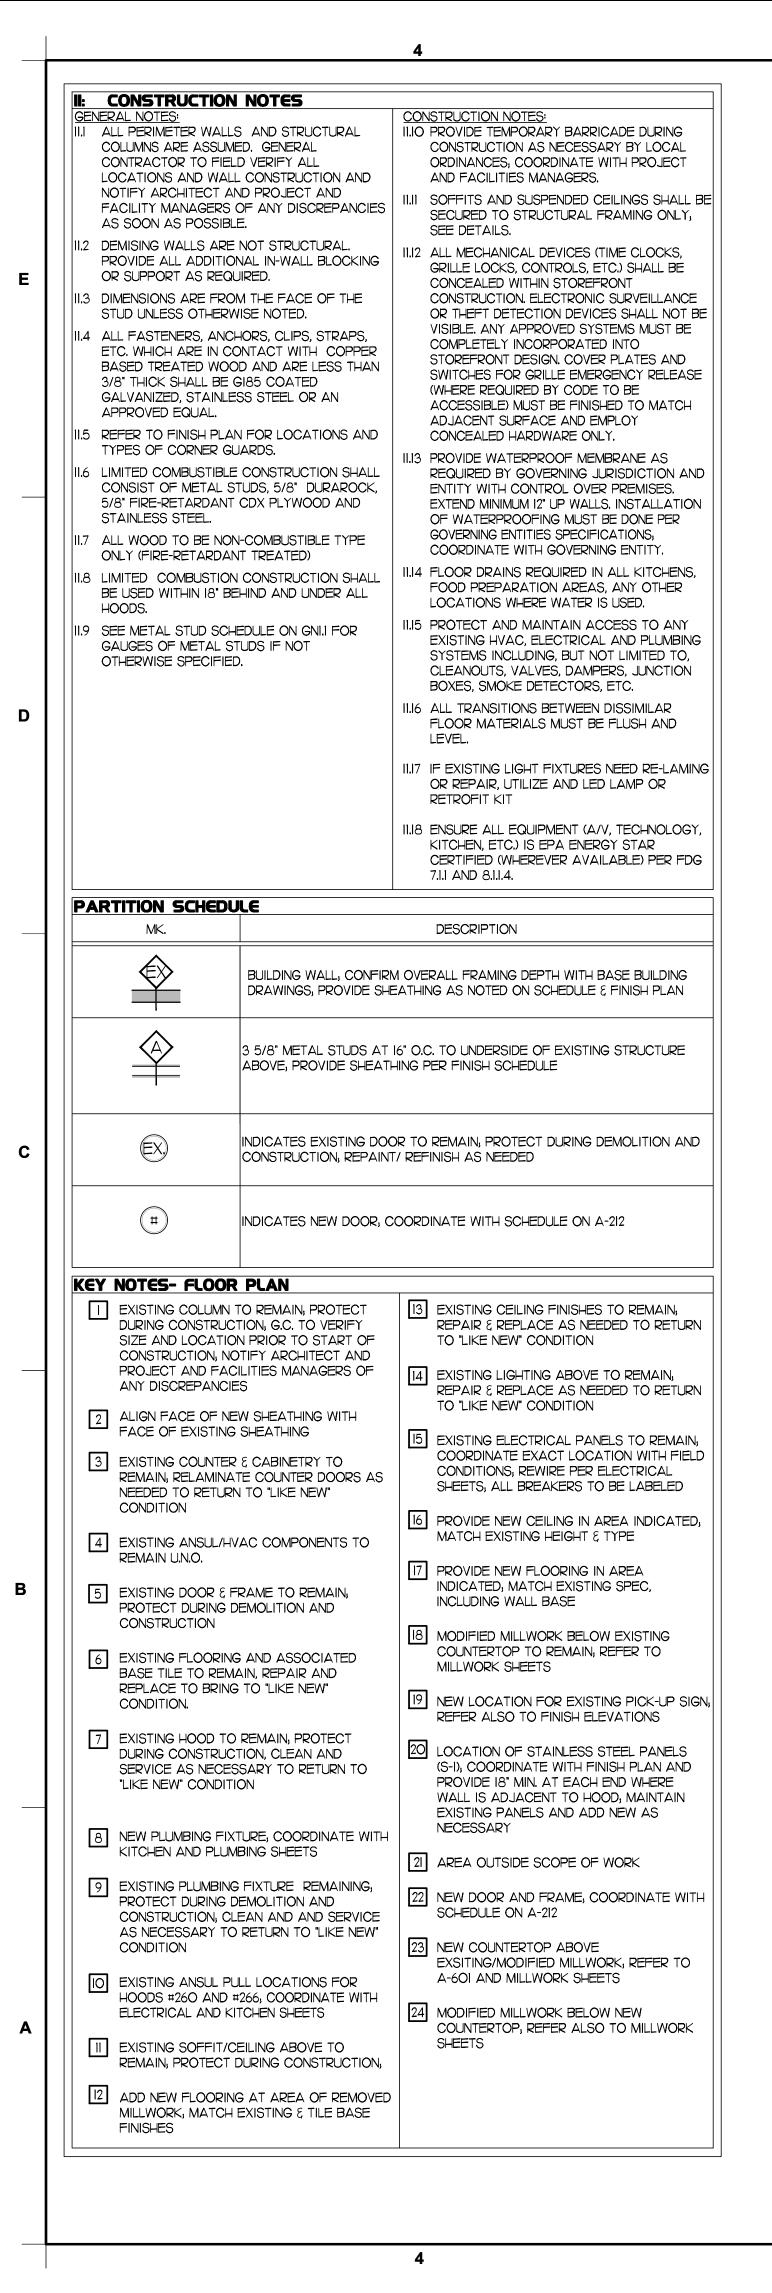

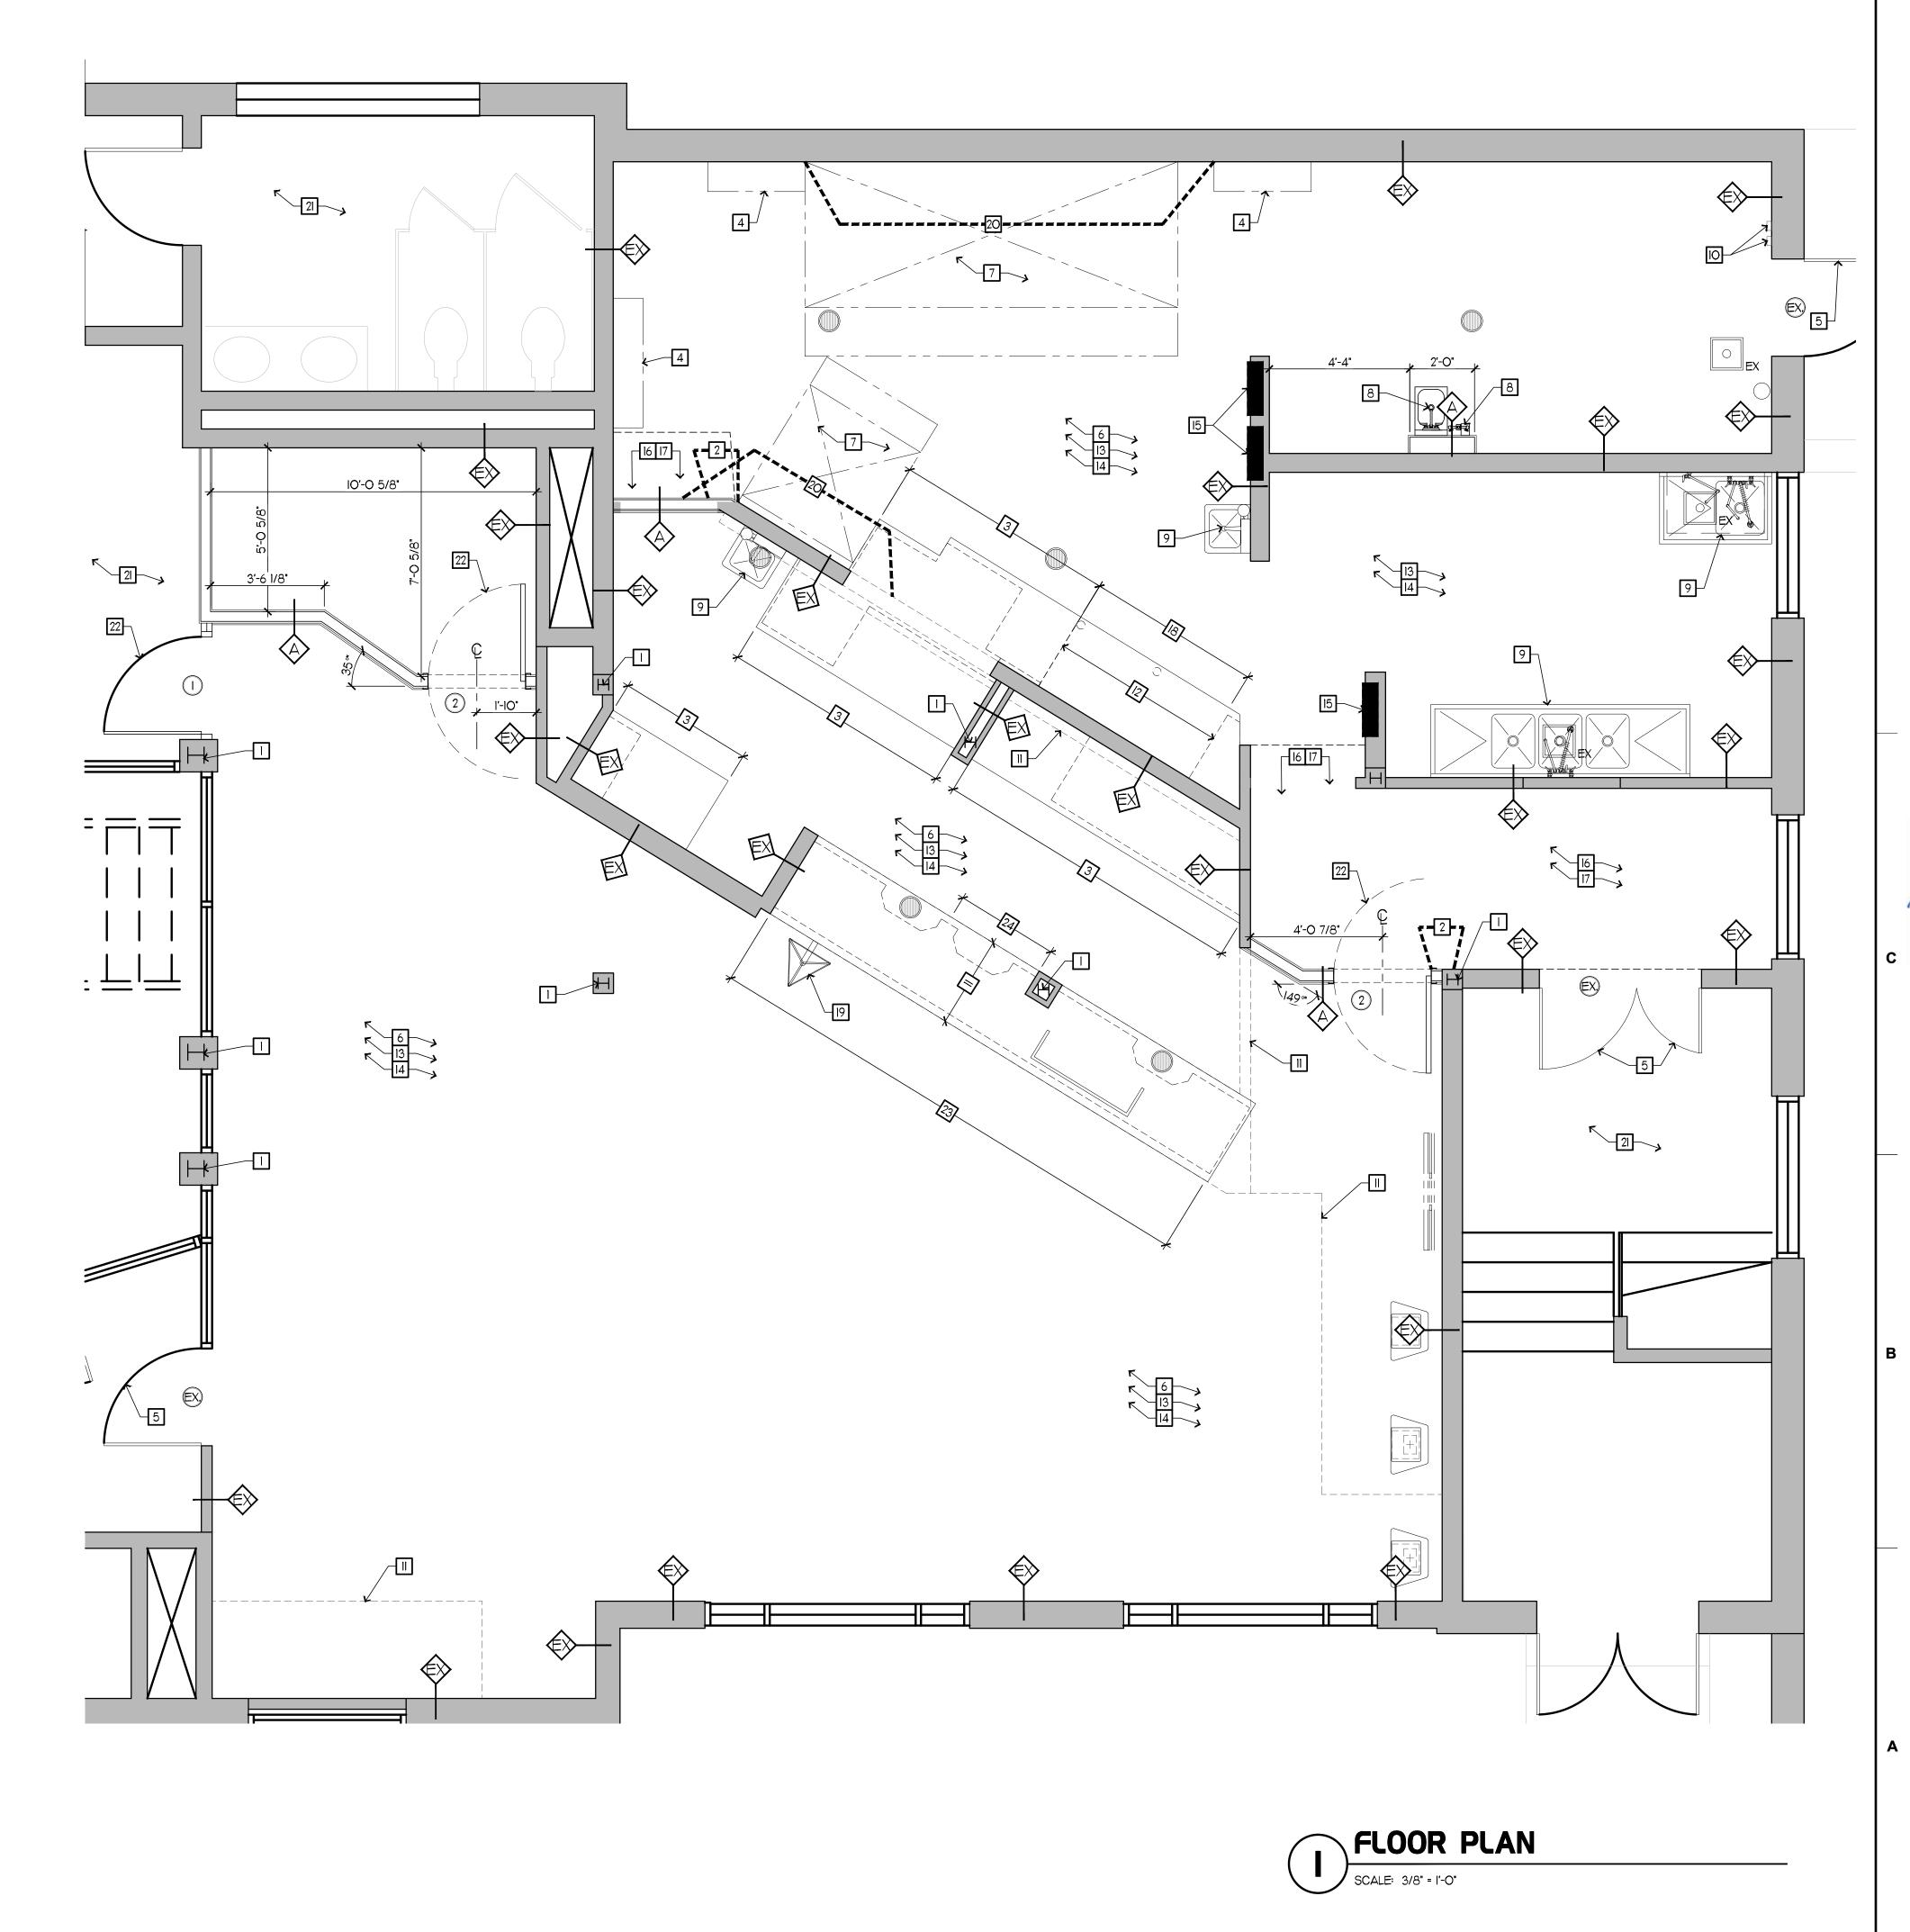





Atlanta, Georgia



Hill Foley Rossi & Associates
ARCHITECTURE + ENGINEERING
3680 Pleasant Hill Road
Suite 200
Duluth, GA 30096
770.622.9858

© Copyright (as dated below).

This drawing and all reproductions thereof are the property of Hill Foley Rossi & Associates, LLC.(HFR). It is intended for the sole use of the project named hereon. Reproduction without the written consent of HFR is unlawful. All copies are to be returned to HFR upon project completion.

SEALED: 10/25/2023





ICK-FIL-Appell University Hall

#80419

BUILDING TYPE / SIZE:

RELEASE:

REVISION SCHEDULENO.DATEDESCRIPTION

CONSULTANT PROJECT # 21.554

PRINTED FOR CD

DATE 10.25.2023

DRAWN BY RJD


Information contained on this drawing and in all digital files produced for above named project may not be reproduced in

produced for above named project may not be reproduced in any manner without express written or verbal consent from authorized project representatives.

SHEET
FLOOR PLAN, NOTES AND
SCHEDULES

SHEET NUMBER

A-201

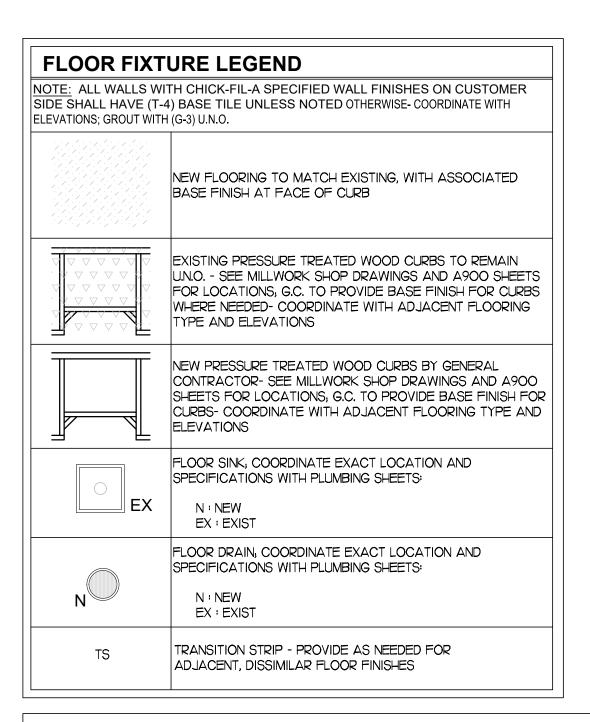

GENERAL NOTES: FINISH

- 1. COORDINATE CONTROL JOINTS IN TILE WITH CONTROL JOINTS IN SLAB BELOW; G.C. TO
- PROVIDE ADDITIONAL CONTROL JOINTS AS NECESSARY. 2. PROVIDE SLOPE IN SLAB (2% MAX) (WHERE POSSIBLE) TO FLOOR DRAINS; COORDINATE LOCATIONS WITH P-SHEETS AND EXISTING CONDITIONS.


- 1. PROVIDE A WATERPROOFING MEMBRANE (62 MIL WITH POLYPROPYLENE FABRIC REINFORCING RECOMMENDED, COORDINATE FINAL SPECIFICATION WITH FACILITY
- WHERE SLAB IS ON GRADE, PROVIDE MEMBRANE AT ALL PERIMETER WALLS EXTENDING INTO SPACE 36"-48" AND UP THE WALL A MINIMUM OF 12" (NOT TO EXCEED THE HEIGHT OF
- WHERE SLAB IS ABOVE GRADE, PROVIDE MEMBRANE THROUGHOUT SPACE AND UP THE WALL A MINIMUM OF 12" (NOT TO EXCEED THE HEIGHT OF THE CEMENT BOARD)

FINISH INSTALLATION NOTES:

- 1. START WOOD (WD-1) INSTALLATION AT TOP OF BASE TILE.
- 2. TILE SETTING METHODS TO BE PER THE LATEST PRINTED EDITION OF "HANDBOOK FOR CERAMIC TILE INSTALLATION" AS PUBLISHED BY THE TILE COUNCIL OF AMERICA, INC.
- 3. START TILE INSTALLATION AT TOP OF BASE TILE. 4. WHERE BASE TILE IS UNDER MILLWORK OR HAS TILE INSTALLED ABOVE; BULLNOSE IS TO BE REMOVED SO THAT TILE CAN BE INSTALLED WITH TOP OF CUT TILE AT 5 1/2" ABOVE FINISHED
- CONCRETE SLAB. 5. TILE TO EXTEND BEHIND MILLWORK.
- 6. INSTALL SUBWAY TILE (T-1A) TILE FROM TOP OF BASE TILE TO UNDERSIDE OF CEILING, PROVIDE TRIM (TR-1) AS INDICATED ON ELEVATIONS AND DETAILS. GROUT WITH (G-2).
- 7. INSTALL TILE (T-2) ACCENT TILE FROM TOP OF BASE TILE TO UNDERSIDE OF CEILING/SOFFIT.
- 8. AT (FRP-2) LOCÀTIÓNS, PROVIDE CORNER GUARDS (CG-3A) AT OUTSIDE CORNERS AND WALL CAPS (CG-3B) AT WALL END.
- 9. AT HOODS, INSTALL STAINLESS STEEL (S-1) PANELS FROM TOP OF BASE TILE TO UNDERSIDE
- OF HOOD OR CEILING AS APPLICABLE. 10. AT MOP SINK, INSTALL STAINLESS STEEL (S-1) PANELS FROM TOP OF BASE TILE TO 48" A.F.F.
- AND (FRP-2) FROM 48" A.F.F. TO UNDERSIDE OF CEILING. PROVIDE CORNER GUARDS AT WALL ENDS (CG-3B).
- 11. SEE MÀTERIAL SCHEDULE FOR FLAME SPREAD INFORMATION. TO COMPLY WITH THE CODES LISTED ON COVERSHEET, ALL INTERIOR FINISHES SHALL:
- a. ALL FLOOR FINISHES SHALL HAVE A MINIMUM CLASS RATING OF "B" OR BETTER. b. ALL CEILINGS SHALL HAVE MINIMUM CLASS RATING OF "A".
- c. FOR ALL INTERIOR ROOMS; CORRIDORS AND EXIT PASSAGES; INTERIOR WALL FINISHES SHALL BE OF A CLASS "C" OR BETTER.

		KEY NOTES - FLO	OOR FINISH PLAN							
MARK	NOTES									
1	SLAB, N	OT ON FLOORING; SEE MILLWORK P AYOUT; PROVIDE BASE TILE AT ALL I	ERAL CONTRACTOR; CURBS TO SIT DIRECTLY ON PAGES FOR DESIGN PLANS AND SHOP DRAWINGS FOR EXPOSED FACES- COORDINATE WITH ADJACNT							
2	AT EXHAUST HOOD, INSTALL STAINLESS STEEL (S-1) PANELS FROM TOP OF BASE TILE TO UNDERSIDE OF HOOD OR CEILING AS APPLICABLE									
6	GROUT	JOINT								
7	NEW FL	OOR DRAIN; REFER TO PLUMBING D	RAWINGS							
8	NEW FL	OOR SINK DRAIN; REFER TO PLUMB	ING DRAWINGS							
S	SHEATHING SCHEDULE									
SHEATH	IING SET		DESCRIPTION							
A NOT USED										

SHEAT	THING SCHEDULE	
SHEATHING SET		DESCRIPTION
А	NOT USED	
A.1	NOT USED	
В	(1) LAYER 5/8" CEMENT BOARD FRO 18" A.F.F TO 6" ABOVE CEILING	M FLOOR TO 18" A.F.F. AND 5/8" CDX PLYWOOD FROI
С	(1) LAYER 5/8" CEMENT BOARD FRO (AS APPLICABLE); TO UNDERSIDE O	M FLOOR TO 6" ABOVE OR UNDERSIDE OF CEILING F STRUCTURE ABOVE AT HOODS
C.1		R (1) LAYER 5/8" FRT-CDX PLYWOOD BLOCKING OR TO 6" ABOVE OR UNDERSIDE OF CEILING (AS
E	(PLYWOOD OCCURS FROM 18" A.F.F. A.F.F.) FROM TOP OF SLAB TO UNDE	OVER (1) LAYER 5/8" CDX PLYWOOD FROM 7'-0"
F		M FLOOR TO 6" A.F.F. AND (1) 5/8" FRT-CDX PLYWOO ERSIDE OF CEILING (AS APPLICABLE)
G	(1) LAYER 5/8" DRYWALL FROM BOT CEILING (AS APPLICABLE)	TOM OF SOFFIT TO 6" ABOVE OR UNDERSIDE OF
Н		YER 5/8" CEMENT BOARD FROM FLOOR TO YWOOD FROM 5" A.F.F. TO 32 3/4" A.F.F
J	NOT USED	

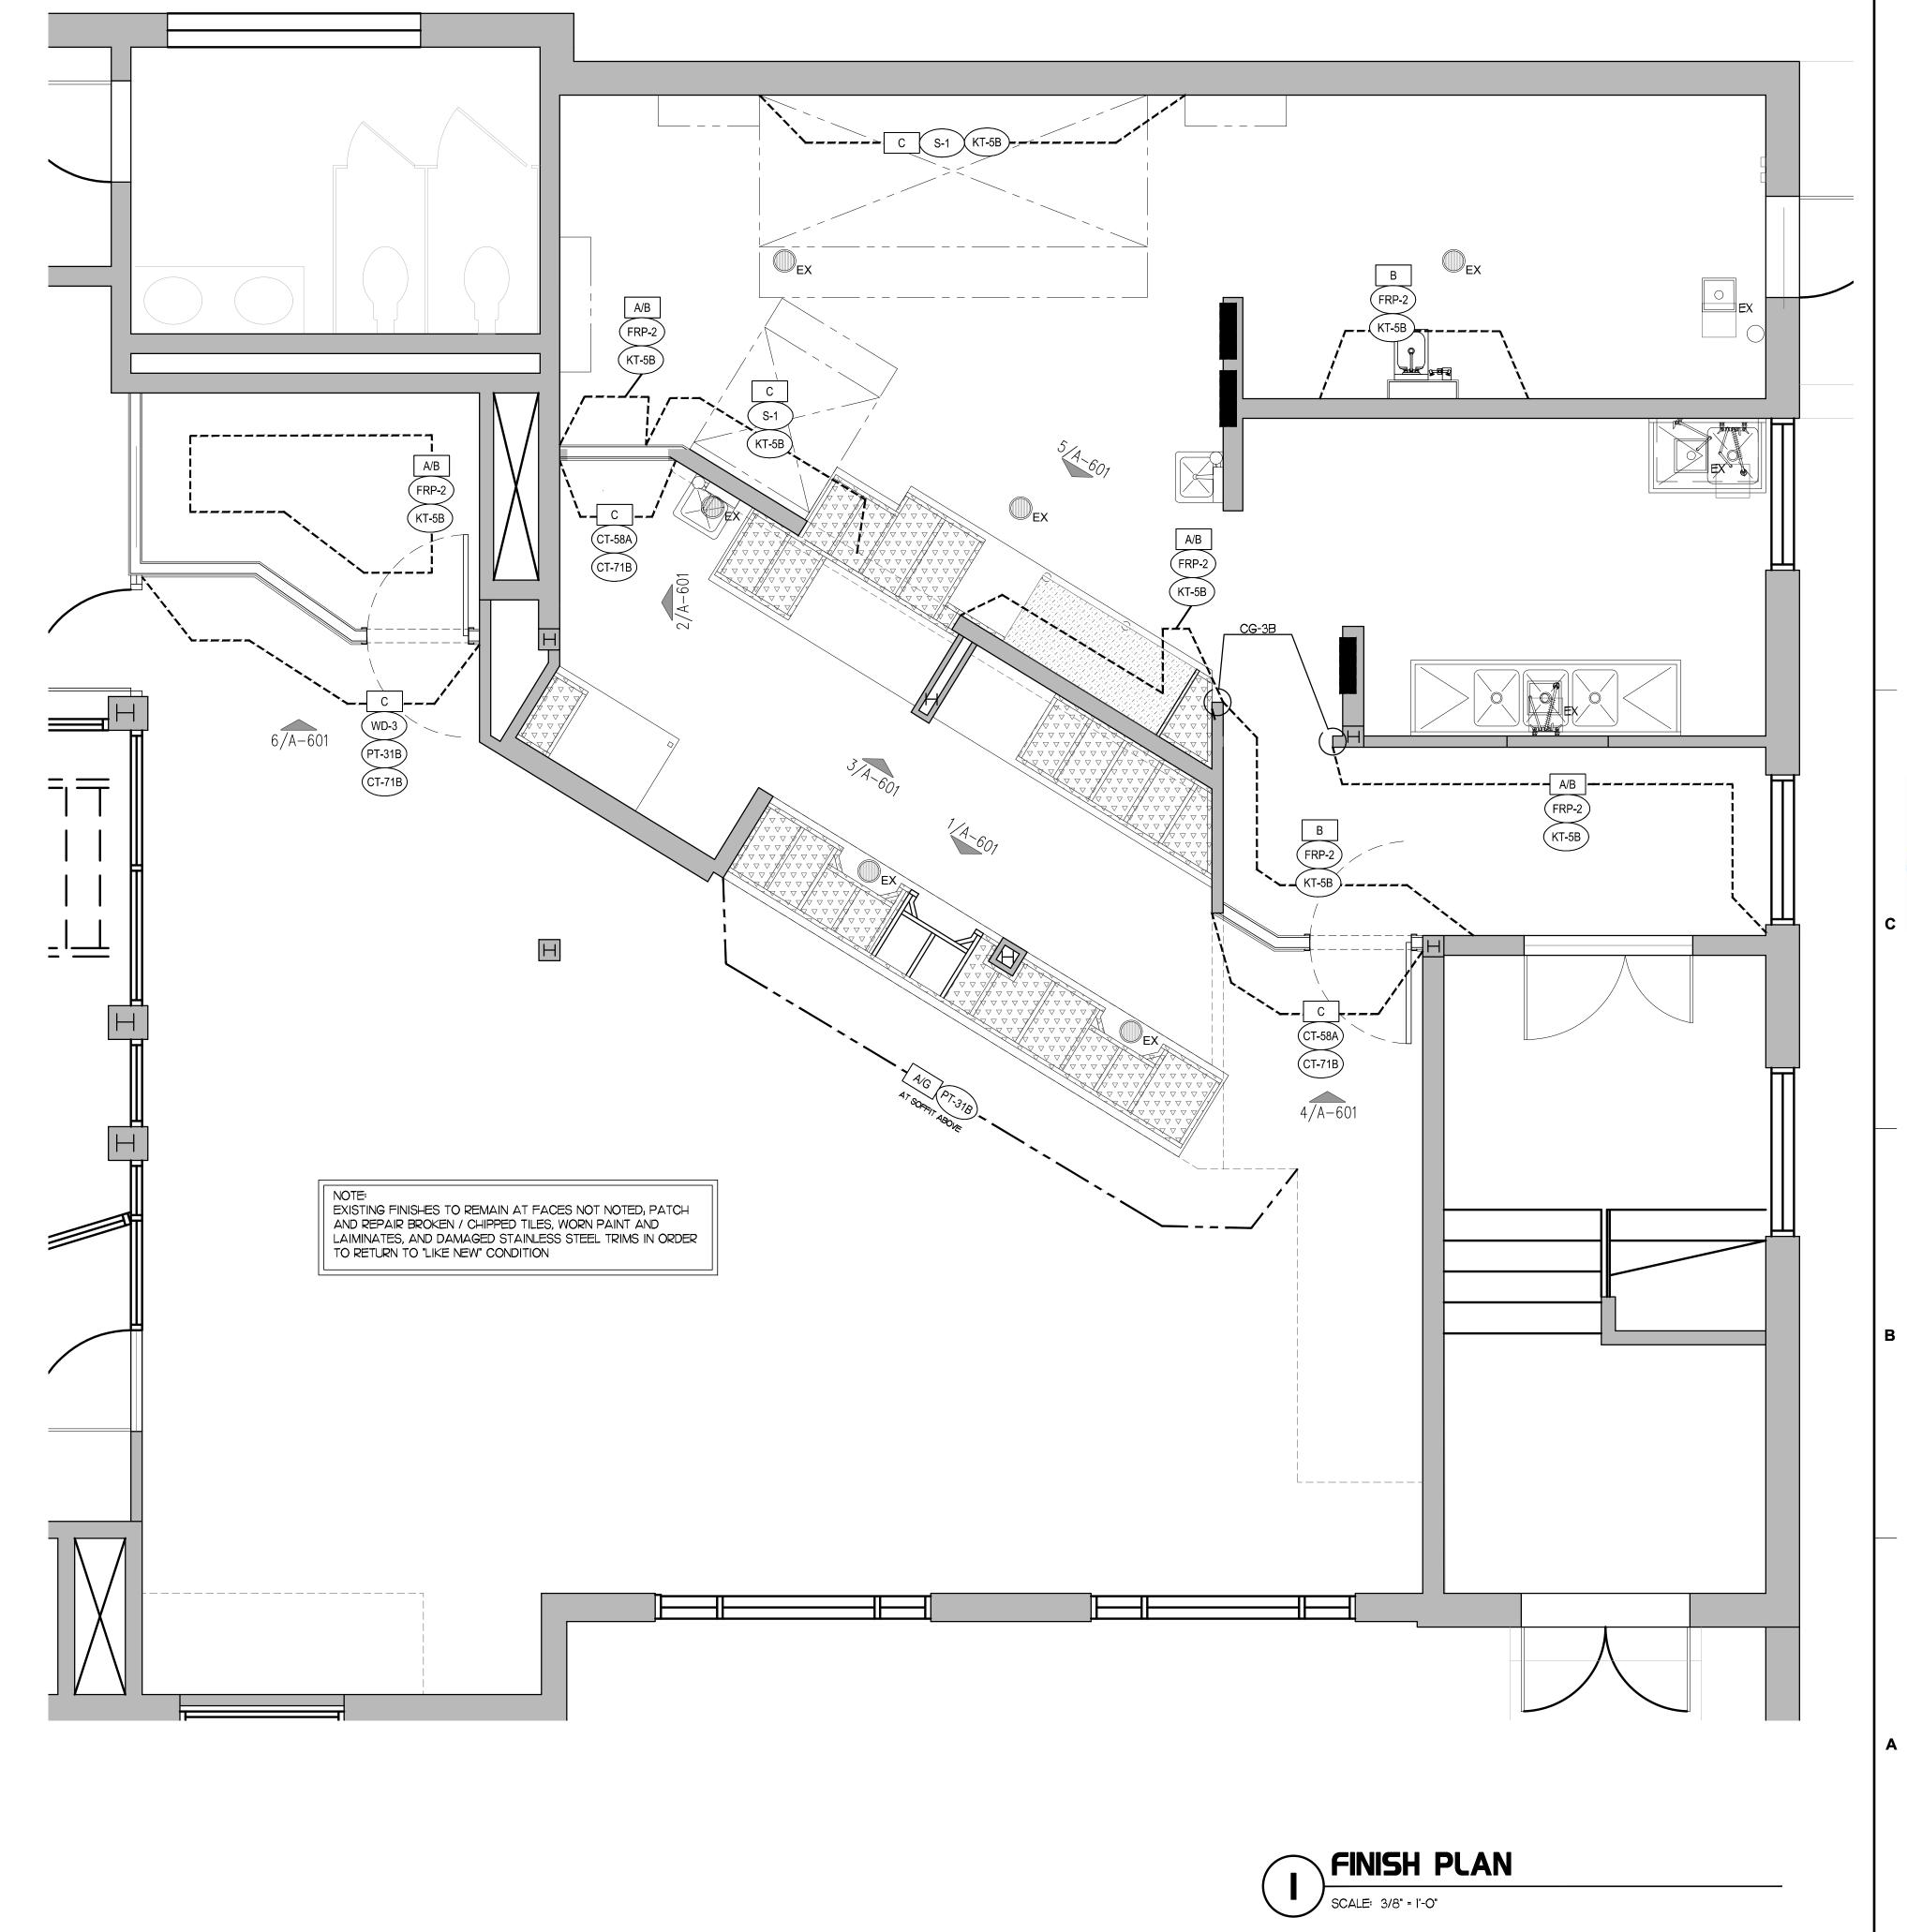





Chick-fil-A **5200 Buffington Road** Atlanta, Georgia 30349-2998



Hill Foley Rossi & Associates ARCHITECTURE + ENGINEERING 3680 Pleasant Hill Road Suite 200 Duluth, GA 30096 770.622.9858

This drawing and all reproductions thereof are the property of Hill Foley Rossi & Associates, LLC.(HFR). It is intended for the sole use of the project named hereon. Reproduction without the written consent of HFR is unlawful. All copies are to be returned to HFR upon project completion.

SEALED: 10/25/2023





BUILDING TYPE / SIZE:

RELEASE:

REVISION SCHEDULE NO. DATE DESCRIPTION

CONSULTANT PROJECT #	21.554
PRINTED FOR	CD
DATE	10.25.2023
DRAWN BY	

Information contained on this drawing and in all digital files produced for above named project may not be reproduced in any manner without express written or verbal consent from authorized project representatives. FINISH PLAN

			4				3				2			1	
	MADIC	DECODIDATION	MANUEACTURED		RIAL SCHEDULE	001.00	0175	NOTE				5 MATERI	AL NOTES		
	MARK	DESCRIPTION	MANUFACTURER	MODEL NAME	MODEL NUMBER	COLOR	SIZE	NOTE				5.1 CEILING SUSPENSION	SYSTEM AS MFG. BY USG INTERIORS, INC., (CHICAGO, IL DONN DX FIRE-RATED (5" WIDE STAND ED ASSEMBLY. LEVEL 5 FINISH, GYP BOARD CEILING)ARD GRID SYSTEM,
E	X. EXIS	STING FINISH						EXISTING FINISH TO REMAIN; PROTECT DURING I CONSTRUCTION	DEMOLITION AND			5.2 GYPSUM & CEMENT V SPECIFICATIONS.	VALLBOARD AS MFG. BY UNITED STATES GYF	PSUM, CHICAGO, IL. SEE SECTIONS AND DETAILS F	
	1_CEILING FINI CT-1 KITC		CERTAINTEED	PREFORMA / VINYLROCK	#142-CRF-1 WHITE		24" X 24"	GRID: STANDARD 15", SQUARE LAY-IN GRID, WHIT	ГЕ			TYPE-2 - SHEETRO	CK BRAND, FIRECODE C CORE GYPSUM PANE OCK BRAND, FIRECODE C CORE GYPSUM PAN OCK BRAND, WATER-RESISTANT (W/R) FIRECC	IELS. (TYPE C)	
P	T-31A PRIM	MARY CEILING PAINT	SHERWIN WILLIAMS	PRO MAR 200 ZERO VOC PAINT	SW-7011 NATURAL CI	HOICE		FINISH: FLAT				TYPE-5 - DUROCK	BRAND, MULTI-PURPOSE CEMENT BOARD	(FRP), AS MFG. BY MARLITE DIVISION OF MASONITE	E CORP., DOVER, OH.
	2_FLOOR FINIS T-5 KITO	HES CHEN QUARRY TILE	CREATIVE MATERIALS CORP. / DALTILE	GRAY	GRAY		8" X 8"	JOINT WIDTH: 3/8" W THINSET MORTAR; 6"X6" AC	CEPTABLE SIZE			<u>PANELING-</u> P-100 16GA S/S CORNER	"WHITE" - 48" WIDE X MAX. HT. X 3/32" (INSTAL GUARDS- TO BE INSTALLED AT ALL OUTSIDE	LL MAXIMUM PANEL SIZES TO REDUCE NUMBER OF E CORNERS (FROM TILE BASE TO CEILING)	
C	T-71 POR	RCELAIN TILE	CREATIVE MATERIALS CORP. / DALTILE	PATINA	LAVA LIGHT	GRAY	12" X 12"	ALTERNATE WHEN NECESSARY JOINT WIDTH: 3/16"; INSTALL TILE AT 45 DEGREE COORDINATE WITH FINISH PLAN	OR 90 DEGREE;			5.4 TILE SETTING METHOD		EXPOSED EDGES AND PANEL JOINTS. OF "HANDBOOK FOR CERAMIC TILE INSTALLATION"	' AS PUBLISHED
	3_WALL BASE F	FINISHES CHEN QUARRY TILE COVE BASE	CREATIVE MATERIALS CORP. / DALTILE	CRAY	507 GRAY		6 " x 8"	JOINT WIDTH: 3/8" WITH THINSET MORTAR; WHE	N TILE IS LINDED			CONCRETE SUBFLO	CIL OF AMERICA, INC. <u>DOR-</u> SET BY METHOD NO. FI3I EPOXY MORTA <u>.RD-</u> SET BY METHOD NO. W252 USING ORGAN		
		RCELAIN TILE COVE BASE	CREATIVE MATERIALS CORP. / DALTILE		LAVA LIGHT	GRAY	6" X 12" COVE	MILLWORK CABINET OR BELOW TILE - REMOVE B JOINT WIDTH: 3/16"				WOOD SUBFLOOR- MASONRY OR CONC.	SET BY METHOD NO. FI52 USING ORGANIC A WALLS- MORTAR - SET BY METHOD NO. W202 DR	.DHESIVE. PY - SET MORTAR OR LATEX PORTLAND CEMENT MORTA	
	4_WALL FINISH RP-2 FRP	ES WALL PANELS @ KITCHEN	MARLITE	STANDARD FRP	P-199 BRIGHT WHI	TE	.090" THICK X 4 X 10 PANELS	PROVIDE MARLITE CORNER GUARDS AT ALL OUT	SIDE CORNERS				TO HAVE A MINIMUM INTERIOR FINISH OF A	OOMS AND ENCLOSED SPACES NOT SPECIFICALLY CLASS "C" RATING. FLAME SPREAD OF FINISHES A DESCRIPTION FLAME-SPREAD	AS FOLLOWS:
		MARY WALL PAINT LL PAINT		PRO MAR 200 ZERO VOC PAINT PRO MAR 200 ZERO VOC PAINT	SW-7011 NATURAL CI SW-7600 BOLERO	HOICE		IN KITCHEN AREAS, U.N.O. FINISH: EGGSHELL FINISH: EGGSHELL				GYPSUM WALLBOA PAINT	RD 10-15 A O A	FIBER CEILINGS O N/A	A A
	T-58A SUB	INLESS STEEL WALL PANEL WAY WALL TILE WAY WALL TILE	CUSTOM CREATIVE MATERIALS CORP. / DALTILE CREATIVE MATERIALS CORP. / DALTILE		GRADE 304		4-1/4" X 8-1/2"	GROUT: G2, JOINT WIDTH: 1/8" GROUT: G2, JOINT WIDTH: 1/8"; BULLNOSE EDGE				DECORATIVE LAMII SOLID SURFACE FIBERGLASS PANE	O	GROUT O IOO PINE (WD-3) II5	A C C
С	T-45 STA /D-1 5" W	INLESS STEEL WALL TILE VIDE NATURAL OAK BOARDS,	CREATIVE MATERIALS CORP. / DALTILE SKYLAR MORGAN		VOGUE STA OILED OR W	INLESS STEEL ATERLOX	4-1/4" X 8-1/2" 1" X 2" BRICK, 12 X 12 SHEET	GROUT: G2				RESILIENT SHEET F			
V		STOM CHARACTER GRADE NSCOTING		1/4" PLYWOOD	WOOD STAI	NED GRIFFIN LIGHT WITH GLAZ	E	SEE A-600 SERIES DRAWINGS & CLAYTON FIXTUE BE ORDERED THROUGH CLAYTON FIXTURES	RE SHOPS, MUST						
l –	5_TRIM G-3A COF	RNER GUARD (KITCHEN ONLY)	CUSTOM	STAINLESS STEEL CORNER GUARD; 2" X 2" LEGS	STAINLESS	STEEL									
	G-3B WAL	L END CAP	CUSTOM	STAINLESS STEEL CORNER GUARD; WALL CAP WITH 2 LEG AT ADJACENT WALL FACES											
	R-3 TRA	.UMN BASE TRIM NSITION FROM (T-6) TO (T-1) OR (T-2 MINATION TRIM OF WD-1 L-SHAPE		JOLLY	A60AT SATIN NICKE	EL DAT TO MATCH PT-4	1/4" (6 MM)								
	6_MILLWORK L-40 MILL	WORK FACE PANELS		NEVAMAR	JUTE			S 2086-AW (WOOD GRAIN TEXTURE)							
11	L-32 REA S-18 SOL	R MILLWORK ID SURFACE ID SURFACE	WILSONART AVONITE	MOVEMENT COLLECTION DUNES COLLECTION	4878, PEWTI 8901, ELEVA F1-9065, AR	TION		FINE VELVET TEXTURE, #38	_						
S		ID SURFACE INLESS STEEL COUNTER	AVOINTL	DOINEO OOLLEO HOIN	F1-9065, AR			16 GAUGE STAINLESS STEEL OVER (2) LAYERS P BRUSHED #4 FINISH, ROUGHNESS OF RA 25 MICE							
							6 DOOR	SCHEDULE					7 DOOR ELEV	VATIONS	
	_				•			DOOR	1 10/41	FRAME	EINHOLL	REMARKS			
							# SIZE	TYPE MATERIAL FINISH		ATERIAL SIZE	FINISH		1		
	451						()								─30"X 9" PLEXIGLASS
	DN I						3 3'-O" X 6'-8" X B.M	A. C STAINLESS PRE-FINISHED	#3 S	TAINLESS 4 7/8" PR	RE-FINISHED				VIEW PANEL
	CEIL						<u> </u>								
	01 0						6 3'-0" X 7'-0" X I 3/4	4" G HOLLOW METAL IN- PT-4 OUT- M.EXT.	#4 HOLI	LOW METAL 5 3/4" THROAT	PT-4			FLUSH DOUBLE ACTING SCP-3 W/ VIEW PA	; ELIASON ANEL
		FINISH TYPE: CEILING ACT-1	FINISH TYPE: WALL/CEIL (PAINT)	(PAINT)			7 8 9	SEE PAGE A7.2 FOR MECHANICAL, EI		STROOM & JANITOR DOOR SO	CHEDULE				
			PT-31A / PT-31B	PT-36B			PRFIN.= PRE-FINISH	B.M BY MANUFACTURER , EX.= EXISTING , HE HED , S.C.= SOLID CORE					₹,		
							ANCHORS AT STRIK	S SCHEDULED, MFG. BY THE STEELCRAFT MF KE AND HINGE SIDES OF FRAMES <u>FRAMES</u> (TYPICAL © DOUBLE ACTING DOOR)	NOTE I- CONF	FORM TO APPLICABLE CODE	FOR FIRE RATING, MIN. B LABEL				
							6.4 PAINT KITCHEN FAC 6.6 G.C. TO PROVIDE SI	CE AND EDGES OF DOOR AS INDICATED. PA JUITE MARKER PER REQUIREMENTS OF AIRP	AINT CORRIDOR ORT AND LOCA	P/EXTERIOR FACE OF DOOR	AND H.M. FRAME PER AIRPORT.		≣R		
							6.7 SANITGRASP CONT 6.8 ALL FACE ON NEW	PERATIONS AND LOCAL JURISDICTION HAVIN FACT: MATTHEW FULKERSON © 404-696-566 DOORS SHALL BE PRE-FINISHED BY MANUFA	I ACTURER, COLO	R TO MATCH PAINT COLOR S	SPECIFIED IN DOOR SCHEDULF.			G	
	NOR						6.9 PAINT EXTERIOR/NO	ON TENANT SIDE FACE OF DOORS AND FRAM OWARE WITH LOCATION SPECIFICATIONS; HA	MES TO MATCH NDLE STYLE TO	ADJACENT SURFACE.		TO MATCH OPERATIONS SPECIFICATION	IS I		
	FLO						8 HARD SET QTY. ITEM	WARE SCHEDULE MANUFACTURER		MODEL NUMBER		SET QTY. ITEM	MANUFACTURER	MODEL NUMBER	
	02										-NOT	I SET HINGES DOUBLE AC	BUILDERS BRASSWORKS	BY MANUFACTURER FI2I X US26D 3E X US32D	
		FINISH TYPE: FLOOR KT-5	FINISH TYPE: FLOOR T-3									1 PULL HANDEL LOCKSET LANDLES	HAGER SARGENT HAGER	SEE DOOR NOTE 6.10 ABOVE 3E X US32D	
	阅						#								
	BAS							IISED							
	ALL										NOT	PULL / PUSH - DOOR CLOSER	STOREFRONT SUPPLIER LCN	CLEAR ANODIZED CLEAN & PROVIDE MAINTENANCE	
	3 W,						#2					#4 I O/S PIVOTS DOOR SWEEP FLOOR STOP	STOREFRONT SUPPLIER STOREFRONT SUPPLER ROCKWOOD	CLEAN & PROVIDE MAINTE REPLACE AS REQUIRED 483X- US32D	:NANCE
	Ö	FINISH TYPE: WALL BASE	FINISH TYPE: WALL BASI	E				USED				LOOK STOP		-100/1 00020	
		KT-5B	T-4 (BASE)										CAULKING	GUIDELINES	
												MATER DINING ROOM	RIAL TO MA	ATERIAL CAULK CO	DLOR
												PAINTED WALLS PAINTED WALLS	BASE TILE DOOR FRAMES (PRIC	,	
	— I											PAINTED WALLS PAINTED WALLS	CEILING GRID STOREFRONT	WHITE PAINTABLE SILICON	
	VAL								A MAN			PAINTED WALLS WAINSCOTING STIL	WAINSCOTING ES WAINSCOTING PANE	MATCH WOOD BROWN LS (1PT) OF RED OAK STA	AIN AND (1)
	<u> </u>)5 T			STOREFRONT FRAM BASE TILE	MES WINDOW SILLS UNDERSIDE OF CABI	MOHAWK FIL-STIK M232 CLEAR NETS MATCH BASE TILE GRO	, ,
	01	FINISH TYPE: WALL FRP-2	FINISH TYPE: WALL/CEIL (PAINT)	LING FINISH TYPE: WALL/CEILING (PAINT)	FINISH TYPE: WALL S-1	FINISH CT-58A,	TYPE: WALL CT-58E	FINISH TYPE: WALL CT-45	FINISH TY	/PE: TRIM G-1B		FLOOR TILE SERVING AREA AND	ENTRY DOOR THRES		
		· -	PT-31A	PT-36B		01-00A,	<u>-</u>		о о -т и , о	.		FRONT MILLWORK (RAILS	PL-1) STILES AND FRONT MILLWORK PA		
									DESCRIPTION OF	NAME OF TAXABLE		SUBWAY WALL TILE SUBWAY WALL TILE		·	
	∠											SUBWAY WALL TILE SUBWAY WALL TILE SUBWAY WALL TILE	STAINLESS STEEL	STAINLESS STEEL	
*	OR X											BASE TILE COUNTER TOP	UNDERSIDE OF CABI ADJACENT MATERIAL	NETS MATCH BASE TILE L WHITE - BONE	
	-LW											STAINLESS CORNER STAINLESS STEEL V	RS / CAPS ALL MATERIALS VALL TILE STAINLESS STEEL CO	STAINLESS STEEL OUNTER STAINLESS STEEL	
	9 MI											FRP FRP	BASE TILE PAINTED DOOR FRAM		
	0	FINISH TYPE: MILLWORK	FINISH TYPE: MILLWORK		FINISH TYPE: MILLWO		TYPE: MILLWORK		FINISH TYPE: N	MILLWORK		FRP FRP	CEILING GRID S/S FRAMES/SPLASH	WHITE IES/HAND SINKS CLEAR CLEAR	
		PL-40	PL-32	S-2	SS-18	SS-13			WD-3			FRP WALK IN-COOLER/FI WALK IN-COOLER/FI		CLEAR	
	١	NOTE: PRINTED REPRE	SENTATION OF FINISHES N	MAY DIFFER FROM ACTUAL FINISH	ES							HOODS/ SHROUDS	S/S WALL PANELS	STAINLESS STEEL	
			4				3				2			1	








Hill Foley Rossi & Associates
ARCHITECTURE + ENGINEERING
3680 Pleasant Hill Road
Suite 200
Duluth, GA 30096
770.622.9858

© Copyright (as dated below).

This drawing and all reproductions thereof are the property of Hill Foley Rossi & Associates, LLC.(HFR). It is intended for the sole use of the project named hereon. Reproduction without the written consent of HFR is unlawful. All copies are to be returned to HFR upon project completion.

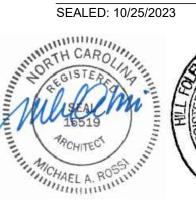



CHICK-FIL-/ Campbell University Britt Hall

#80419

BUILDING TYPE / SIZE:

RELEASE:

REVISION SCHEDULE

NO. DATE DESCRIPTION

CONSULTANT PROJECT # 21.554

PRINTED FOR CD

DATE 10.25.2023

DRAWN BY


Information contained on this drawing and in all digital files produced for above named project may not be reproduced in any manner without express written or verbal consent from authorized project representatives.

SHEET
FINISH, DOOR, & HARDWARE
SCHEDULE, CAULKING
GUIDELINES
SHEET NUMBER

A-212

		CON	NTACT C	CHI (616) 796	-1020 T	o order e	QUIPME	NT							
							N	MECHANICAL					<u>o</u>	≥	REMARKS
DESCRIPTION	MANUFACTURER	MODEL / PART NUMBER			ELE	CTRICA	\L				PLUMBI	PLUMBING		A	
			VOLT	PH KW	AMP I	HP DIRECT	PLUG	NEMA RATING	HW C	CW FV	v Fwz Iw	ROUGH-IN	 	9	
A PICK-UP SIGN WALL MOUNT KIT	СНІ	CFPS3000-2 + (3) LICENSEE INSERTS											957A	1	
22"X24" TABLE - 2 TOP	CHI	TABLE2224VBE1											960	3	
STANDARD HEIGHT TABLE BASE	CHI	200755SARB-CFA											960A	3	
24"X44" TABLE - 4 TOP	CHI	TABLE2444VBE1											961	2	
STANDARD HEIGHT TABLE BASE	CHI	200753SARB-CFA											961A	4	2 REQUIRED PER TABLE TOP
LIBRARY CHAIR (STANDARD)	CHI	LIBRARYCHUPH1-Silver											970	9	
B HERITAGE BOOTH — SINGLE (45")	CHI	HERITAGE45S100PRE											974B	2	

PROPRIETARY MENU BOARD EQUIPMENT SCHEDULE															
<u>o</u>							N	NECHANICAL	<u>o</u>	ΤY	REMARKS				
Z	DESCRIPTION	MANUFACTURER	MODEL / PART NUMBER			ELE	CTRICAL			PLUMBING		7 Z	ANTI		
<u>\</u>				VOLT PH	KW	AMP H	P DIRECT PLUG	NEMA RATING	HW CV	N FW	FW2 IW	ROUGH-IN	7 🖺	OO.	
K1	ORDER TERMINAL KIOSK MONITOR (POS) — SINGLE SIDE — PORTRAIT	ELO	2202L — 22" — "CFA Standard"										K1	3	FINAL PLACEMENT OF KIOSKS SHALL BE DETERMINED BY FOOD SERVICE PROVIDER & COORDINAT WITH CHICK-FIL-A & ARCHITECT FOR OPERATIONAL & ELECTRICAL CONSIDERATIONS
K1A	ORDER TERMINAL KIOSK (POS) - DISPLAY STAND	WALLABY	E062324 — "CFA Standard"										K1A	3	FINAL PLACEMENT OF KIOSKS SHALL BE DETERMINED BY FOOD SERVICE PROVIDER & COORDINAT WITH CHICK-FIL-A & ARCHITECT FOR OPERATIONAL & ELECTRICAL CONSIDERATIONS
OM1	ORDER DISPLAY MONITOR	BY FSP		120 1		20	X						OM1	1	PROVIDE DUPLEX RECEPTACLE AND DATA FOR SELECTED ITEM; 55" SCREEN SIZE INDICATED; CONFIRM WITH FSP, ALONG WITH DESIRED MOUNTING HEIGHT

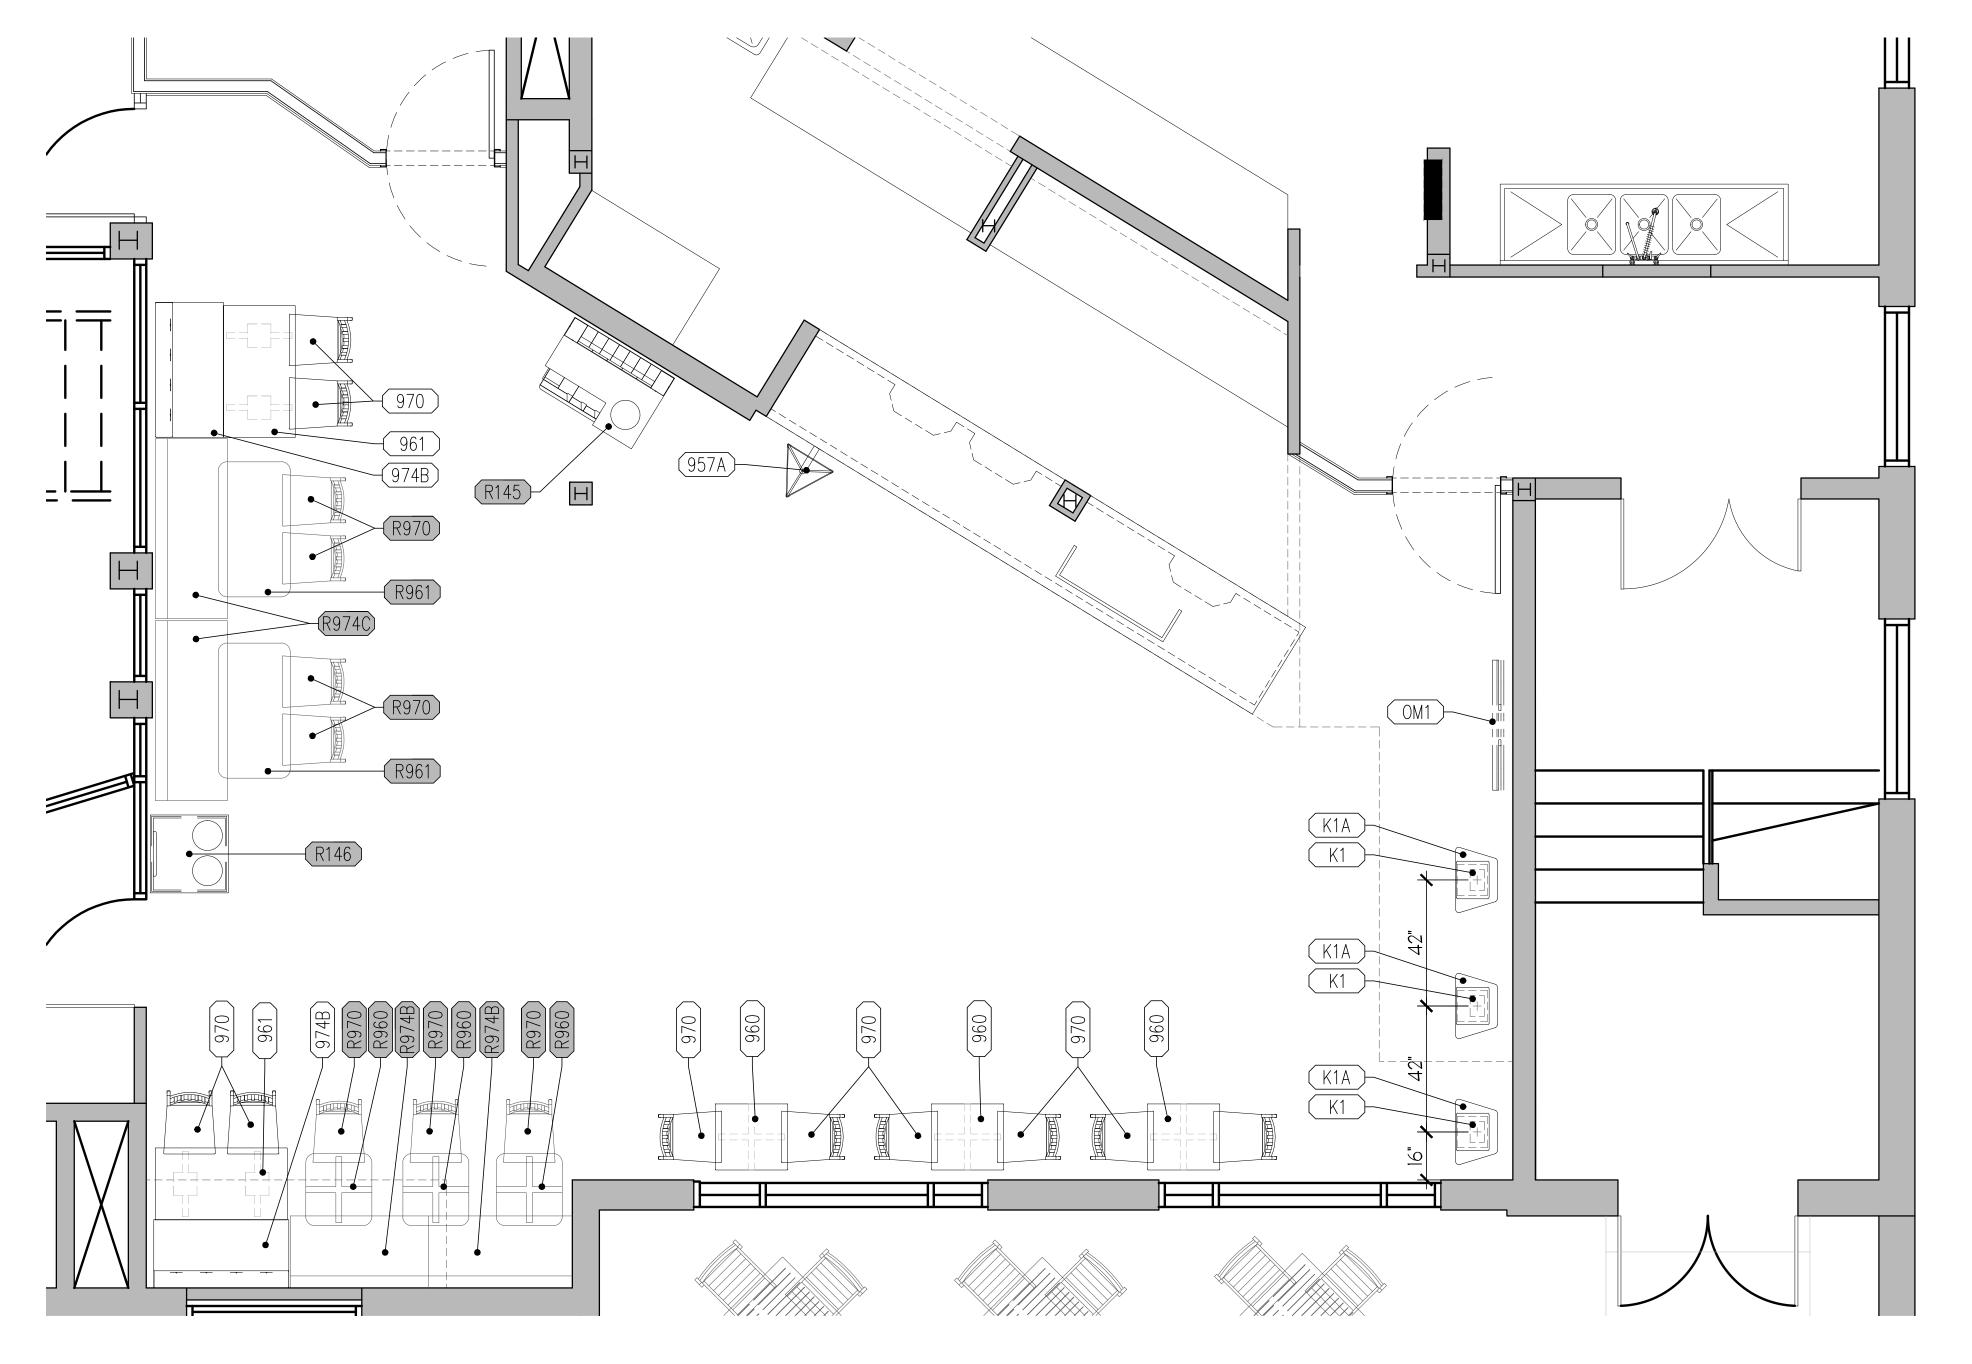









Hill Foley Rossi & Associates
ARCHITECTURE + ENGINEERING
3680 Pleasant Hill Road
Suite 200
Duluth, GA 30096
770.622.9858

© Copyright (as dated below).

This drawing and all reproductions thereof are the property of Hill Foley Rossi & Associates, LLC.(HFR). It is intended for the sole use of the project named hereon. Reproduction without the written consent of HFR is unlawful. All copies are to be returned to HFR upon project completion.

SEALED: 10/25/2023





SHICK-FIL-Zampbell Universit Sritt Hall

#80419

BUILDING TYPE / SIZE: RELEASE:

REVISION SCHEDULE

NO. DATE DESCRIPTION

CONSULTANT PROJECT #	21.5
PRINTED FOR	C
DATE	10.25.20
DRAWN BY	

Information contained on this drawing and in all digital files produced for above named project may not be reproduced in any manner without express written or verbal consent from authorized project representatives.

SHEET
BRANDING PLAN

SHEET NI IMBED

F-201



ELEVATION KEY NOTES

- NEW COUNTERTOP AT FRONT COUNTER, REMOVE AND REPLACE LAMINATE AT FRONT COUNTER WHERE NEEDED, EXISTING SUBSTRATES TO REMAIN, U.N.O.
- 2 PATCH AND REPAIR LAMINATE (ADD NEW DOORS AND HARDWARE FOR SERVICE AREA CABINETS) AT EXISTING CABINETRY TO RETUN TO 'LIKE NEW' CONDITION
- PATCH AND REPAIR LAMINATE AT EXISTING CABINETRY TO RETUN TO 'LIKE NEW' CONDITION
- 4 MODIFIED MILLWORK BELOW NEW COUNTERTOP
- 5 PATCH AND REPAIR WALL BASES, TYP.
- 6 PROVIDE NEW BASE FINISH TO MATCH EXISTING SURROUNDING BASE FINISHES

ELEVATION NOTES:

TILE WORK IS TO EXTEND BEHIND MILLWORK. 2. START TILE INSTALLATION AT TOP OF BASE TILE, SEE

3. STAINLESS STEEL COUNTERTOPS ARE TO HAVE INTEGRAL BACKSPLASHES AND ALL SEAMS ARE TO BE WELDED, GROUND SMOOTH, AND POLISHED





Chick-fil-A **5200 Buffington Road** Atlanta, Georgia 30349-2998



Hill Foley Rossi & Associates ARCHITECTURE + ENGINEERING 3680 Pleasant Hill Road Suite 200 Duluth, GA 30096 770.622.9858

© Copyright (as dated below).

This drawing and all reproductions thereof are the property of Hill Foley Rossi & Associates, LLC.(HFR). It is intended for the sole use of the project named hereon. Reproduction without the written consent of HFR is unlawful. All copies are to be returned to HFR upon project completion.

SEALED: 10/25/2023





#80419


BUILDING TYPE / SIZE:

NO. DATE

CONSULTANT PROJECT #	21.554
PRINTED FOR	CD
DATE	10.25.2023
DRAWN BY	RJD

INTERIOR ELEVATIONS

A-601

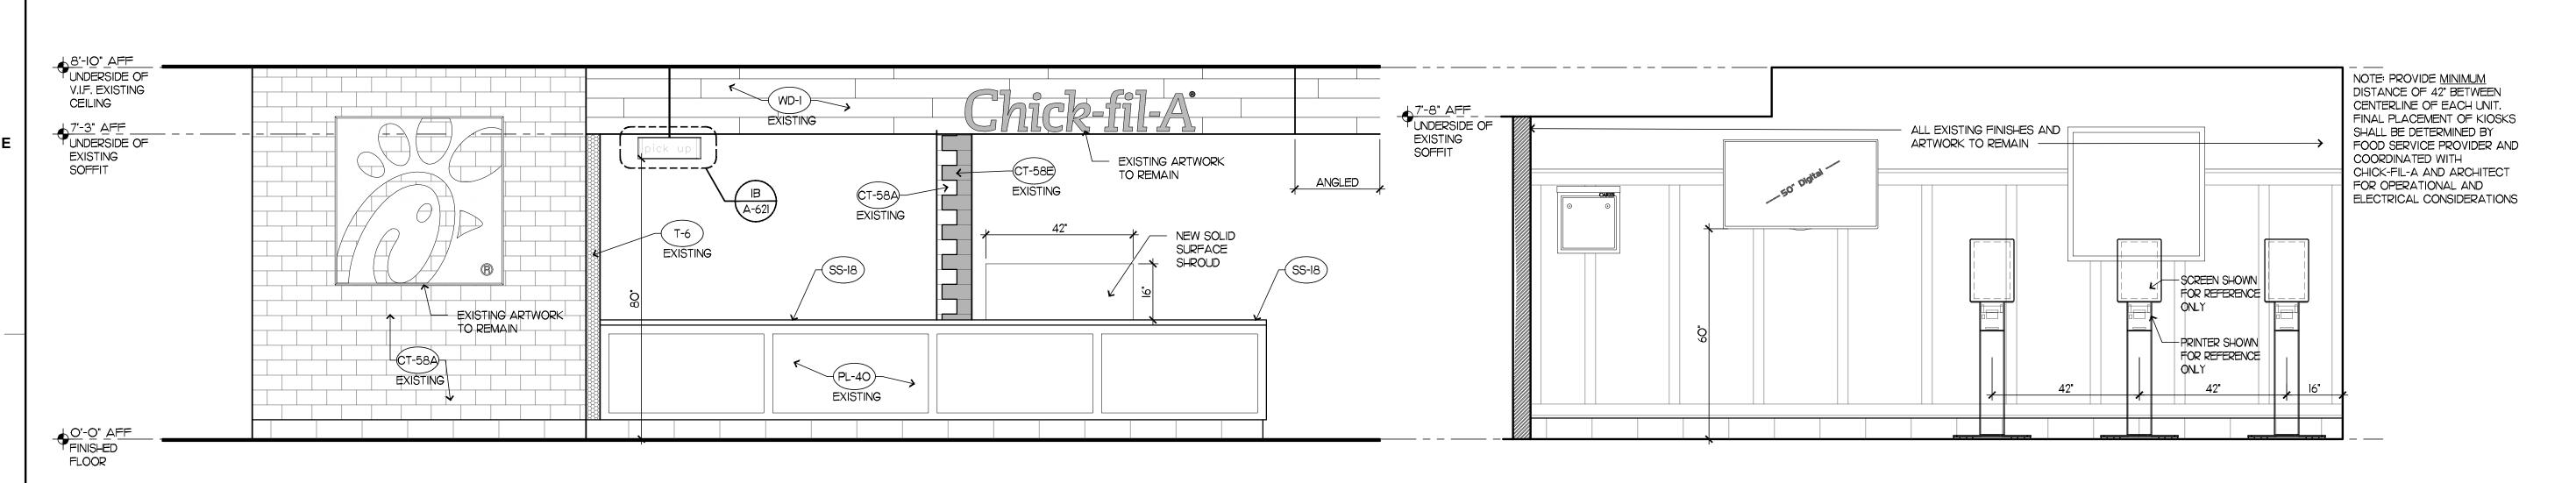

ARCHITECTURAL ELEVATION

SCALE: 1/2' = 1'-0'



ELEVATION NOTES:

1. TILE WORK IS TO EXTEND BEHIND MILLWORK.
2. START TILE INSTALLATION AT TOP OF BASE TILE, SEE

3. STAINLESS STEEL
COUNTERTOPS ARE TO HAVE
INTEGRAL BACKSPLASHES
AND ALL SEAMS ARE TO BE
WELDED, GROUND SMOOTH,
AND POLISHED





Chick-fil-A 5200 Buffington Road Atlanta, Georgia 30349-2998



Hill Foley Rossi & Associates
ARCHITECTURE + ENGINEERING
3680 Pleasant Hill Road
Suite 200
Duluth, GA 30096
770.622.9858

© Copyright (as dated below).

This drawing and all reproductions thereof are the property of Hill Foley Rossi & Associates, LLC.(HFR). It is intended for the sole use of the project named hereon. Reproduction without the written consent of HFR is unlawful. All copies are to be returned to HFR upon project completion.

SEALED: 10/25/2023





HCK-FIL-A mpbell University

#80419

JILDING TYPE / SIZE: ELEASE: X X

X X X


REVISION SCHEDULE

NO. DATE DESCRIPTION

CONSULTANT PROJECT #	21.554
PRINTED FOR	CD
DATE	10.25.2023
DRAWN BY	RJD
Information contained on this drawing a produced for above named project may any manner without express written or	not be reproduced in

SHEET
INTERIOR ELEVATIONS

1-602

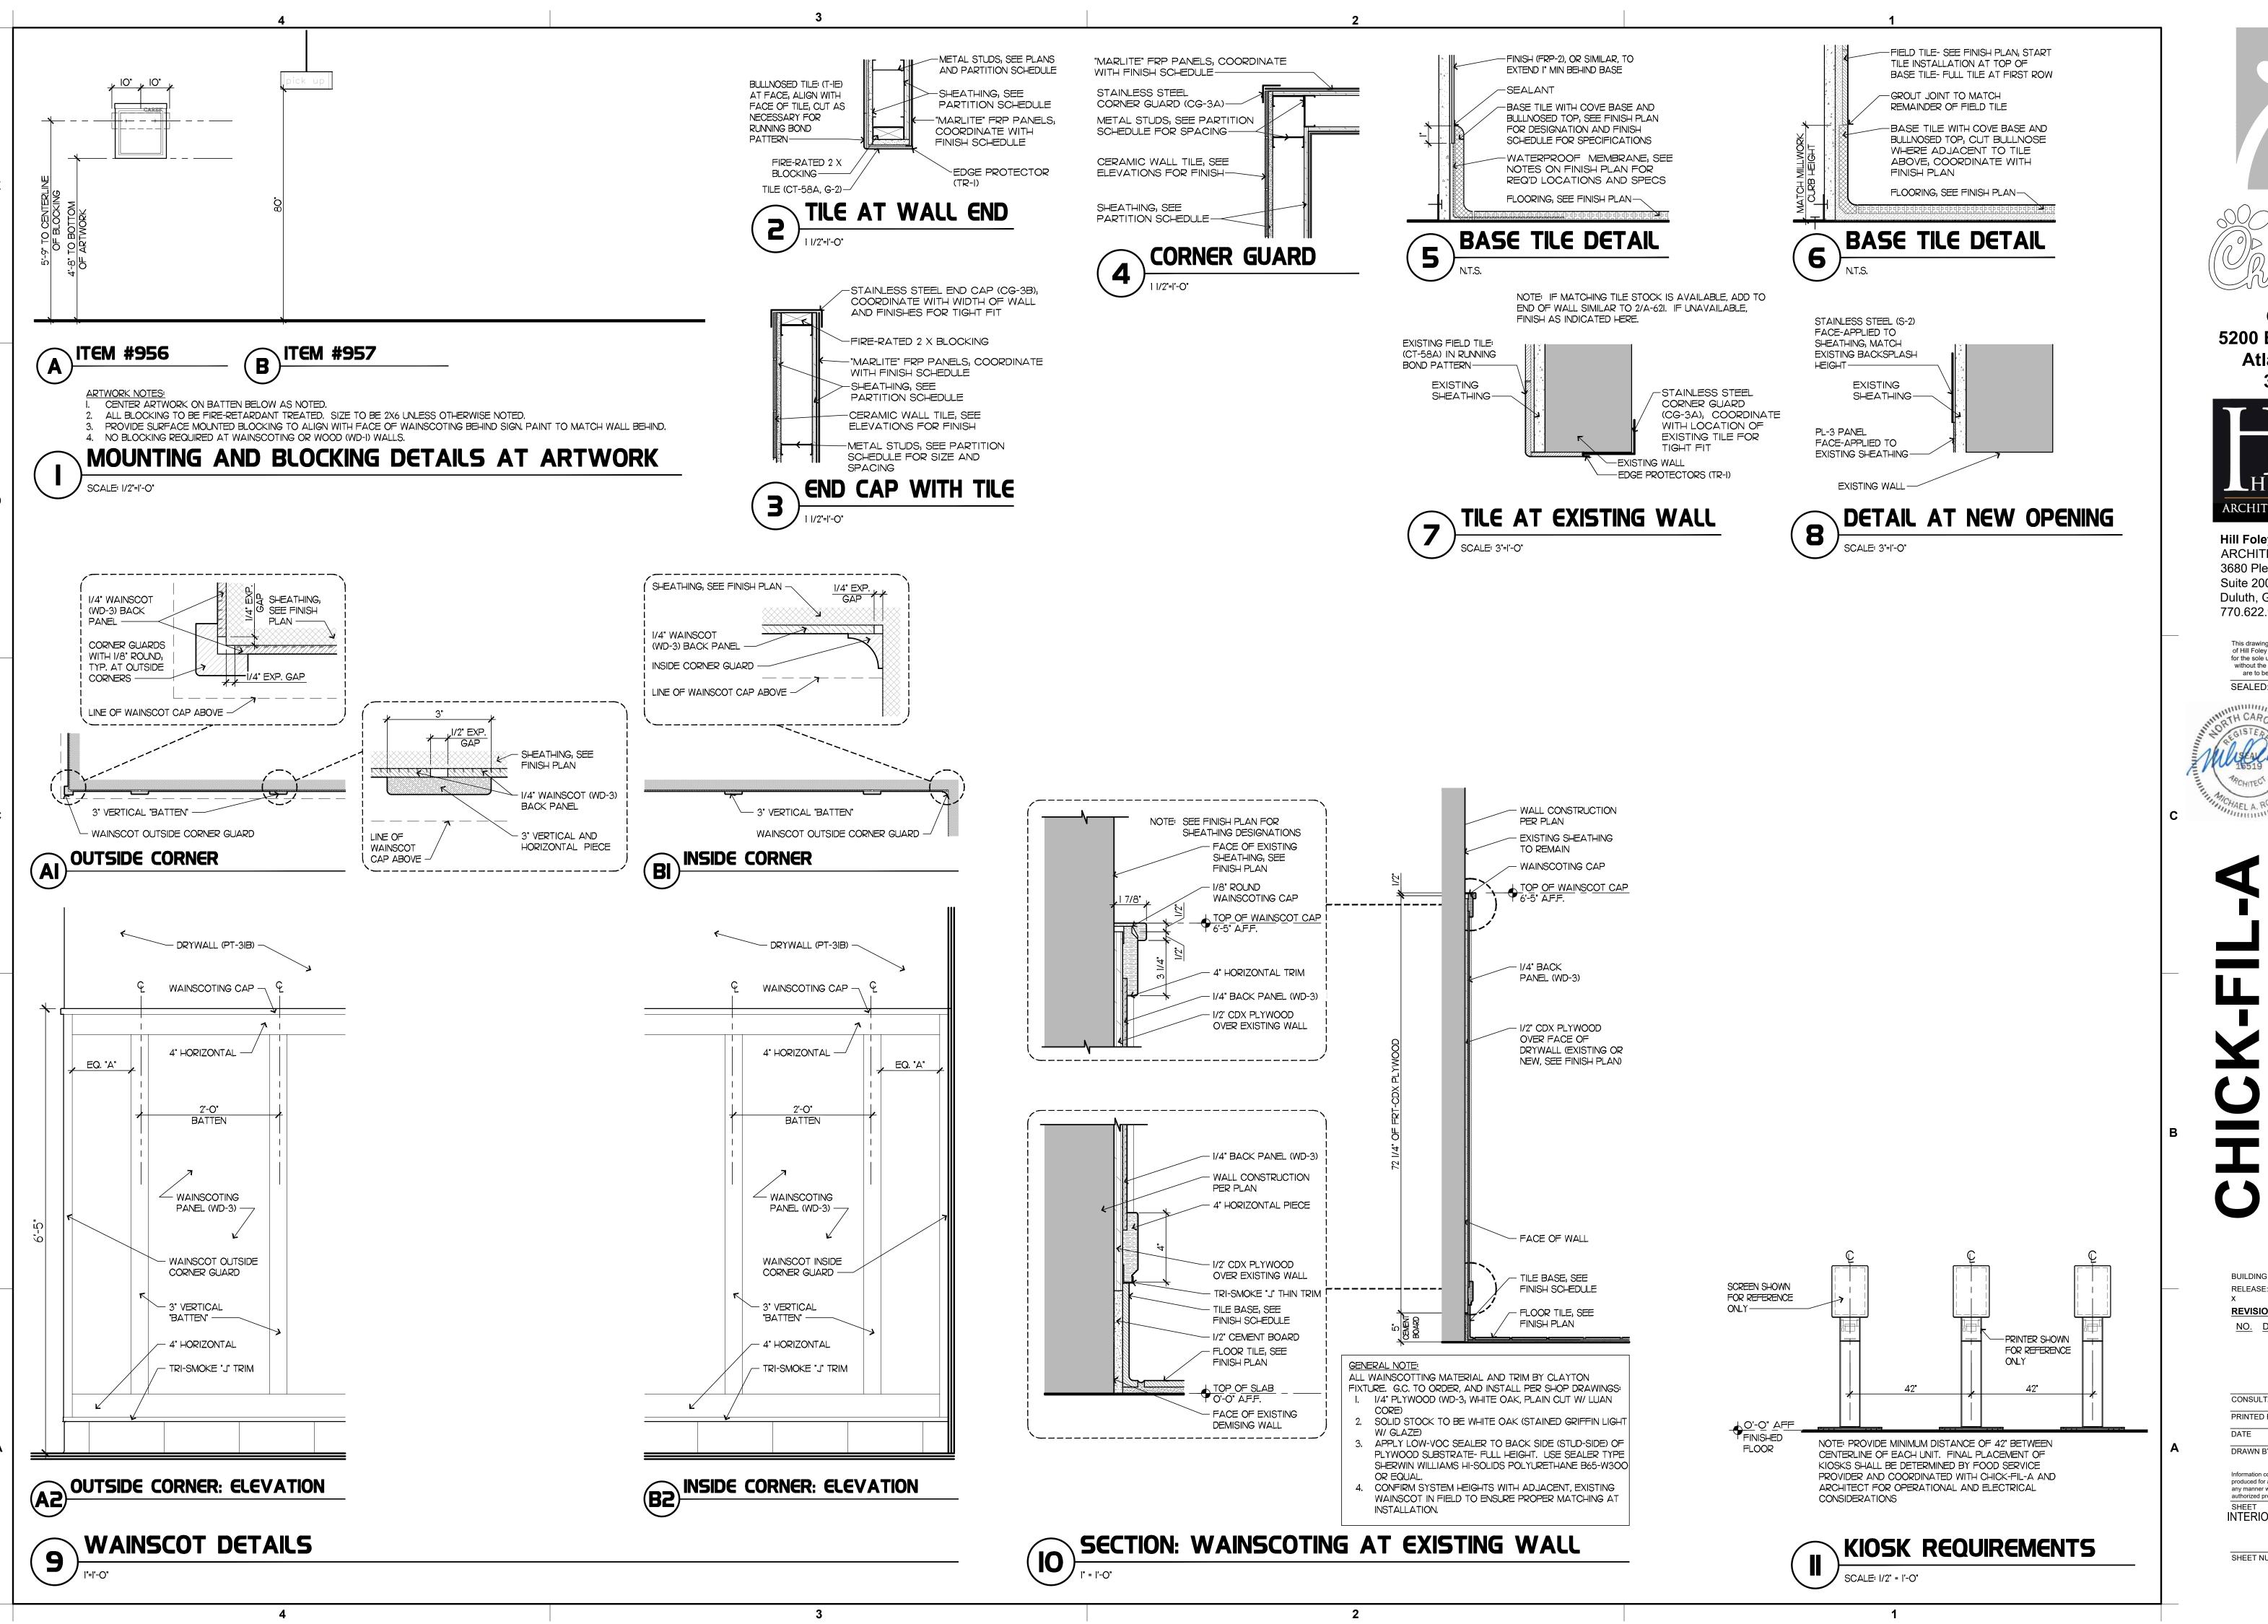








Hill Foley Rossi & Associates ARCHITECTURE + ENGINEERING 3680 Pleasant Hill Road Suite 200 Duluth, GA 30096 770.622.9858

This drawing and all reproductions thereof are the propert of Hill Foley Rossi & Associates, LLC.(HFR). It is intended for the sole use of the project named hereon. Reproduction without the written consent of HFR is unlawful. All copies are to be returned to HFR upon project completion.

SEALED: 10/25/2023



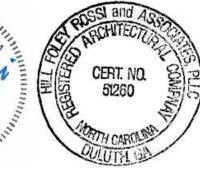

#80419


BUILDING TYPE / SIZE:

REVISION SCHEDULE NO. DATE DESCRIPTION

CONSULTANT PROJECT #	21.554
PRINTED FOR	CD
DATE	10.25.2023
DRAWN BY	RJD
Information contained on this drawing a	

any manner without express written or verbal consent from INTERIOR DETAILS

A-621

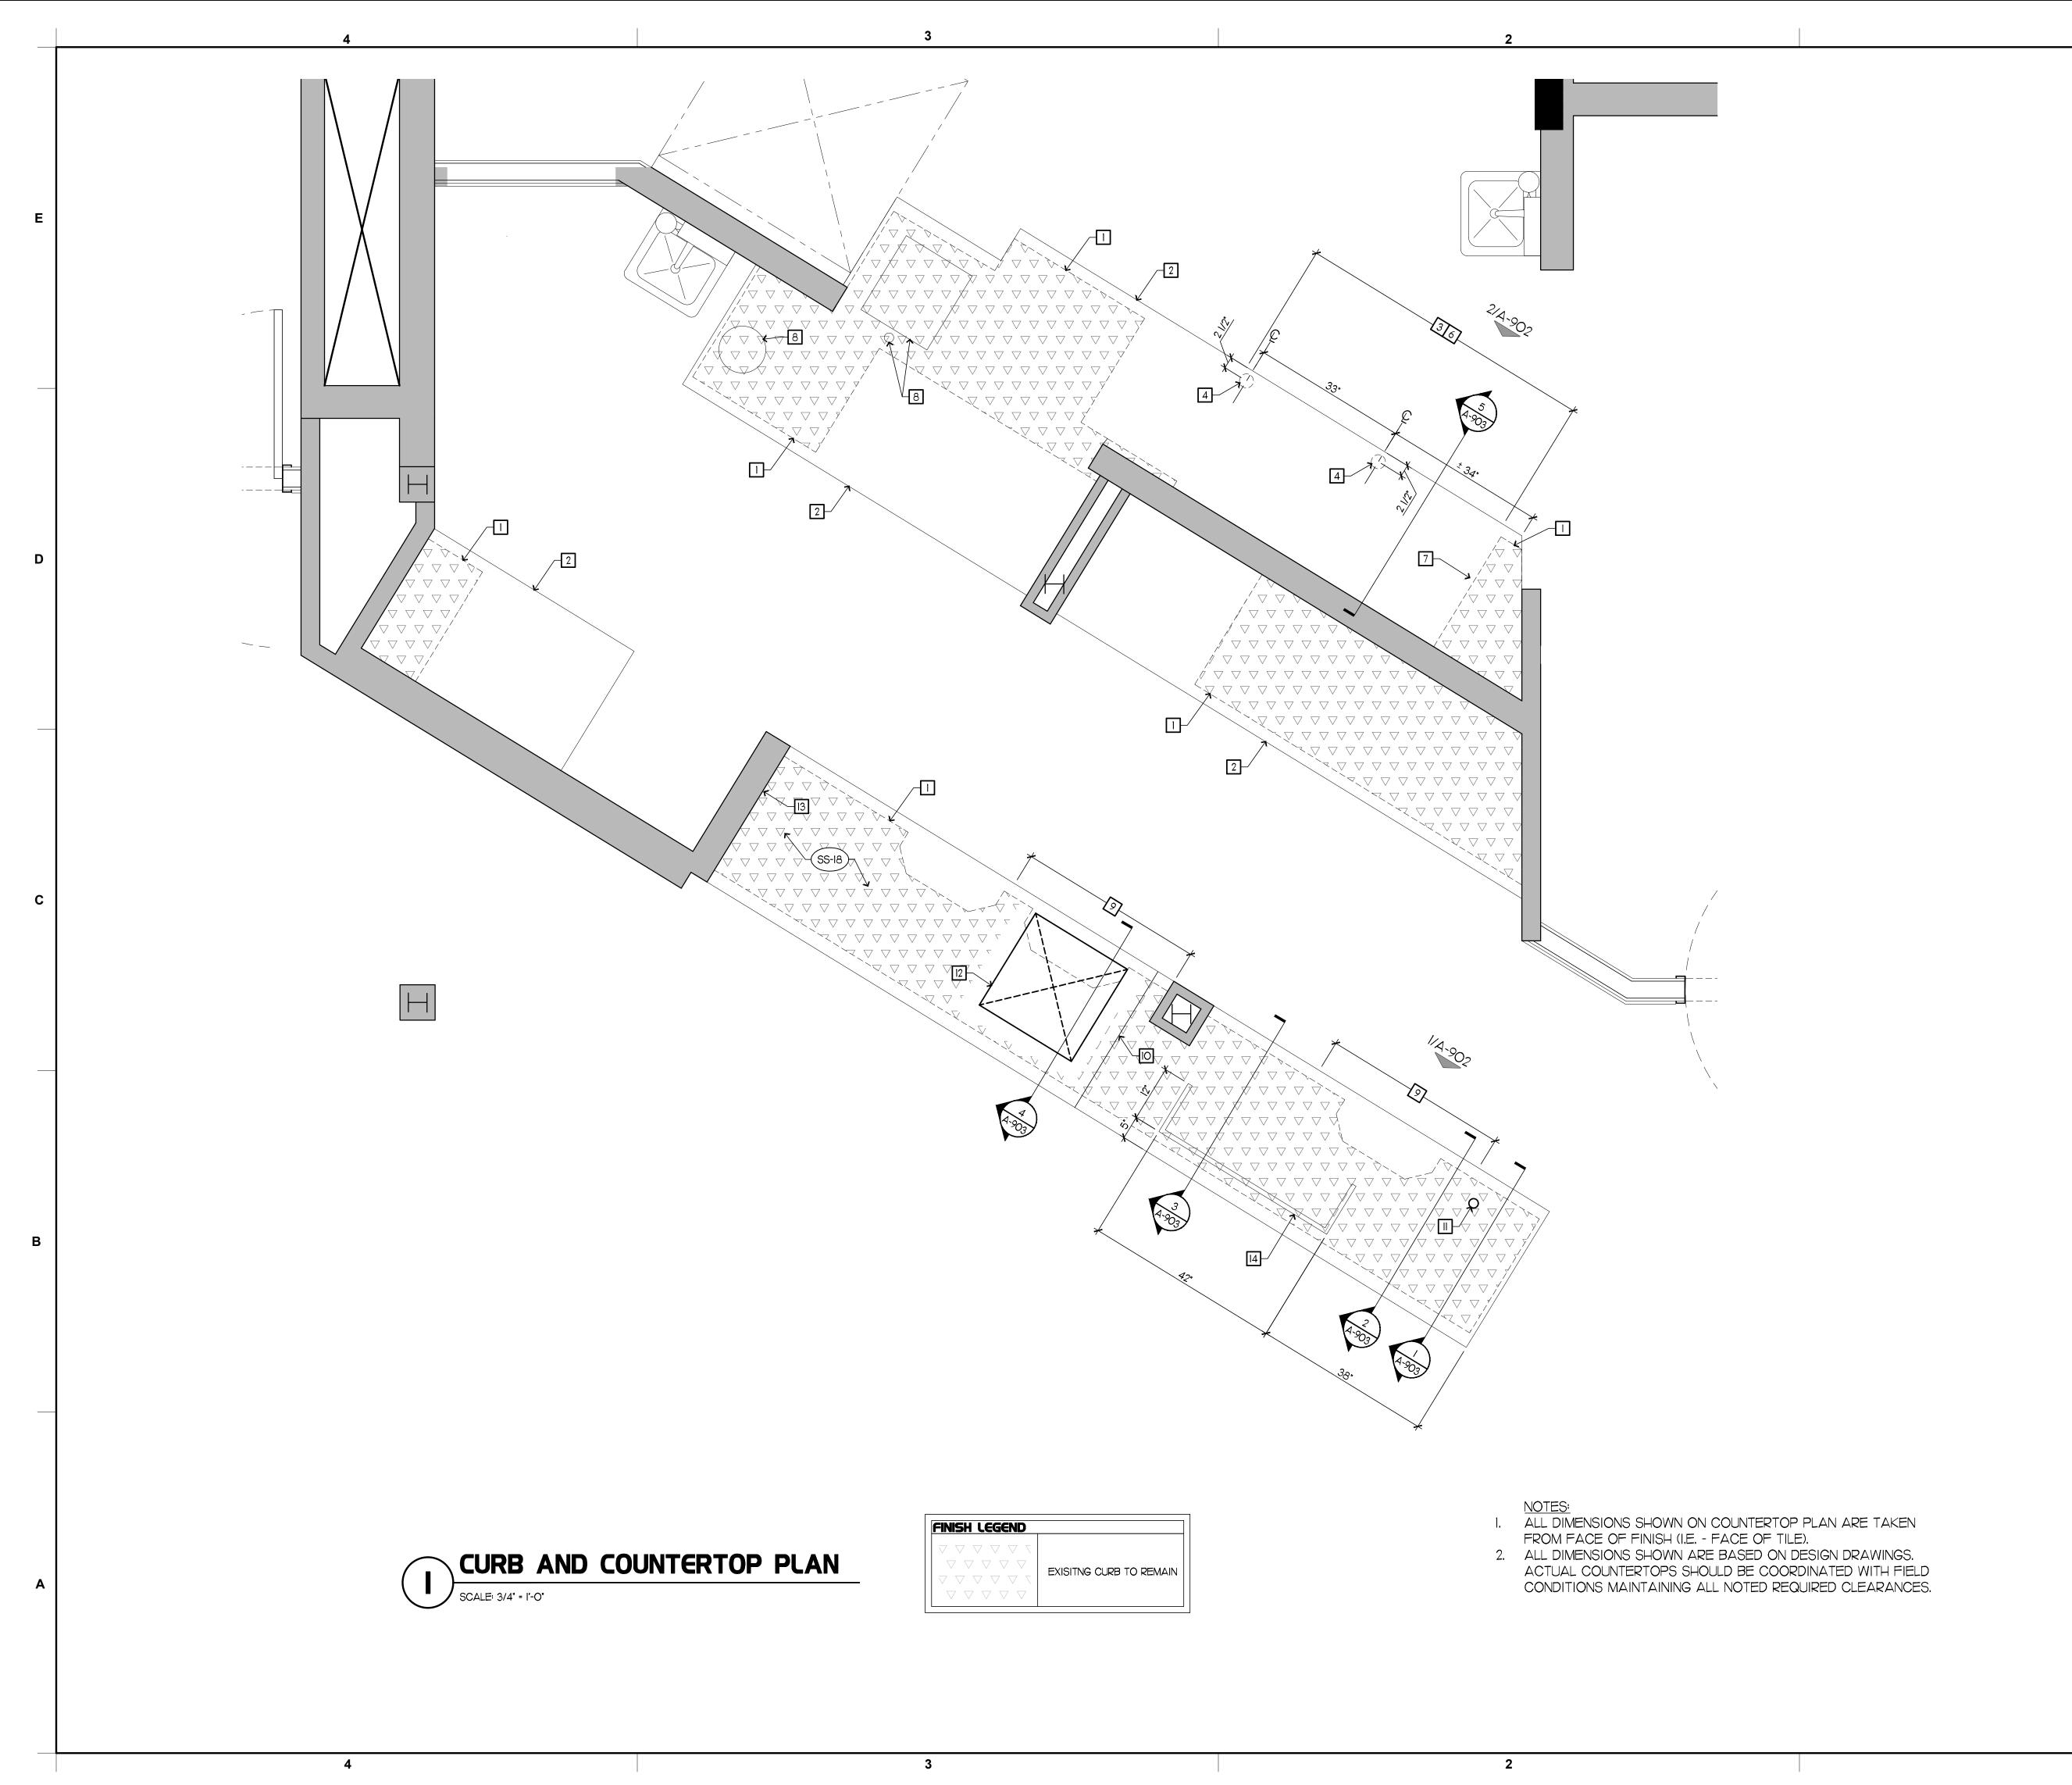

- 44.1 GENERAL CONTRACTOR IS TO ENSURE THAT MILLWORK PROVIDER SUBMITS SHOP DRAWINGS TO HILL FOLEY ROSSI FOR REVIEW AND APPROVAL PRIOR TO THE START OF MILLWORK PRODUCTION. ALLOW (5) BUSINESS DAYS FOR REVIEW.
- 44.2 GENERAL CONTRACTOR OR MILLWORK MANUFACTURER TO FIELD VERIFY DIMENSIONS OF ANY WALLS ADJACENT TO MILLWORK AFTER

GENERAL NOTES:

- ALL DIMENSIONS SHOWN ON COUNTERTOP PLAN ARE TAKEN FROM FACE OF FINISH (I.E.- FACE OF TILE), UNLESS NOTED
- ALL DIMENSIONS SHOWN ARE BASED ON DESIGN DRAWINGS. ACTUAL COUNTERTOPS SHOULD BE COORDINATED WITH FIELD CONDITIONS MAINTAINING ALL NOTED
- STAINLESS STEEL TOPS SHOULD HAVE A #4 FINISH WITH A SURFACE ROUGHNESS OF RA
- ALL SIDE AND BACK SPLASHES TO BE INTERGRAL. COORDINATE WITH MATERIAL.

- PROVIDE FOR NEW BASE TILE IN AREA WHERE MILLWORK CABINETRY WAS REMOVED
- 3" DIA. STAINLESS STEEL LEG WITH ADJUSTABLE
- MODIFIED PORTION OF MILLWORK BELOW
- NEW MILLWORK CURB, INSTALL DIRECTLY ON SLAB, NOT ON TOP OF FINISHED FLOOR, MATCH HEIGHT OF EXISTING, ADJACENT
- MODIFIED PORTION OF MILLWORK BELOW NEW COUNTERTOP
- 2" DIA. HOLE FOR ELECTRICAL CORD, PROVIDE STAINLESS STEEL GROMMET
- CUT-OUT FOR EQUIPMENT BEVERAGE SPECIFIED IN THIS PACKAGE, 24" X 24" TO COORDINATE WITH REQUIREMENTS OF EQUIPMENT SELECTED BY FOOD SERVICE
- SERVICE COUNTER

44: SHOP DRAWING NOTES

- DEMOLITION AND INSTALLATION OF NEW WALLS BUT PRIOR TO FABRICATION OF ANY MILLWORK.

NOTES: COUNTERTOP PLANS

- OTHERWISE.
- REQUIRED CLEARANCES.
- "HIDE" SEAMS IN COUNTERTOPS WHENEVER POSSIBLE, LABEL SEAM LOCATIONS ON SHOP DRAWINGS.
- 25 MICRO INCHES OR LESS (S-2)

- LINE OF EXISTING CURB BELOW
- EXISTING COUNTERTOP TO REMAIN
- ADD/MODIFY CABINET RECESSES TO ADD NEW CUP DISPENSERS, REFER ALSO TO
- EXISTING COUNTERTOP, REFER TO A-902
- EXISTING COUNTERTOP OPENING / CUTOUT AND ASSOCIATED EQUIPMENT TO REMAIN, PROTECT DEMOLITION AND CONSTRUCTION
- ASSUMED LOCATION OF SEAM IN SOLID SURFACE, MILLWORK MANUFACTURE TO COORDINATE WITH STRUCTURAL SUPPORT, "HIDE" SEAM WHENEVER POSSIBLE, LABEL SEAM LOCATIONS ON SHOP DRAWINGS
- DISPENSER (#315), BEVERAGE DISPENSER NOT OPENING SHOWN; MILLWORK MANUFACTURER
- DO NOT INSTALL SIDE SPLASH AT FRONT
- NEW SOLID SURFACE SHROUD (2 LAYERS OF 1/2" SOLID SURFACE), SET ATOP COUNTER AT LOCATION INDICATED, BOLT DOWN ON INTERIOR SIDE AS NECESSARY






Chick-fil-A **5200 Buffington Road** Atlanta, Georgia 30349-2998



Hill Foley Rossi & Associates ARCHITECTURE + ENGINEERING 3680 Pleasant Hill Road Suite 200 Duluth, GA 30096 770.622.9858

© Copyright (as dated below). This drawing and all reproductions thereof are the property of Hill Foley Rossi & Associates, LLC.(HFR). It is intended for the sole use of the project named hereon. Reproduction are to be returned to HFR upon project completion.

SEALED: 10/25/2023

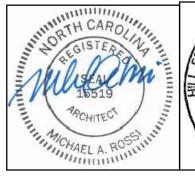



#80419

BUILDING TYPE / SIZE:

RELEASE:

REVISION SCHEDULE NO. DATE DESCRIPTION

CONSULTANT PROJECT #	21.55
PRINTED FOR	CI
DATE	10.25.202
DRAWN BY	RJE

produced for above named project may not be reproduced in any manner without express written or verbal consent from authorized project representatives. CURB AND COUNTERTOP PLAN


A901

NEW SS-18 COUNTERTOP NEW SS-18 COUNTERTOP NEW SOLID SURFACE SHROUD, BOLT DOWN (SS-18) ON INTERIOR SIDE AS NECESSARY-34" AFF TOP OF ACCESSIBLE COUNTER V.I.F. 5 3/4' DIA.
HOLE FOR
EQUIPMENT
ITEM #IO3,
TYPICAL 5 3/4" DIA. HOLE FOR EQUIPMENT _ ITEM #103, TYPICAL EXISTING MILLWORK MODIFIED EXISTING **EXISTING** MILLWORK MILLWORK MILLWORK TO REMAIN TO REMAIN UNDERNEATH TO REMAIN MODIFIED MILLWORK UNDERNEATH MILLWORK UNDERNEATH

• ALL INSIDE FACES OF EXISTING MILLWORK TO BE REPAIRED / REPLACED WITH WHITE CABINET LINER, U.N.O.

NO GAPS, CAULK ALL SEAMS, CORNERS, JOINTS, ETC.

MILLWORK ELEVATIONS: FRONT COUNTER (REAR) SCALE: 3/4" = 1'-0"

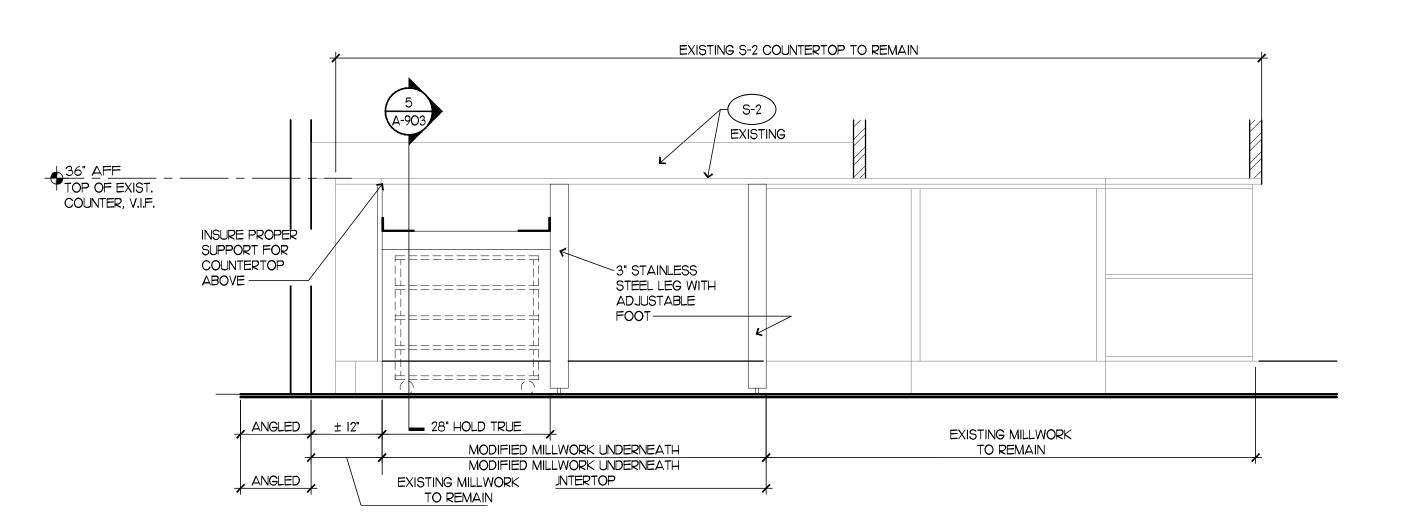

• ALL INSIDE FACES OF EXISTING MILLWORK TO BE REPAIRED / REPLACED WITH WHITE CABINET LINER, U.N.O.

• NO GAPS, CAULK ALL SEAMS, CORNERS, JOINTS, ETC.







Chick-fil-A 5200 Buffington Road Atlanta, Georgia 30349-2998





Hill Foley Rossi & Associates
ARCHITECTURE + ENGINEERING 3680 Pleasant Hill Road Suite 200 Duluth, GA 30096 770.622.9858

© Copyright (as dated below).

This drawing and all reproductions thereof are the property of Hill Foley Rossi & Associates, LLC.(HFR). It is intended for the sole use of the project named hereon. Reproduction without the written consent of HFR is unlawful. All copies are to be returned to HFR upon project completion.

SEALED: 10/25/2023

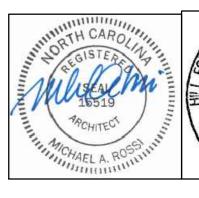

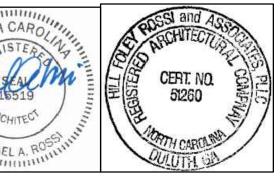

NO. DATE DESCRIPTION

CONSULTANT PROJECT #	21.554
PRINTED FOR	CD
DATE	10.25.2023
DRAWN BY	RJD
Information contained on this drawing a produced for above named project may any manner without express written or visited in the contained on	not be reproduced in

MILLWORK ELEVATIONS

NEW COUNTERTOP ON EXISTING FACE PANEL AND EXISTING MILLWORK, EXISTING #180 REINSTALLED ON NEW COUNTERTOP NEW 34" SOLID SURFACE (SS-18) COUNTERTOP — WITH INTEGRAL TURNDOWNS OVER -3/4" PLYWOOD SUBSTRATE -2" HOLE GROMMETED WITH STAINLESS STEEL GROMMET, SEE COUNTERTOP PLAN FOR LOCATION


COUNTER SECTION: CASH DRAWER

2X6 PRESSURE TREATED CURBS

BY G.C., SEE I/A901 FOR LAYOUT

COUNTER SECTION: DRINK TOWER

NEW COUNTERTOP AND CUP DISPENSERS ON EXISTING FACE PANEL AND EXISTING MILLWORK NEW 34" SOLID SURFACE (SS-18) COUNTERTOP WITH INTEGRAL TURNDOWNS OVER 3/4" PLYWOOD SUBSTRATE 3/4" MARINE GRADE PLYWOOD (SEE 10.3) COVERED WITH WHITE PLASTIC LAMINATE

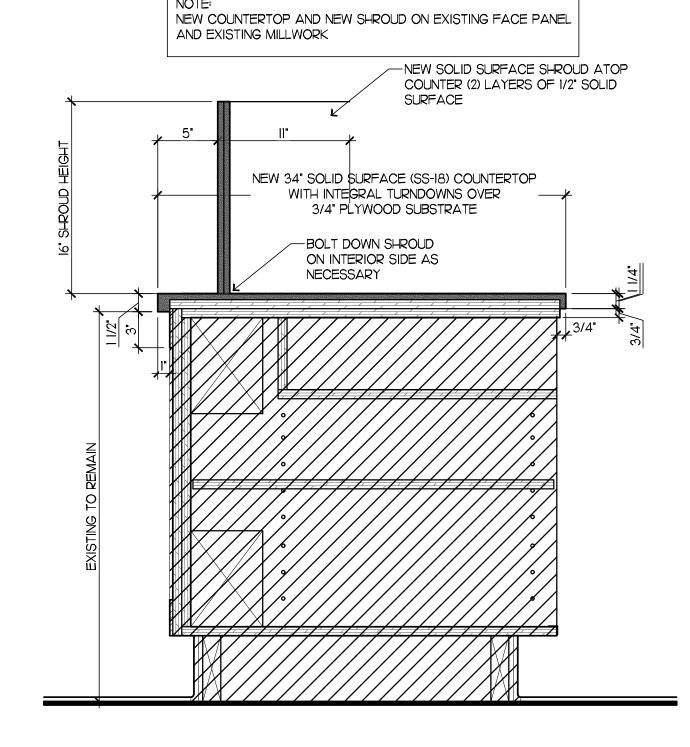

COUNTER SECTION: NEW CUP DISPENSER

COUNTER SECTION: SHROUD

NEW COUNTERTOP ON EXISTING FACE PANEL AND EXISTING MILLWORK, EXISTING #315 REINSTALLED ON NEW COUNTERTOP NEW 34" SOLID SURFACE (SS-18) COUNTERTOP WITH INTEGRAL TURNDOWNS OVER -3/4" PLYWOOD SUBSTRATE CUT OUT FOR EQUIPMENT #315, COORDINATE 3"
WITH FINAL EQUIPMENT SELECTION (24"X24" SHOWN) ELECTRICAL ELECTRICAL OUTLET CHASE-INSTALLED BY ELECTRICAL CONTRACTOR, SURFACE -3/4" MARINE GRADE PLYWOOD (SEE 10.3) MOUNTED, PROVIDE ACCESS PANEL COVERED WITH WHITE FLEXIBLE MC CONDUIT FOR PLASTIC LAMINATE, ATTACH AT BOTH WIRING, SEE ELEVATIONS SIDES OF CABINET WITH 3/4"X3/4" ON KITCHEN SHEETS FOR ALUMINUM ANGLE, PROVIDE (8) SELF HEIGHTS AND LOCATIONS-TAPPING SCREWS PER ANGLE CHASE-3" HOLE GROMMETED WITH STAINLESS STEEL GROMMET, ROUTE TO NEARBY FLOOR SINK

______ -(3) 1/8" DIAMETER PILOT | HOLES (TYPICAL) WITH #8-18 STAINLESS STEEL SELF TAPPING SCREWS, ONE AT EACH END AND ONE IN CENTER -2 I/4" X 5 I/4" X 28" ALUMINUM ANGLE ~-----EXISTING STAINLESS STEEL (S-2) COUNTERTOP 2" X 2" METAL ANGLE -SEE FINISH PLAN FOR FINISH AND SHEATHING 3" STAINLESS STEEL LEG WITH ADJUSTABLE FOOT-

COUNTER SECTION: FLOOR MOUNTED SUPPORT

IO: EQUIPMENT NOTES

SEE EQUIPMENT PLAN ON KI.I FOR EQUIPMENT LOCATIONS.

10.2 GENERAL CONTRACTOR TO COORDINATE FINAL PLACEMENT OF EQUIPMENT SO THAT ALL OPERABLE PARTS INTENDED TO BE USED BY CUSTOMERS WILL MEET "OPERABLE PARTS" AND ALL ASSOCIATED SECTIONS OF THE ACCESSIBILITY CODE LISTED ON THE COVERSHEET. NOTIFY ARCHITECT OF ANY DISCREPANCIES. 10.3 ALL PLYWOOD USED TO CONSTRUCT MAIN CABINET SECTIONS SHALL BE 3/4" MARINE GRADE PLYWOOD.

10.4 CAULK COUNTERTOP BACKSPLASH AND CABINET TO WALLS TO CLOSE ALL GAPS.

10.5 SEAL ALL PENETRATIONS IN MILLWORK. 10.6 FACES OF ALL MILLWORK TO BE EITHER WHITE PLASTIC LAMINATE TO MATCH LINER OR (PL-3) AS INDICATED

10.7 DIMENSIONS NOTED ARE TO BE MEASURED FROM TOP OF SLAB.



Chick-fil-A **5200 Buffington Road** Atlanta, Georgia 30349-2998




Hill Foley Rossi & Associates ARCHITECTURE + ENGINEERING 3680 Pleasant Hill Road Suite 200 Duluth, GA 30096 770.622.9858

This drawing and all reproductions thereof are the property of Hill Foley Rossi & Associates, LLC.(HFR). It is intended for the sole use of the project named hereon. Reproduction without the written consent of HFR is unlawful. All copies are to be returned to HFR upon project completion.

SEALED: 10/25/2023



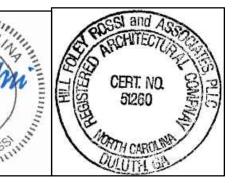

BUILDING TYPE / SIZE: RELEASE:

REVISION SCHEDULE NO. DATE DESCRIPTION

CONSULTANT PROJECT #	21.554
PRINTED FOR	CD
DATE	10.25.2023
DRAWN BY	RJD

any manner without express written or verbal consent from

MILLWORK DETAILS

TILE BASE, SEE

FINISH PLAN

A-903

5200 Buffington Road Atlanta, Georgia 30349-2998



4 _

0

2

— Ш

S

v3.21.05

 ∞ \square

RELEASE:

<u>DATE</u>

REVISION SCHEDULE

DESCRIPTION

CONSULTANT PROJECT # PRINTED FOR CONSTRUCTION DOCUMENTS 09/22/2023 DRAWN BY Information contained on this drawing and in all digital files

produced for above named project may not be reproduced in

GENERAL NOTES

SHEET NUMBER

TriMark®
Foodservice Equipment, Supplies and Design

909

CUMENTS RELEASE: **REVISION SCHEDULE** NOIT

NO. DATE DESCRIPTION CONSULTANT PROJECT # PRINTED FOR CONSTRUCTION DOCUMENTS

Information contained on this drawing and in all digital files produced for above named project may not be reproduced in any manner without express written or verbal consent from

KITCHEN EQUIPMENT PLAN

SHEET NUMBER

K-201

7 KITCHEN 1/2" = 1'-0"

ELECTRICAL CONDITIONS

6 KITCHEN 1/2" = 1'-0"

Chick-fil-A **5200 Buffington Road** Atlanta, Georgia 30349-2998



506

0

0

C

ELECTRICAL KEYNOTES LEGEND

PROVIDE A 2" CONDUIT FROM FACE OF WALL AND EXTEND CONDUIT TO JUNCTION BOX IN CEILING SPACE ABOVE TERMINATE FLUSH WITH FACE OF WALL STAINLESS STEEL COVER PLATE IN WALL

R6 PROVIDE SINGLE GANG EXTRA DEEP JUNCTION BOX MOUNTED ON THE MOUNTING PLATE WITHIN THE FRONT SERVING COUNTER CASEWORK. MOUNT BOX ADJACENT TO THE RECEPTACLE FOR EQUIPMENT 180. DO NOT MOUNT BOX BETWEEN EQUIPMENT 180 AND EQUIPMENT

(R7) PROVIDE A SINGLE GANG BOX FLUSH MOUNTED IN THE CEILING FOR THE POS DATA PLATE (BY OTHERS) FOR THE

S9 PROVIDE SINGLE GANG JUNCTION BOX WITHOUT COVERPLATE. EXTEND 1/2" CONDUIT UP IN WALL TO ABOVE ACCESSIBLE

REFER TO K-901 & K-902 FOR: - SHELVING INSTALLATION AND MOUNTING DETAILS - OEP DETAILS - DIRECT CONNECTION - ISLAND LOCATION - WATER FILTRATION DETAILS - ANSUL DETAILS

CONSULTANT PROJECT # PRINTED FOR CONSTRUCTION DOCUMENTS

BUILDING TYPE / SIZE:

REVISION SCHEDULE

RELEASE:

Information contained on this drawing and in all digital files produced for above named project may not be reproduced in any manner without express written or verbal consent from ELECTRICAL ROUGH-IN

NO. DATE DESCRIPTION

ELEVATION SHEET NUMBER

K-601

09/22/2023

ELECTRICAL LEGEND

888Aa EQUIPMENT NUMBER (R3) INDICATES NOTE ON SHEET E2 JUNCTION BOX

SIMPLEX RECEPTACLE DUPLEX RECEPTACLE SWITCH

PHONE TERMINATION OF PVC CONDUIT FOR RADIANT POS SYSTEM DOUBLE DUPLEX RECEPTACLE

SPECIAL RECEPTACLE H HUMIDITY SENSOR TEMPERATURE SENSOR

D SMOKE DETECTOR

SK SECURITY KEYPAD

LED (2 GANG BOX)

SIDE VIEW SURFACE MOUNTED RECEPTACLE

ELECTRICAL KEYNOTES LEGEND

PROVIDE SINGLE-GANG JUNCTION BOX WITH A 1" CONDUIT EXTENDING UP INTO THE CEILING SPACE FOR POS MONITOR(S). COVER PLATE PROVIDED BY OWNER'S POS SYSTEM VENDOR.

R3> PROVIDE A 2" CONDUIT FROM FACE OF WALL AND EXTEND CONDUIT TO JUNCTION BOX IN CEILING SPACE ABOVE SERVING AREA. CONDUIT SHALL TERMINATE FLUSH WITH FACE OF WALL BELOW COUNTER. CUSTOM STAINLESS STEEL COVER PLATE IN WALL WITH GROMMET ON 2" DIAMETER

HOLE AT CONDUIT TERMINATION IN WALL. R6 PROVIDE SINGLE GANG EXTRA DEEP JUNCTION BOX MOUNTED ON THE MOUNTING PLATE WITHIN THE FRONT SERVING COUNTER CASEWORK. MOUNT BOX ADJACENT TO THE RECEPTACLE FOR EQUIPMENT 180. DO NOT MOUNT BOX BETWEEN EQUIPMENT 180 AND EQUIPMENT

182 RECEPTACLES. (R7) PROVIDE A SINGLE GANG BOX FLUSH MOUNTED IN THE CEILING FOR THE POS DATA PLATE (BY OTHERS) FOR THE SALAD PREP AREA POS

MONITOR AND PRINTER. (S9) PROVIDE SINGLE GANG JUNCTION BOX WITHOUT COVERPLATE. EXTEND 1/2" CONDUIT UP IN WALL TO ABOVE ACCESSIBLE

E-SHEET STANDARDS

CEILING.

REFER TO K-901 & K-902 FOR: - SHELVING INSTALLATION AND MOUNTING DETAILS - OEP DETAILS - DIRECT CONNECTION - ISLAND LOCATION - WATER FILTRATION DETAILS - ANSUL DETAILS

BUILDING TYPE / SIZE: RELEASE: **REVISION SCHEDULE** NO. DATE DESCRIPTION 0

0

C

CONSULTANT PROJECT # PRINTED FOR CONSTRUCTION DOCUMENTS 09/22/2023

S R

v3.21.05

Information contained on this drawing and in all digital files produced for above named project may not be reproduced in any manner without express written or verbal consent from authorized project representatives. ELECTRICAL ROUGH-IN

ELEVATION SHEET NUMBER

K-602

PLUMBING LEGEND

EQUIPMENT NUMBER HOT WATER COLD WATER TEPID WATER FILTERED WATER (FW) FILTERED WATER (FW2)

PLUMBING KEYNOTES LEGEND P-5 KITCHEN HAND SINK ROUGH IN: (SINK AND FAUCET WITH 1.0 GPM AERATORFURNISHED BY OWNER) CONTRACTOR SHALL INSTALL WALL HUNG, STAINLESSSTEEL SINK AND FAUCET SET AND MAKE FINAL CONNECTIONS. PROVIDEMCGUIRE LF175 SUPPLIES WITH STOPS AND A MCGUIRE 8912 POLISHED CHROMEP-TRAP. ADJUST FAUCET OUTLET TEMPERATURE TO 100 DEGREES F (OR HIGHERAS REQUIRED BY LOCAL

JURISDICTION). P-6 SERVING COUNTER DROP IN SINK ROUGH IN: (SINK AND FAUCET WITH 1.0 GPMAERATOR FURNISHED BY OWNER) CONTRACTOR SHALL INSTALL SINK ANDFAUCET SET AND MAKE FINAL CONNECTIONS. PROVIDE MCGUIRE 8912 POLISHEDCHROME P-TRAP AND MCGUIRE LF175 STOPS WITH 20" CHROME PLATED 3/8"COPPER RISERS. ADJUST FAUCET OUTLET TEMPERATURE TO 100 DEGREES F(OR HIGHER AS REQUIRED BY LOCAL JURISDICTION).

P-7 MOP SINK FAUCET: (MOP SINK BASIN BUILT BY GENERAL CONTRACTOR) PROVIDET&S BRASS MODEL B-2345 FAUCET WITH CERAMA SPRING CHECK VALVECARTRIDGES, HOSE THREAD SPOUT OUTLET, TOP BRACE, ADJUSTABLE INLETSPREAD FROM 3" TOP 8". INCLUDE T&S BRASS MODEL 43-072 HOSE THREAD X 3/4"FEMALE NPT CHROME ADAPTOR. NO SUBSTITUTIONS. SEE ALSO P-16.

P-8 VEGETABLE PREP SINK ROUGH-IN: (SINK AND FAUCET WITH 0.65 GPM SPRAYHEAD FURNISHED BY OWNER) CONTRACTOR P-28 BALL VALVE: NIBCO MODEL 4660-T, 3/4", WITH IPS INLET AND SHALL INSTALL SINK AND MAKEFINAL CONNECTIONS. PROVIDE MCGUIRE LFST08 STOPS AND BRASSCRAFT 36"CHROME PLATED 1/2" OD COPPER RISERS MODEL 3-36AC, ASSEMBLE AND MOUNTTWO HANDLE FAUCET WITH PRE-RINSE SPRAY ARM. INSTALL ADD-ON FAUCETWITH 15" SPOUT AT BASE OF PRE-RINSE RISER. SEE K-SHEET ELEVATIONS.PROVIDE 1-1/2" SCHED 80 PVC (PIPE AND FITTINGS) INDIRECT WASTE MANIFOLDFROM SINK BASIN TO FLOOR SINK P-13B, NO P-TRAP REQUIRED. INSTALLCLEANOUT AT TURN.

(SINK AND FAUCETS WITH 0.65 GPMSPRAY HEAD FURNISHED BY OWNER) CONTRACTOR SHALL INSTALL SINK, ASSEMBLE & MOUNT TWO FAUCETS. AND MAKE FINAL CONNECTIONS. PROVIDEMCGUIRE LFST08 STOPS AND BRASSCRAFT 36" CHROME PLATED 1/2" OD COPPERRISERS MODEL 3-36AC,. ASSEMBLE AND MOUNT ONE TWO-HANDLE FAUCET WITHPRE-RINSE SPRAY. INSTALL ADD-ON FAUCET WITH 18" SPOUT AT BASE OFPRE-RINSE RISER. ASSEMBLE AND MOUNT ONE TWO-HANDLE FAUCET WITHDOUBLE JOINT SPOUT ON OPPOSITE SIDE. SEE K-SHEET ELEVATIONS FORFAUCET LOCATIONS. PROVIDE 1-1/2" SCHED 80 PVC (PIPE AND FITTINGS)INDIRECT WASTE MANIFOLD FROM EACH SINK BASIN TO FLOOR SINK

1/2" FIP INLET AND OUTLET. PROVIDECHROME WALL FORPIPING AT ICE MAKERS.

P-24 UTILITY CONNECTION (COFFEE & TEA BREWERS): PROVIDE A MCGUIRE MODELLFHST06SB LEAD-FREE CHROME WHEEL WALL ESCUTCHEON. INSTALL WITH BFP P-34.

OUTLET. FILTERED WATER FAUCET: (FAUCET PROVIDED BY OWNER) TWO-HANDLE WALLMOUNT FAUCET WITH SWING SPOUT. MOUNT ON WALL AS SHOWN ON K-SHEETS.PIPE FILTERED

SETPOINT OF 85 DEG F. MOUNTING BRACKET INCLUDED. FACTORY ASSEMBLED AND TESTED. ROUGH BRASS FINISH. NO SUBSTITUTIONS. CONTACT CHICK-FIL-A NATIONAL ACCOUNTS AT HAYNES, JONES & CADBURY FOR PRICING AND DELIVERY.

Chick-fil-A **5200 Buffington Road** Atlanta, Georgia 30349-2998

GAS

REFER TO K-901 & K-902 FOR: - SHELVING INSTALLATION AND MOUNTING DETAILS - OEP DETAILS - DIRECT CONNECTION - ISLAND LOCATION - WATER FILTRATION DETAILS - ANSUL DETAILS

PLUMBING KEYNOTES LEGEND THREE OR FOUR COMPARTMENT POT SINK ROUGH-IN: P-13A, NOP-TRAPS REQUIRED. PROVIDE CLEANOUT AT EACH

P-23 UTILITY CONNECTION (ICEMAKER): PROVIDE A MCGUIRE MODEL LFHST06SBLEAD-FREE CHROME WHEEL ANGLE STOP, ESCUTCHEON. INSTALL WITH BFP P-34. SEE DETAIL 3/P-201

ANGLE STOP, 1/2" FIP INLET ANDOUTLET. PROVIDE CHROME

WATER TO BOTH SIDES OF FAUCET. CONNECT TO SUPPLY PIPINGWITH BRASS OR CHROME NIPPLES; GALVANIZED NOT

ALLOWED. EMERGENCY THERMOSTATIC MIXING VALVE (EMERGENCY EYEWASH): BRADLEY MODEL S19-2000 EFX8 THERMOSTATIC TEMPERING VALVE (PROVIDED BY HJC). ANSI Z358.1 CERTIFIED FOR EMERGENCY FIXTURES, ASSE 1071 COMPLIANT, WITH DIAL THERMOMETER, INLET CHECK STOPS, ADJUSTABLE SETPOINT, ACCURATE WITHIN +/- 3 DEG F. INCLUDES INTEGRAL COLD WATER BYPASS WITH POSITIVE HOT WATER SHUT-OFF WHEN COLD WATER SUPPLY IS LOST. FACTORY

0 CONSULTANT PROJECT # PRINTED FOR CONSTRUCTION DOCUMENTS

C

Information contained on this drawing and in all digital files produced for above named project may not be reproduced in any manner without express written or verbal consent from authorized project representatives.

NO. DATE DESCRIPTION

PLUMBING ROUGH-IN

ELEVATION SHEET NUMBER

RELEASE:

REVISION SCHEDULE

09/22/2023

						•		,
	CONTACT CFA LICENSING TEAM AT	(800) 304-08	849 OPTION :	3 OR CFALICE	NSING@TRIMARKUSA.CO	OM AT TRIMARK STRATEGIC TO OR	RDER EQUIPMEN	IT - SOME EQUIPMENT HAS A 10 - 12 WEEK LEAD TIME
<u> </u>					MECHANIC	CAI		
				ELECTRICA		PLUMBING		\dashv \circ \mid
				ELECTRICA	_	PLUIVIDING		
4								E REMARKS
ITEM NO. G DESCRIPTION OF EQUIPMENT	APPROVED MANUFACTURER	VOLT	PH KW	AMP	$HP \mid NEMA ext{-RATING} \mid HV$	W CW FW FW2 IW DW	ROUGH-IN	REMARKS
103 8 CUP DISPENSER	SAN JAMAR MODEL #C2410C							103
122B 1 XL MENU TAB PACKAGING HOLDER	FRANKE MODEL #27807100							122B
300c 2 SINGLE-SPINDLE MIXER	HAMILTON BEACH MODEL #HMD300M-CFA							300c MOUNTED ON ITEM #300X - FRONT MOUNT
300d 1 TOPPING DISPENSER/HOLDER	ALL SOUTHERN FABRICATORS MODEL #7200-NCH							300d MOUNTED ON ITEM #300X - RIGHT HAND MOUNT - ORDER WITH 3FRA112
300f 1 DOUBLE SLIMLINE COOKIE DISPENSER	SERVER MODEL #88847							300f MOUNTED ON ITEM #300d
300X 1 DOUBLE BARREL ICE CREAM MACHINE	TAYLOR MODEL #079333BWDC (AIR COOLED)	208	3	19.00/15.00 1.5	50/1.50 15-30P/15-20P			300X PROVIDED WITH HUBBELL HBL8432C & HBL8421C ANGLE PLUGS
360e 1 HAND SINK	EAGLE MODEL #YCFA-HSAN-0004-00					2"	P-5	360e WITH SIDE MOUNTING BRACKETS
431 1 DOUBLE REFRIGERATED WORK TABLE	TRAULSEN MODEL #UHT48-ZCF-LR	115	1 0.756	6.30	0.2 5-15P			431 ORDER ON 6 IN CASTERS WITH BACKSPLASH TOP
440C 2 ICE BATH BREADING TABLE	DUKE MODEL #BSTA-120-US	120	1	1.00	5-15P			440C 10 FT CORD AND PLUG - LEAF INCLUDED WITH TABLE - INSTALL IF SHOWN ON PLANS
562A 1 HIGH DENSITY HOT HOLDING TOWER	FRANKE MODEL #18017713	120	1 1.80	16.00	5-20P			562A PROVIDED WITH 8 FT CORD AND PLUG
562AT 1 HIGH DENSITY HOT HOLDING TOWER	FRANKE MODEL #18017713	120	1 1.80	16.00	L5-20P (BY EC)			562AT EC TO CHANGE PLUG TO TWIST LOCK - PROVIDED WITH 8 FT CORD AND PLUG
634L 1 FOOD PREP TABLE	EAGLE MODEL #T3048STE-BS							634L WITH BACKSPLASH - ORDER WITH 1 5/8 IN DIAMETER LEGS
702 8 WALL MOUNT SINGLE RAIL	U-LINE MODEL #H-4681							702 <varies></varies>
703L 5 LARGE CONDIMENT BIN	CARLISLE MODEL #104976GY							703L
703M 10 MEDIUM CONDIMENT BIN	CARLISLE MODEL #104977GY							703M
703S 23 SMALL CONDIMENT BIN	CARLISLE MODEL #104978GY							703S
714 3 DUNNAGE RACK (22"x 48")	INTERMETRO							714
1121G 1 TRAY SLIDES (21" DEEP)	INTERMETRO							1121G METROSEAL GRAY - INSTALLED BETWEEN TOP TWO SHELVES OF SHELVING UNIT IN COOLER
1323W 1 FREEZER FLOOR SHELF UNIT (74" POST, 18"x42")	INTERMETRO							1323W METROSEAL GRAY - (1) 1842NK4, (3) DD9807B, (4) 74PK4, & (4) 9993S
1324W 1 FREEZER FLOOR SHELF UNIT (74" POST, 18"x48")	INTERMETRO							1324W METROSEAL GRAY - (1) 1848NK4, (3) DD9807C, (4) 74PK4, & (4) 9993S
1330 2 FLOOR SHELF UNIT (74" POST, 24"x24")	INTERMETRO							1330 METROSEAL GRAY - 2 SHELVES ABOVE DUNNAGE SHELF & 1 SHELF BELOW DUNNAGE SHELF
1330W 1 FREEZER FLOOR SHELF UNIT (74" POST, 24"x24")	INTERMETRO							1330W METROSEAL GRAY - (4) 2424NK4, (4) 74PK4, & (4) 9993S
1331 1 FLOOR SHELF UNIT (74" POST, 24"x30")	INTERMETRO							1331 METROSEAL GRAY - 2 SHELVES ABOVE DUNNAGE SHELF & 1 SHELF BELOW DUNNAGE SHELF
1332 2 FLOOR SHELF UNIT (74" POST, 24"x36")	INTERMETRO							1332 METROSEAL GRAY - 2 SHELVES ABOVE DUNNAGE SHELF & 1 SHELF BELOW DUNNAGE SHELF
1333 2 FLOOR SHELF UNIT (74" POST, 24"x42")	INTERMETRO							1333 METROSEAL GRAY - 4 SHELVES
1334 1 FLOOR SHELF UNIT (74" POST, 24"x48")	INTERMETRO							1334 METROSEAL GRAY - 2 SHELVES ABOVE DUNNAGE SHELF & 1 SHELF BELOW DUNNAGE SHELF
1351F 1 GEN3 SOLID SHELF (14"x30")	INTERMETRO							1351F SOLID - SEE INTERIOR ELEVATIONS FOR MOUNTING INFORMATION
1373 1 GEN3 SHELF (18"x42")	INTERMETRO							1373 METROSEAL GRAY - SEE INTERIOR ELEVATIONS FOR MOUNTING INFORMATION
1381 1 GEN3 SHELF (24"x30")	INTERMETRO							1381 METROSEAL GRAY - SEE INTERIOR ELEVATIONS FOR MOUNTING INFORMATION
1382 1 GEN3 SHELF (24"x36")	INTERMETRO							1382 METROSEAL GRAY - SEE INTERIOR ELEVATIONS FOR MOUNTING INFORMATION
1383 3 GEN3 SHELF (24"x42")	INTERMETRO							1383 METROSEAL GRAY - SEE INTERIOR ELEVATIONS FOR MOUNTING INFORMATION
(2.772)		L	1 1					

KITCHEN EQUIPMENT SCHEDULE (ITEMS TO BE REUSED/RELOCATED)

ALL ITEMS IN THIS SCHEDULE ARE TO BE REUSED AND CLEANED / SERVICED TO A LIKE NEW CONDITION - COORDINATE CLEANING / SERVICING WITH THE FOOD SERVICE PROVIDER - ALL NECESSARY POWER, PLUMBING, MECHANICAL INFRASTRUCTURE REQUIRED FOR THE RELOCATION OF EQUIPMENT IS THE RESPONSIBILITY OF THE FOOD SERVICE PROVIDER / GENERAL CONTRACTOR - GENERAL CONTRACTOR TO COORDINATE PROTECTION AND STORAGE OF REUSED EQUIPMENT WITH FOOD SERVICE PROVIDER DURING CONSTRUCTION

	>							MEC	CHANICAL					
	E					ELECT	RICAL				PLUN	MBING		
ITEMANO	Z DECODIDATION OF FOLLIDMENT	A DDDOV/ED MANUEA OTUDED	VOLT	DII	IOM	A N 4 D	LID	NIENAA DATING	1.11.47	E)A/ E	-14/0 114	/ D)A/	DOLLOUIN	∑ ∭
ITEM NO.	ਰ DESCRIPTION OF EQUIPMENT	APPROVED MANUFACTURER	VOLT	PH	KVV	AMP	HP	NEMA-RATING	HW CW	FVV F	· VV 2 IV	/ DW	ROUGH-IN	REMARKS
122AR	1 PACKAGING STORAGE SYSTEM	EQUIPMENT TO BE REUSED/RELOCATED												122AR
150R	1 BREAD RACK	EQUIPMENT TO BE REUSED/RELOCATED												150R
300aR	1 MILKSHAKE BASE DISPENSER	EQUIPMENT TO BE REUSED/RELOCATED	120	1		4.00		5-20P						300aR
301CR	1 CUP DISPENSER & LID ORGANIZER	EQUIPMENT TO BE REUSED/RELOCATED												301CR
310R	1 DOUBLE LEMONADE BUBBLER	EQUIPMENT TO BE REUSED/RELOCATED	120	1		8.50	0.10	5-15P						310R
315R	1 8-HEAD BEVERAGE DISPENSER WITH ICE BIN	EQUIPMENT TO BE REUSED/RELOCATED	115	1		10.00		5-15P/5-15P			3/4	."		315R
400LR	1 REACH-IN FREEZER (30" WIDE)	EQUIPMENT TO BE REUSED/RELOCATED	115	1	1.100	9.40		5-15P						400LR
431R	1 DOUBLE REFRIGERATED WORK TABLE	EQUIPMENT TO BE REUSED/RELOCATED	115	1	0.756	6.30	0.20	5-15P						431R
438R	1 33" COLD RAIL	EQUIPMENT TO BE REUSED/RELOCATED	115	1	0.800	7.10	0.25	5-15P						438R COMPRESSOR ON RIGHT
444DR	1 DOUBLE THAWING CABINET (52" WIDE)	EQUIPMENT TO BE REUSED/RELOCATED	115	1		16.00	0.5	5-20P						444DR
500AR	1 VERTICAL CONTACT TOASTER	EQUIPMENT TO BE REUSED/RELOCATED	120	1	1.80	15.00		5-15P						500AR
564AR	1 PRODUCT HOLDING CABINET	EQUIPMENT TO BE REUSED/RELOCATED	120	1	0.80	6.70		5-15P						564AR
570R	1 COOLING RACK	EQUIPMENT TO BE REUSED/RELOCATED												570R
600R	1 FLOOR MIXER	EQUIPMENT TO BE REUSED/RELOCATED	120	1		8.0	_	L5-20P						600R
607R	1 COUNTER TOP LEMON JUICER	EQUIPMENT TO BE REUSED/RELOCATED	115	1			.25	5-15P						607R
634MR	1 FOOD PREP TABLE	EQUIPMENT TO BE REUSED/RELOCATED												634MR WITH MARINE EDGE & BACKSPLASH - ORDER ON 5" CASTERS

EQUIPMENT SCHEDULE (ITEMS SUPPLIED BY GENERAL CONTRACTOR / FOOD SERVICE PROVIDER)

		.				AL	MECHANIC						-	}-
		8		PLUMBING				CAL	ELECTRI					
DEMARKO.	j j	ΨЩ	DOLLOLLIN	A/O 1)A/	E) 4 /		DATING		A	101	VOLT	A DDD OVED MANUEA OTUBED	DESCRIPTION OF FOLUBRIENT	-
REMARKS	: REMARI		ROUGH-IN	V2 IW DW	FVV	CVV	-RATING HV	HP	AMP	KW	VOLT P	APPROVED MANUFACTURER	DESCRIPTION OF EQUIPMENT	EM NO. る
	0	150										LOCAL SUPPLIER	BREAD RACK	150 1
	PA	202A										RUBBERMAID MODEL #1971258	UNDER-COUNTER SLIM JIM TRASH CAN	202A 1
HEIGHTS AND LOCATIONS	RE: ARCHITECTURAL SHEETS FOR DETAILS ON MOUNTING HEIGHTS AND LOCA	206 F										ECOLAB MODEL#92021189	SOAP DISPENSER	206 1
	5	225										PITCO FRIALATOR MODEL FAT VAT	FAT VAT	225 1
	9 SEE DETAILS PAGE K-901 FOR TYP.	359										GC/FSP VENDOR	WALL MOUNTED SPLASH GUARD	359 1
	E TO BE MOUNTED TO WALL BETWEEN 33 IN AND 45 IN AFF	360E	P-42									ACORN MODEL #S0660-RH	EMERGENCY EYEWASH STATION	360E 1
	Fe Fe	360Fe	P-5			1/2"	1/2					IK TOTO MODEL #TEL165-C20E#CP	SENSOR FAUCET FOR WALL MOUNTED HAND SINK	360Fe 1
HEIGHTS AND LOCATIONS	RE- ARCHITECTURAL SHEETS FOR DETAILS ON MOUNTING HEIGHTS AND LOCA	660 F										SAN JAMAR #T1490TBK	PAPER TOWEL DISPENSER	660 1



Chick-fil-A 5200 Buffington Road Atlanta, Georgia 30349-2998



REVISION SCHEDULE

CONSULTANT PROJECT # PRINTED FOR CONSTRUCTION DOCUMENTS 09/22/2023

Information contained on this drawing and in all digital files produced for above named project may not be reproduced in any manner without express written or verbal consent from

EQUIPMENT SCHEDULE

HON

TO ORDER EQUIPMENT CONTACT DONALD WILSON AT CLAYTON FIXTURE (404) 363-1665 - DONALD.WILSON@ACCESSCFA.COM - EQUIPMENT HAS A 6 WEEK LEAD TIME MINIMUM

MECHANICAL ELECTRICAL PLUMBING APPROVED MANUFACTURER REMARKS DESCRIPTION OF EQUIPMENT 105d 1 PACKAGE BAG HOLDER CLAYTON FIXTURE

EQUIPMENT SCHEDULE (ITEMS SUPPLIED BY MILLWORK MANUFACTURER)

IF CLAYTON FIXTURE IS PROVIDING ALL THE MILLWORK IN THE MILLWORK PACKAGE, PLEASE CONTACT DONALD WILSON AT CLAYTON FIXTURE (404) 363-1665 - DONALD.WILSON@ACCESSCFA.COM - IF NOT, PLEASE CONTACT THE GENERAL CONTRACTOR

		<u>></u>				MECHANICA	AL			
		드 는 Z			ELECTRICAL		PLUMB	ING		
ITEM	I NO.	₹ O DESCRIPTION OF EQUIPMENT	APPROVED MANUFACTURER	VOLT PH KW	AMP HP	NEMA-RATING HW	CW FW FW2 IW	DW ROUGH-IN	∑ Ш <u>H</u> REMARKS	
10)1	1 FRONT SERVING COUNTER	G.C./MILLWORK MANUFACTURER	-	-				101 REFER TO MANUFACTURER SHOP DRAWINGS	

	EQUIPMENT SCHEDULE (FUTURE ITEMS)										
	MECHANICAL .										
	트	RICAL		PLUMBING		9					
	NA								Σ		
ITEM NO.	DESCRIPTION OF EQUIPMENT	APPROVED MANUFACTURER	VOLT PH K	W AMP	HP NEMA-RATING	HW CW	FW FW2 IW DW	ROUGH-IN		REMARKS	
F182L	1 LABEL PRINTER	GC/FSP VENDOR	120 1	1.7	5-20P				F182L	PROVIDE WITH 120V/24V POWER SUPPLY ADAPTER FOR USE WITH 120V IG OUTLET	
F183	1 ORDER MONITOR	GC/FSP VENDOR	120 1	0.10	5-20P				F183		1
F183a	1 FUTURE RADIAL ARM	GC/FSP VENDOR							F183a	USED TO MOUNT ORDER MONITORS - NOT SHOWN IN PLAN	

	GRUB HUB MASTER EQUIPMENT SCHEDULE									
ITEM NO.	QUANTITY	DESCRIPTION OF EQUIPMENT	REMARKS							
181	1	CASH DRAWER	REFER TO MANUFACTURER SHOP DRAWINGS							
182B	1	BT CLOUD PRINTER	REFER TO MANUFACTURER SHOP DRAWINGS							
182L	5	LABEL PRINTER	REFER TO MANUFACTURER SHOP DRAWINGS							
187A	1	BEVERAGE KDS MONITOR	INCLUDES CHROMEBOX (GRC-0000029), KEYBOARD (GRC-0000070) AND BUMP BAR (GRC-0000030C)							
187a	6	WALL MOUNT KDS ARM	USED TO MOUNT ORDER MONITORS - ORDER MODEL #GH7000-1000 WITH WALL FLEXMOUNT AND KC3 BRACKET - NOT SHOWN IN PLAN							
187B	1	DESSERT KDS MONITOR	INCLUDES CHROMEBOX (GRC-0000029), KEYBOARD (GRC-0000070) AND BUMP BAR (GRC-0000030C)							
187b	1	KDS MOUNTING POLE - ISLAND APPLICATION	USED TO MOUNT ORDER MONITORS - TBD							
187C	1	EXPO 1 KDS MONITOR	INCLUDES CHROMEBOX (GRC-0000029), KEYBOARD (GRC-0000070) AND BUMP BAR (GRC-0000030C)							
187c	1	COUNTER MOUNT KDS ARM	USED TO MOUNT ORDER MONITORS - ORDER MODEL #GH7000-1000 WITH GROMMET HOLE FLEXMOUNT, KC3 BRACKET AND (2) #8171-6 EXTENDER TUBES - NOT SHOWN IN PLAN							
187D	1	EXPO 2 KDS MONITOR	INCLUDES CHROMEBOX (GRC-0000029), KEYBOARD (GRC-0000070) AND BUMP BAR (GRC-0000030C)							
187E	1	FRY KDS MONITOR	INCLUDES CHROMEBOX (GRC-0000029), KEYBOARD (GRC-0000070) AND BUMP BAR (GRC-0000030C)							
187F	1	PRIMARY BOARDS KDS MONITOR	INCLUDES CHROMEBOX (GRC-0000029), KEYBOARD (GRC-0000070) AND BUMP BAR (GRC-0000030C)							
187G	1	SECONDARY BOARDS KDS MONITOR	INCLUDES CHROMEBOX (GRC-0000029), KEYBOARD (GRC-0000070) AND BUMP BAR (GRC-0000030C)							
187H	1	CONSOLIDATED DISPLAY KDS MONITOR - ARAMARK ONLY	INCLUDES CHROMEBOX (GRC-0000029), KEYBOARD (GRC-0000070) AND BUMP BAR (GRC-0000030C)							
188	1	POS KIOSK	REFER TO MANUFACTURER SHOP DRAWINGS							
189	3	CUSTOMER-FACING KIOSK	REFER TO MANUFACTURER SHOP DRAWINGS							
673	1	CDS MONITOR	REFER TO MANUFACTURER SHOP DRAWINGS; ALL CDS MONITORS INCLUDE A CHROMEBOX (GRC-0000029) AND KEYBOARD (GRC-0000070)							



Chick-fil-A 5200 Buffington Road Atlanta, Georgia 30349-2998



REVISION SCHEDULE

CONSULTANT PROJECT # PRINTED FOR CONSTRUCTION DOCUMENTS

produced for above named project may not be reproduced in any manner without express written or verbal consent from

EQUIPMENT SCHEDULE

NOIT



— ELECTRICAL CONDUIT — ELECTRICAL BOX In Case of FIRE LINE OF ANSUL FIXTURE eq PULL)、□ANSUL / FIRE SUPPRESSION NOTES: 1. REFER TO KITCHEN ELEVATIONS FOR ANSUL FIX I 2. G.C. TO COORDINATE ELECTRICAL BOX REQUIREMEN. 3. VERIFY NECESSARY ORIENTATION OF ELECTRICAL BOX W1. MOUNTING HARDWARE PRIOR TO INSTALLATION. 4. ELECTRICAL BOX AND ALL ASSOCIATED CONDUIT TO BE RECESSEL ANSUL PULL MOUNTING DETAIL

SCALE: N.T.S.

EQUIPMENT ITEM'S ELECTRICAL CORD O BE CONNECTED TO THE BELL BOX OUNTED ON TOP-REAF THE ITEM


WEATHER-PR'
(TO REDUCF
TURNING P
GRADE SV.
SECTION 1614
SPECIFICATIONS.,

SCALE: N.T.S.


FLEXIBLE CONDUIT ELBOW

SURFACE MOUNTED SINGLE GANG BELL BU, MOUNTED TO THE TOP-REAR OF THE EQUIPME, ITEM AT THE POINT OF THE POWER CONNECTION.


6'-0" FLEXIBLE LIQUID-TIGHT METAL CONDUIT FROM OEP DROP CORD BOX FLUSH IN CEILING BOX TO THE KITCHEN EQUIPMENT ITEM.

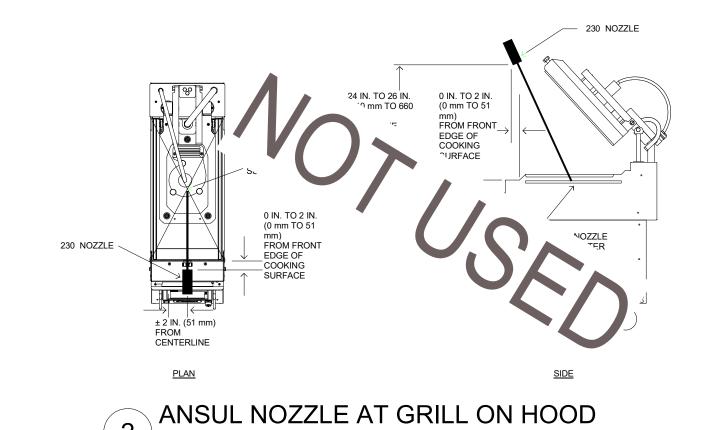


INSTALL WATER FILTER MINIMUM 10" BELOW SLAB. COORDINATE LOCATION

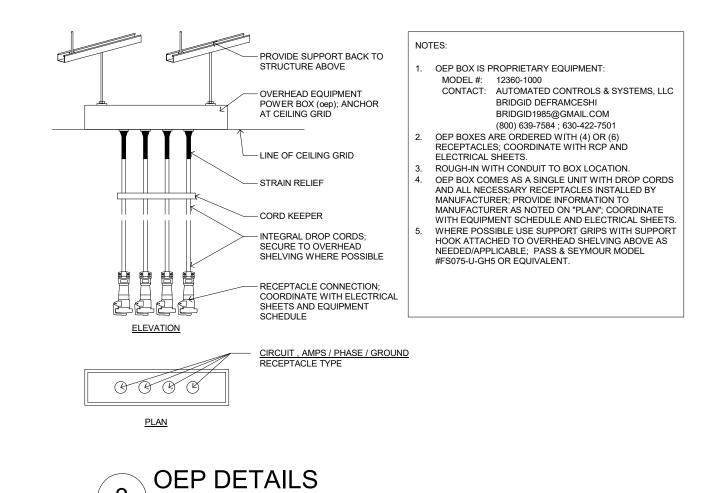


SCALE: N.T.S.

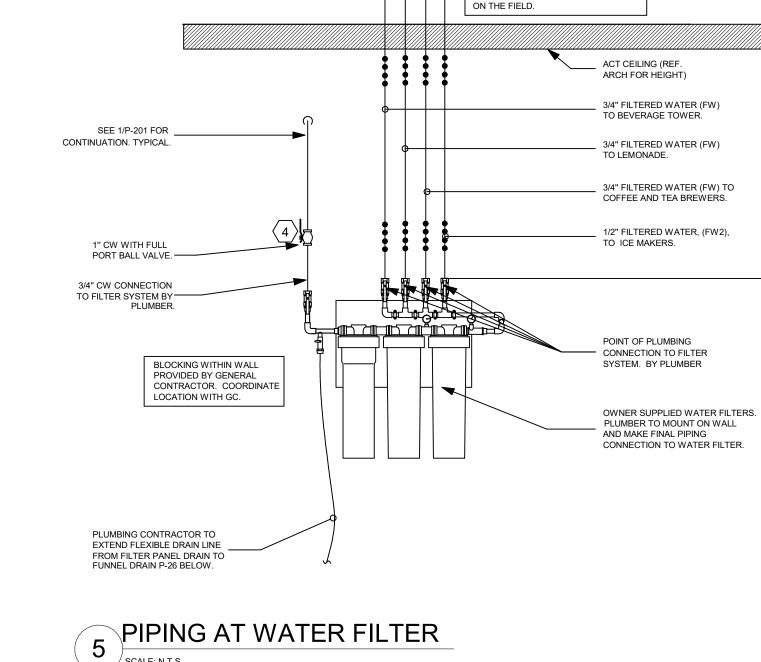


SCALE: N.T.S.

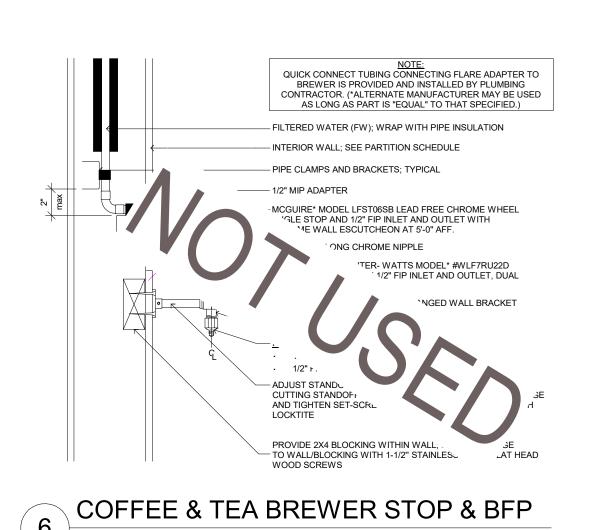


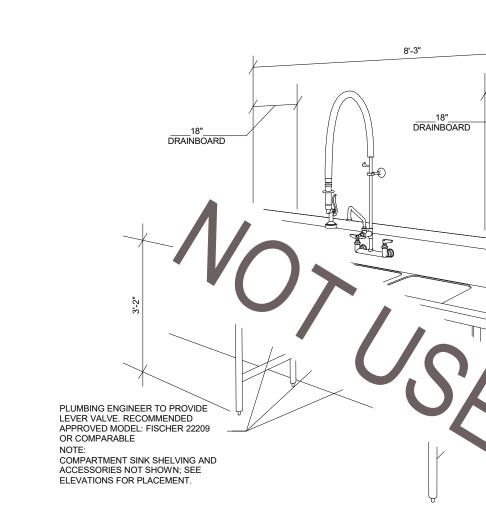

SCALE: N.T.S.

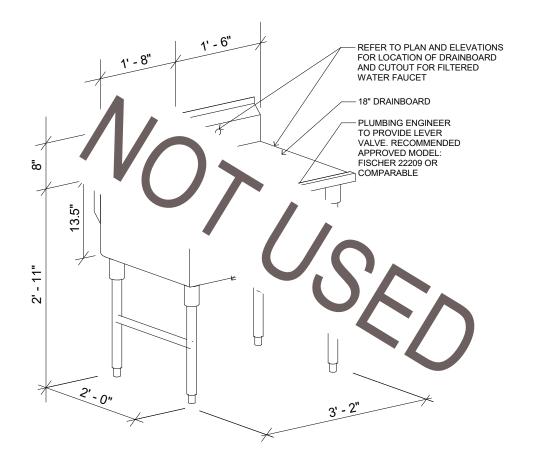




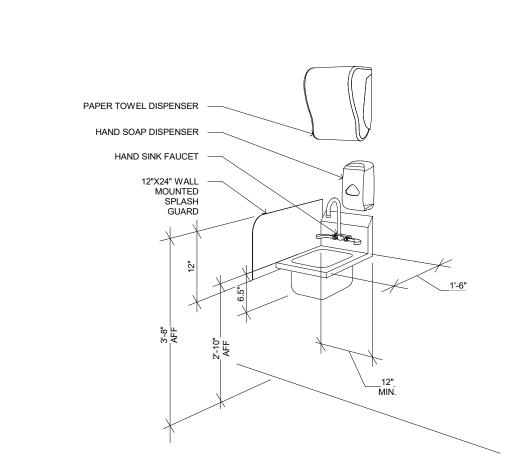

DIRECT CONNECTION - ISLAND LOCATION



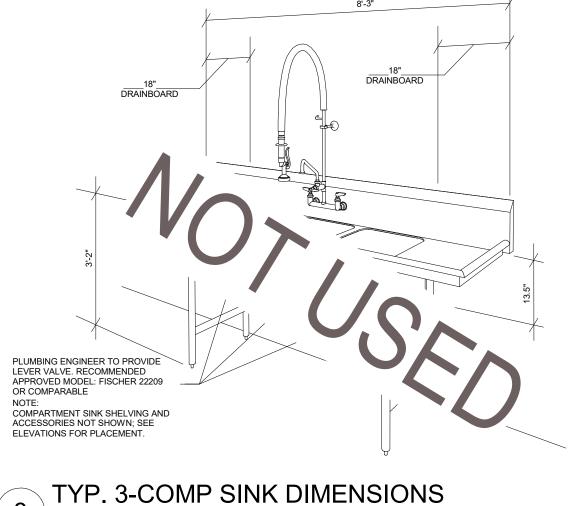

TOP OF OUTLET VALVES

* INFORMATION ON THIS SHEET IS FOR REFERENCE ONLY - SEE MANUFACTURER DOCUMENTATION FOR FINAL INSTALLATION INSTRUCTIONS AND OTHER DETAILS

Chick-fil-A **5200 Buffington Road** Atlanta, Georgia 30349-2998

506

CUME

HON

0

C

RELEASE: v3.21.05 REVISION SCHEDULE

DESCRIPTION

CONSULTANT PROJECT # PRINTED FOR CONSTRUCTION DOCUMENTS 09/22/2023 Information contained on this drawing and in all digital files

produced for above named project may not be reproduced in any manner without express written or verbal consent from KITCHEN DETAILS

SHEET NUMBER K-901

506

RELEASE:

CUME

NOIT

REVISION SCHEDULE

CONSULTANT PROJECT # PRINTED FOR CONSTRUCTION DOCUMENTS 09/22/2023

produced for above named project may not be reproduced in any manner without express written or verbal consent from

KITCHEN DETAILS

SHEET NUMBER

K-902

506

RELEASE: **REVISION SCHEDULE**

CONSULTANT PROJECT # PRINTED FOR CONSTRUCTION DOCUMENTS

produced for above named project may not be reproduced in any manner without express written or verbal consent from

KITCHEN DETAILS


SHEET NUMBER K-903 HOOK TOP CLIP TO PLEXIGLASS (x2)
THEN SLIDE OVER TOP OF TOP SHELF

SHELF (


PLEXIGLASS PANELS

WIRE SHELF SHELF HEIGHTS 86" UPRIGHT TASK LIGHT MOUNTING BRACKET PLEXIGLASS PANELS WIRE SHELF DIVIDER TASK LIGHT BY OTHERS SHELF MOUNT HOOK & LOCKING WEDGE CROSS BAR & BRACE KIT LEG LOW-PROFILE LEG




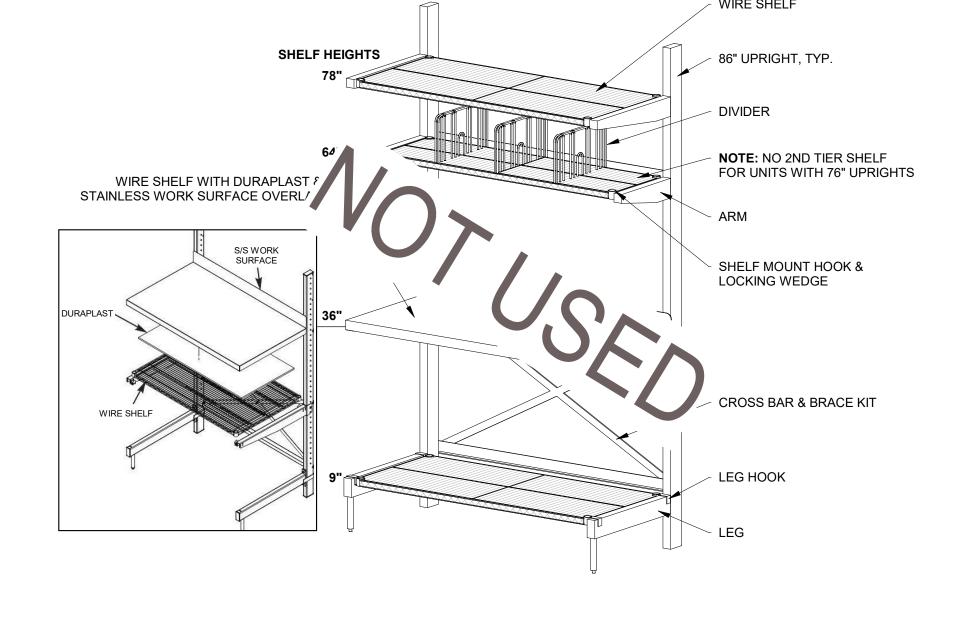


CANTILEVER SHELVING - WORK SURFACE

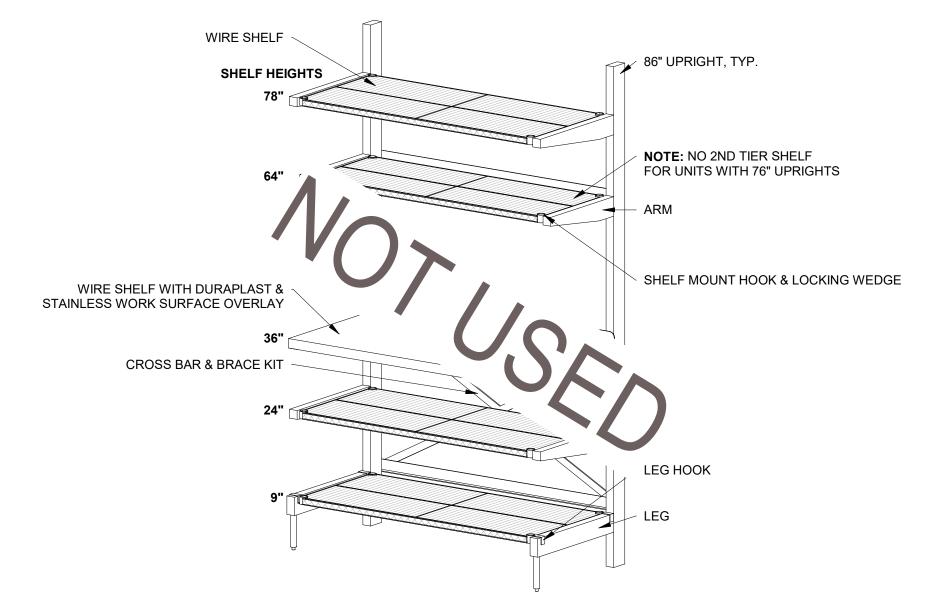



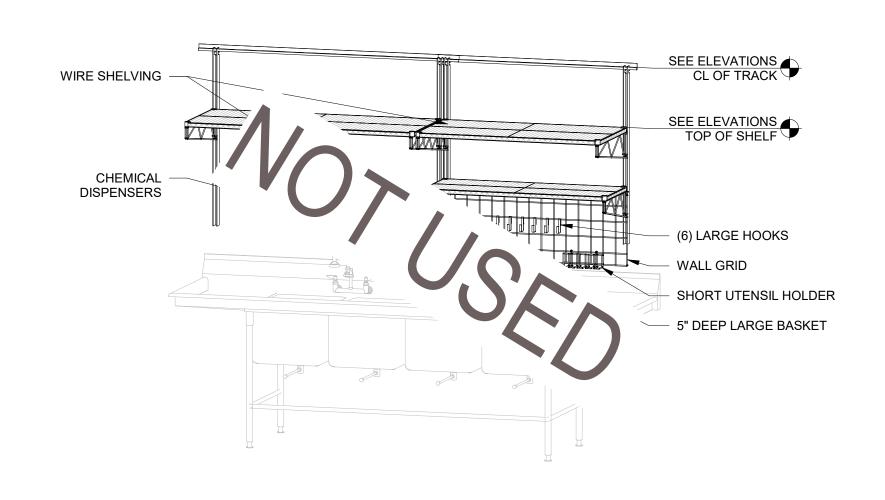


4 COMP UTILITY SINK SHELVES & ACCESSORIES

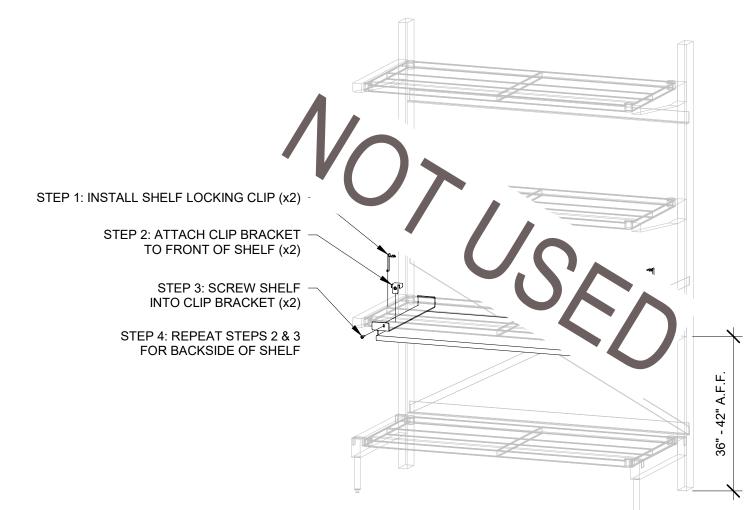

PULL-OUT SHELF

NOTE: 4-TIER SHELF SHOWN FOR REFERENCE ONLY. PULL-OUT WORK SURFACE TO BE INSTALLED ON 3RD TIER OF 5-TIER SHELVING UNITS.

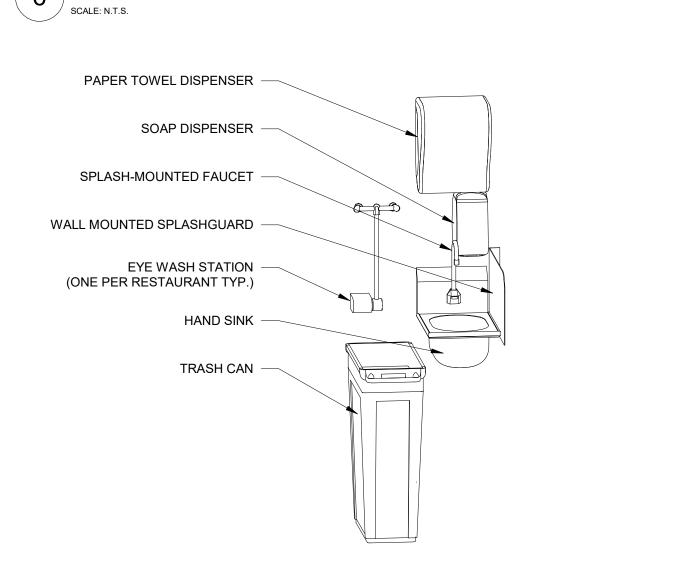

HAND SINK & ACCESSORIES

* INFORMATION ON THIS SHEET IS FOR REFERENCE ONLY - SEE MANUFACTURER DOCUMENTATION FOR FINAL INSTALLATION INSTRUCTIONS AND OTHER DETAILS

Chick-fil-A **5200 Buffington Road** Atlanta, Georgia 30349-2998

27506

REVISION SCHEDULE

CUME


NOIT

CONSULTANT PROJECT # PRINTED FOR CONSTRUCTION DOCUMENTS

produced for above named project may not be reproduced in any manner without express written or verbal consent from

KITCHEN DETAILS C

> SHEET NUMBER K-904

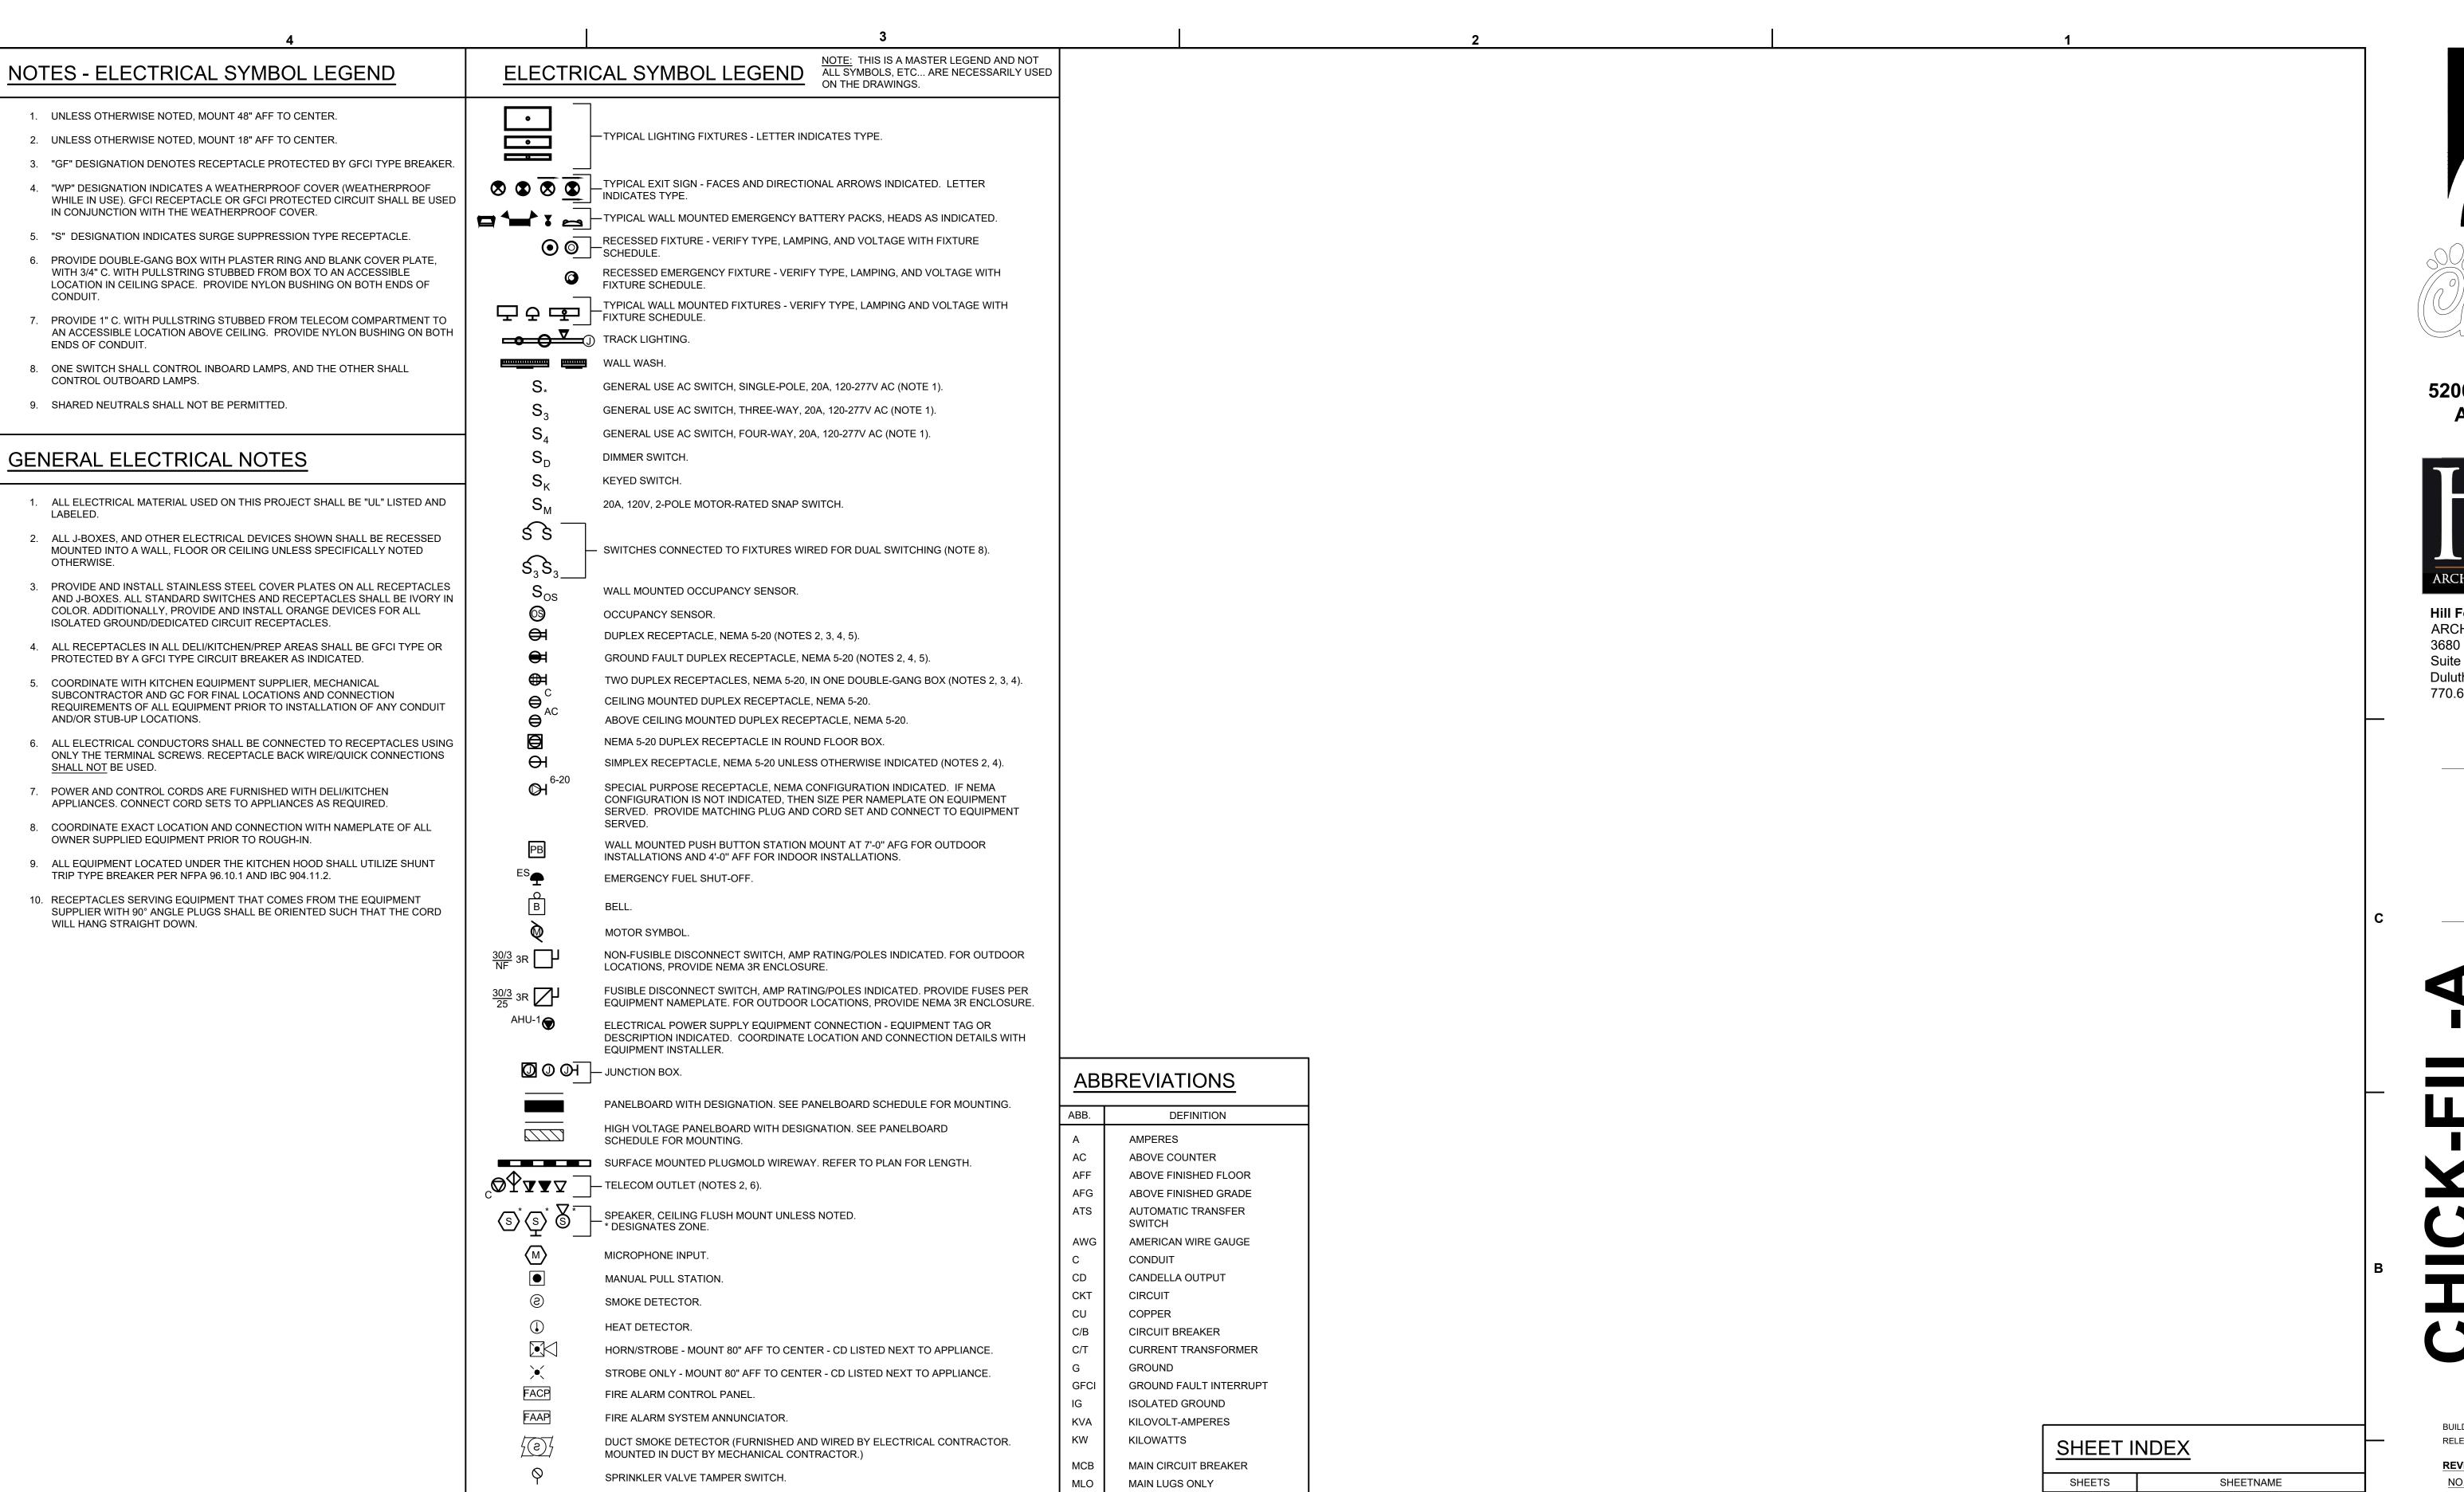

NC

NTS

POS

RIP

UNO

WP

XFMR

SPRINKLER FLOW SWITCH.

CONDUIT UNDER SLAB/GROUND.

ONE HOMERUN CIRCUIT - PANEL AND CIRCUIT NUMBER INDICATED.

TWO HOMERUN CIRCUITS - PANEL AND CIRCUIT NUMBERS INDICATED (NOTE 9).

THREE HOMERUN CIRCUITS - PANEL AND CIRCUIT NUMBERS INDICATED (NOTE 9).

CONCEALED CONDUIT.

EXPOSED CONDUIT.

NORMALLY CLOSED

NIGHT LIGHT CIRCUIT

NORMALLY OPEN

NOT TO SCALE

POINT OF SALE

IN-USE COVER

TRANSFORMER

ROUGH IN POINT

UNLESS NOTED OTHERWISE

WEATHERPROOF-PROVIDE WITH

WEATHERPROOF WITH GROUND

FAULT INTERRUPT-PROVIDE

WITH IN-USE COVER

NOTE TO CONTRACTOR:

DUE TO LACK OF CURRENT AS-BUILT DRAWINGS, ELECTRICAL

CONTRACTOR SHALL HAVE THE RESPONSIBILITY OF VERIFYING

PLANS WERE PRODUCED USING DATA FROM THE ORIGINAL

DESIGN DOCUMENTS. ALL PANEL DESIGNATIONS, CIRCUIT

IDENTIFIERS AND EXISTING LOADS ARE ASSUMED.

ALL INFORMATION PRIOR TO BIDDING AND ROUGH-IN.

PHASE

VOLTS

WATTS

WYE

SHEET I	NDEX	
SHEETS	SHEETNAME	
E0	ELECTRICAL SYMBOL LEGEND AND NOTES	
E1	FLOOR PLAN - LIGHTING	
E2	FLOOR PLAN - POWER	
E3	ELECTRICAL EQUIPMENT SCHEDULES AND DETAILS	
E4	ELECTRICAL PANEL SCHEDULE AND RISER	4



ENGINEERS & CONSULTANTS 923 MAIN STREET, NORTH WILKESBORO, NC 28659 NC - BUSINESS FIRM

This item has been signed and sealed by

Digital Signature and date. Printed copies

Christopher G. Anderson PE using a

of this document are not considered signed and sealed and the signature must

be verified on any electronic copies.

PHONE: 336-667-4225





Chick-fil-A 5200 Buffington Road Atlanta, Georgia 30349-2998



Hill Foley Rossi & Associates ARCHITECTURE + ENGINEERING 3680 Pleasant Hill Road Suite 200 Duluth, GA 30096 770.622.9858



BUILDING TYPE / SIZE: RELEASE:

REVISION SCHEDULE NO. DATE DESCRIPTION

CONSULTANT PROJECT # 21.554 PRINTED FOR CD 09.22.2023 DRAWN BY

Information contained on this drawing and in all digital files any manner without express written or verbal consent from authorized project representatives.

ELECTRICAL SYMBOL LEGEND AND NOTES SHEET NUMBER



GENERAL ELECTRICAL NOTES

COORDINATE EXACT LOCATIONS OF ALL LIGHTING FIXTURES WITH FINAL REFLECTED CEILING PLAN PROVIDED BY ARCHITECT.

KEYED NOTES

- (1) EXISTING LIGHTING TO REMAIN IN SERVICE.
 CONTRACTOR SHALL CLEAN AND RELAMP AS
 DIRECTED.
- 2 EXISTING LIGHTING TO BE REMOVED FROM SERVICE. CONTRACTOR SHALL ENSURE THAT ANY FIXTURES SHARING THIS CIRCUIT THAT ARE TO REMAIN IN SERVICE CONTINUE TO BE OPERATIONAL AND FUNCTION AS ORIGINALLY INTENDED.





Chick-fil-A 5200 Buffington Road Atlanta, Georgia 30349-2998



Hill Foley Rossi & Associates ARCHITECTURE + ENGINEERING 3680 Pleasant Hill Road Suite 200 Duluth, GA 30096 770.622.9858



#80419

BUILDING TYPE / SIZE:

RELEASE:

REVISION SCHEDULE NO. DATE DESCRIPTION

CONSULTANT PROJECT # 21.554 PRINTED FOR CD 09.22.2023

DRAWN BY Information contained on this drawing and in all digital files produced for above named project may not be reproduced in any manner without express written or verbal consent from authorized project representatives.

FLOOR PLAN - LIGHTING

SHEET NUMBER

This item has been signed and sealed by Christopher G. Anderson PE using a Digital Signature and date. Printed copies of this document are not considered signed and sealed and the signature must be verified on any electronic copies.

PAGE INTERWORKS, P.A. ENGINEERS & CONSULTANTS

923 MAIN STREET, NORTH WILKESBORO, NC 28659 NC - BUSINESS FIRM # C-1304 PHONE: **336-667-4225** NC - BUSINESS FIRM # C-1304 JUNE 30, 2024

E1

EQUIPMENT TAG - REFER TO ELECTRICAL ALL RECEPTACLES AND ELECTRICAL DEVICES CONTRACTOR SHALL COORDINATE RECEPTACLE SHOWN IN MILLWORK SHALL BE INSTALLED PER AND DEVICE LOCATIONS WITH ELEVATIONS **EQUIPMENT SCHEDULE SHEET E3 FOR ALL** ELEVATIONS SHOWN ON THE ARCHITECTURAL K SHOWN ON THE ARCHITECTURAL K-SERIES ELECTRICAL EQUIPMENT REQUIREMENTS SHEETS. DIMENSIONS AND HEIGHTS SHOWN ON INCLUDING MOUNTING HEIGHT, NEMA PLUG SERIES DRAWINGS. PROVIDE WHIP CONNECTORS CONFIGURATION AND BREAKER REQUIREMENTS -TO MILLWORK AS NECESSARY. K-SHEET ELEVATIONS TAKE PRECEDENCE OVER (TYPICAL FOR ALL EQUIPMENT WITH TAGS). SEE MOUNTING HEIGHTS SHOWN IN PLAN VIEW. GENERAL NOTE #2 AND #8 ON SHEET E0. CONTRACTOR SHALL PROTECT ALL FIRE ALARM SYSTEM DEVICES FROM DAMAGE DURING THE DEMOLITION AND REMODELING WORK. ALL FIRE ALARM SYSTEM DEVICES TO REMAIN IN SERVICE. FREEZERS. SHALL BE "UL" LISTED AND LABELED. 000 NOT BE USED. PRIOR TO ROUGH-IN. 96.10.1 AND IBC 904.11.2. $\langle 1 \rangle$ NOT USED. INFORMATION. 4 NOTUSED. PANEL AA RECEPTACLE. FLEXIBLE CONDUIT. 7 NOT USED. 8 NOT USED. 9 NOT USED. 10 NOT USED. (14) NOT USED. NOT USED. 1 FLOOR PLAN - POWER INTERWORKS, P.A. This item has been signed and sealed by Christopher G. Anderson PE using a Digital Signature and date. Printed copies of this document are not considered signed and sealed and the signature must be verified on any electronic copies. PHONE: 336-667-4225

GENERAL ELECTRICAL NOTES

- DURING UNDER SLAB ROUGH-IN, PLAN FOR OUTLETS THAT MUST BE FED WITH CONDUIT FROM UNDER SLAB (FOR EXAMPLE, OUTLETS IN FREE-STANDING CASES, OR OUTLETS BELOW WINDOWS THAT CANNOT BE FED WITH HORIZONTAL CONDUIT IN WALL DUE TO STEEL COLUMNS ON BOTH SIDES OF WINDOW).
- PROVIDE SEAL FITTINGS WITH SEALING COMPOUND AT CONDUIT ENTRIES TO WALK-IN COOLERS AND
- FOR OUTLETS OR CONNECTIONS WITH EQUIPMENT TAGS, COORDINATE MOUNTING HEIGHTS AND LOCATIONS WITH INSTALLATION OF EQUIPMENT.
- 4. ALL ELECTRICAL MATERIAL USED ON THIS PROJECT
- ALL J-BOXES, AND OTHER ELECTRICAL DEVICES SHOWN
- SHALL BE RECESSED MOUNTED INTO A WALL, FLOOR OR CEILING UNLESS SPECIFICALLY NOTED OTHERWISE.
- PROVIDE AND INSTALL STAINLESS STEEL COVER PLATES ON ALL RECEPTACLES AND J-BOXES. ALL STANDARD SWITCHES AND RECEPTACLES SHALL BE IVORY IN COLOR. ADDITIONALLY, PROVIDE AND INSTALL ORANGE DEVICES FOR ALL ISOLATED GROUND/DEDICATED CIRCUIT RECEPTACLES.
- ALL RECEPTACLES IN ALL DELI/KITCHEN/PREP AREAS SHALL BE GFCI TYPE OR PROTECTED BY A GFCI TYPE CIRCUIT BREAKER AS INDICATED.
- COORDINATE WITH KITCHEN EQUIPMENT SUPPLIER, MECHANICAL SUBCONTRACTOR AND GC FOR FINAL LOCATIONS AND CONNECTION REQUIREMENTS OF ALL **EQUIPMENT PRIOR TO INSTALLATION OF ANY CONDUIT** AND/OR STUB-UP LOCATIONS.
- ALL ELECTRICAL CONDUCTORS SHALL BE CONNECTED TO RECEPTACLES USING ONLY THE TERMINAL SCREWS. RECEPTACLE BACK WIRE/QUICK CONNECTIONS SHALL
- 0. POWER AND CONTROL CORDS ARE FURNISHED WITH DELI/KITCHEN APPLIANCES. CONNECT CORD SETS TO APPLIANCES AS REQUIRED.
- . COORDINATE EXACT LOCATION AND CONNECTION WITH NAMEPLATE OF ALL OWNER SUPPLIED EQUIPMENT
- 12. ALL EQUIPMENT LOCATED UNDER THE KITCHEN HOOD SHALL UTILIZE SHUNT TRIP TYPE BREAKER PER NFPA

KEYED NOTES

- (2) CONTRACTOR SHALL UTILIZE EXISTING CIRCUIT BREAKER SERVING EQUIPMENT AND EXTEND CIRCUIT TO SERVE EQUIPMENT AT ITS NEW LOCATION. COORDINATE CONNECTION TYPE WITH EXISTING EQUIPMENT IN FIELD.
- (3) PROVIDE NEMA CONFIGURATION RECEPTACLE AND MATCHING CORD (IF NOT FURNISHED W/ EQUIPMENT). COORDINATE WITH MANUFACTURER'S INSTRUCTIONS. SEE EQUIPMENT SCHEDULE ON SHEET E3 FOR MORE
- 5 PROVIDE WEATHERPROOF WHILE-IN-USE COVER FOR
- 6 PROVIDE JUNCTION BOX SURFACE MOUNTED ON TOP REAR OF CABINET. CONNECT TO DISCONNECT VIA LIQUID-TIGHT
- (11) EXISTING ELECTRICAL DISTRIBUTION PANEL/EQUIPMENT TO REMAIN IN SERVICE.
- PROVIDE NEW ELECTRICAL DISTRIBUTION PANEL. SEE SHEET E4 FOR MORE INFORMATION.
- PROVIDE SINGLE-GANG JUNCTION BOX FOR POS MONITORS. PROVIDE WITH A 1" CONDUIT ROUTED TO AN ACCESSIBLE LOCATION 6" ABOVE THE LAY-IN CEILING. PROVIDE NYLON BUSHINGS AND A 200LB PULLSTRING.
- (16) PROVIDE SINGLE-GANG JUNCTION BOX (EXTRA DEEP) MOUNTED ON THE MOUNTING PLATE WITHIN THE FRONT COUNTER CASEWORK. MOUNT BOX ADJACENT TO THE RECEPTACLE FOR ITEM 188. DO NOT MOUNT BOX BETWEEN RECEPTACLES FOR ITEMS 188 AND 182B.
- (17) OVERHEAD POWER EQUIPMENT BOX FROM AUTOMATED CONTROLS AND SYSTEMS, LLC. SEE DETAIL 1-E3 FOR MORE INFORMATION.
- (18) MOUNT ABOVE CEILING FOR POWER CONNECTION TO MONITOR MOUNTING POLE.



ENGINEERS & CONSULTANTS

923 MAIN STREET, NORTH WILKESBORO, NC 28659 NC - BUSINESS FIRM # C-1304 JUNE 30, 2024





Chick-fil-A 5200 Buffington Road Atlanta, Georgia 30349-2998



Hill Foley Rossi & Associates ARCHITECTURE + ENGINEERING 3680 Pleasant Hill Road Suite 200 Duluth, GA 30096 770.622.9858



#80419

BUILDING TYPE / SIZE: RELEASE:

REVISION SCHEDULE NO. DATE DESCRIPTION

CONSULTANT PROJECT # 21.554 PRINTED FOR CD 09.22.2023 DRAWN BY

Information contained on this drawing and in all digital files produced for above named project may not be reproduced in any manner without express written or verbal consent from authorized project representatives.


FLOOR PLAN - POWER

SHEET NUMBER

ELECTRICAL EQUIPMENT CONNECTION SCHEDULE											
EQUIP. TAG	EQUIP. TAG DESCRIPTION MOUNTING HEIGHT AND/OR SPECIAL INSTRUCTIONS VOLTAGE KVA/KW BREAKER SIZE/TYPE CONN. TYPE (NEMA CONFIG.) WIRE SCHEDULE NOTES										
(182*)	LABEL PRINTER	SEE PLAN VIEWS FOR HEIGHTS. DIMENSIONS ARE TO CENTER OF BOX	120/1Ø	0.2	20/1P GFCI TYPE	5-20	212	VERIFY REQUIREMENTS WITH OWNER SELECTED DEVICE.			
183 / (F183)	ORDER MONITOR	SEE PLAN VIEWS FOR HEIGHTS. DIMENSIONS ARE TO CENTER OF BOX	120/1Ø	0.4	20/1P GFCI TYPE	5-20	212	VERIFY REQUIREMENTS WITH OWNER SELECTED DEVICE.			
(187*)	KDS MONITOR	SEE PLAN VIEWS FOR HEIGHTS. DIMENSIONS ARE TO CENTER OF BOX	120/1Ø	0.1	20/1P GFCI TYPE	5-20	212	-			
188	ORDER REGISTER	SEE PLAN VIEWS FOR HEIGHTS. DIMENSIONS ARE TO CENTER OF BOX	120/1Ø	0.5	20/1P GFCI TYPE	5-20	212	VERIFY REQUIREMENTS WITH OWNER SELECTED DEVICE.			
300X)	DOUBLE BARREL ICE CREAM MACHINE	55" ABOVE FINISHED FLOOR TO CENTER OF BOX	208/3Ø / 208/3Ø	6.8/5.4	25/3P GFCI / 20/3P GFCI	15-30 / 15-20	38 / 310	VERIFY NEMA CONFIGURATION WITH MANUFACTURER'S INFORMATION. REQUIERS (2) CIRCUITS			
431)	DOUBLE REFRIGERATED WORK TABLE	24" ABOVE FINISHED FLOOR TO CENTER OF BOX	120/1Ø	0.9	20/1P GFCI TYPE	5-20	212	-			
440C	ICE BATH BREADING TABLE	48" ABOVE FINISHED FLOOR TO CENTER OF BOX	120/1Ø	0.1	15/1P GFCI TYPE	5-15	212	-			
442WC)	SINGLE UPRIGHT REFRIGERATOR (30" WIDE)	86" ABOVE FINISHED FLOOR TO CENTER OF BOX	120/1Ø	0.9	15/1P GFCI TYPE	5-20	212	-			
(562A)	HIGH DENSITY HOT HOLDING TOWER	48" ABOVE FINISHED FLOOR TO CENTER OF BOX	120/1Ø	1.9	20/1P GFCI TYPE	5-20	210	-			
(562AT)	HIGH DENSITY HOT HOLDING TOWER	PROVIDE CEILING MOUNTED J-BOX WITH CORD RECEPTACLE HANGING DOWN TO 48" A.F.F.	120/1Ø	1.9	20/1P GFCI TYPE	L5-20	212	-			
(564A)	PRODUCT HOLDING CABINET	PROVIDE CEILING MOUNTED J-BOX WITH CORD RECEPTACLE HANGING DOWN TO 48" A.F.F.	120/1Ø	0.7	15/1P GFCI TYPE	5-15	212	-			
(580H)	MULTI-USE HOLDING CABINET	24" ABOVE FINISHED FLOOR TO CENTER OF BOX	120/1Ø	1.9	20/1P GFCI TYPE	5-20	210	-			
GEN	GENERAL RECEPTACLE	SEE PLAN VIEWS FOR HEIGHTS. DIMENSIONS ARE TO CENTER OF BOX	120/1Ø	0.2	20/1P GFCI TYPE	5-20	212	-			

		RELOCATED ELECTRICA		DMENIT	CONNECTIO	N SCHEDIII E				
EQUIP. TAG	RELOCATED ELECTRICAL EQUIPMENT CONNECTION SCHEDULE EQUIP. TAG DESCRIPTION MOUNTING HEIGHT AND/OR SPECIAL INSTRUCTIONS VOLTAGE KVA/KW BREAKER SIZE/TYPE CONN. TYPE (NEMA CONFIG.) WIRE SCHEDULE NOTES									
300aR)	MILKSHAKE BASE DISPENSER	48" ABOVE FINISHED FLOOR TO CENTER OF BOX	120/1Ø	0.5	15/1P GFCI TYPE*	5-20	212	-		
310R)	DOUBLE LEMONADE BUBBLER	30" ABOVE FINISHED FLOOR TO CENTER OF BOX	120/1Ø	1.0	15/1P GFCI TYPE*	5-20	212	-		
315R)	8-HEAD BEVERAGE DISPENSER WITH ICE BIN	16" ABOVE FINISHED FLOOR TO CENTER OF BOX	120/1Ø	1.2	15/1P GFCI TYPE*	5-20	212	-		
400LR)	REACH-IN FREEZER (30" WIDE)	86" ABOVE FINISHED FLOOR TO CENTER OF BOX	115/1Ø	1.1	15/1P GFCI TYPE*	5-20	212	-		
(431R)	DOUBLE REFRIGERATED WORK TABLE	24" ABOVE FINISHED FLOOR TO CENTER OF BOX	120/1Ø	0.8	15/1P GFCI TYPE*	5-20	212	-		
(438R)	COLD RAIL	48" ABOVE FINISHED FLOOR TO CENTER OF BOX	120/1Ø	0.9	15/1P GFCI TYPE*	5-20	212	-		
444DR)	DOUBLE THAWING CABINET (52" WIDE)	SEE PLAN VIEW FOR HEIGHTS. DIMENSIONS ARE TO CENTER OR BOX OR DEVICE.	115/1Ø	1.9	20/1P GFCI TYPE*	5-20	212	-		
500AR	VERTICAL CONTACT TOASTER	48" ABOVE FINISHED FLOOR TO CENTER OF BOX	120/1Ø	1.8	15/1P GFCI TYPE*	5-20	212	=		
564AR)	PRODUCT HOLDING CABINET	48" ABOVE FINISHED FLOOR TO CENTER OF BOX	120/1Ø	0.7	15/1P GFCI TYPE*	5-15	212	=		
600R)	FLOOR MIXER	48" ABOVE FINISHED FLOOR TO CENTER OF BOX	120/1Ø	1.0	20/1P GFCI TYPE*	L5-20	212	-		
607R)	COUNTERTOP LEMON JUICER	48" ABOVE FINISHED FLOOR TO CENTER OF BOX	120/1Ø	0.5	15/1P GFCI TYPE*	5-20	212	-		

* IF CURRENT BREAKER IS NOT GFCI TYPE, PROVIDE NEW GFCI TYPE BREAKER.

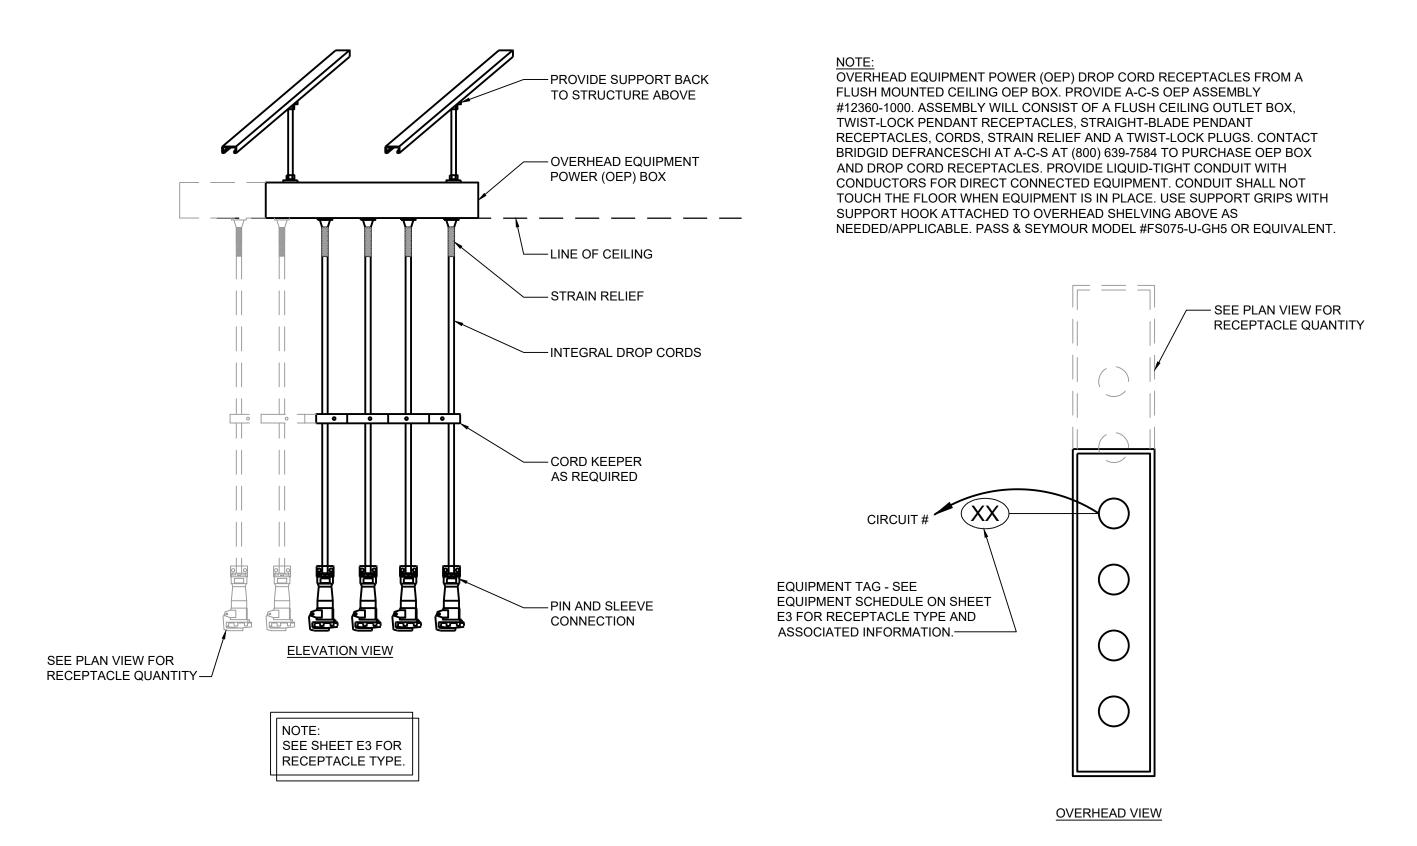

OVERHEAD EQUIPMENT POWER BOX DETAILS

SCALE:

NTS

This item has been signed and sealed by Christopher G. Anderson PE using a Digital Signature and date. Printed copies of this document are not considered signed and sealed and the signature must be verified on any electronic copies.



CONDUIT AND CONDUCTOR SCHEDULE

CODE	WIRE AND CONDUIT
212	(2)#12, 1#12GND. 3/4"C.
210	(2)#10, 1#10GND. 3/4"C.
310	(3)#10, 1#10GND. 3/4"C.
38	(3)#8, 1#10GND. 1"C.
36	(3)#6, 1#8GND. 1"C.

CONTRACTOR SHALL COORDINATE RECEPTACLE
AND DEVICE LOCATIONS WITH ELEVATIONS
SHOWN ON THE ARCHITECTURAL K-SERIES
SHEETS. DIMENSIONS AND HEIGHTS SHOWN ON
K-SHEET ELEVATIONS TAKE PRECEDENCE OVER
MOUNTING HEIGHTS SHOWN IN PLAN VIEW.






Chick-fil-A 5200 Buffington Road Atlanta, Georgia 30349-2998



Hill Foley Rossi & Associates
ARCHITECTURE + ENGINEERING
3680 Pleasant Hill Road
Suite 200
Duluth, GA 30096
770.622.9858

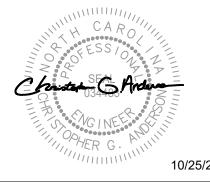

K-FIL-A

Britt Hall 85 Main St Buies Creek, N

#80419

BUILDING TYPE / SIZE: RELEASE:

REVISION SCHEDULE

NO. DATE DESCRIPTION


CONSULTANT PROJECT #	21.554
PRINTED FOR	CD
DATE	09.22.2023
DRAWN BY	LAF

Information contained on this drawing and in all digital files produced for above named project may not be reproduced in any manner without express written or verbal consent from authorized project representatives.

SHEET

ELECTRICAL EQUIPMENT
SCHEDULES AND DETAILS
SHEET NUMBER

E3

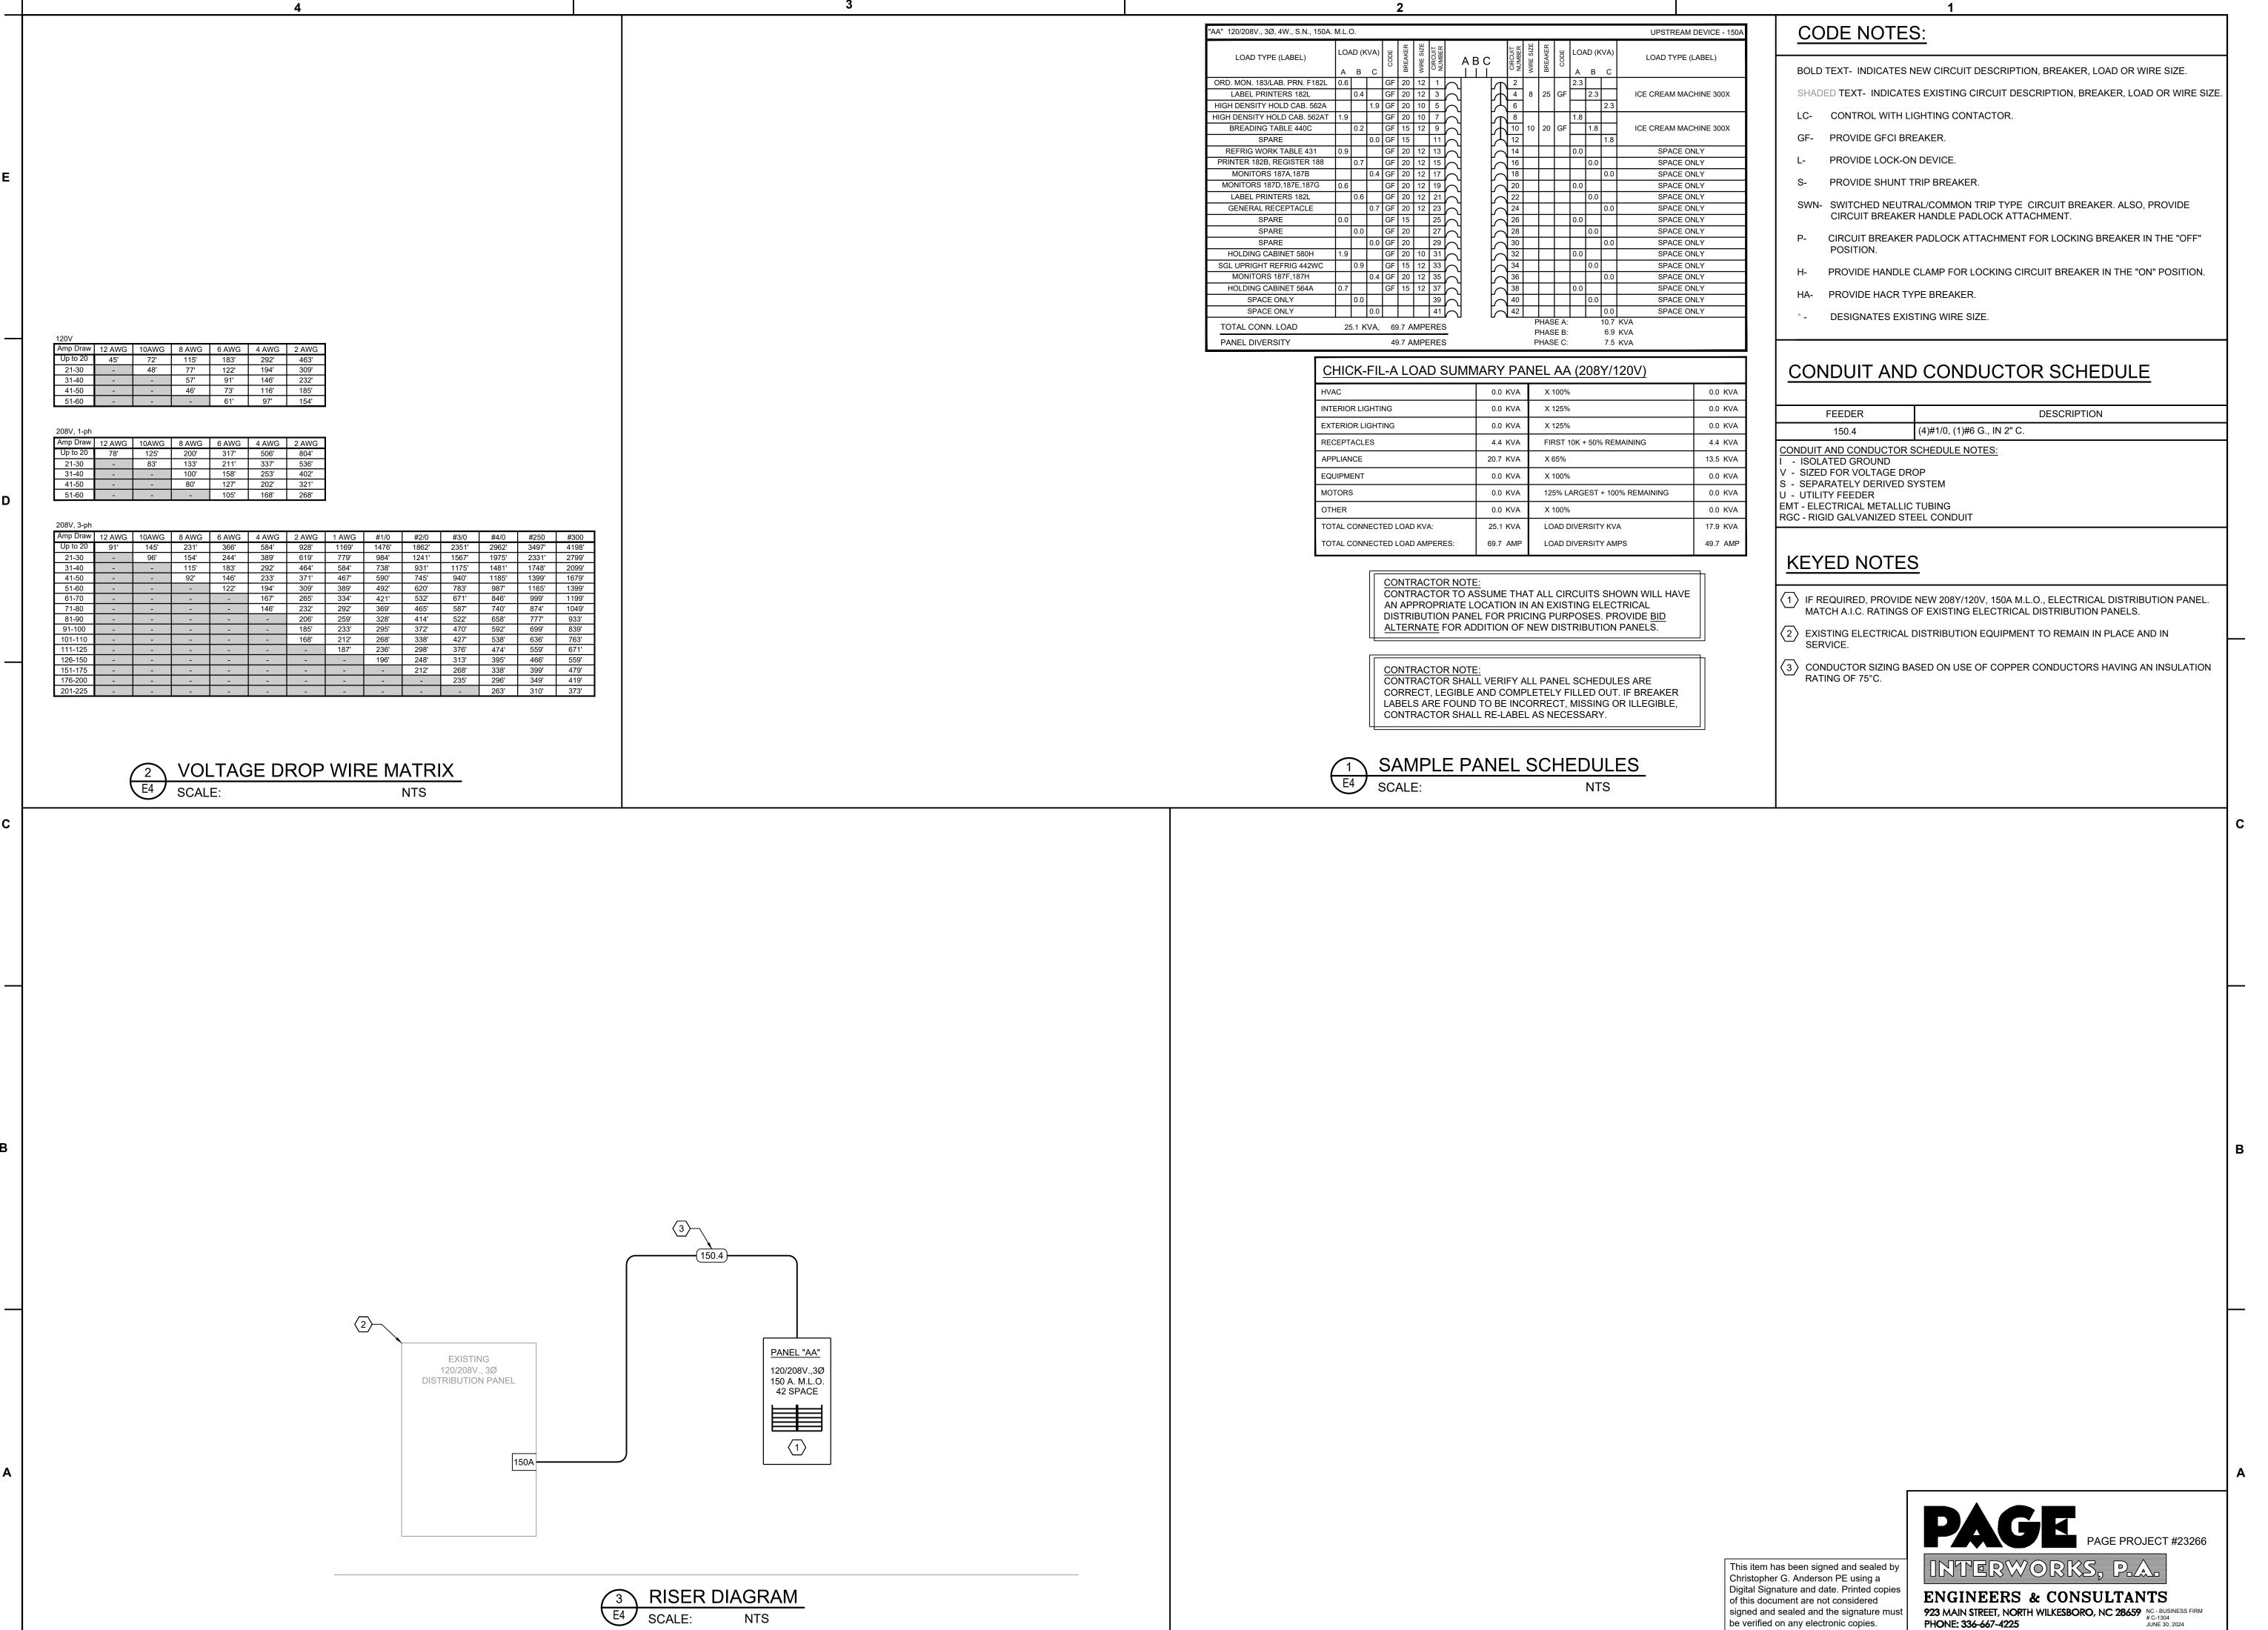





Hill Foley Rossi & Associates ARCHITECTURE + ENGINEERING 3680 Pleasant Hill Road Suite 200 Duluth, GA 30096 770.622.9858



#80419

BUILDING TYPE / SIZE:

RELEASE:

REVISION SCHEDULE NO. DATE DESCRIPTION

CONSULTANT PROJECT #	21.554
PRINTED FOR	CD
DATE	09.22.2023
DRAWN BY	LAF

Information contained on this drawing and in all digital files produced for above named project may not be reproduced in any manner without express written or verbal consent from authorized project representatives.

ELECTRICAL PANEL SCHEDULE AND RISER DIAGRAM SHEET NUMBER

be verified on any electronic copies.

E4

SPECIFICATIONS

CAST IRON SOIL, WASTE AND VENT PIPING: WASTE AND VENT PIPING SHALL BE HUBLESS CAST IRON. WASTE AND VENT PIPING BELOW GRADE OR EMBEDDED IN CONCRETE SHALL BE SERVICE WEIGHT CAST IRON. THE CONTRACTOR MAY AT HIS DISCRETION USE PVC DWV SCHEDULE 40 SOLID CORE PIPE IF APPROVED BY LOCAL AUTHORITY/OWNER.

GASKETED AND/OR "NO HUB" JOINTS: THE CONTRACTOR MAY, AT HIS DISCRETION, USE "NO-HUB" PIPE ENDS WITH RESILIENT SLEEVES AND METAL CLAMPS EQUAL TO TYLER'S "TY-SEAL" AND TYLER'S "NO-HUB". GASKETS AND RESILIENT SLEEVES SHALL BE VIRGIN RUBBER OR NEOPRENE. OUTSIDE METAL CLAMPS ON "NO-HUB" JOINTS SHALL BE STAINLESS STEEL.

SLOPE WASTE AND VENT PIPING 1/4 INCH PER FOOT (MIN) FOR PIPE SIZES 2-1/2" OR LESS. FOR PIPE SIZES 3" TO 6" SLOPE 1/8 INCH PER FOOT (MIN), 8" OR LARGER PIPE, SLOPE MIN 1/16" PER FOOT. REFER TO TABLE 704.1 OF THE LATEST PLUMBING CODE FOR MINIMUM SLOPE REQUIRED.

WATER PIPING: ALL WATER PIPING 3" AND SMALLER SHALL TYPE "L" COPPER TUBING WITH FORGED FITTINGS AND SWEAT CONNECTIONS. DIELECTRIC UNIONS, EPCO SALES, INC., SERIES FX SHALL BE INSTALLED BETWEEN COPPER PIPE AND WATER HEATER. ALL FITTINGS SHALL BE SWEAT TYPE WROUGHT COPPER WITH WALL THICKNESS EQUAL TO PIPE WALL THICKNESS. ALL JOINTS SHALL BE MADE WITH 95-5 SOLDER OR SILVABRITE 100. NO SOLDER W/LEAD SHALL BE PERMITTED.

ALL ROUGHING-IN PIPING SHALL BE RUN CONCEALED. ALL EXPOSED WATER LINES, STOPS, TRAP AND WASTE PIPE AT THE FIXTURES SHALL BE CHROME PLATED BRASS, WHICH FOR THE MOST PART WILL BE FURNISHED WITH THE FIXTURES. CHROME PLATED ESCUTCHEON RINGS

SHALL BE USED AT EACH POINT OF ENTRANCE OF CHROME PIPING INTO WALLS, FLOORS, OR CEILINGS. EXPOSED WORK SHALL BE UNIFORM IN HEIGHT AND LOCATION FOR EACH TYPE FIXTURE.

WATER PIPING UNDER GROUND OUTSIDE OF BUILDING SHALL BE AT LEAST 36 INCHES BELOW THE FINISHED GRADE SURFACE.

THERMAL INSULATION: ALL HOT AND COLD WATER PIPING INSIDE BUILDING AND IN CRAWL SPACE, ALL HOT WATER PIPING BELOW GRADE, AND COLD WATER PIPING BELOW GRADE WITHIN 3'-0" OF OUTSIDE SHALL BE INSULATED WITH 1" THICK "ARMAFLEX" OR IMCOA WITH SEALED JOINTS OR PREMOLDED FIBERGLASS WITH VAPOR BARRIER JACKET.

SUBMITTAL: THE CONTRACTOR SHALL WITHIN (15) DAYS OF RECEIPT OF PROPERLY SIGNED CONTRACT SUBMIT TO THE ARCHITECT/ENGINEER FOR APPROVAL (5) COPIES OF A LIST OF SUPPLIES AND MANUFACTURER'S MATERIAL AND EQUIPMENT TO BE USED ON THIS PROJECT.

SUBSTITUTION OF MATERIALS AND/OR EQUIPMENT FOR THAT SPECIFIED WILL NOT BE ACCEPTED WITHOUT PRIOR WRITTEN APPROVAL BY THE ARCHITECT/ENGINEER PRIOR TO RECEIPT OF BIDS.

GENERAL: THE ENTIRE PLUMBING SYSTEM SHALL BE IN ACCORDANCE WITH THE LATEST PLUMBING CODE. SUBMIT THREE (3) COPIES OF PLUMBING INSPECTION CERTIFICATES TO OWNER. PLUMBING CONTRACTOR SHALL OBTAIN AND PAY FOR ALL PERMITS REQUIRED BY GOVERNING AUTHORITIES FOR WORK DONE UNDER THIS CONTRACT. PROVIDE AND INSTALL ALL SUPPORTS, BRACKETS, MATERIALS AND LABOR AS REQUIRED FOR A COMPLETE AND ACCEPTABLE PLUMBING SYSTEM. PLUMBING CONTRACTOR SHALL CLEAN ALL CORRELATING PLUMBING FIXTURES AFTER ALL CONSTRUCTION IS COMPLETE.

GUARANTEE: THE PLUMBING CONTRACTOR SHALL GUARANTEE ALL MATERIALS AND WORKMANSHIP FOR A PERIOD OF NOT LESS THAN ONE (1) YEAR FROM DATE OF FINAL ACCEPTANCE BY OWNER STATING THE DAY THE GUARANTEE BEGINS AND ENDS.

WATER HAMMER CONTROL: ARRESTORS SHALL BE SIZED AND APPLIED IN ACCORDANCE WITH THE PLUMBING AND DRAINAGE INSTITUTE STANDARD PDI-WH-201. EQUIPMENT EQUAL TO JOSAM #57000 OR EQUAL BY AMTROL, WADE, SIOUX CHIEF OR SMITH IS ACCEPTABLE. PROVIDE "KARP" ACCESS COVER IN WALL TO SERVICE WATER HAMMER ARRESTORS, AS REQUIRED.

FIXTURE SCHEDULE: SEE DRAWINGS.

CLEANOUTS: CLEANOUTS SHALL BE AS FOLLOWS:

FLOOR CLEANOUTS: IN FINISHED AREAS SHALL BE JOSAM #5500-1-SQ WITH SQARE NICKEL BRONZE TOP.

IN CARPETED FLOORS SHALL BE JOSAM #5#5500-1-SQ.

IN TILE FLOORS SHALL BE JOSAM #5500-1-SQ.

WALL CLEANOUTS: JOSAM #58710 WITH STAINLESS STEEL COVERPLATE.

CLEANOUTS IN EXPOSED PIPING: JOSAM #58900.

EXTERIOR CLEANOUTS: JOAM # 56050 W/ROUND NICKEL BRONZE TOP.

CLEANOUTS IN WATERPROOF FLOOR SHALL HAVE FLASHING FLANGE AND CLAMPING DEVICE.


CLEANOUTS IN CARPETED AREAS SHALL BE PROVIDED WITH CARPET MARKERS.

BALL VALVES: NIBCO MODEL 4660-T, LINE SIZE.

POINT-OF-USE MIXING VALVES: WATTS LFMMV-M1-US, LINE SIZE.

	CHICK-FIL-A EQUIPMENT SCHEDULE									
MARK DESCRIPTION MANUFACTURER MODEL NUMBER PLUMBING REMARKS						- REMARKS				
IVIAIXIX	DESCRIPTION	WANDFACTURER		WASTE	VENT	CW	HW	FW	KLIVIAKKO	
315R	8-HEAD BEVERAGE DISPENSER WITH ICE BIN	EXISTING	EXISTING	3/4"						
360E	EMERGENCY EYEWASH STATION	ACORN	S0660-RH		1	1/2"	1/2"		- P-42; TO BE MOUNTED TO WALL BETWEEN 33" AND 45" AFF	
360e	HAND SINK	EAGLE	YCFA-HSAN-0004-0 0	2"	2"				p-5; WITH SIDE MOUNTING BRACKETS	
360Fe	SENSOR FAUCET FOR WALL MOUNTED HAND SINK	тото	TEL165-C20E#CP			1/2"	1/2"		P-5	

SYMBOL LEGEND

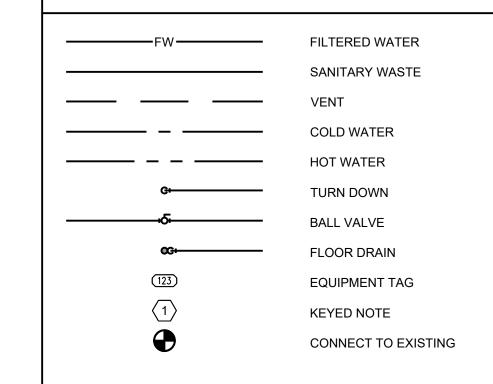

<u>ABBREVIATIONS</u>								
ABB.	DEFINITION	ABB.	DEFINITION					
1CS	ONE COMPARTMENT SINK	МВН	1000 BTH PER HOUR					
3CS	THREE COMPARTMENT SINK	MIN	MINIMUM					
AFF	ABOVE FINISHED FLOOR	MS	MOP SINK					
BC	BEVERAGE CONDUIT	NTS	NOT TO SCALE					
		PC	PLUMBING CONTRACTOR					
BFP BACKFLOW PREVENTOR CD CONDENSATE DRAIN		TMV	THERMOSTATIC MIXING VALVE					
EX	EXISTING	TP	TRAP PRIMER					
FCO	FLOOR CLEANOUT	TYP	TYPICAL					
FD	FLOOR DRAIN	UR	URINAL					
FS	FLOOR SINK	V	VENT					
FW	FILTERED WATER	W	WASTE					
G	GAS	W/	WITH					
GW	GREASE WASTE	W/O	WITHOUT					
KEC	KITCHEN EQUIPMENT	wc	WATER CLOSET					
LAV	CONTRACTOR	WCO WH	WALL CLEANOUT WATER HEATER					
MAX	MAXIMUM	I VVII	WAILINILAILIN					

TESTING PROCEDURES

TEST INSTALLED WATER PIPING AT 100 PSI FOR A PERIOD OF 24 HOURS, OBSERVING FOR ANY VISIBLE LEAKS. TEST PIPING AGAIN WITH FIXTURES INSTALLED.

CHLORINATE ALL WATER PIPING FOR A PERIOD OF 8 HRS, BY CHARGING WITH A HYPOCHLORINATE SOLUTION TO ACHIEVE A 5 PPM STRENGTH AT THE FIXTURE FURTHEST FROM THE POINT OF APPLICATION. UPON COMPLETION OF THE CHLORINATION, FLUSH ALL PIPING UNTIL NO CHLORINE CAN BE DETECTED BY TASTE. CLEAN ALL STRAINERS AND SET WATER FLOWS FROM FIXTURES IN ACCORDANCE WITH MANUFACTURER AND LOCAL REQUIREMENTS.

TEST INSTALLED WASTE AND VENT PIPING FOR A PERIOD OF 8
HRS, BY CAPPING OR PLUGGING ALL JOINTS TO A LEVEL OF THE
HIGHEST FIXTURE OR FITTING. FILL THE SYSTEM WITH WATER AND
OBSERVE FOR ANY LEAKS.

GENERAL NOTES

- 1. DRAWINGS ARE DIAGRAMMATIC ONLY AND REPRESENT THE GENERAL SCOPE OF THE WORK. PRIOR TO SUBMITTING BID, VISIT THE JOB SITE TO OBSERVE THE EXISTING CONDITIONS OF THE PROJECT. REVIEW THE GENERAL NOTES, SPECIFICATIONS AND PLANS FOR ADDITIONAL REQUIREMENTS THAT MAY NOT BE SPECIFICALLY CALLED OUT IN THIS PORTION OF THE CONSTRUCTION DOCUMENTS. NOTIFY ARCHITECT OF ANY CONFLICTS OR DISCREPANCIES PRIOR TO SUBMISSION OF BID.
- 2. INSTALLATION SHALL COMPLY WITH LEGALLY CONSTITUTED CODES AND THE REQUIREMENTS OF AUTHORITIES HAVING JURISDICTION AND ALSO MEET ALL REQUIREMENTS OF THE LANDLORD. OBTAIN A COPY OF THE LANDLORD'S REQUIREMENTS AND REVIEW PRIOR TO SUBMITTING BID.
- PROVIDE A CONSTRUCTION RECORD SET OF "AS-BUILT" DOCUMENTS TO THE ARCHITECT REFLECTING ANY VARIANCES OF INSTALLED PIPING LOCATIONS OR EQUIPMENT CONTRARY TO THE CONSTRUCTION DOCUMENTS. REFER TO SPECIFICATIONS.
- 4. PROVIDE TO THE ARCHITECT A COPY OF INSPECTION REPORTS AND APPROVAL CERTIFICATES FROM LOCAL AND STATE INSPECTIONS, REFER TO SPECIFICATIONS.
- 5. PLANS AND SPECIFICATIONS GOVERN WHERE THEY EXCEED CODE REQUIREMENTS.
- COMPLY WITH HEALTH DEPARTMENT REGULATIONS. PROVIDE CLEARANCE FOR CLEANING BEHIND AND UNDER EXPOSED PIPING AS REQUIRED BY HEALTH DEPARTMENT. CONFORM TO HEALTH DEPARTMENT REQUIREMENTS FOR LOCATIONS OF FLOOR SINKS.
- PROVIDE ITEMS AND WORK AS REQUIRED FOR A COMPLETE AND WORKING PLUMBING INSTALLATION FOR EACH PIECE OF KITCHEN EQUIPMENT. PROVIDE ROUGH-INS AND CONNECT TO THE KITCHEN EQUIPMENT WITH TRAPS, SUPPLIES, SHUTOFF VALVES, PIPES TO THE WALL, ESCUTCHEONS, ETC., AS SHOWN, SPECIFIED AND REQUIRED.
- 8. VERIFY LOCATION AND DEPTH OF UTILITIES AT POINTS OF CONNECTION BEFORE START OF PIPING INSTALLATION.
- 9. DO NOT SCALE FLOOR PLANS FOR EXACT HORIZONTAL LOCATION OF PIPE ROUTING.
- 10. REFER TO ARCHITECTURAL AND K-SERIES PLANS FOR EXACT LOCATION AND MOUNTING HEIGHTS OF PLUMBING FIXTURES.
- 11. COORDINATE ALL WASTE, VENT, AND WATER PIPING TO AVOID CONFLICT WITH OTHER TRADES AND CONTRACTORS. DO NOT INSTALL PIPING OVER ELECTRICAL PANELS. COORDINATE PIPING INSTALLATION WITH STRUCTURAL GRADE BEAMS, FOOTINGS, COLUMN PIERS, ETC. SLEEVE PIPING THROUGH GRADE BEAMS, FOOTING, ETC., WHERE REQUIRED AND AS NOTED ON PLANS. COORDINATE SLEEVE INSTALLATIONS WITH THE ARCHITECT, STRUCTURAL ENGINEER, STRUCTURAL CONTRACTOR AND GENERAL CONTRACTOR BEFORE CONCRETE IS INSTALLED.
- 12. COORDINATE ALL ROOF PENETRATIONS WITH OTHER TRADES.
 MAINTAIN 10' MINIMUM CLEARANCE FROM ALL AIR INTAKES. MAINTAIN
 MINIMUM 3'-0" OF CLEARANCE FROM ALL OTHER EQUIPMENT.
- 13. COORDINATE FLOOR DRAIN LOCATIONS WITH THE ARCHITECTURAL PLANS. INSTALL RIM OF FLOOR DRAINS AND FLOOR SINKS BELOW FINISHED FLOOR LEVEL.
- 14. INSTALL CONCEALED PIPING TIGHT TO THE STRUCTURE AND AS HIGH AS POSSIBLE. INSTALL EXPOSED PIPING TIGHT TO THE STRUCTURE, WALL OR CEILING AND AS HIGH AS POSSIBLE. COORDINATE WITH OTHER TRADES TO AVOID CONFLICTS.
- 15. INSULATE ALL DOMESTIC WATER PER LATEST PLUMBING CODE, PLUMBING DRAWINGS AND K-SERIES DRAWINGS.
- 16. SEAL ALL PENETRATIONS THROUGH FLOORS, WALLS, CEILINGS AND ROOFS. REPAIR SURFACES TO MATCH ADJACENT AREAS.
- 17. DO NOT INSTALL PLUMBING ROOF PENETRATIONS THROUGH GREASE FILTER PANS ON THE ROOF. REFER TO MECHANICAL DRAWINGS PRIOR TO START OF INSTALLATION.
- 18. PROVIDE WALL BACKING OR SPECIFIED CARRIERS FOR THE PROPER SUPPORT OF INSTALLED WALL HUNG FIXTURES AND EQUIPMENT.
- 19. CLEAN INSTALLED PLUMBING FIXTURES AND EQUIPMENT.
- 20. SEAL AROUND INSTALLED FIXTURES AND KITCHEN EQUIPMENT WITH CAULK.
- 21. PROVIDE AIR GAP OF TWO PIPE DIAMETERS MINIMUM PER CODE AT ALL INDIRECT WASTE TERMINATIONS.
- 22. PROVIDE TRAP PRIMERS WHERE REQUIRED BY LOCAL AUTHORITIES.
- 23. PROVIDE VERTICAL LIFT SPRING LOADED CHECK VALVES IN HOT AND COLD WATER SUPPLIES FOR 3-COMPARTMENT SINKS, PRE-RINSE UNITS AND JANITOR SINKS DOWNSTREAM OF SHUTOFF VALVES.
- 24. ASSUMED MINIMUM 55 PSI SERVICE PRESS FOR DOMESTIC WATER SIZING. VERIFY PRESSURE IN FIELD.

SHEET INDEX

SHEETS	DESCRIPTION
P1.0	PLUMBING SYMBOL LEGEND, SCHEDULES, AND SPECIFICATIONS
P2.0	NEW PLUMBING WASTE & WATER FLOOR PLAN

This item has been signed and sealed by Ryan J. Crawford PE using a Digital Signature and date. Printed copies of this document are not considered signed and sealed and the signature must be verified on any electronic copies.



ENGINEERS & CONSULTANTS

PHONE: 336-667-4225


923 MAIN STREET, NORTH WILKESBORO, NC 28659 NC - BUSINESS FIRM



Chick-fil-A 5200 Buffington Road Atlanta, Georgia 30349-2998



Hill Foley Rossi & Associates
ARCHITECTURE + ENGINEERING
3680 Pleasant Hill Road
Suite 200
Duluth, GA 30096
770.622.9858

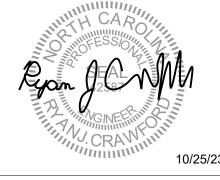

FILLA niversity

Campbell Unive Britt Hall 85 Main St

#80419

BUILDING TYPE / SIZE: RELEASE:

REVISION SCHEDULENO.DATEDESCRIPTION

CONSULTANT PROJECT # 21.554

PRINTED FOR CD

DATE 09.22.2023

DRAWN BY BJE


Information contained on this drawing and in all digital files produced for above named project may not be reproduced in any manner without express written or verbal consent from authorized project representatives.


SHEET

PLUMBING SYMBOL LEGEND,
SCHEDULES & SPECIFICATIONS
SHEET NUMBER

P1

3

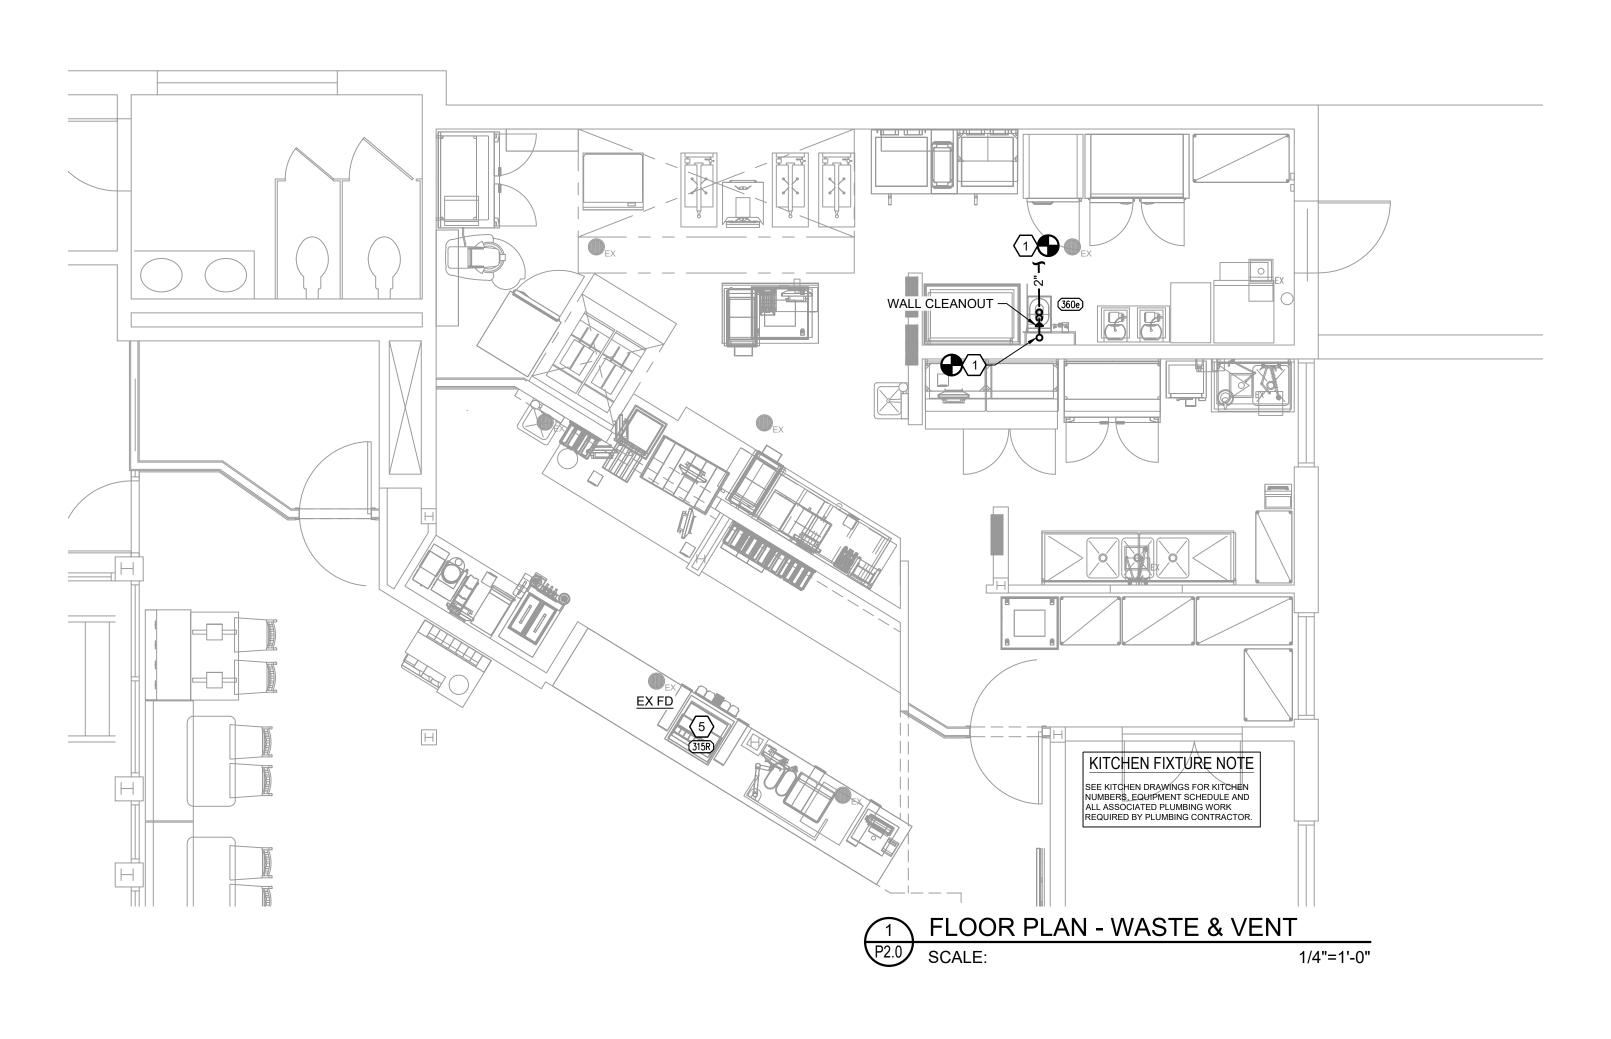

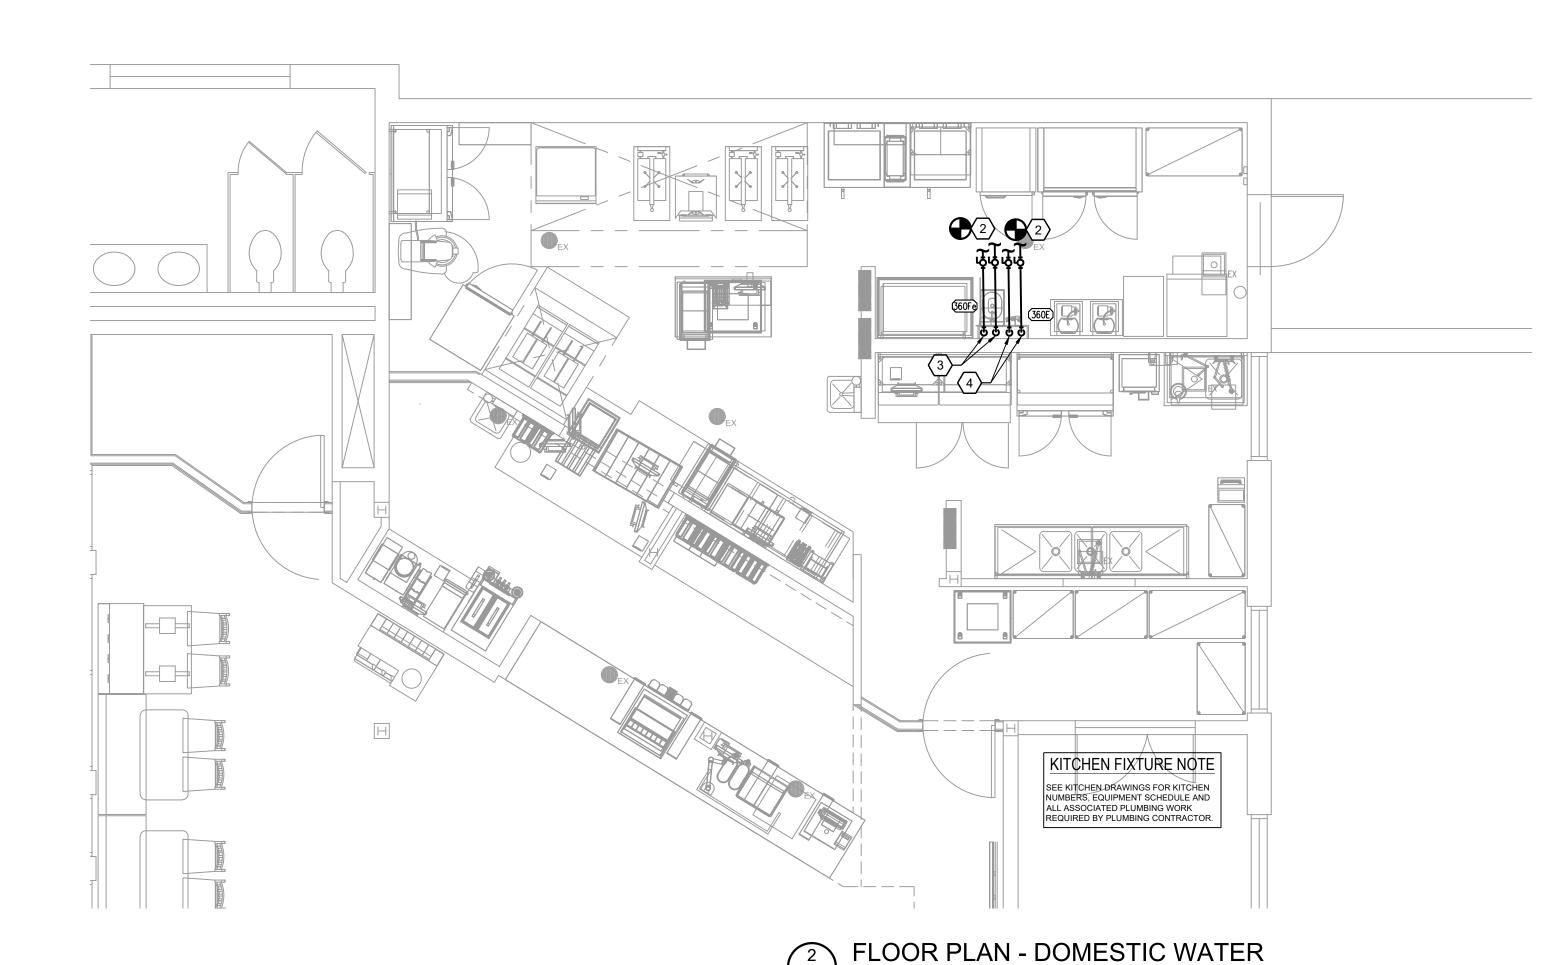

1/4"=1'-0"

This item has been signed and sealed by Ryan J. Crawford PE using a Digital Signature and date. Printed copies of this document are not considered signed and sealed and the signature must be verified

This item has been signed and sealed by Ryan J. Crawford PE using a Digital Signature and date. Printed copies of this document are not considered signed and sealed by Ryan J. Crawford PE using a Digital Signature and date. Printed copies of this document are not considered signed and sealed by Ryan J. Crawford PE using a Digital Signature and date. Printed copies of this document are not considered signed and sealed by Ryan J. Crawford PE using a Digital Signature and date. Printed copies of this document are not considered signed and sealed and sealed by Ryan J. Crawford PE using a Digital Signature and date. Printed copies of this document are not considered signed and sealed by Ryan J. Crawford PE using a Digital Signature and date. Printed copies of this document are not considered signed and sealed and the signature must be verified.

on any electronic copies.

PAGE PROJECT #23266
INTERWORKS, P.A.

ENGINEERS & CONSULTANTS
923 MAIN STREET, NORTH WILKESBORO, NC 28659
PHONE: 336-667-4225


DEMOLITION NOTES

1. PRIOR TO START OF CONSTRUCTION, GENERAL CONTRACTORS AND SUBCONTRACTORS SHALL VISIT THE SITE TO FIELD VERIFY EXISTING CONDITIONS WITH RESPECT TO THE CONSTRUCTION DOCUMENTS.

- 2. ALL WORK SHALL BE IN COMPLIANCE WITH RECOGNIZED INDUSTRY STANDARDS, CRAFTSMANSHIP STANDARDS, MANUFACTURER'S RECOMMENDATIONS, AND ALL OTHER APPLICABLE CODES.
- 3. COORDINATE ALL DEMOLITION WITH FACILITIES MANAGEMENT
- 4. ALL DEMOLITION WORK TO COMPLY WITH CONSTRUCTION PROCEDURES AND REGULATIONS AS SET FORTH BY LOCATION IN WHICH WORK IS BEING DONE.
- 5. DO NOT ABANDON ANY UTILITES WITHIN SPACE. REMOVE ALL UTILITES CONNECTED TO ITEMS TO BE DEMOLISHED UNLESS OTHERWISE NOTED. COORDINATE WITH FIELD CONDITIONS AND PROJECT AND FACILITY MANAGERS.
- 6. CAP AND SEAL OFF ANY PLUMBING PENETRATIONS AS NECESSARY. DO NOT ABANDON ANY UTILITES OR MATERIALS WITHIN SPACE REMOVE BACK AND CAP AT THE SOURCE.
- 7. CLEAN AND REPAIR ALL EXISTING-TO-REMAIN EQUIPMENT TO "LIKE NEW" CONDITION AND PREPARE FOR REINSTALLATION.
- 8. IT SHALL BE THE RESPONSIBILITY OF THE PLUMBING CONTRACTOR TO COORDINATE WITH THE OTHER SUBCONTRACTORS/TRADES. FAILURE TO DO SO WILL NOT CONSTITUTE GROUNDS FOR A CHANGE OPDER
- 9. ALL MATERIALS ARE TO BE NEW UNLESS OTHERWISE NOTED.
- 10. SEE K-SERIES DRAWINGS FOR ADDITIONAL PLUMBING DETAILS.

KEYED NOTES

- CONNECT NEW SANITARY WASTE LINE / VENT LINE TO NEAREST EXISTING SANITARY WASTE LINE / VENT LINE OF EQUAL OR GREATER SIZE. CONTRACTOR SHALL FIELD VERIFY EXACT LOCATION, SIZE, TYPE AND INVERT OF EXISTING SANITARY WASTE LINE / VENT LINE.
- CONNECT NEW HOT (110°F) AND COLD WATER LINES TO NEAREST EXISTING HOT (110°F) AND COLD WATER LINES OF EQUAL OR GREATER SIZE. CONTRACTOR SHALL FIELD VERIFY EXACT LOCATION, SIZE AND TYPE OF EXISTING HOT (110°F) AND COLD WATER LINES. PROVIDE BALL VALVE AT EACH POINT OF CONNECTION TO EXISTING. CONTRACTOR SHALL PROVIDE POINT-OF-USE MIXING VALVE SET AT 110°F OUTPUT IF 110°F HOT WATER LINE IS NOT AVAILABLE.
- 3 1/2" HOT (110°F) AND 1/2" COLD WATER LINES DOWN IN WALL TO NEW SINK. SEE DETAILS ON SHEET K611. ALSO SEE KEYED NOTE 2.
- 4 1/2" HOT AND COLD WATER LINES DOWN TO MIXING VALVE (P-42); SEE KITCHEN PLANS. TEPID WATER LINE TO EYEWASH. SEE DETAILS ON SHEET K611.
- 5 EXTEND WASTE INDIRECT WASTE FROM BEVERAGE DISPENSER/ICE BIN TO EXISTING FLOOR DRAIN.

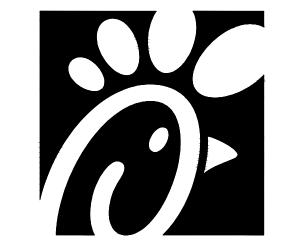




Chick-fil-A 5200 Buffington Road Atlanta, Georgia 30349-2998



Hill Foley Rossi & Associates
ARCHITECTURE + ENGINEERING
3680 Pleasant Hill Road
Suite 200
Duluth, GA 30096
770.622.9858

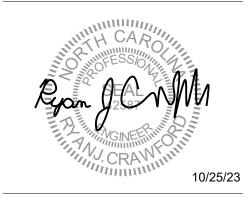

THCK-FIL-ampbell Universiritt Hall

#80419

BUILDING TYPE / SIZE:

RELEASE:

REVISION SCHEDULE

NO. DATE DESCRIPTION

CONSULTANT PROJECT # 21.554

PRINTED FOR CD

DATE 09.22.2023

Information contained on this drawing and in all digital files produced for above named project may not be reproduced in any manner without express written or verbal consent from authorized project representatives.

NEW PLUMBING WASTE & WATER FLOOR PLAN
SHEET NUMBER

P2