SYMBOL	MANUFACTURER	MODEL #	FIXTURE DESCRIPTION	ACCESSORIES	SUPPLY	WASTE	VENT	REMARKS
P-1	AMERICAN STD.		CADET 3 RIGHT HEIGHT ELONGATED TOILET WITREOUS CHINA, 1.6 GPF—ADA	CHURCH 295C ELONGATED SEAT OPEN FRONT LESS COVER	3/4" C.W.	3"	2"	
P-2	AMERICAN STD.	270CA.001	CADET 3 RIGHT HEIGHT ELONGATED TOILET VITREOUS CHINA, 1.6 GPF	CHURCH 295C ELONGATED SEAT OPEN FRONT LESS COVER	3/4" C.W.	3"	2"	
P-3	AMERICAN STD	0490.011	OVAL LAVATORY, COUNTER TOP	DELTA 2507LF-HDF TWO HANDLE METERING FAUCET	1/2" H.W./C.W.	2"	1-1/2"	
P-4	AMERICAN STD.	6541.132	URINAL, WALL—TYPE	SLOAN ROYAL 186-1, FLUSH VALVE	3/4" C.W.	2"	1-1/2"	
P-5	FIAT	MSB2424	MOP SINK	CHROME FAUCET, ADJUSTABLE BRACE AND PAIL HOOK	1/2" H.W./C.W.	3"	1-1/2"	
P-6	SERV-WARE	HS15S-CWP	HAND SINK	4" OC DECK FAUCET BKD3GG	1/2" H.W./C.W.	2"	1-1/2"	
P-7	SERV-WARE	E1CWP1818R-24	1-COMPARTMENT SINK W/24" DRAIN BOARD	-	1/2" H.W./C.W.	2"	1-1/2"	
P-8	SERV-WARE	E3CWP18182-24	3-COMPARTMENT SINK W/24" DRAIN BOARD	_	1/2" C.W.	2"	1-1/2"	
P-9	ELKAY	DLRS332210	STAINLESS STEEL DROP IN SINK (ONE COMPARTMENT)	GOOSENECK LK406GN04T4	1/2" H.W./C.W.	2"	1-1/2"	
WH-1	STATE OR EQ.		60 GALLON WATER HEATER 199,000 BTU	3/4" T & P RELIEF VALVE	1" C.W. 1/2" H.W.	_	_	SEE PLAN FOR LOCATION

GENERAL PL	UMBING SYMBOLS
	UNION
o	PIPE UP
€	PIPE DOWN
0 -	POINT OF CONNECTION BETWEEN NEW AND EXISTING WORK
1 1	TEE
	ELBOW
WCO	WALL CLEANOUT
\oplus	FLOOR CLEANOUT
\bowtie	GATE VALVE
	COLD WATER
	HOT WATER
	VENT PIPING
	WASTE PIPING
RD	ROOF DRAIN PIPING

ALL WORK SHALL BE DONE IN ACCORDANCE WITH THE LATEST EDITION OF THE STATE CODE AS WELL AS ALL LOCAL AND OTHER APPLICABLE CODES.

ALL WORK SHALL BE PERFORMED BY EXPERIENCED AND SKILLED CRAFTSMEN.

WATER LINES BELOW GRADE SHALL BE TYPE "K" COPPER (NO JOINTS BELOW GRADE) AND ABOVE GRADE TYPE "L" COPPER SUPPORTED AS REQUIRED AND SHALL BE HYDROSTATICALLY TESTED FOR TWO HOURS AT 100 PSI. ALL WATER PIPING AT WATER FIXTURES SHALL BE PROVIDED WITH 18" AIR CHAMBERS OR SHOCK ABSORBERS. STOPS SHALL BE PROVIDED ON HOT AND COLD WATER LINES. HOT WATER PIPING SHALL BE INSULATED WITH 1" CLOSED CELL RUBBER. THE ENTIRE WATER SYSTEM SHALL BE DISINFECTED PRIOR TO PLACING IN SERVICE PVC/PEX MAYBE SUBSTITUED FOR COPPER

SANITARY SEWER LINES SHALL BE PVC.

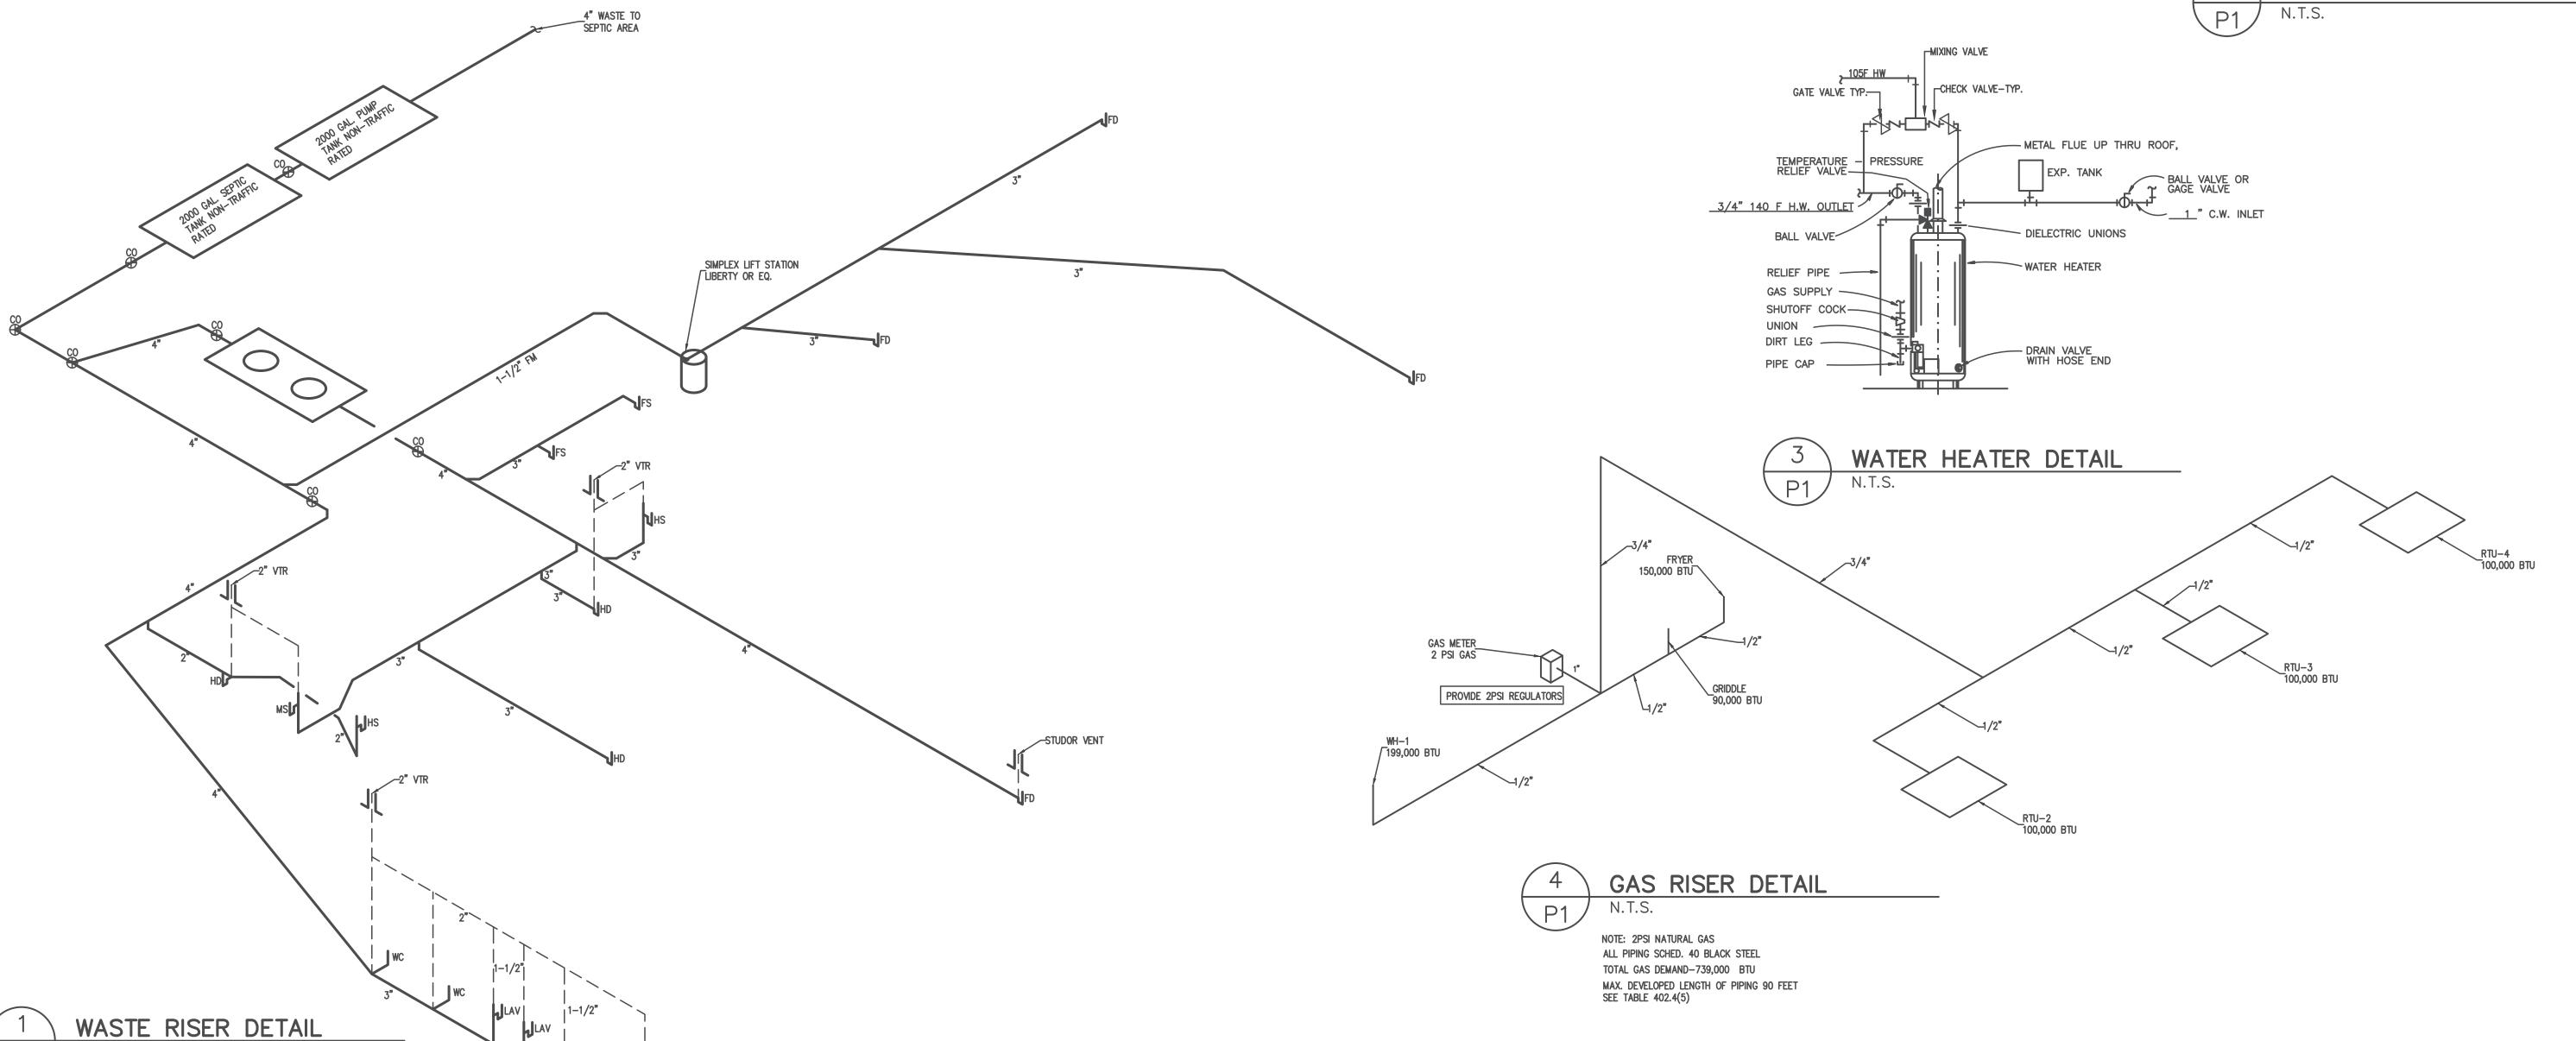
PROVIDE PRESSURE REDUCING VALVE IF STREET WATER EXCEEDS 80 PSI GAS PIPING WILL BE SCHEDULE 40 BLACK STEEL WITH BLACK MALLEABLE IRON SCREW-TYPE FITTINGS.

THE PLUMBING CONTRACTOR SHALL PROVIDE ALL OPENINGS REQUIRED FOR THE PLUMBING WORK AND SHALL INSTALL FIRE RATED SLEEVES WHEREVER PENETRATIONS OF RATED WALLS OR FLOORS ARE MADE. THE PATCHING SHALL BE BY THE PLUMBING CONTRACTOR. THE PLUMBING CONTRACTOR SHALL REVIEW ALL UTILITY SITE PLANS AND ARCHITECTURAL SITE PLANS FOR WORK BY OTHERS.

LOCATION OF UTILITIES (WASTE AND WATER LINES, MANHOLES ETC.) THAT ARE TO BE CONNECTED TO ARE ASSUMED. IT SHALL BE THE RESPONSIBILITY OF THE PLUMBING CONTRACTOR TO VERIFY THESE LOCATIONS AND MAKE THE FINAL CONNECTION AS

ALL FLOOR DRAINS SHALL BE PROVIDED WITH TRAP PRIMERS





REVISIONS DATE

CHAMPS CONVENIENCE STORE U.S. HWAY 401 NORTH 1ay-Varina, North Carolina 27526

Engineerin Plains

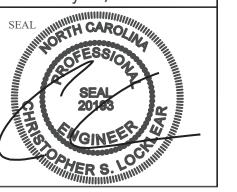
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JOB NUMBER: **2024–056**

SHEET NO:

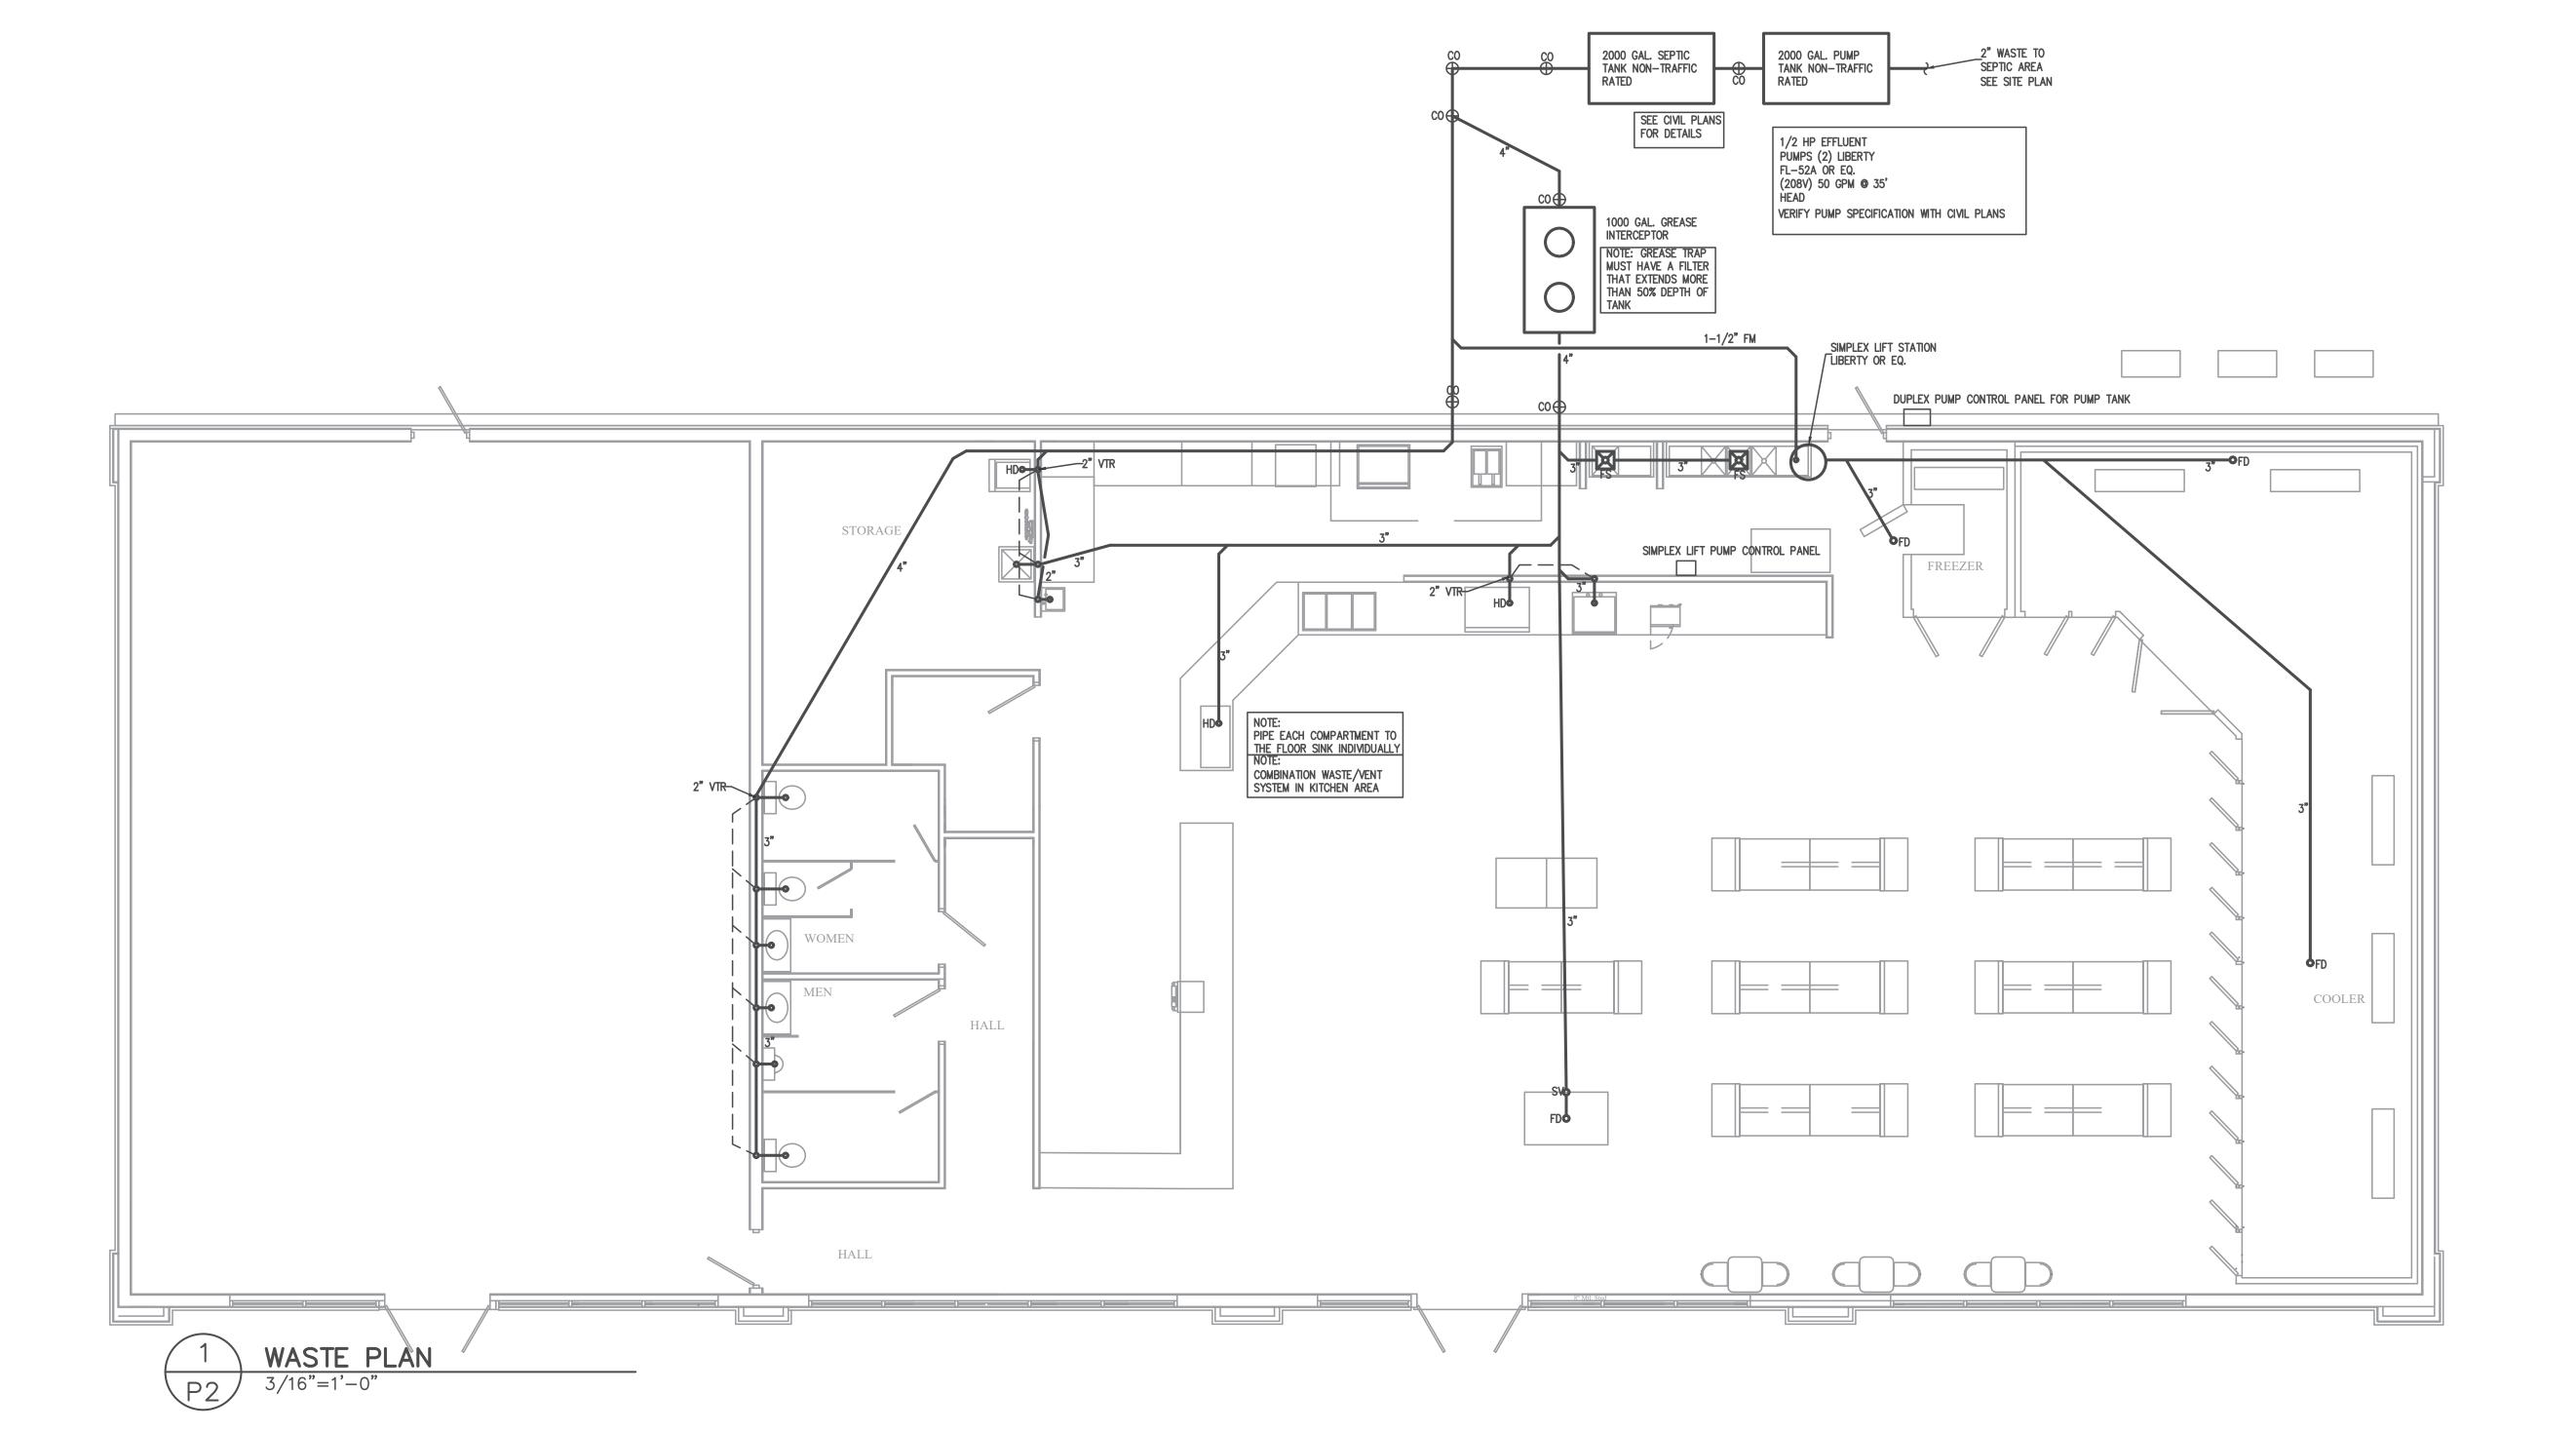


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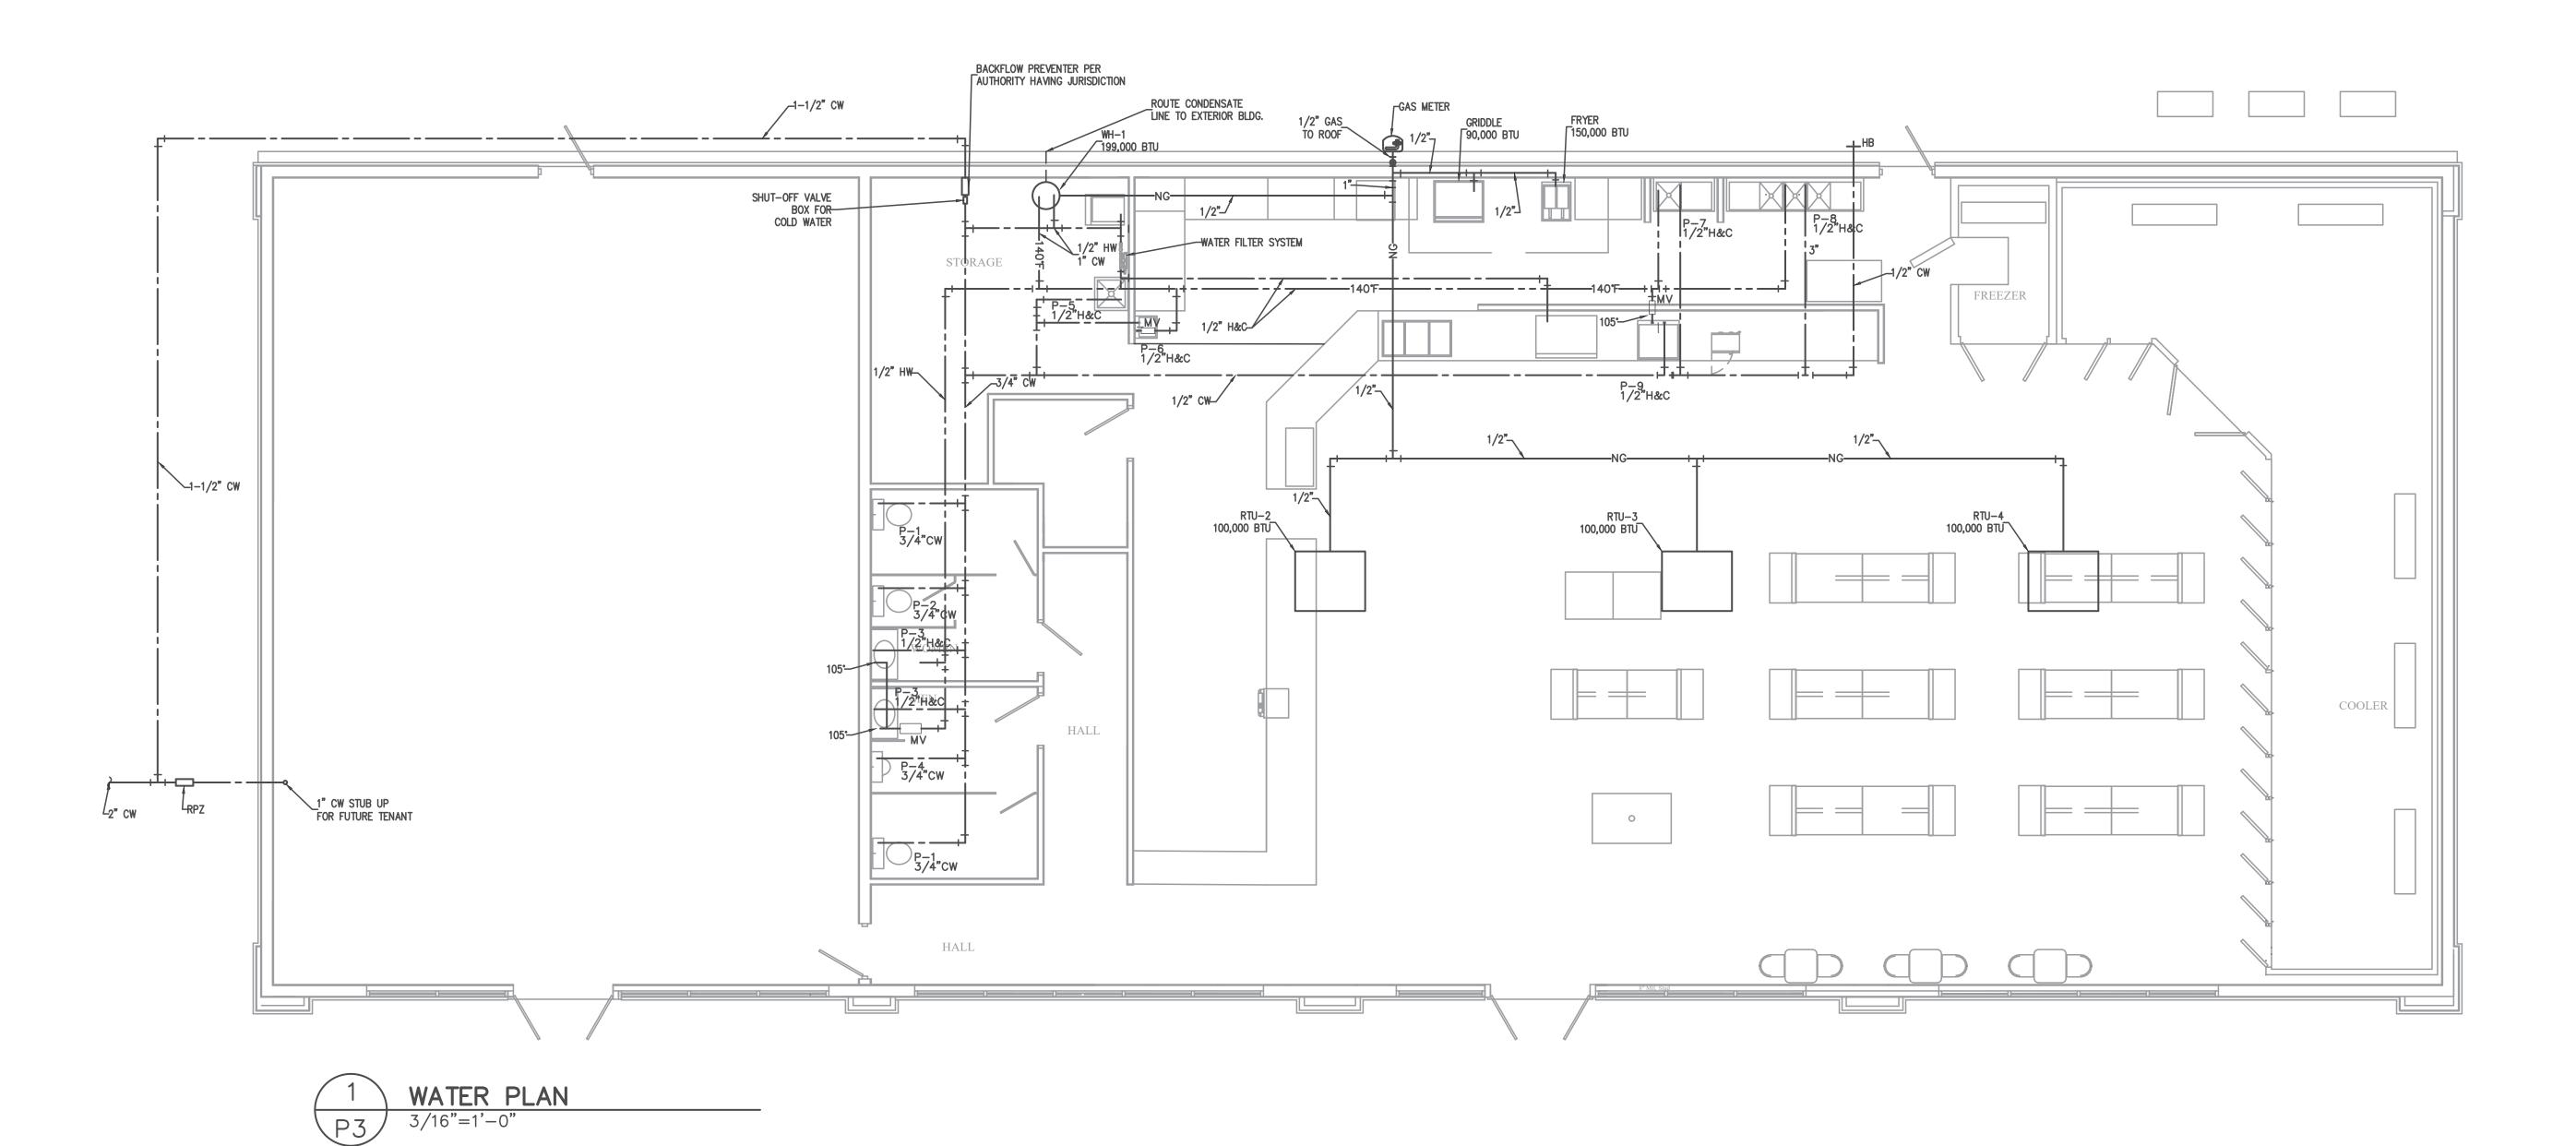
By Regency Construction at 12:43 pm, May 02, 2024



REVISIONS DATE IEW CHAMPS CONVENIENCE STORE U.S. HWAY 401 NORTH Fuquay-Varina, North Carolina 27526 NEW Engineering, Coastal Plains
FIRM # C-2059
FIRM # C-2059
295 Locklear Rd
P.O. Box 1117
Pembroke, NC 28372
Voice: 910-521-7213
WWW.coastalblaineans Anna SCALE: **3/16"=1'-0"** DRAWN BY: **AJO** CHECKED BY: DWG. NUMBER: JOB NUMBER: **2024–056** SHEET NO:

May 01, 2024

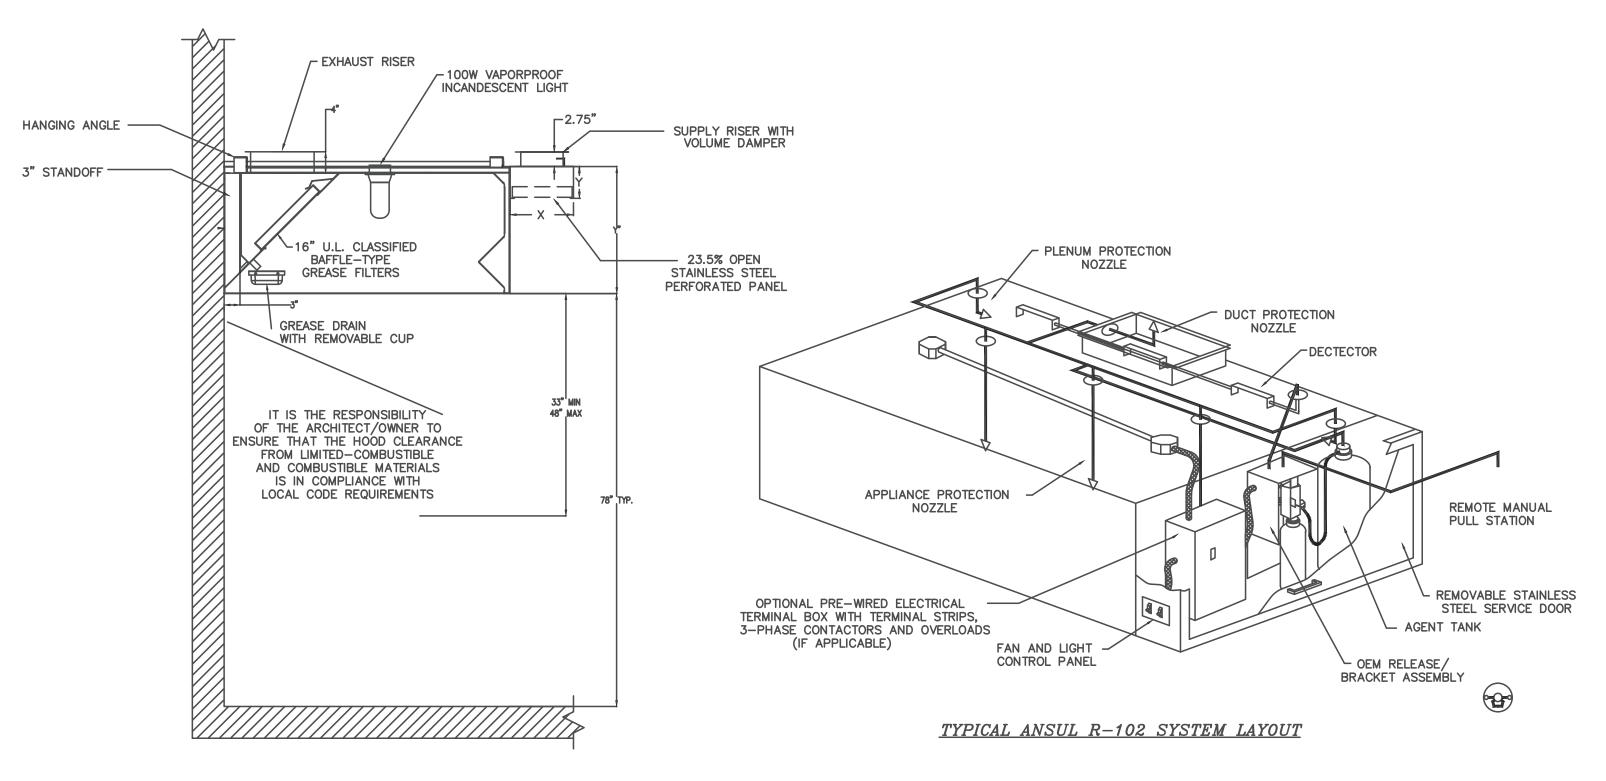
By Regency Construction at 12:43 pm, May 02, 2024



REVISIONS DATE NEW CHAMPS CONVENIENCE STORE U.S. HWAY 401 NORTH Fuquay-Varina, North Carolina 27526 P.A Engineering Coastal Plains SCALE: **3/16"=1'-0"** DRAWN BY: **AJO** CHECKED BY: DWG. NUMBER: JOB NUMBER: **2024–056** SHEET NO: May 01, 2024

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KITCHEN HOOD DETAILS

OUTSIDE AIR CALCULATION -NC 2018 MECHANICAL CODE	(TABLE 403.3.1.1) Vbz = RpPz + RaAz

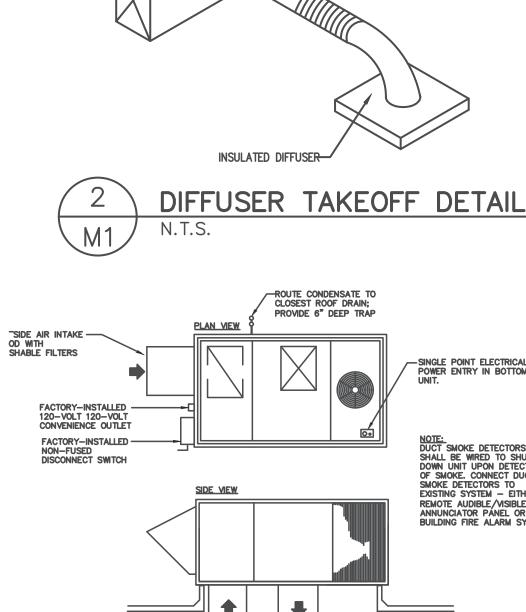
	OCCUPANCY TYPE:	SF (Az)	# OF OCCUPANTS PER 1000 SF	# OF OCCUPANTS (Pz)	O.A. CFM PER PERSON (Rp)	O.A CFM PER SqFt (Ra)	O.A. CFM REQUIRED (Vbz)	EXAUST CFM REQUIRED
	OFFICE	60	5	0.3	5	0.06	5	0
	STORAGE	139	5	0.695	5	0.06	12	0
	MEN'S RESTROOM	139	5	0.695	5	0.06	12	140
RTU-1	WOMEN'S RESTROOM	41	0	0	0	0	0	140
	HALL	41	0	0	0	0.06	2	0
	TOTAL CFM REQUIRED						31	280
	TOTAL CFM FURNISHED						31	280
	KITCHEN	406	0	0	0	0	0	284
RTU-2	SALES	1322	15	19.83	7.5	0.12	307	0
KIU-Z	TOTAL CFM REQUIRED						307	284
	TOTAL CFM FURNISHED						307	284
	SALES	1322	15	19.83	7.5	0.12	307	0
RTU-3	TOTAL CFM REQUIRED						307	0
	TOTAL CFM FURNISHED						307	0

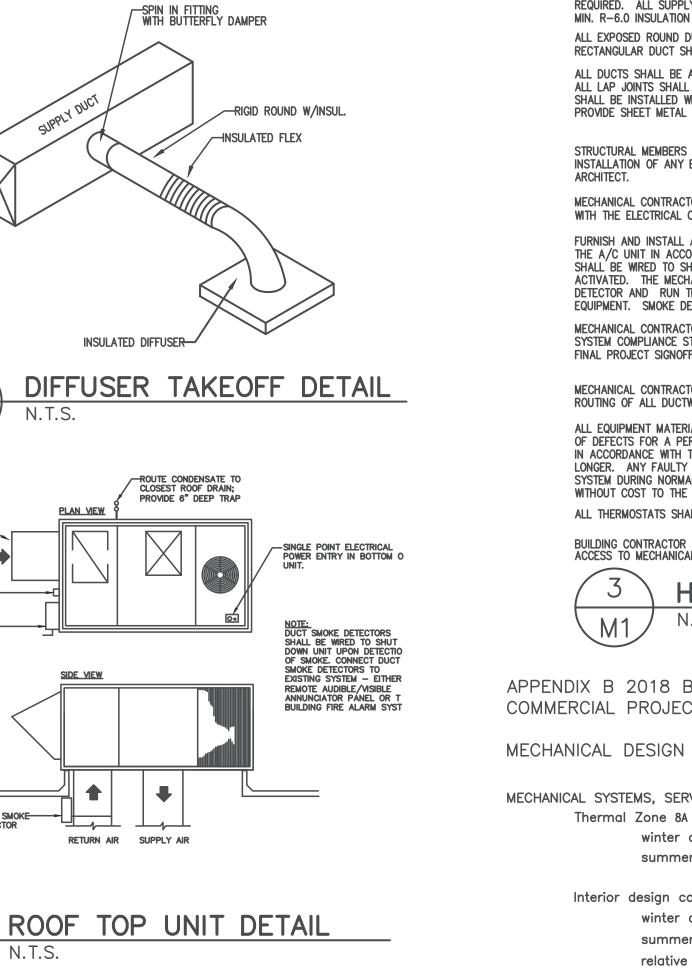
	ROOFTOP UNIT SCHEDULE																		
	CAPACITIES														LINUT				
UNIT NO.	TOTAL CFM	O.A. CFM	EXT. S.P.	EVAP. FAN HP	COMPRESSOR AMPS	PRESSOR NO. OF FAN NO. OF UNIT UNIT UNIT GROSS EER/ HEATING REMARKS								REFRIG.	UNIT NET WEIGHT				
RTU-1	2000	300	0.50"	1	15.9	1	1.4	1	29	40	208	3	60,000	12.0/ 14.0	100,000	81%	TRANE YSC060 PACKAGED ROOFTOP GAS/ELEC W/GFCI RECEPT	R410A	682 LBS.
RTU-2	2000	300	0.50"	1	15.9	1	1.4	1	29	40	208	3	60,000	12.0/ 14.0	100,000	81%	TRANE YSC060 PACKAGED ROOFTOP GAS/ELEC W/GFCI RECEPT	R410A	682 LBS.
RTU-3	2000	300	0.50"	1	15.9	1	1.4	1	29	40	208	3	60,000	12.0/ 14.0	100,000	81%	TRANE YSC060 PACKAGED ROOFTOP GAS/ELEC W/GFCI RECEPT	R410A	682 LBS.

	DIFFUSER/RETURN SCHEDULE												
MARK ON PLANS	CFM	AIR PATTERN	NECK SIZE	RUNOUT SIZE	REMARKS								
A	50-145	4 WAY	6 X 6	6"	PRICE SERIES ASCD SQUARE CONE DIFFUSER WHITE POWDER COAT FINISH, ALUMINUM								
B	150-275	4 WAY	8 X 8	8"	PRICE SERIES ASCD SQUARE CONE DIFFUSER WHITE POWDER COAT FINISH, ALUMINUM								
C	285-400	4 WAY	10 X 10	10"	PRICE SERIES ASCD SQUARE CONE DIFFUSER WHITE POWDER COAT FINISH, ALUMINUM								
D		N/A	12 X 12	SEE PLAN	PRICE SERIES 630FF WHITE POWDER COAT FINISH, ALUMINUM, FILTER RETURN GRILLE								
E		N/A	20 X 20	SEE PLAN	PRICE SERIES 630FF WHITE POWDER COAT FINISH, ALUMINUM, FILTER RETURN GRILLE								

		FAN SCHEDULE												
	MARK	LOCATION	SERVICE	CFM	S.P.	WATTS /HP	RPM	VOLT	PHASE	DRIVE	REMARKS			
	EF-1,2	CEILING	TOILETS	140	.125"	128	1050	120	1	DIRECT	CEILING MOUNTED FAN. PROVIDE W/B.D.D. AND WALL CAP GREENHECK SPA-70 OR EQ. 6"ø TO ROOF/WALL CAP			
	EF-3	ROOF	KITCHEN	3050	1"	1 HP	1730	208	1	DIRECT	PROVIDED BY KITCHEN EQUIP. SUPPLIER			
RN GRILLE	SF-1	ROOF	KITCHEN	2440	0.5"	1 HP	1800	208	1	DIRECT	PROVIDED BY KITCHEN EQUIP. SUPPLIER			

	AIR BALANCE SCHEDULE													
ID	TOTAL AIR	RECIRC. AIR	O/S AIR	EXH. CFM	MUA									
RTU-1	2000	1764	300											
RTU-2	2000	1795	300											
RTU-3	2000	1795	300											
EF-3				3050										
SF-1					2440									
TOTALS			+900	-3050	+2440									
BUILDING PF	RESSURIZATION	V												





ALL WORK SHALL BE IN ACCORDANCE WITH THE 2018 NC MECHANICAL CODE.

ALL DUCTWORK SHALL BE CONSTRUCTED OF GALVANIZED SHEET METAL IN ACCORDANCE WITH ASHRAE & SMACNA. DUCT SIZES SHOWN ARE NET FREE AREA REQUIRED. ALL SUPPLY AND RETURN DUCTS AND FLEX SHALL BE INSULATED WITH MIN. R-6.0 INSULATION UNLESS OTHERWISE NOTED IN THE DRAWING. ALL EXPOSED ROUND DUCT SHALL BE DOUBLE WALL INSULATED. EXPOSED RECTANGULAR DUCT SHALL BE INTERNALLY LINED WITH INSULATION ALL DUCTS SHALL BE AIR TIGHT, RIGID AND FREE FROM VIBRATION AND NOISE. ALL LAP JOINTS SHALL BE IN THE DIRECTION OF FLOW. VOLUME OR SPLITTER DAMPERS SHALL BE INSTALLED WHERE NECESSARY TO GUIDE AND CONTROL THE AIR FLOW. PROVIDE SHEET METAL SLEEVES AND COLLARS WHERE DUCTS PASS THROUGH WALLS.

STRUCTURAL MEMBERS OF THE BUILDING SHALL NOT BE CUT IN ANY MANNER FOR THE INSTALLATION OF ANY EQUIPMENT UNLESS PRIOR APPROVAL IS OBTAINED FROM THE

MECHANICAL CONTRACTOR TO CONFIRM BREAKER/DISCONNECT SIZES OF HIS EQUIPMENT WITH THE ELECTRICAL CONTRACTOR.

FURNISH AND INSTALL A DUCT MOUNTED SMOKE DETECTOR IN THE RETURN DUCT OF THE A/C UNIT IN ACCORDANCE WITH 2018 NC MECHANICAL CODE. THE DETECTOR SHALL'BE WIRED TO SHUT DOWN THE FAN IN THE EVENT THE DETECTOR IS ACTIVATED. THE MECHANICAL CONTRACTOR SHALL FURNISH AND INSTALL THE DUCT DETECTOR AND RUN THE NECESSARY CONTROL WIRING FROM THE DETECTOR TO HIS EQUIPMENT. SMOKE DETECTORS ARE ONLY REQUIRED FOR UNITS SUPPLYING 2000 CFM OR MORE.

MECHANICAL CONTRACTOR SHALL PROVIDE A TEST AND BALANCE REPORT SYSTEM COMPLIANCE STATEMENT REQUIRES A WRITTEN T&B REPORT. FINAL PROJECT SIGNOFF WILL BE DENIED WITHOUT THIS REPORT

MECHANICAL CONTRACTOR IS RESPONSIBLE FOR COORDINATING THE LOCATIONS AND ROUTING OF ALL DUCTWORK WITH OTHER TRADES TO AVOID CONFLICTS.

ALL EQUIPMENT MATERIALS AND WORKMANSHIP SHALL BE GUARANTEED TO BE FREE OF DEFECTS FOR A PERIOD OF ONE YEAR AFTER FINAL ACCEPTANCE OF THE WORK OR IN ACCORDANCE WITH THE PARTICULAR MANUFACTURER'S STANDARD GUARANTEE IF LONGER. ANY FAULTY MATERIAL OR WORKMANSHIP OR FAILURE OF ANY PART OF THE SYSTEM DURING NORMAL OPERATIONS UNDER THIS GUARANTEE SHALL BE CORRECTED WITHOUT COST TO THE OWNER.

ALL THERMOSTATS SHALL BE OF A PROGRAMMABLE TYPE.

BUILDING CONTRACTOR SHALL PROVIDE PERMANENT ACCESS TO ROOF STRUCTURE FOR ACCESS TO MECHANICAL EQUIPMENT WHEN ROOF STRUCTURE IS GREATER THAN 16'-0" HIGH.



APPENDIX B 2018 BUILDING CODE SUMMARY FOR ALL COMMERCIAL PROJECTS

MECHANICAL DESIGN

MECHANICAL SYSTEMS, SERVICE SYSTEMS AND EQUIPMENT

winter dry bulb: 22° summer dry bulb: 93° Interior design conditions relative humidity: 50%

131,765 BTU/H Building cooling load:

Building heating load:

Mechanical Spacing Conditioning System description of unit: ___SPLIT SYSTEM HEAT PUMP heating efficiency: <u>8.50 HSPF</u> cooling efficiency: <u>17.0 SEER</u>

size category of unit: <65,000 BTU

Size category. If oversized, state reason.:

95,137 BTU/H

Size category. If oversized, state reason.:

List equipment efficiencies:

CONVENIENCE S'AY 401 NORTH

A, North Carolina 275

REVISIONS

DATE

En Plains Coastal

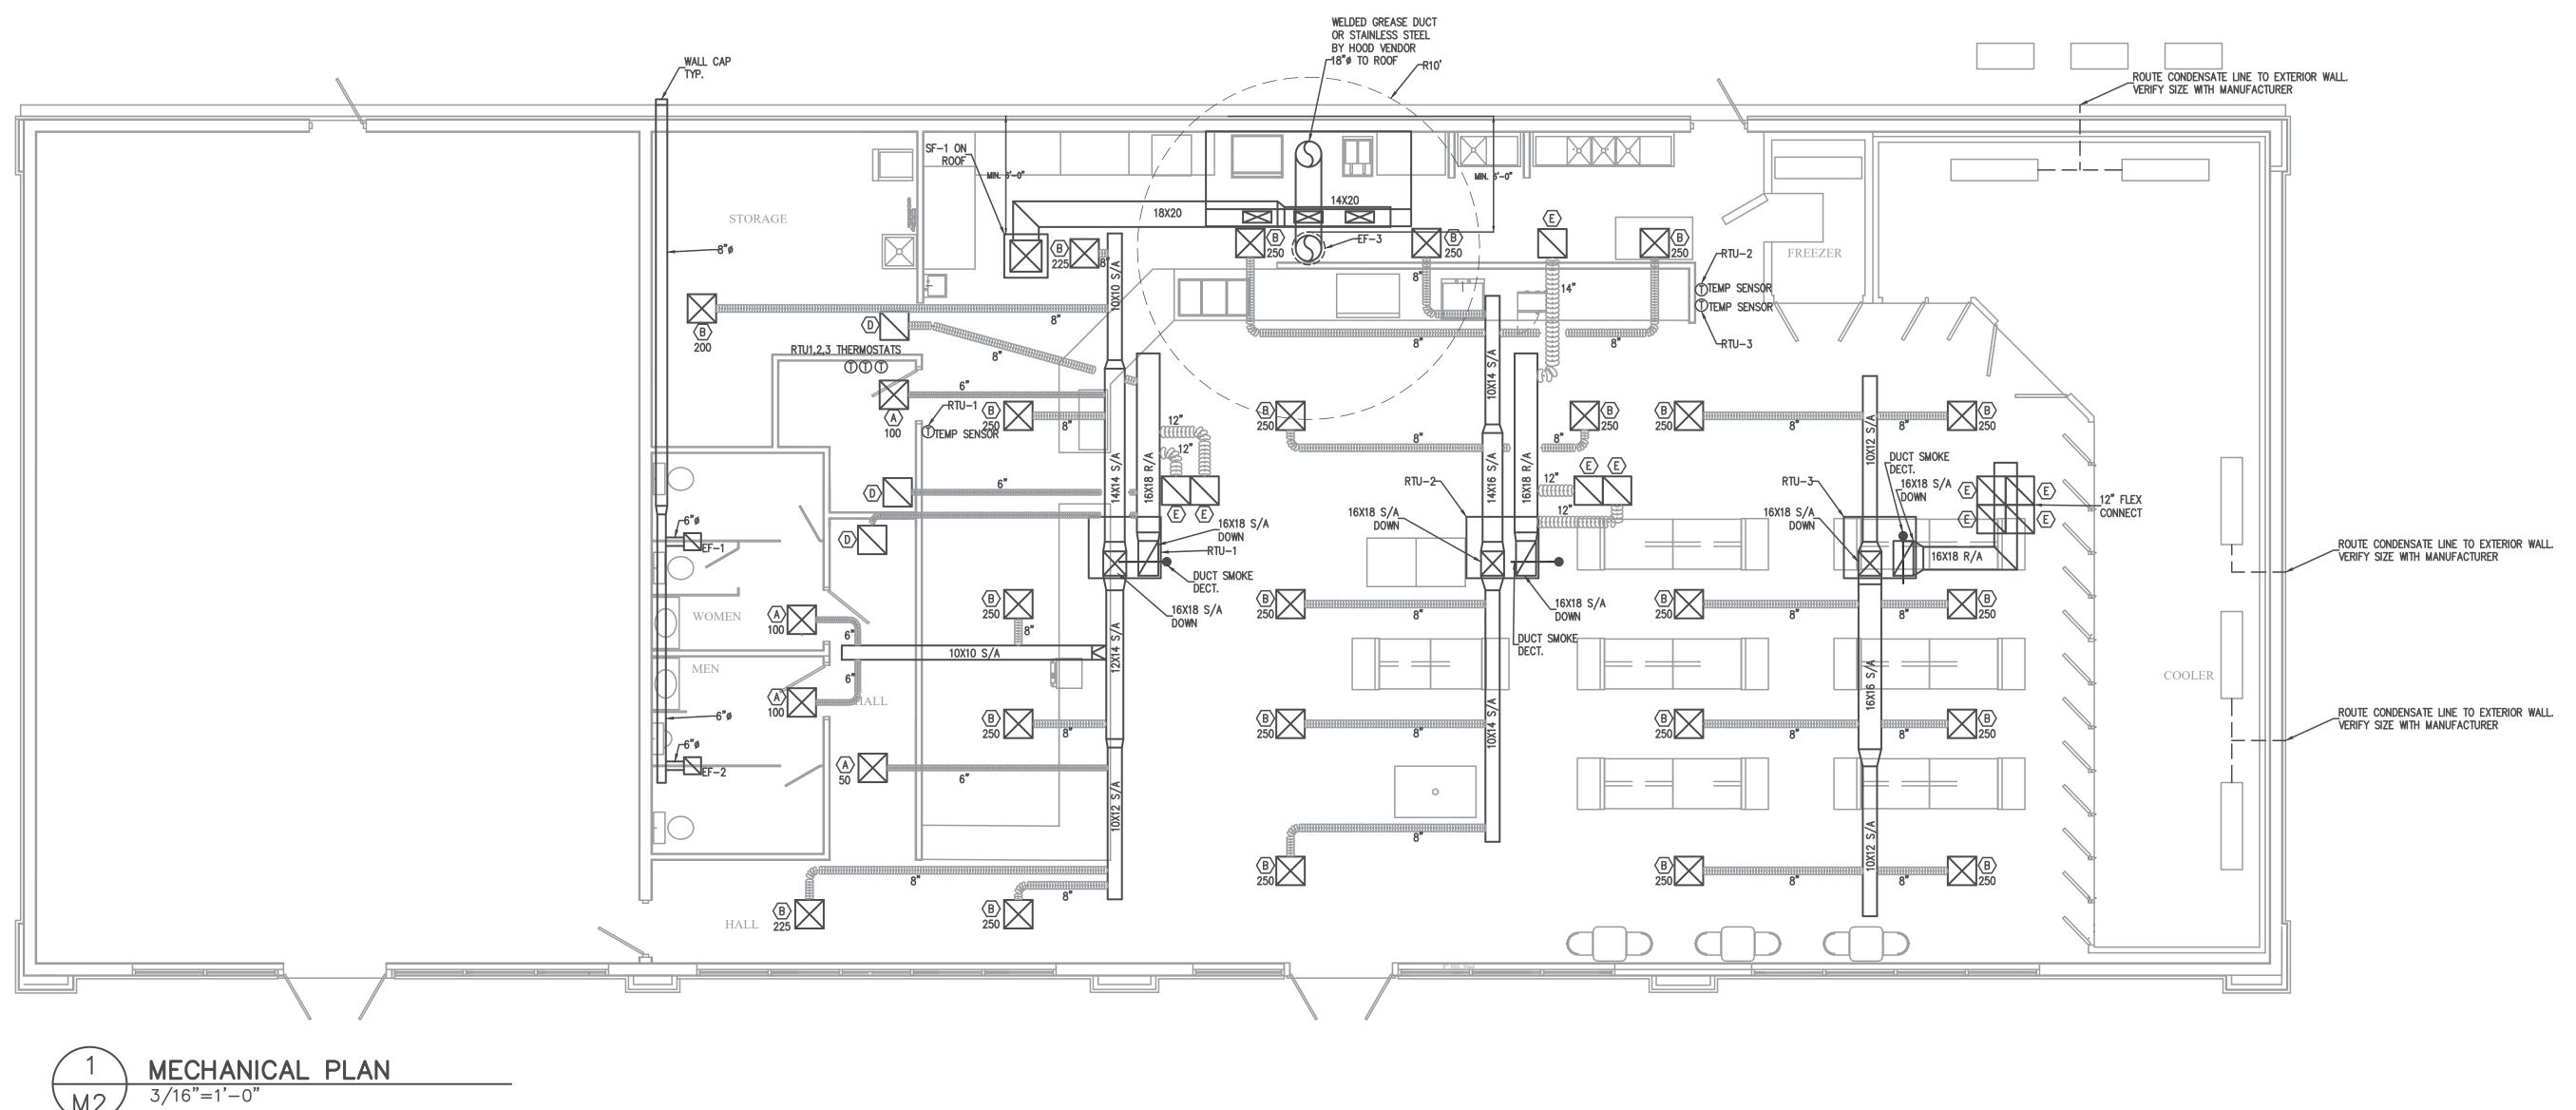
SCALE: **3/16"=1'-0"**

DRAWN BY: AJU
DATE:
CHECKED BY:
DWG. NUMBER:
JOB NUMBER: 2024–056
SHEET NO:



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DATE NEW CHAMPS CONVENIENCE STORE U.S. HWAY 401 NORTH Fuquay-Varina, North Carolina 27526 Ingineering, Coastal Plains SCALE: **3/16"=1'-0"** DRAWN BY: **AJO** DATE: CHECKED BY: DWG. NUMBER: JOB NUMBER: **2024–056** SHEET NO: May 01, 2024

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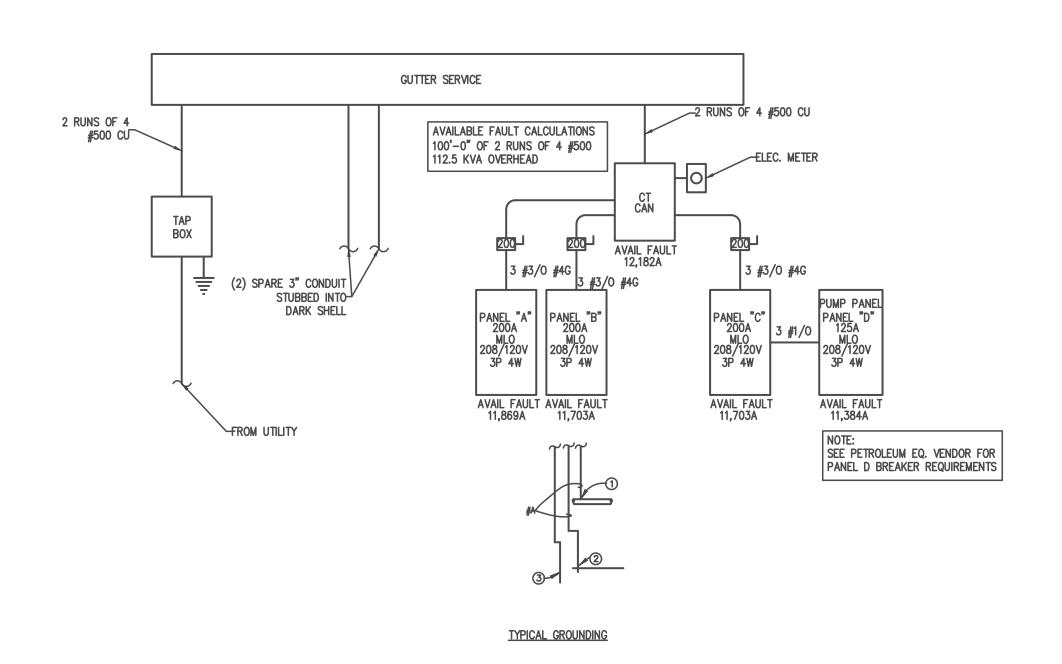
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By Regency Construction at 12:42 pm, May 02, 2024

A															
1	ITING FL FROM U			E	VOLTS 208Y/120V 3P 4W BUS AMPS 200 NEUTRAL 100%						AIC 22,000 MAIN BKR LUGS STAN	MLO			
CKT	CKT BKR	CIDCUIT	DESCRIPTION			OAD KV		CKT	CKT BKR	CIDCUIT	DESCRIPTION	NI.		OAD KV	
#			DESCRIP HON		A 2.4	В	С	#					A	В	С
1	20/1	WH-1			2.4			2	20/1	RECEPT	E AND STOR ACLE	AGE	0.9		
3 5 7	20/1 40/3	ICE MAKI RTU-1	ER		2.72	1.82	2.72	4 6 8	20/1 20/1	OFFICE	E RECEPTACLI RECEPTACLI WOMEN TOI	E	0.36	0.54	0.72
	l				2.72				20/1	RECEPT	ACLE	LEI	0.36		
9 11	20/1	1	REP TABLE	_	0.40	2.72	0.528	10	20/1 20/1	CASHIEF	ECEPTACLE R AREA REC		4.00	0.72	1.08
13 15 17	20/1 20/2	SF-1	P RECEPTACLE	<u>-</u>	0.18	0.96	0.96	14 16 18	20/2 20/2	EF-3	' CASE HEA	IED	1.22	1.22	0.96
19	-/1 20/1	SHUNT TRIP STORAGE,MEN & WOMEN & HALL EF-1, EF-2, LIGHTING			0	0.563	0.00	20	20/1	SPACE			0.96	0	
23	20/1	SPACE	-1, EF-2, LIC	∍⊓ IING			0	24	20/1	SPACE					0
25 27	20/1 20/1	SPACE SPACE			0	0		26 28	20/1 20/1	SPACE SPACE			0	0	
29	20/1 20/1	SPACE SPACE			0		0	30 32	20/1 20/1	SPACE SPACE			0		0
33	20/1 20/1	SPACE SPACE				0	0	34 36	20/1 20/1	SPACE SPACE				0	0
37 39	20/1 20/1	SPACE SPACE			0	0		38 40	20/1 20/1	SPACE SPACE			0	0	
41	20/1	SPACE					0	42	20/1	SPACE					0
									TO	TAL CON	NECTED KVA	BY PHASE	8.74	8.55	6.97
			CONN KVA	CALC K	V A						CONN KVA	CALC KV	A		
LAR MOT	LIGHTING 0.307 0.384 LARGEST MOTOR 1.92 0.48 MOTORS 4.1 4.1 RECEPTACLES 4.5 4.5			4.1	(25 (10	25%) 5%) 00%) 0%>10)		CONT			0.528 4.26 2.4 1.75 8.17	0.528 5.33 2.4 0 8.17	(100 (125 (100 (0%) (100	5%) 0%))	
									L LOAD NCED 3-	-PHASE L	.OAD	25.9 71.9 A	_		

5001	4					0000//4/	201/ 70	4144		AIO 00 000			
ROOM	и NTING FL	IISH			VOLTS 208Y/120V 3P 4W AIC 22,000 BUS AMPS 200 MAIN BKR MLO								
	FROM U				NEUTRAL 100% LUGS STANDARD								
NOTE													
CKT	CKT				L	OAD KV	A	СКТ	CKT		L		A
#	BKR	CIRCUIT	RCUIT DESCRIPTION			В	С	#	BKR	CIRCUIT DESCRIPTION	Α	В	С
1	40/3	RTU-3			2.72			2	20/1	ROOFTOP RECEPTACLE	0.18		
3						2.72		4	20/1	WIF EVAPORATOR		0.5	
5							2.72	6	20/1	WIC EVAPORATOR			0.5
7	20/1	+	PORATOR		0.5			8	20/1	WIC EVAPORATOR	0.5		
9	20/1	Į.	PORATOR			0.5		10	20/1	WIC EVAPORATOR		0.5	_
11	40/3	WIF CON	DENSOR				2.84	12	30/3	WIC BEER CONDENSOR			2
13					2.84	0.04		14			2		
15	70 /7	WIC CON	DENICOD		-	2.84		16	00 /1	SDAGE	-	2	
17 19	30/3	WIC CON	DENSOR		2		2	18 20	20/1	SPACE SPACE	0		0
21						2		22	20/1 20/1	SPACE		0	
23	30/2	PUMP TA	VVIK				1.18	24	20/1	SPACE			0
25	00/2	1 Own 17	NAIX.		1.18		1.10	26	20/1	SPACE	0		
27	20/1	SPACE				0		28	20/1	SPACE		0	
29	20/1	SPACE			†		0	30	20/1	SPACE	1		0
31	20/1	SPACE			0			32	20/1	SPACE	0		
33	20/1	SPACE			1	0		34	20/1	SPACE	Ì	0	
35	20/1	SPACE					0	36	20/1	SPACE			0
37	20/1	SPACE			0			38	125/3	PANEL D	0		
39	20/1	SPACE				0		40				0	
41	20/1	SPACE					0	42					0
									TO	TAL CONNECTED KVA BY PHASE	11.9	11.1	11.2
			CONN KVA	CALC K	VA					CONN KVA CALC KV	'A		
LARGEST MOTOR 8.52 2.13				2.13	—— (2)	5%)		RFCF	PTACLES	0.18 0.18	— (50°	%>10)	
MOTORS 25.9 25.9					• •			HEAT		1.75 0	(0%)	,	
WIOTORS 25.9 25.9			20.0	(10	. 373)		COOL		8.17 8.17	(100			
								TOTAL LOAD 36.4				•	
						BALANCED 3—PHASE LOAD 101 A							
								J, 12/1					

В															
	ITING FL FROM U	LUSH TILITY			VOLTS : BUS AMF NEUTRAL	PS 200)	4W			AIC 22,000 MAIN BKR M LUGS STAND				
CKT	CKT	CIDCUIT	DECODIDION	. 1		OAD KV		CKT	CKT	CIDCUIT	DECODIDITION	ı		OAD KV	
#	BKR	CIRCUIT	DESCRIPTION	N	A	В	С	#	BKR	R CIRCUIT DESCRIPTION			Α	В	С
1 3 5	40/3	RTU-2			2.72	2.72	2.72	2 4 6	20/1 20/1 20/1	FLY FAI SIGNAGE	Ξ		0.18	0.76	0.25
7 9 11	20/1 30/2	3 WELL GFCI BKI			0.72	1.81	1.81	8 10 12	20/2 20/1	GFCI BK	KER		1.2	1.2	0.984
13 15 17	20/1 20/1 20/1	KITCHEN COOLER	ERAGE DISPI GFCI RECEF		0.345	0.36	0.516	14 16 18	20/1 20/1 20/1	KITCHEN KITCHEN	AVE OVEN I GFCI RECEP I RECEPTACLE		1.8	0.54	0.54
19 21 23	20/1 20/1 20/1	SALES L SALES L WALL PA		0.692	1.04	0.369	20 22 24	20/1 20/1 20/1	FREEZEI	IGHTING & COOLER LIGHTING RECEPTACLE GFCI		0.735	0.32	0.36	
25 27 29 31	20/2 20/1 20/1	SPACE SPACE	ΛP		1.18	0	0	26 28 30 32	-/1 20/1 20/1 20/1	SHUNT KITCHEN SPACE SPACE	TRIP I LIGHTING		0	0.389	0
33 35 37 39	20/1 20/1 20/1 20/1	SPACE SPACE SPACE SPACE			0	0	0	34 36 38 40	20/1 20/1 20/1 20/1	SPACE SPACE SPACE			0	0	0
41	20/1	SPACE					0	42	20/1	SPACE					0
		1							ТО	TAL CONI	NECTED KVA	BY PHASE	9.57	9.14	7.55
			CONN KVA	A CALC K	VA	<u> </u>	1				CONN KVA	CALC KV	А	1	1
LIGHTING 3.79 4.74 LARGEST MOTOR 2.4 0.6 MOTORS 3.58 3.58 RECEPTACLES 2.7 2.7				0.6 3.58	(125%) (25%) (100%) (50%>10)			KITCHEN EQUIPMENT CONTINUOUS NONCONTINUOUS HEATING COOLING TOTAL LOAD BALANCED 3-PHASE			2.32 4.6 1.11 1.75 8.17	2.32 5.75 1.11 0 8.17 29 80.4 A	(100 (125 (100 (0%) (100	5%) 0%))	



GROUNDING ELECTRODE DETAILS

GROUNDING ELECTRODE CONDUCTORS SHALL BE #4 BARE COPPER. OTHER MATERIAL AND INSTALLATION PER NEC

① CONNECT TO METALIC WATER PIPE AS REQ'D.

3 3/4"x10' LONG COPPER CLAD GROUNDING ROD W/ #6 COPPER GROUND.

2 #A COPPER GROUND PLACED TO BLDG STEEL

A=#4 CU PANEL A,B,C

CONTRACTOR SHALL COORDINATE WITH LOCAL UTILITY FOR SERVICE. A COMPLETE AND WORKING SYSTEM IS REQUIRED FOR COMPLIANCE WITH THESE DOCUMENTS. DETERMINE THE POINT OF CONNECTION TO THE UTILITY WITH THE UTILITY REPRESENTATIVE AND PROVIDE ACCORDINGLY FOR A COMPLETE WORKING SYSTEM.

WIRE AND CABLE SHALL BE INSULATED, TYPE THWN OR THHN, 600 VOLTS, WITH COPPER CONDUCTORS. CONDUCTOR SIZES NO. 8 AWG AND LARGER MAY BE STRANDED. CONDUCTORS SIZES NO. 10 AWG AND SMALLER MAY BE SOLID OR STRANDED. NO ROMEX PERMITTED.

EMT SHALL BE GALVANIZED STEEL TUBING, 1/2-INCH MINIMUM SIZE, EQUAL TO ELECTRUNITE BRAND OR APPROVED AND USED ONLY WITH HEXAGONAL ALL STEEL COMPRESSION FITTINGS.

PLASTIC CONDUIT SHALL BE RIGID, 3/4—INCH MINIMUM NON—METALLIC, HEAVY DUTY, HIGH IMPACT, POLYVINYLCHLORIDE (PVC), TYPE I WILL BE USED FOR CONCRETE ENCASEMENT. FITTINGS SHALL BE THE SAME MATERIALS AND MANÙFACTURER AS THE PLASTIC CONDUIT.

FLEXIBLE METAL CONDUIT SHALL BE 1/2— INCH MINIMUM SINGLE STRIP, STEEL, HOT DIPPED GALVANIZED INSIDE AND OUTSIDE, MAXIMUM LENGTH 72 INCHES FOR LIGHTING AND 36" FOR MOTORS. FLEXIBLE METAL CONDUIT SHALL BE LIQUIDTIGHT OR WATERTIGHT WITH PVC JACKET WHERE USED IN DAMP, WET OR OUTSIDE AREAS, AND LIQUIDTIGHT OR WATERTIGHT CONNECTORS SHALL BE USED.

NO RECEPTACLES OR TEL. OUTLETS TO BE MOUNTED BACK TO BACK, KEEP AT LEAST 2 INCHES BETWEEN RECEPTACLES AND TEL. OUTLETS.

ALL CONDUCTOR SHALL BE COPPER WITH A MINIMUM SIZE OF #12 AWG EXCEPT FOR FIRE ALARM. THESE CONDUCTORS SHOULD COMPLY WITH NFPA.

CONTRACTOR SHALL ALIGN FIXTURES, SMOKE DETECTORS, CEILING DIFFUSERS ETC. AS REQUIRED TO PROVIDE A UNIFORM PRESENTATION. AT NO TIME WILL AN IONIZATION DETECTOR BE LOCATED WITHIN 3'-0" OF A SUPPLY OR RETURN AIR

CIRCUIT BREAKERS AND WIRE ARE SIZED FOR SPECIFIC EQUIPMENT. BEFORE ORDERING WIRE, BREAKERS AND CONDUIT FOR THIS PROJECT THE CONTRACTOR SHALL COORDINATE WITH THE OTHER CONTRACTORS ON THE JOB AND VERIFY THE ELECTRICAL DATA FOR THE EQUIPMENT WHICH WILL ACTUALLY BE INSTALLED, RECOMPUTING WIRE AND BREAKER SIZES IF REQUIRED BY THE NEC.

ALL CONDUIT TERMINATING IN THE CEILING CAVITIES IS TO BE LABELED.

ALL CONDUIT SHALL BE COLOR CODED WITH 1/2" WIDE TAPE, 10'-0" ON CENTER IN ACCORDANCE WITH STANDARD INDUSTRY PRACTICE.

THE MOUNTING HEIGHTS AND LOCATIONS OF ALL WALL MOUNTED OUTLETS AND JUNCTION BOXES SHALL BE REVIEWED AND COORDINATED WITH THE ARCHITECT AND OWNER, PRIOR TO INSTALLATION, FOR USE WITH ACTUAL EQUIPMENT.

EACH CONTRACTOR WILL PROVIDE HIS OWN SUPPORT OF ALL DEVICES AND EQUIPMENT PROVIDED BY HIM AND SHALL SUPPORT SUCH EQUIPMENT PER APPROVED GOVERNING CODES OR PER APPROVAL OF THE ENGINEER/ARCHITECT. UNACCEPTABLE WORKMANSHIP OR MATERIALS SHALL REPLACED AT THE REQUEST OF THE ENGINEER/ARCHITECT AT THE CONTRACTORS EXPENSE.

THE CONTRACTOR SHALL REFER TO THE ARCHITECTURAL PLANS FOR FLOOR PLAN DIMENSIONS.

THE CONTRACTOR SHALL COORDINATE ANY AND ALL WORK WITH OTHER TRADES INVOLVED IN THIS PROJECT PRIOR TO THE INSTALLATION OF HIS EQUIPMENT, SO AS TO AVOID CONFLICTS DURING CONSTRUCTION AND ALLOW FOR OPTIMUM WORKING

ALL FUSES DISCONNECT SWITCHES AND BREAKER SIZES SHOWN FOR MECHANICAL EQUIPMENT SHALL BE VERIFIED BEFORE PURCHASE AND INSTALLATION OF SAID EQUIPMENT WITH THE EQUIPMENT SUPPLIER AND

WHERE EQUIPMENT PENETRATES EXTERIOR WALL OR ROOF THEY SHALL BE PROPERLY SEALED WITH METHODS APPROVED BY THE ARCHITECT/ENGINEER.

ALL WORK IS TO BE DONE IN STRICT COMPLIANCE WITH THE LATEST VERSION OF THE NEC AND APPLICABLE STATE CODES

RECESSED FIXTURES INSTALLED IN RATED ASSEMBLIES SHALL BE INSTALLED WITH AN ENCLOSURE SO AS TO MAINTAIN THE RATING OF



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Engineer Plains Coastal

SCALE: 3/16"=1'-0"
DRAWN BY: AJO
DATE:
CHECKED BY:
DWG. NUMBER:
JOB NUMBER: 2024–05
SHEET NO:

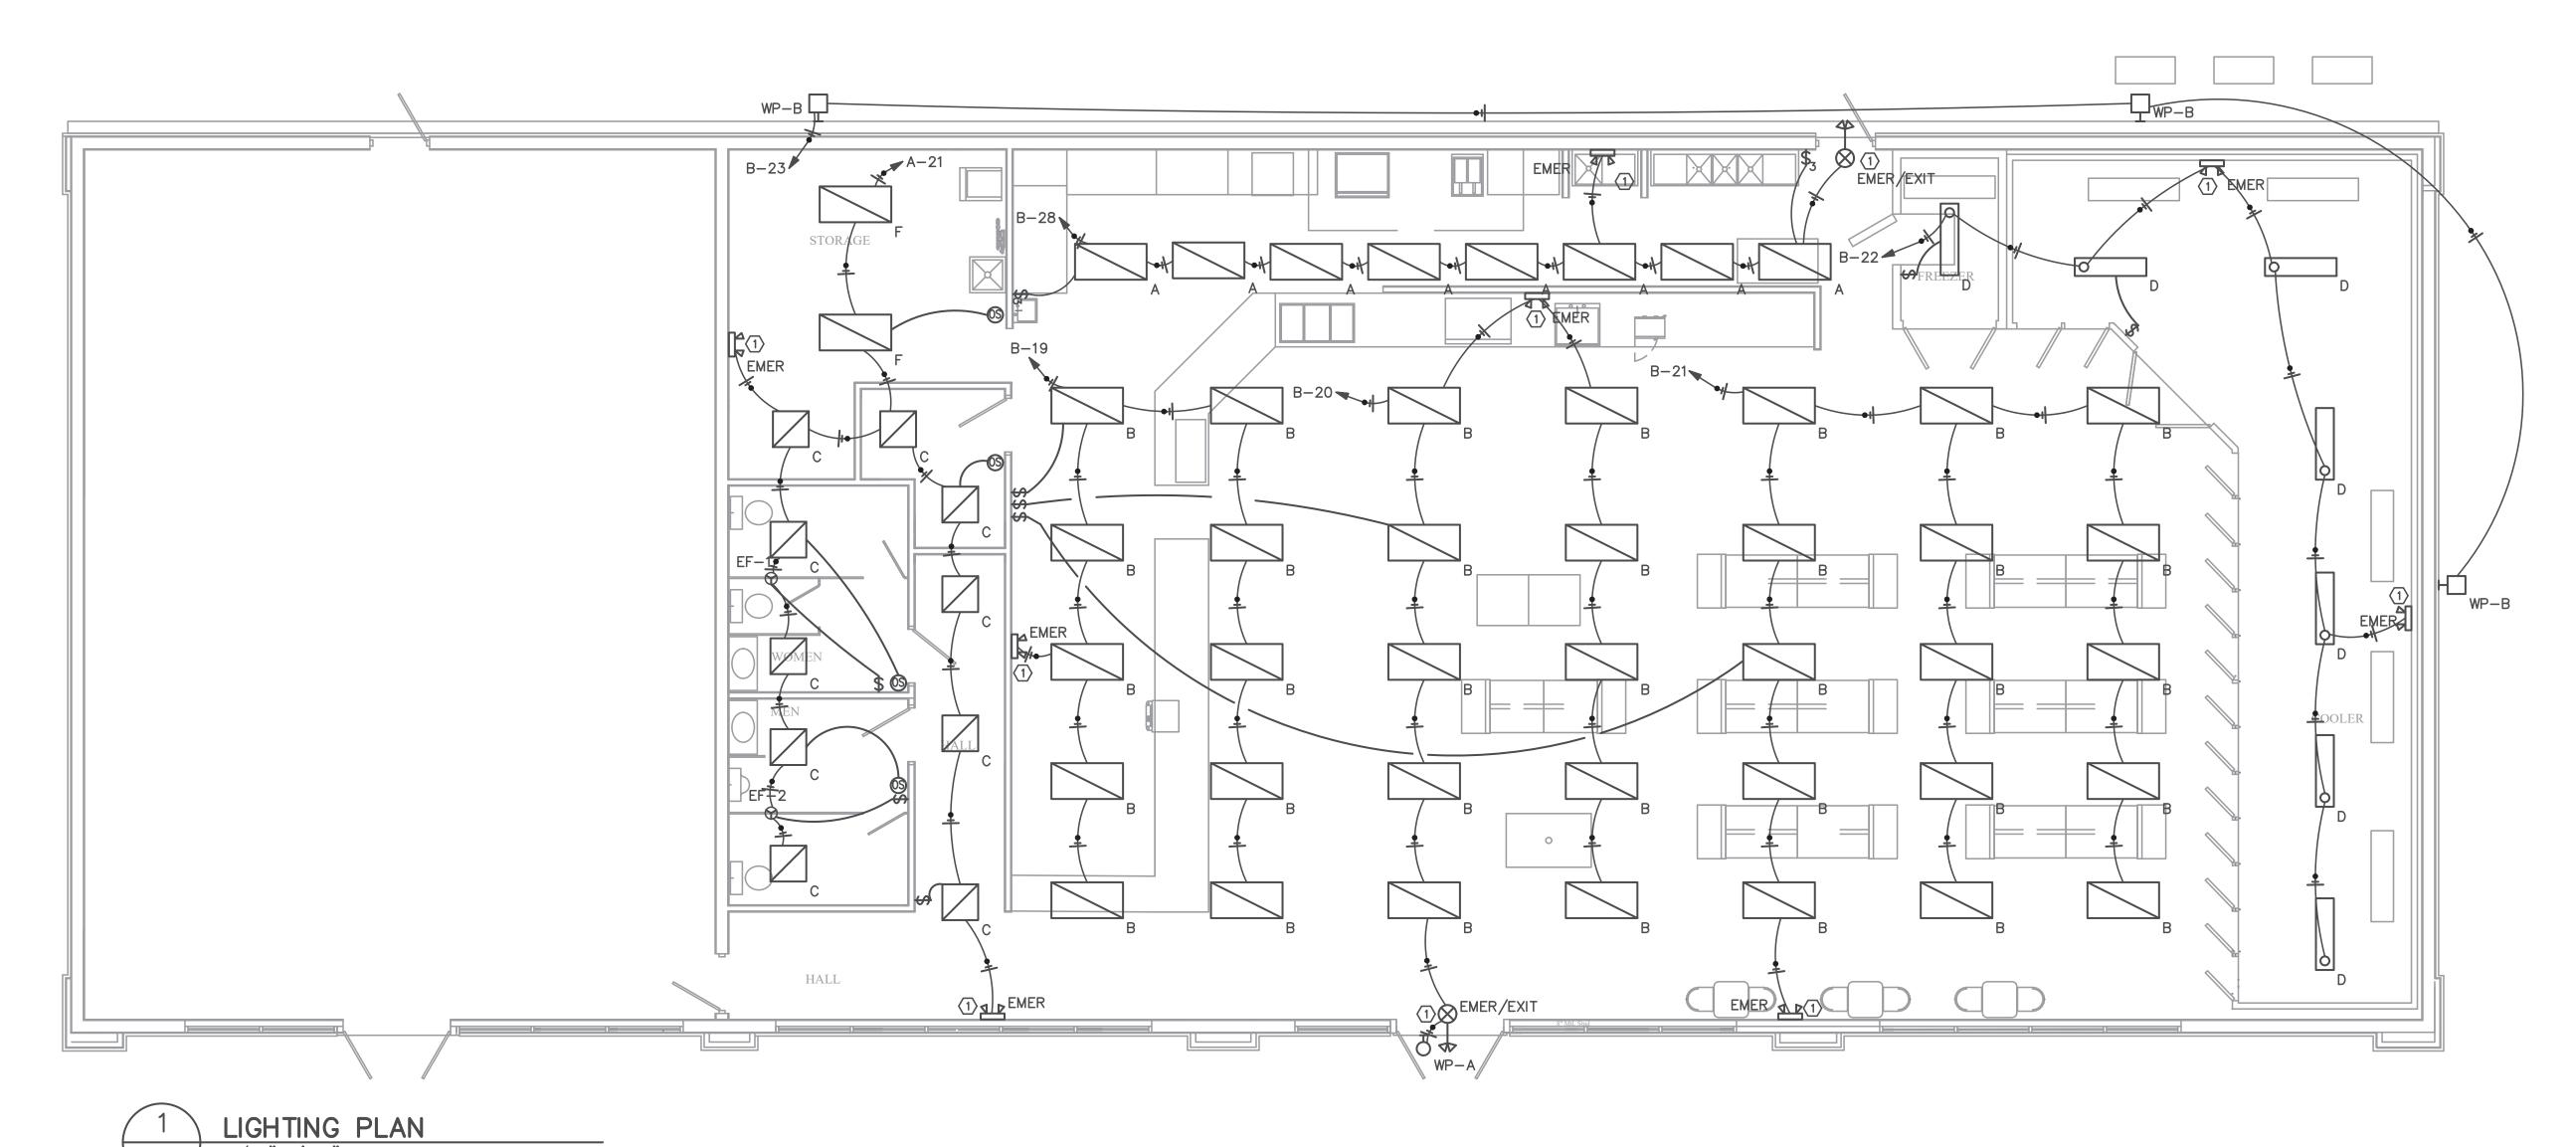


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BRYANT (HUBBELL) MSD1000W1 OR EQUAL WALL SWITCH OCCUPANCY SENSOR DUAL (ULTRASONIC AND PASSIVE INFRARED) TECHNOLOGY

SEE FIXTURE SCHEDULE

BRYANT (HUBBELL) MSD1000W1 OR EQUAL WALL SWITCH OCCUPANCY SENSOR DUAL (ULTRASONIC AND PASSIVE INFRARED) TECHNOLOGY 1,000 SQUARE FOOT COVERAGE 800W INCANDESCENT, 1000W FLUORESCENT AT 120V AC ALL O.S. TO BE WALL MOUNTED TO ALLOW FOR OCCUPANT MANUAL OVERRIDE

(1) UNSWITCHED LEG OF CIRCUIT TO BATT PACK, SWITCHED LEG TO NORMAL LED DRIVER

DIX B 2018 BUILDING CODE SUMMARY FOR ALL COMMERCIAL PROJECTS

CICAL DESIGN

AL SYSTEM AND EQUIPMENT

of Compliance:

nergy Code:

SHRAE 90.1:

Prescriptiv

SHRAE 90.1: Prescriptive Performance schedule (each fixture type)

amp type required in fixture
umber of lamps in fixture
allast type used in the fixture
umber of ballasts in fixture
atal wattage per fixture

otal interior wattage specified vs. allowed (whole building or space by space)

otal exterior wattage specified vs. allowed

dditional Prescriptive Compliance

506.2.1 More Efficient HVAC Equipment

506.2.2 Reduced Lighting Power Density

506.2.3 Energy Recovery Ventilation Systems

506.2.5 Energy Recovery Vendedon Systems

506.2.4 Higher Efficiency Service Water Heating

506.2.5 On-Site Supply of Renewable Energy

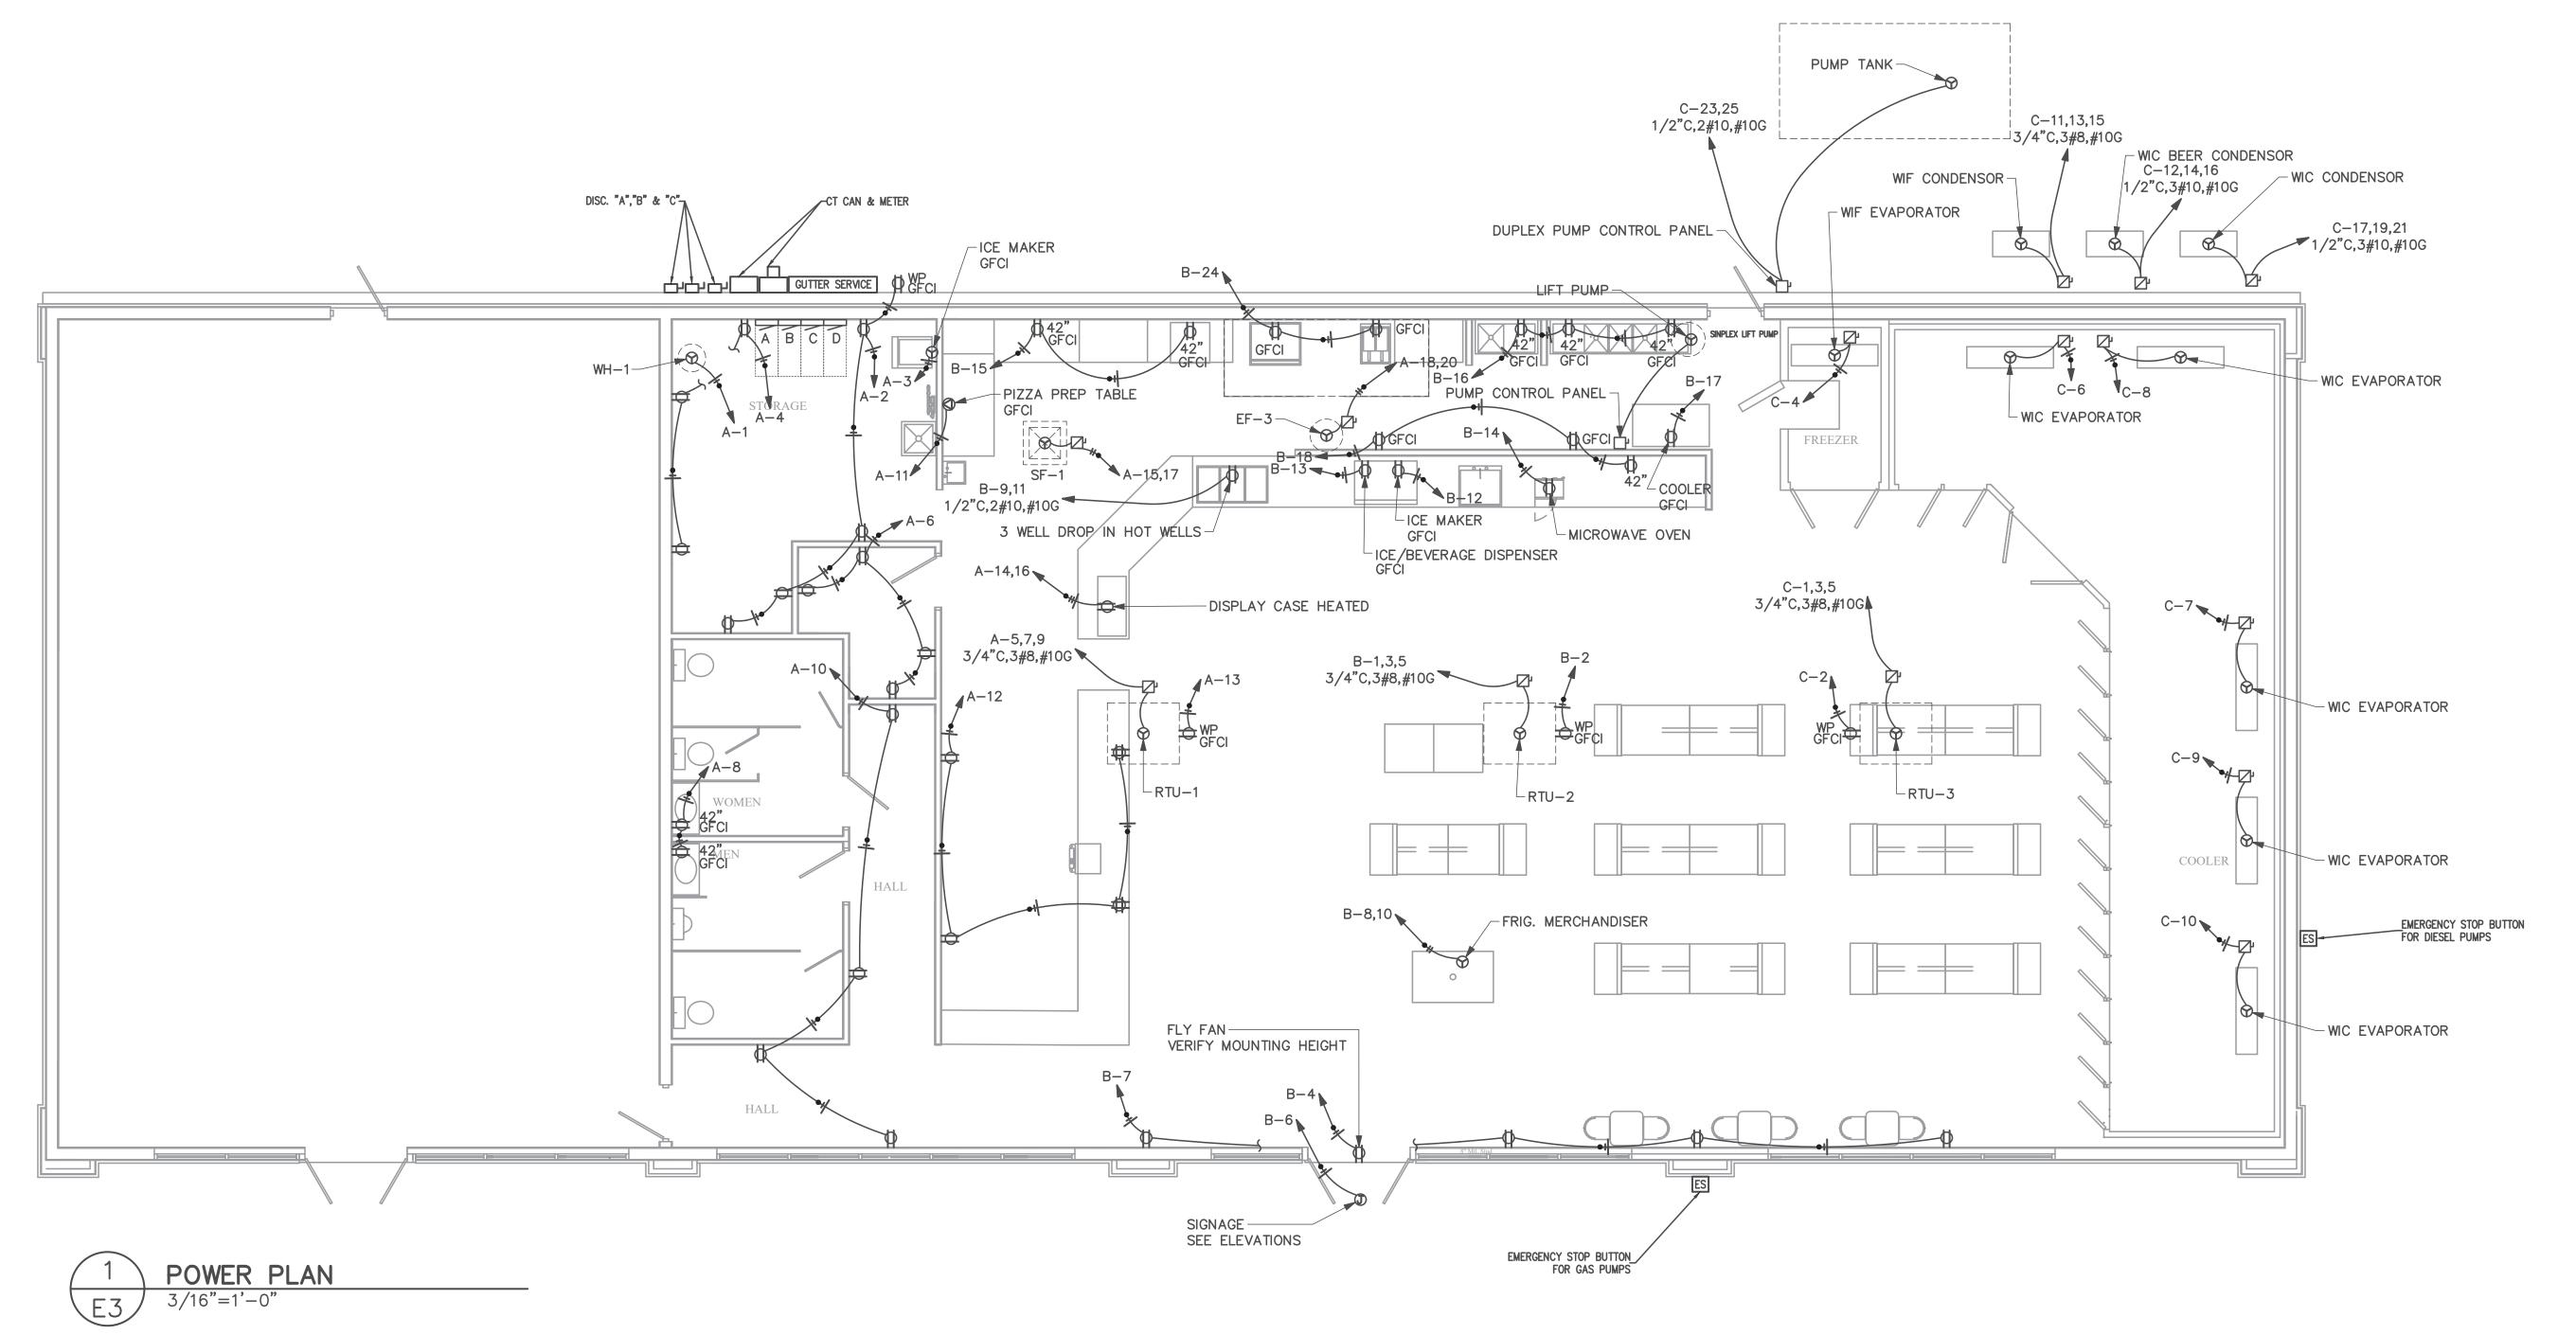
506.2.6 Automatic Daylighting Control Systems

LUMI	NAIRE S	CHEDULE						
CALLOUT	SYMBOL	LAMP	DESCRIPTION	BALLAST	MOUNTING	MODEL	INPUT WATTS	VOLTS
		LED	2' X 4' LED TROFFER WITH EMERGENCY BATTERY PACK	ELECTRONIC	RECESSED	METALUX 24GR-LD5-64-F1-UNV-	48 EL14W-L840	120V 1P 2W -CD1-U
		(336) 4000K CCT, 80 CRI LEDS	METALUX GR 2X4 LED TROFFER WITH F1 LENS	ELECTRONIC	RECESSED	COOPER LIGHTING SOLUTIONS — METALUX (FORMERLY EATON), 24GR-LD5-90-F1-UNV-	69 L930-CD1-U	120V 1P 2W
;		(1) LED	2' X 2' LED TROFFER	ELECTRONIC	RECESSED	METALUX 22GR-LD5-28-F1-UNV- OR EQUAL	22.9 L840-CD1-U	120V 1P 2W
)	0	(1) 45.2W 4000K LED	4' LED STRIP	ELECTRONIC	SURFACE	MAXLITE LSV4U4540	45.2	120V 1P 2W
MER	Ľ	(2) LED	SQUARE HEAD LED EMERGENCY LIGHT	ELECTRONIC	WALL/CEILING	METALUX AP2SQLED OR EQUAL	1.8	120V 1P 2W
MER/EXIT	\otimes	(2) LED	LED COMBINATION EXIT/EMERGENCY LIGHT	ELECTRONIC	WALL/CEILING	METALUX APCH7RSQ OR EQUAL	3.4	120V 1P 2W
		(1) LED	2' X 4' LED TROFFER	ELECTRONIC	RECESSED	METALUX 24GR-LD5-48-F1-UNV- OR EQUAL	37.4 L840-CD1-U	120V 1P 2W
P-A	Ю	(1) (1) 2700K CCT, 90 CRI LED	LUMIERE LANTERRA 9004 LED WALL LUMINAIRE, RECESSED LENS, FLOOD OPTIC, BLACK HOUSING.	ELECTRONIC	CEILING	COOPER LIGHTING SOLUTIONS — LUMIERE (FORMERLY EATON), 9004—W2—[RW, RI]—LED2790—F—BK—L2—	40.2 UNV	120V 1P 2W
/P-B	Н	(1) LED	LED WALL PACK WITH FULL CUTOFF LENS	ELECTRONIC	WALL	METALUX/COOPER AXCL12A-PC-VS/AXCL OR EQUAL	123	120V 1P 2W

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COASTA FIRM # C-2059 295 Locklear Rd P.O. Box 1117 Pembroke, NC 28 Voice: 910-521-7	
Coastal Prim # c-2059 FIRM # c-2059 295 Locklear Rd P.0. Box 1117 Pembroke, NC 28372 Voice: 910-521-7213 www.coastalplainseng.cc	
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