REVELS TURF & TRACTOR RAWLS CHURCH ROAD FUQUAY-VARINA, NORTH CAROLINA

SCOPE	OF	WO	RK .

NEW PRE-ENGINEERED METAL BUILDING (29,920 SF) FOR OFFICES, STORAGE, AND SHOP AREA FOR NON-COMMERCIAL VEHICLES.


		EAST WEST	30'+ 30'+ 30'+
	NSURANCE 2018 APPENDIX B	SOUTH INTERIOR NONBEARING WALLS	
BUILDING CODE SUMMA	ARY FOR ALL COMMERCIAL PROJECTS INGS AND TOWNHOUSES) AON THE BUILDING PLANS SHEET 1 OR 2)	AND PARTITIONS EXTERIOR NORTH	
(REPRODUCE THE FOLLOWING DAT	REVELS TURF & TRACTOR	EAST WEST	
Address: Zip Code:	RAWLS CHURCH ROAD, FUQUAY-VARINA, NC 27526	SOUTH INTERIOR WALL & PARTITION	 S
Owner Or Authorized Agent: Owned By:	W. S. Architects, PA Phone: (919) 779-9797 E-mail ginger@wsarchitectspa.com [] City/County [X] Private [] State	FLOOR CONSTRUCTION INCLUDING SUPPORTING BEAMS AND JOISTS	
Code Enforcement Jurisdiction:	[X] Town: Fuquay-Varina [] County [] State	FLOOR CEILING ASSEMBLY COLUMNS SUPPORTING FLO	ORS
Designer FIRM	SIONAL: W. S. ARCHITECTS, PA NAME LIC. # TELEPHONE E-MAIL	ROOF CONSTRUCTION INCLUDING SUPPORTING BEAMS AND JOISTS	
Architectural: W. S. Arch Civil Stewart-Pr Electrical: Burke Des	roctor	ROOF CEILING ASSEMBLY COLUMNS SUPPORTING ROC)F
Fire Alarm: Plumbing: Burke Des	ign Group Benjamin F Burke 22038 (919) 771-1916 ben@bdg-nc.com	SHAFTS ENCLOSURES-EXIT SHAFTS ENCLOSURES-LID CORRIDOR SEPARATION	
Mechanical: Burke Des Sprinkler-Standpipe: Structural: Ross Linde		OCCUPANCY/FIRE AREA SEPARA	TION
Retaining Walls >5' High:		PARTY/FIRE WALL SEPARATION SMOKE BARRIER SEPARATION	
Other:		SMOKE PARTITION TENANT/DWELL. UNIT/SLEEP. UNI INCIDENTAL USE SEPARATION	T SEP.
2018 NC BUILDING COD	E: [X] New Building [] Shell/Core [] 1st Time Interior Completions [] Addition [] Phased Construction - Shell Core	*INDICATE SECTION NO. PERMITTIN	IG REDUCTION
2018 NC EXISTING BUILDING	i CODE: [] Prescriptive [] Alteration Level I [] Historic Property [] Repair [] Alteration Level II [] Change of Use [] Chapter 14 [] Alteration Level III	** PER FOOTNOTE 'F' ON TABLE 102 PERCENTAGE OF WALL OF	
		FIRE SEPARATIO	N DEGREE
,	date) PROPOSED OCCUPANCY(S) (Ch. 3): B & S-1 FEGORY (Table 1604.5): Current: Proposed: II	DISTANCE (FEET FROM PROPERTY LINES	
BASIC BUILDING DATA CONSTRUCTION TYPE:	[]I-A []II-A []III-A []IV []V-A	N 30'+ E 30'+	UP, NS UP, NS
SPRINKLERS:	[]I-B [X]II-B []III-B []V-B [X]NO [] PARTIAL []NFPA 13 []NFPA 13R []NFPA 13D	S 30'+ W 30'+	UP, NS UP, NS
STANDPIPES: PRIMARY FIRE DISTRICT:	[X]NO CLASS []I []II []III []WET []DRY [X]NO []YES FLOOD HAZARD AREA : [X]NO []YES	LIFE SAFETY SYSTEM REQUI	REMENTS
SPECIAL INSPECTIONS REQUIRED:	[]NO [X]YES	EMERGENCY LIGHTING: [> EXIT SIGNS: [>	(]YES []NO (]YES []NO]YES [X]NO
GROSS BUILDING AREA 3RD FLOOR	EXISTING (SF) NEW (SF) SUB-TOTAL TENANT	LIFE SAFETY PLAN REQUIRE	
2ND FLOOR MEZZANINE	 	[X] FIRE AND/OR SMOKE RATED	
1ST FLOOR BASEMENT TOTAL	29,920 29,920	[] ASSUMED AND REAL PROPER [] EXTERIOR WALL OPENING AF	RTY LINE LOCAT REA WITH RESPE
		[X] OCCUPANCY USE FOR EACH [X] OCCUPANT LOADS FOR EACH [X] EXIT ACCESS TRAVEL DISTA	CH AREA
ALLOWABLE AREA: PRIMARY OCCUPANCY:		[] COMMON PATH OF TRAVEL D [] DEAD END LENGTHS (1020.4)	ISTANCES (1006
	1 []A-2 []A-3 []A-4 []A-5	[X] CLEAR EXIT WIDTHS FOR EA [X] MAXIMUM CALCULATED OC(EGRESS WIDTH (1005.3)	ACH EXIT DOOR CUPANT LOAD C
[] ĚDUCATIONAL [] FACTORY [] HIGH-HAZARD	[]F-1 Moderate []F-2 Low []H-1 Detonate []H-2 Deflagrate []H-3 Combust []H-4 Health []H-5 HPM	[X] ACTUAL OCCUPÀNT LOAD F [] A SEPARATE SCHEMATIC PLA	N INDICATING V
[] INSTITUTIONAL	[] I-1 [] I-2 [] I-3 [] I-4 [-] I-1 [] I-2 [] I-3 [] I-4 I-1 Condition [] 1 [] 2	STRUCTURE IS PROVIDED F [] LOCATION OF DOORS WITH P [] LOCATION OF DOORS WITH D	ANIC HARDWAR
	I-2 Condition [] 1 [] 2 I-3 Condition [] 1 []2 [] 3 [] 4 [] 5	[] LOCATION OF DOORS WITH E [] LOCATION OF DOORS EQUIPF	LECTROMAGNE
[] MERCANTILE [] RESIDENTIAL [X] STORAGE	[]R-1 []R-2 []R-3 []R-4 [X]S-1 Moderate []S-2 Low []HIGH-PILED	[] LOCATION OF EMERGENCY E [X] THE SQUARE FOOTAGE OF [] THE SQUARE FOOTAGE OF E	EACH FIRE ARE
[]UTILITY & MISCELLANEOU] PARKING GARAGE [] OPEN [] ENCLOSED [] REPAIR GARAGE	[] NOTE ANY CODE EXCEPTION THE ITEMS ABOVE	
INCIDENTAL USES (Table 50	CLASSIFICATION(S):		
This separation is not SPECIAL USES (Chapter 4 - L	exempt as a Non-Separated Use (see exceptions). List Code Sections):		(
SPECIAL PROVISIONS (Char MIXED OCCUPANCY:	Separation: NON SEPARATED MIXED USE Exception:	TOTAL UNITS UN	SSIBLE TYPE IITS UNI DV'D REC
	f Occupancy A+Actual Area of Occupancy Ba of Occupancy AAllowable Area of Occupancy B≤1		
	+ + = ≤ 1.00	ACCESSIBLE PARKING (SEC	CTION 1106) S
STORY DESCR	(A) (B) (C) (D) R'N BLDG AREA TABLE 506.2₄ AREA FOR ALLOWABLE	TOTAL # OF	SPACES
NO. AND US		LOT OR PARKING AREA REQ'D P EXISTING	ROVID'D
1 BUSINES	SS12,20823,00017,25040,250 per flr.(S1)17,71117,50013,12530,625 per flr.	PROPOSED	
ESTRICTIVE			
 A. Perimeter Which Front B. Total Building Perimeter 	om Section 506.2 Are Competed Thus: ts A Public Way Or Open Space Having 20 Ft Min. Width =' (F). er =' (P).	PLUMBING FIXTURE REQUIF 104 MALES / 104 FEMALES	REMENT (T
C. Ratio (F/P) = (20/30) = D. W= Minimum Width Of	=. f Public Way $=$ (W)	USE WATERCLOSET	rs urinals
 Unlimited area applicable un Max. Building Area = Total N The Maximum Area Of Oper 	No. Of Stories In The Building X D (maximum 3 stories) (506.2). n Parking Garages Must Comply With 406.5.4. The Maximum Area Of Air Traffic	MALE FEMALE UN	NISEX
Control Towers Must Comply	y With 412.3.1. on the unsprinklered area value in Table 506.2.	NEW 4 4	
ALLOWABLE HEIGHT	ALLOWABLE SHOWN CODE (TABLES 504.3 & 504.4) ON PLANS REFERENCE	SPECIAL APPROVALS	
BUILDING HEIGHT IN FEET	55 (FT) 20 (FT) MEAN ROOF	Special Approval: (Local Jurisdic	tion, Dept of Insur
BUILDING HEIGHT IN STORIE		na	
1. Provide code reference if the	e "Shown on Plans" quantity is not based on Table 504.3 or 504.4.		


ſ	NC DEPT. OF INSU	RAN	CE					
	2018 APPENDIX В в	UILDIN	G CODE	SUMMARY			CONT	INUED
ſ	FIRE PROTECTION REQUIREME	ENTS						
	BUILDING ELEMENT	FIRE SEP'N DIST. (FT)	RATING REQ'D	RATING PROV'D (W/* REDUCTION)	DETAIL # AND SHEET #	FOR	DES. # FOR RATED PENET'N	DES. # FOR RATED JOINTS
	STRUCTURAL FRAME, INCLUDING COLUMNS GIRDERS, TRUSSES BEARING WALLS		0					
	EXTERIOR NORTH EAST	30'+ 30'+	0					
	WEST SOUTH INTERIOR NONBEARING WALLS	30'+ 30'+ 	0 0 					
	AND PARTITIONS EXTERIOR NORTH							
	EAST WEST SOUTH	 			 			
	INTERIOR WALL & PARTITIONS FLOOR CONSTRUCTION INCLUDING SUPPORTING		0					
	BEAMS AND JOISTS FLOOR CEILING ASSEMBLY COLUMNS SUPPORTING FLOOR ROOF CONSTRUCTION	S	 					
	INCLUDING SUPPORTING BEAMS AND JOISTS ROOF CEILING ASSEMBLY COLUMNS SUPPORTING ROOF							
	SHAFTS ENCLOSURES-EXIT SHAFTS ENCLOSURES-LID CORRIDOR SEPARATION		 0**		 			
	OCCUPANCY/FIRE AREA SEPARATIC PARTY/FIRE WALL SEPARATION	N	2 3 	2 3 		U419 U904/U419 		
	SMOKE BARRIER SEPARATION SMOKE PARTITION							

CALCULATI	ONS		
EGREE OF DPENINGS ROTECTION ABLE 705.8)	ALLOWABLE AREA (%)	ACTUAL SHOWN ON PLANS (%)	
UP, NS UP, NS UP, NS UP, NS	NO LIMIT NO LIMIT NO LIMIT NO LIMIT	 	

REMI	ENTS							
] YES] YES YES	6 [] NO 6 [] NO [X] NO		KE DETEC C HARDW/		TEMS:	[] Y [] Y	YES [X] YES [X]	NO NO
/IEN	ſS			SI	HEET NU	MBE	R A0.3	
ty lin Ea Wi Are/ Are Nces	NE LOCAT TH RESP A AS IT RE EA (1017)	TONS (II ECT TO ELATES	APTER 7) F NOT ON DISTANCE TO OCCU 006.3.2(1)	E TO ASS PANT LO	UMED PF	rope Ulat	ERTY LINE FION (TAB	S (705.8) LE 1004.1.2
	(IT DOOR IT LOAD (Y EACH E		R CAN AC		MMODATE	BASED ON
N IND R PU NIC I ELAYE ED W CAPE ACH CH S	RPOSES HARDWAF ED EGRES ROMAGNE ITH HOLD E WINDOV FIRE ARE MOKE CC	WHERE OF OCC RE (1010 SS LOCH TIC EG -OPEN VS (1030 A (202) MPART	(S AŃD TH RESS LOC DEVICES 0)	SEPARAT IE AMOUR CKS (1010	ION NT OF TH .1.9.9) ANCY CL	IE DE ASSI	ELAY (1010).1.9.7) I-2 (407.5)
s	(SECTIC	N 1107)						
SIBLE TS V'D		E A TS Q'D	UNITS	TYPE I UNITS REQ'D		UNI		TOTAL ACCESSIB UNITS PRO
TION	1106)	see site	plan by Ste	ewart-Proc	tor			
SPAC ROVIE 	ES	<u># OF</u> REG.	ACCESSII WITH 5' SS AISLE 	BLE SPAC VAI	CES PROV N SPACE	S WI 3' AC	TH	TOTAL # ACCESSIBL PROVIDED
EME	N T (1	ABLE 4	03.1)					
S ISEX	URINALS	MALE	_AVATORI FEMALE	ES UNISEX	SERVIC SINK		DRINKIN REGULAF	G FOUNTAI
 		 4 3	 4 3		 1 1		 1 1	 1 1

ance, OSC, DPI, DHHS, etc., describe below
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W. S. ARCHITECTS, PA 3305-109 Durham Drive Raleigh, North Carolina 27603 919.779.9797 www.wsarchitectspa.com

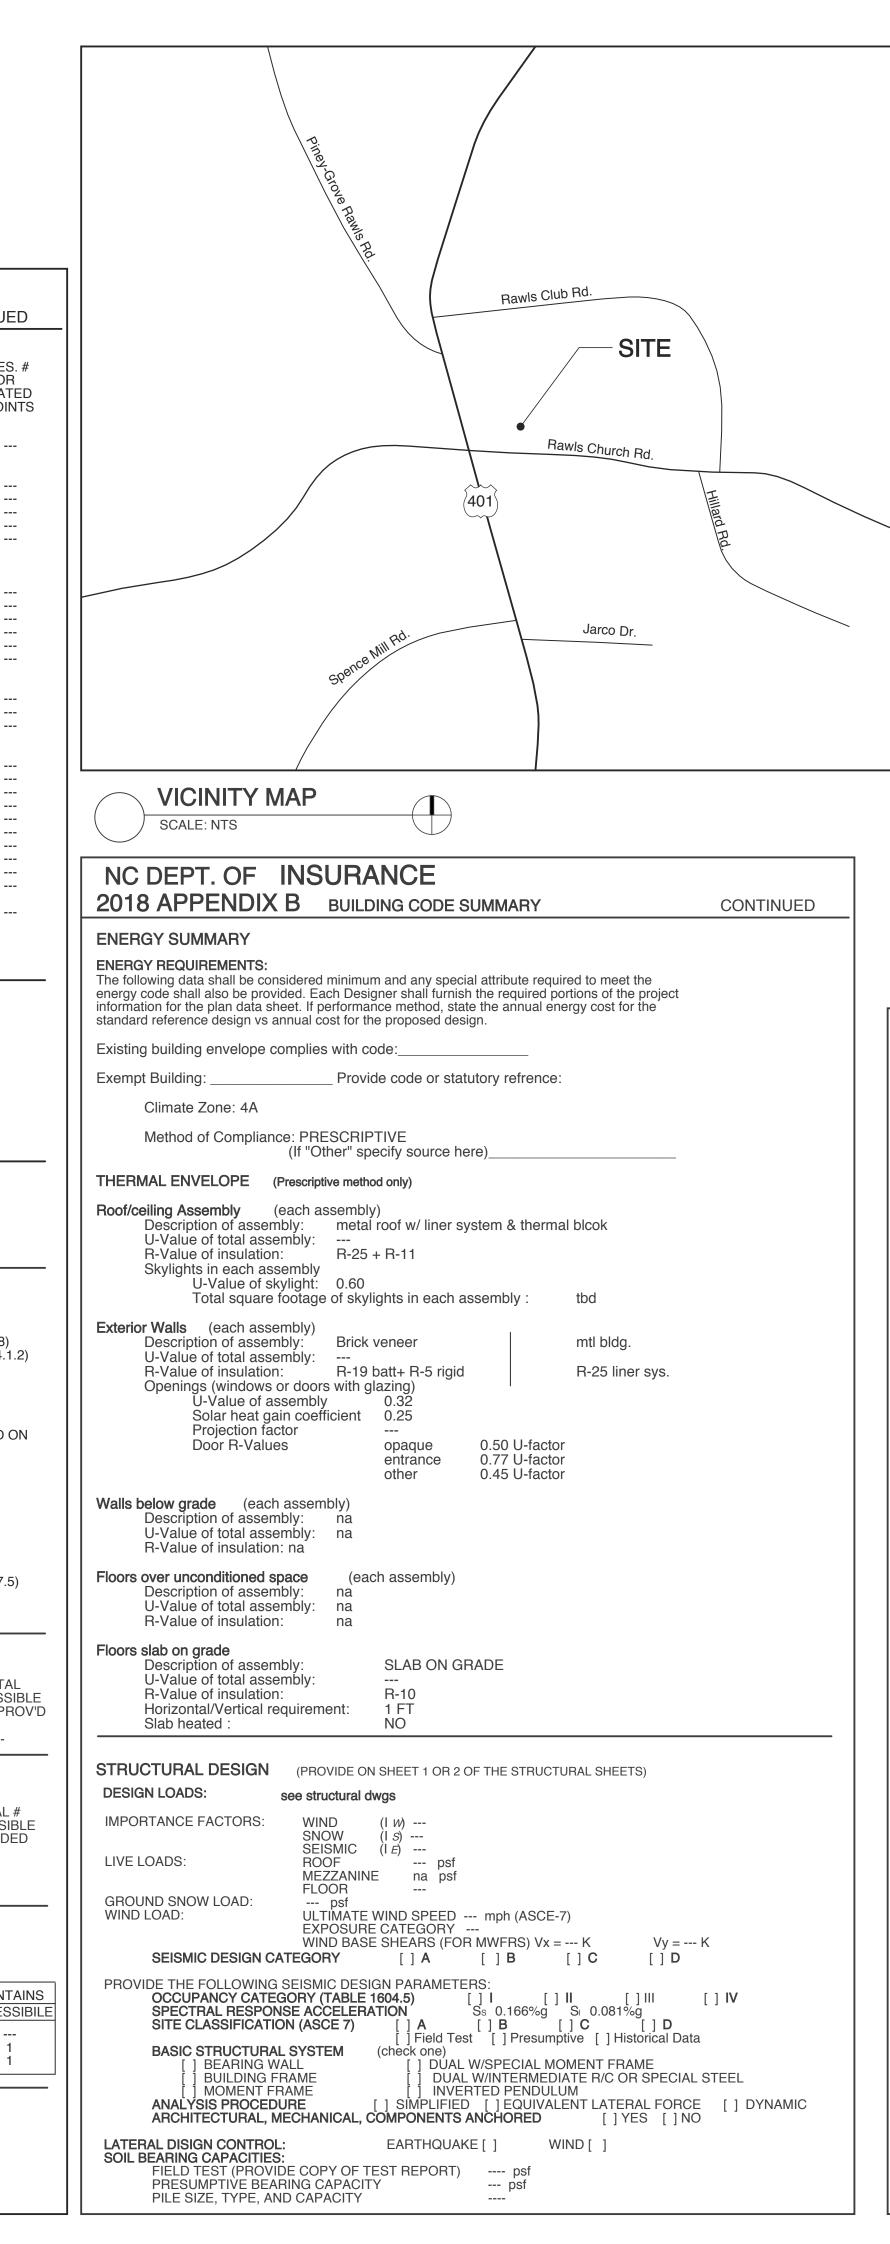

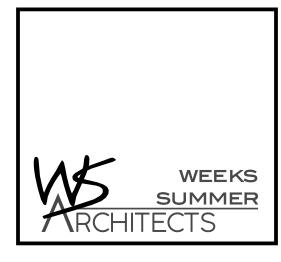

GENERAL NOTES

I: FOR THIS PROJECT:

A) A PROJECT EXPEDITOR WILL BE DESIGNATED BY THE OWNER TO PROVIDE GENERAL ADMINISTRATION OF THESE DOCUMENTS FOR THE OWNER. THE OWNER SHALL BE THE PROJECT EXPEDITOR UNLESS OTHERWISE STIPULATED BY WRITTEN AGREEMENT WITH ANOTHER PARTY. B) THESE DOCUMENTS ARE SCHEMATIC IN NATURE AND ARE INTENDED TO CONVEY THE DESIGN DIMENSIONS, EXISTING CONDITIONS, ETC. FOR THE PROPER IMPLEMENTATION OF THESE

Reviewed for Fire Code Compliance

Leslie Jackson

11/20/2023 5:37:18 PM

DRAWINGS. DO NOT SCALE THE DRAWINGS. C) THE ARCHITECTS SCOPE OF WORK DOES NOT INCLUDE CONSTRUCTION OBSERVATION UNLESS OTHERWISE DESIGNATED IN WRITING BY THE OWNER. THE CONTRACTOR IS IN CHARGE OF THE WORK AND COMPLIANCE WITH THESE DOCUMENTS IS THE SOLE RESPONSIBILITY OF THE CONTRACTOR. THE ARCHITECT WILL BEAR NO

RESPONSIBILITY FOR FAILURE OF THE CONTRACTOR TO FULLY COMPLY WITH ALL INCLUSIVE DOCUMENTS. USE OF THESE DOCUMENTS WILL CONSTITUTE AGREEMENT BY THE CONTRACTOR TO THESE CONDITIONS

D) "THE GENERAL CONDITIONS OF THE CONTRACT FOR THE CONSTRUCTION OF THE BUILDINGS" OF THE AMERICAN INSTITUTE OF ARCHITECTS DOCUMENT A-201, LATEST EDITION, ARE HEREBY MADE PART OF THE DOCUMENTS, IN THE EVENT OF A CONFLICT, THESE GENERAL NOTES AND CONTRACT SUPERSEDE "AIA DOCUMENT A-201".

II: ALL WORK UNDER THIS CONTRACT SHALL:

A) CONFORM TO STATE, LOCAL AND NATIONAL CODES AND ORDINANCES AS ARE APPLICABLE TO THE WORK INCLUDING BUT NOT LIMITED TO THE NORTH CAROLINA STATE BUILDING CODE, THE AMERICANS WITH DISABILITIES ACT (ADA), NATIONAL ELECTRIC CODES, ASTM SPECIFICATIONS, AND OSHA SAFETY REGULATIONS.

B) COMPLY WITH ALL LAWS, ORDINANCES, CODES, RULES AND REGULATIONS PERTAINING TO ENVIRONMENTAL PROTECTION (EPA). THE COST OF ALL REQUIRED INSPECTIONS AND PERMITS SHALL BE THE RESPONSIBILITY OF THE CONTRACTOR.

III: UNLESS OTHERWISE DIRECTED BY THE ARCHITECT, THE CONTRACTOR SHALL: A) SUPPLY AND PAY FOR ALL LABOR, TRANSPORTATION, MATERIALS, TOOLS, APPARATUS, LIGHTS, POWER, HEAT, SANITARY FACILITIES, WATER, SCAFFOLDING, AND INCIDENTALS NECESSARY FOR THE COMPLETION OF HIS WORK.

B) INSTALL, MAINTAIN AND REMOVE ALL EQUIPMENT, OTHER UTENSILS OR THINGS USED FOR THE CONSTRUCTION PRIOR TO TURNING OVER THE PROJECT.. IF SUCH ITEMS ARE LEFT AFTER COMPLETION OF THE PROJECT, THEY SHALL BECOME PROPERTY OF THE OWNER. THE OWNER MAY PROMPTLY DISPOSE OF SUCH ITEMS, AND WILL NOT BE SUBJECT TO CLAIMS OF THE CONTRACTOR RESULTING FROM SUCH DISPOSITION.

C) CONSTRUCT IN THE BEST AND PROFESSIONAL MANNER, A COMPLETE JOB AND EVERYTHING INCIDENTAL THERETO, AS SHOWN OR REASONABLY IMPLIED FROM THE PLANS, ALL WORK SHALL BE COMPLETED IN ACCORDANCE WITH THE DOCUMENTS.

D) VERIFY ALL DIMENSIONS AND CONDITIONS PRIOR TO PROCEEDING WITH THE WORK AND NOTIFY THE ARCHITECT IN WRITING OF ANY DISCREPANCIES DISCOVERED OR LACK OF REQUIRED INFORMATION TO REQUEST CLARIFICATION. IF THE CONTRACTOR OBSERVES THE DOCUMENTS TO BE CONTRARY TO GOVERNING LAWS, ORDINANCES, CODES, RULES AND REGULATIONS OR OTHERWISE QUESTIONABLE CONDITIONS, HE SHALL PROMPTLY NOTIFY THE ARCHITECT IN WRITING FOR INSTRUCTIONS PRIOR TO PROCEEDING WITH THE WORK.

E) KEEP THE BUILDING AND SURROUNDING AREA REASONABLY FREE FROM RUBBISH AT ALL TIMES. AT A MINIMUM, DEBRIS SHALL BE REMOVED FROM THE SITE ON A WEEKLY BASIS OR AS DIRECTED BY PROJECT EXPEDITOR.

F) LOCATE ALL EXISTING UTILITIES. THE CONTRACTOR MAY NOT INTERFERE WITH ADJACENT UTILITIES UNLESS PRIOR NOTICE AND PERMISSION IS RECEIVED FROM THOSE WHO MAY AS A RESULT OF THIS INTERFERENCE BE AFFECTED.

G) PRIOR TO ANY WORK, CALL "NC ONE CALL CENTER" @ 800-632-4949 AND OTHER LOCATING SERVICES AS TO CONFIRM LOCATION OF UTILITIES.

H) PRIOR TO FINAL INSPECTION AND ACCEPTANCE OF THE BUILDING, EACH CONTRACTOR SHALL CLEAN HIS PORTION OF THE WORK, INCLUDING GLASS, HARDWARE FIXTURES, MASONRY, TILE AND MARBLE (USING NO ACID), CLEAN AND WAX ALL FLOORS AS SPECIFIED, AND COMPLETELY PREPARE THE BUILDING FOR USE BY THE OWNER.

I) FILE WITH THE OWNER CURRENT INSURANCE CERTIFICATIONS IN THE AMOUNTS REQUESTED BY THE OWNER FOR BUILDER'S RISK, WORKMEN'S COMPENSATION, COMPREHENSIVE GENERAL LIABILITY, BODILY INJURY AND PROPERTY DAMAGE. THIS INSURANCE SHALL INDEMNIFY THE OWNER AND THE ARCHITECT OF ANY AND ALL COSTS, CLAIMS, SUITS AND JUDGEMENTS FOR PROPERTY DAMAGE AND PERSONAL INJURY (INCLUDING GENERAL) ARISING OUT OF THE CONTRACTOR'S ACTIONS.


J) PROVIDE ALL NECESSARY SAFETY MEASURES FOR THE PROTECTION OF ALL PERSONS OF THE WORK, INCLUDING THE REQUIREMENTS OF THE A.G.C. ACCIDENT PREVENTION MANUAL IN CONSTRUCTION AS AMENDED, AND SHALL FULLY COMPLY WITH ALL STATE LAWS OR REGULATIONS AND NORTH CAROLINA STATE BUILDING CODE REQUIREMENTS TO PREVENT ACCIDENT OR INJURY TO PERSONS ON OR ABOUT THE LOCATION OF THE WORK.

K) CLEARLY MARK OR POST SIGNS WARNING OF HAZARDS EXISTING, AND BARRICADE EXCAVATIONS, ELEVATOR SHAFTS, STAIRWELLS AND SIMILAR HAZARDS. PROTECT AGAINST DAMAGE OR INJURY RESULTING FROM FALLING MATERIALS AND MAINTAIN ALL PROTECTIVE DEVICES AND SIGNS THROUGHOUT THE PROGRESS OF THE WORK

PROJECT TITLE

REVELS TURF & TRACTOR RAWLS CHURCH ROAD FUQUAY-VARINA, NORTH CAROLINA


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10/25/23

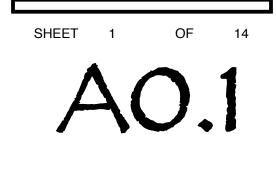
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Certification (such as Canada), respectively.

24 in. OC max.

Design No. U419 Nonbearing Wall Ratings 1, 2, 3 or 4 Hr (See Items 3 & 4)

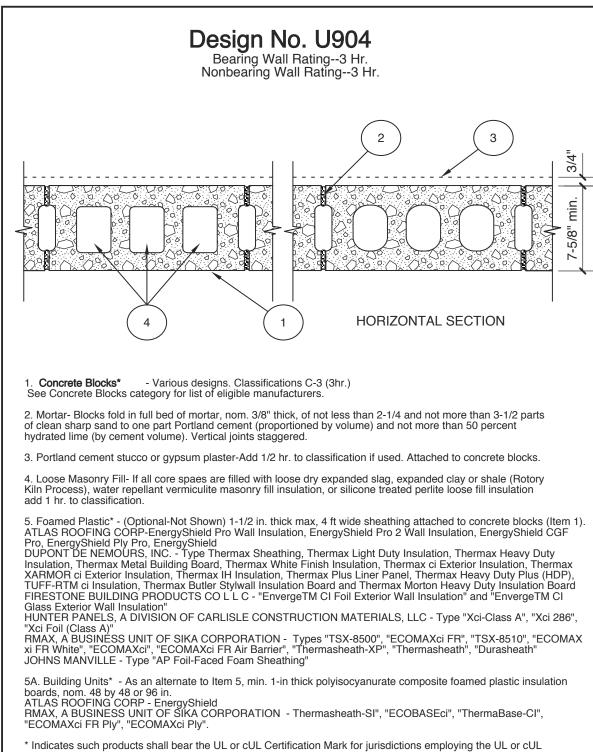

WEEKS SUMMER **T**RCHITECTS

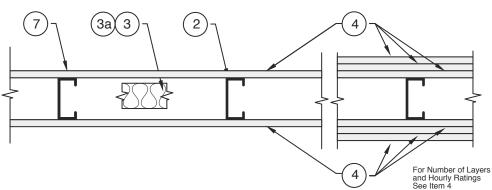W. S. ARCHITECTS, PA

3305-109 Durham Drive

www.wsarchitectspa.com

919.779.9797

Raleigh, North Carolina 27603

1. Floor and Ceiling Runners – (Not shown) – Channel shaped, fabricated from min 25 MSG (min 20 MSG when Item 4A is used) corrosion-protected steel, min width to accommodate stud size, with min 1 in. long legs, attached to floor and ceiling with fasteners

2. Steel Studs — Channel shaped, fabricated from min 25 MSG (min 20 MSG when Item 4A is used) corrosion-protected steel, min width as indicated under Item 4, min 1-1/4 in. flanges and 1/4 in. return, spaced a max of 24 in. OC. Studs to be cut 3/8 to 3/4 in. less than assembly height.

3. Batts and Blankets* – (Required as indicated under Item 4) – Mineral wool batts, friction fitted between studs and runners. Min nom thickness as indicated under Item 4. See Batts and Blankets (BKNV or BZJZ) Categories for names of Classified companies.

3A. Batts and Blankets* – (Optional) – Placed in stud cavities, any glass fiber or mineral wool insulation bearing the UL Classification Marking as to Surface Burning Characteristics and/or Fire Resistance. See Batts and Blankets (BKNV or BZJZ) Categories for names of Classified companies.

4. Gypsum Board* — Gypsum panels with beveled, square or tapered edges, applied vertically or horizontally. Vertical joints centered over studs and staggered one stud cavity on opposite sides of studs. Vertical joints in adjacent layers (multilayer systems) staggered one stud cavity. Horizontal joints need not be backed by steel framing. Horizontal edge joints and horizontal butt joints on opposite sides of studs need not be staggered. Horizontal edge joints and horizontal butt joints in adjacent layers (multilayer systems) staggered a min of 12 in. The thickness and number of layers for the 1 hr, 2 hr, 3 hr and 4 hr ratings are as follows:

Wallboard Protection on Each Side of Wall

Rating	Min Stud Depth	No. of Layers & Thkns of Panel	Min Thkns of Insulation (Item 3)
	3-1/2	1 layer, 5/8 in. thick	Òptional
	2-1/2	1 layer, 1/2 in. thick	1-1/2 in.
	1-5/8	1 layer, 3/4 in. thick	Optional
2	1-5/8	2 layers, 1/2 in. thick	Optional
2	1-5/8	2 layers, 5/8 in. thick	Optional
2	3-1/2	1 layer, 3/4 in. thick	3 in.
3	1-5/8	3 layers, 1/2 in. thick	Optional
3	1-5/8	2 layers, 3/4 in. thick	Optional
3	1-5/8	3 layers, 5/8 in. thick	Optional
1	1-5/8	4 layers, 5/8 in. thick	Optional
1	1-5/8	4 layers, 1/2 in. thick	Optional
Ļ	2-1/2	2 layers, 3/4 in. thick	2 in.

CANADIAN GYPSUM COMPANY — 1/2 in. thick Type C, IP-X2 or IPC-AR; WRC, 5/8 in. thick Type AR, C, IP-AR, IP-X1, IP-X2, IPC-AR, SCX, SHX, WRX or WRC; 3/4 in. thick Type IP-X3, ULTRACODE, ULTRACODE SHC or ULTRACODE WRC.

UNITED STATES GYPSUM CO - 1/2 in. thick Type C, IP-X2, IPC-AR or WRC; 5/8 in. thick Type SCX, SHX, WRX, IP-X1, AR, C, WRC, FRX-G, IP-AR, IP-X2, IPC-AR ; 3/4 in. thick Type IP-X3, ULTRACODE, ULTRACODE SHC or ULTRACODE WRC.

USG MEXICO S A DE C V — 1/2 in. thick Type C, IP-X2, IPC-AR or WRC; 5/8 in. thick Type AR, C, IP-AR, IP-X1, IP-X2, IPC-AR, SCX, SHX, WRX, WRC or; 3/4 in. thick Type IP-X3, ULTRACODE, ULTRACODE SHC or ULTRACODE WRC.

4A. Gypsum Board^{*} – (As an alternate to Item 4) – 5/8 in. thick gypsum panels, installed as described in Item 4 with Type S-12 steel screws. The length and spacing of the screws as specified under Item 5.

CANADIAN GYPSUM COMPANY – Type FRX UNITED STATES GYPSUM CO - Type FRX

4B. Gypsum Board^{*} – (As an alternate to Items 4 and 4A) – 5/8 in. thick, 2 ft. wide, tongue and groove edge, applied horizontally as the outer layer to one side of the assembly. Secured as described in Item 5. Joint covering (Item 7) not required.

CANADIAN GYPSUM COMPANY - Type SHX.

UNITED STATES GYPSUM CO - Type SHX.

USG MEXICO S A DE C V — Type SHX.

5. Fasteners — (Not shown) — Type S or S-12 steel screws used to attach panels to studs (Item 2) or furring channels (Item 6). Single layer systems: 1 in. long for 1/2 and 5/8 in. thick panels or 1-1/4 in. long for 3/4 in. thick panels, spaced 8 in. OC when panels are applied horizontally, or 8 in. OC along vertical and bottom edges and 12 in. OC in the field when panels are applied vertically. Two layer systems: First layer- 1 in. long for 1/2 and 5/8 in. thick panels or 1-1/4 in. long for 3/4 in. thick panels, spaced 16 in. OC. Second layer- 1-5/8 in. long for 1/2 in., 5/8 in. thick panels or 2-1/4 in. long for 3/4 in. thick panels, spaced 16 in. OC with screws offset 8 in. from first layer. Three-layer systems: First layer- 1 in. long for 1/2 in., 5/8 in. thick panels, spaced 24 in. OC. Second layer- 1-5/8 in. long for 1/2 in., 5/8 in. thick panels, spaced 24 in. OC. Third layer- 2-1/4 in. long for 1/2 in., 5/8 in. thick panels or 2-5/8 in. long for 5/8 in. thick panels, spaced 12 in. OC. Screws offset min 6 in. from layer below. Four-layer systems: First layer- 1 in. long for 1/2 in., 5/8 in. thick panels, spaced 24 in. OC. Second layer- 1-5/8 in. long for 1/2 in., 5/8 in. thick panels, spaced 24 in. OC. Third layer- 2-1/4 in. long for 1/2 in. thick panels or 2-5/8 in. long for 5/8 in. thick panels, spaced 24 in. OC. Fourth layer- 2-5/8 in. long for 1/2 in. thick panels or 3 in. long for 5/8 in. thick panels, spaced 12 in. OC. Screws offset min 6 in. from layer below.

6. Furring Channels – (Optional, not shown, for single or double layer systems) – Resilient furring channels fabricated from min 25 MSG corrosion-protected steel, spaced vertically a max of 24 in. OC. Flange portion attached to each intersecting stud with 1/2 in. long Type S-12 steel screws. Not for use with Item 4A.

7. Joint Tape and Compound — Vinyl or casein, dry or premixed joint compound applied in two coats to joints and screw heads of outer layers. Paper tape, nom 2 in. wide, embedded in first layer of compound over all joints of outer layer panels. Paper tape and joint compound may be omitted when gypsum panels are supplied with a square edge.

8. Siding, Brick or Stucco – (Optional, not shown) – Aluminum, vinyl or steel siding, brick veneer or stucco, meeting the requirements of local code agencies, installed over gypsum panels. Brick veneer attached to studs with corrugated metal wall ties attached to each stud with steel screws, not more than each sixth course of brick.

9. Caulking and Sealants* – (Optional, not shown) – A bead of acoustical sealant applied around the partition perimeter for sound control.

UNITED STATES GYPSUM CO — Type AS


*Bearing the UL Classification Mark



PROJECT TITLE

REVELS TURF & TRACTOR RAWLS CHURCH ROAD FUQUAY-VARINA, NORTH CAROLINA


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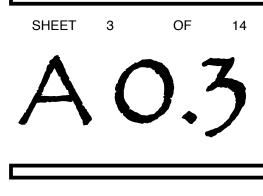

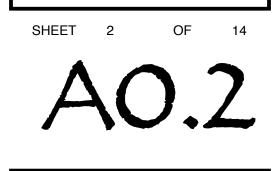
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PROJECT TITLE REVELS TURF & TRACTOR	
RAWLS CHURCH ROAD FUQUAY-VARINA, NORTH CAROLIN	IA


PROJECT NO. 2232b DRAWING TITLE LIFE SAFETY




PLOT DATE REVISION

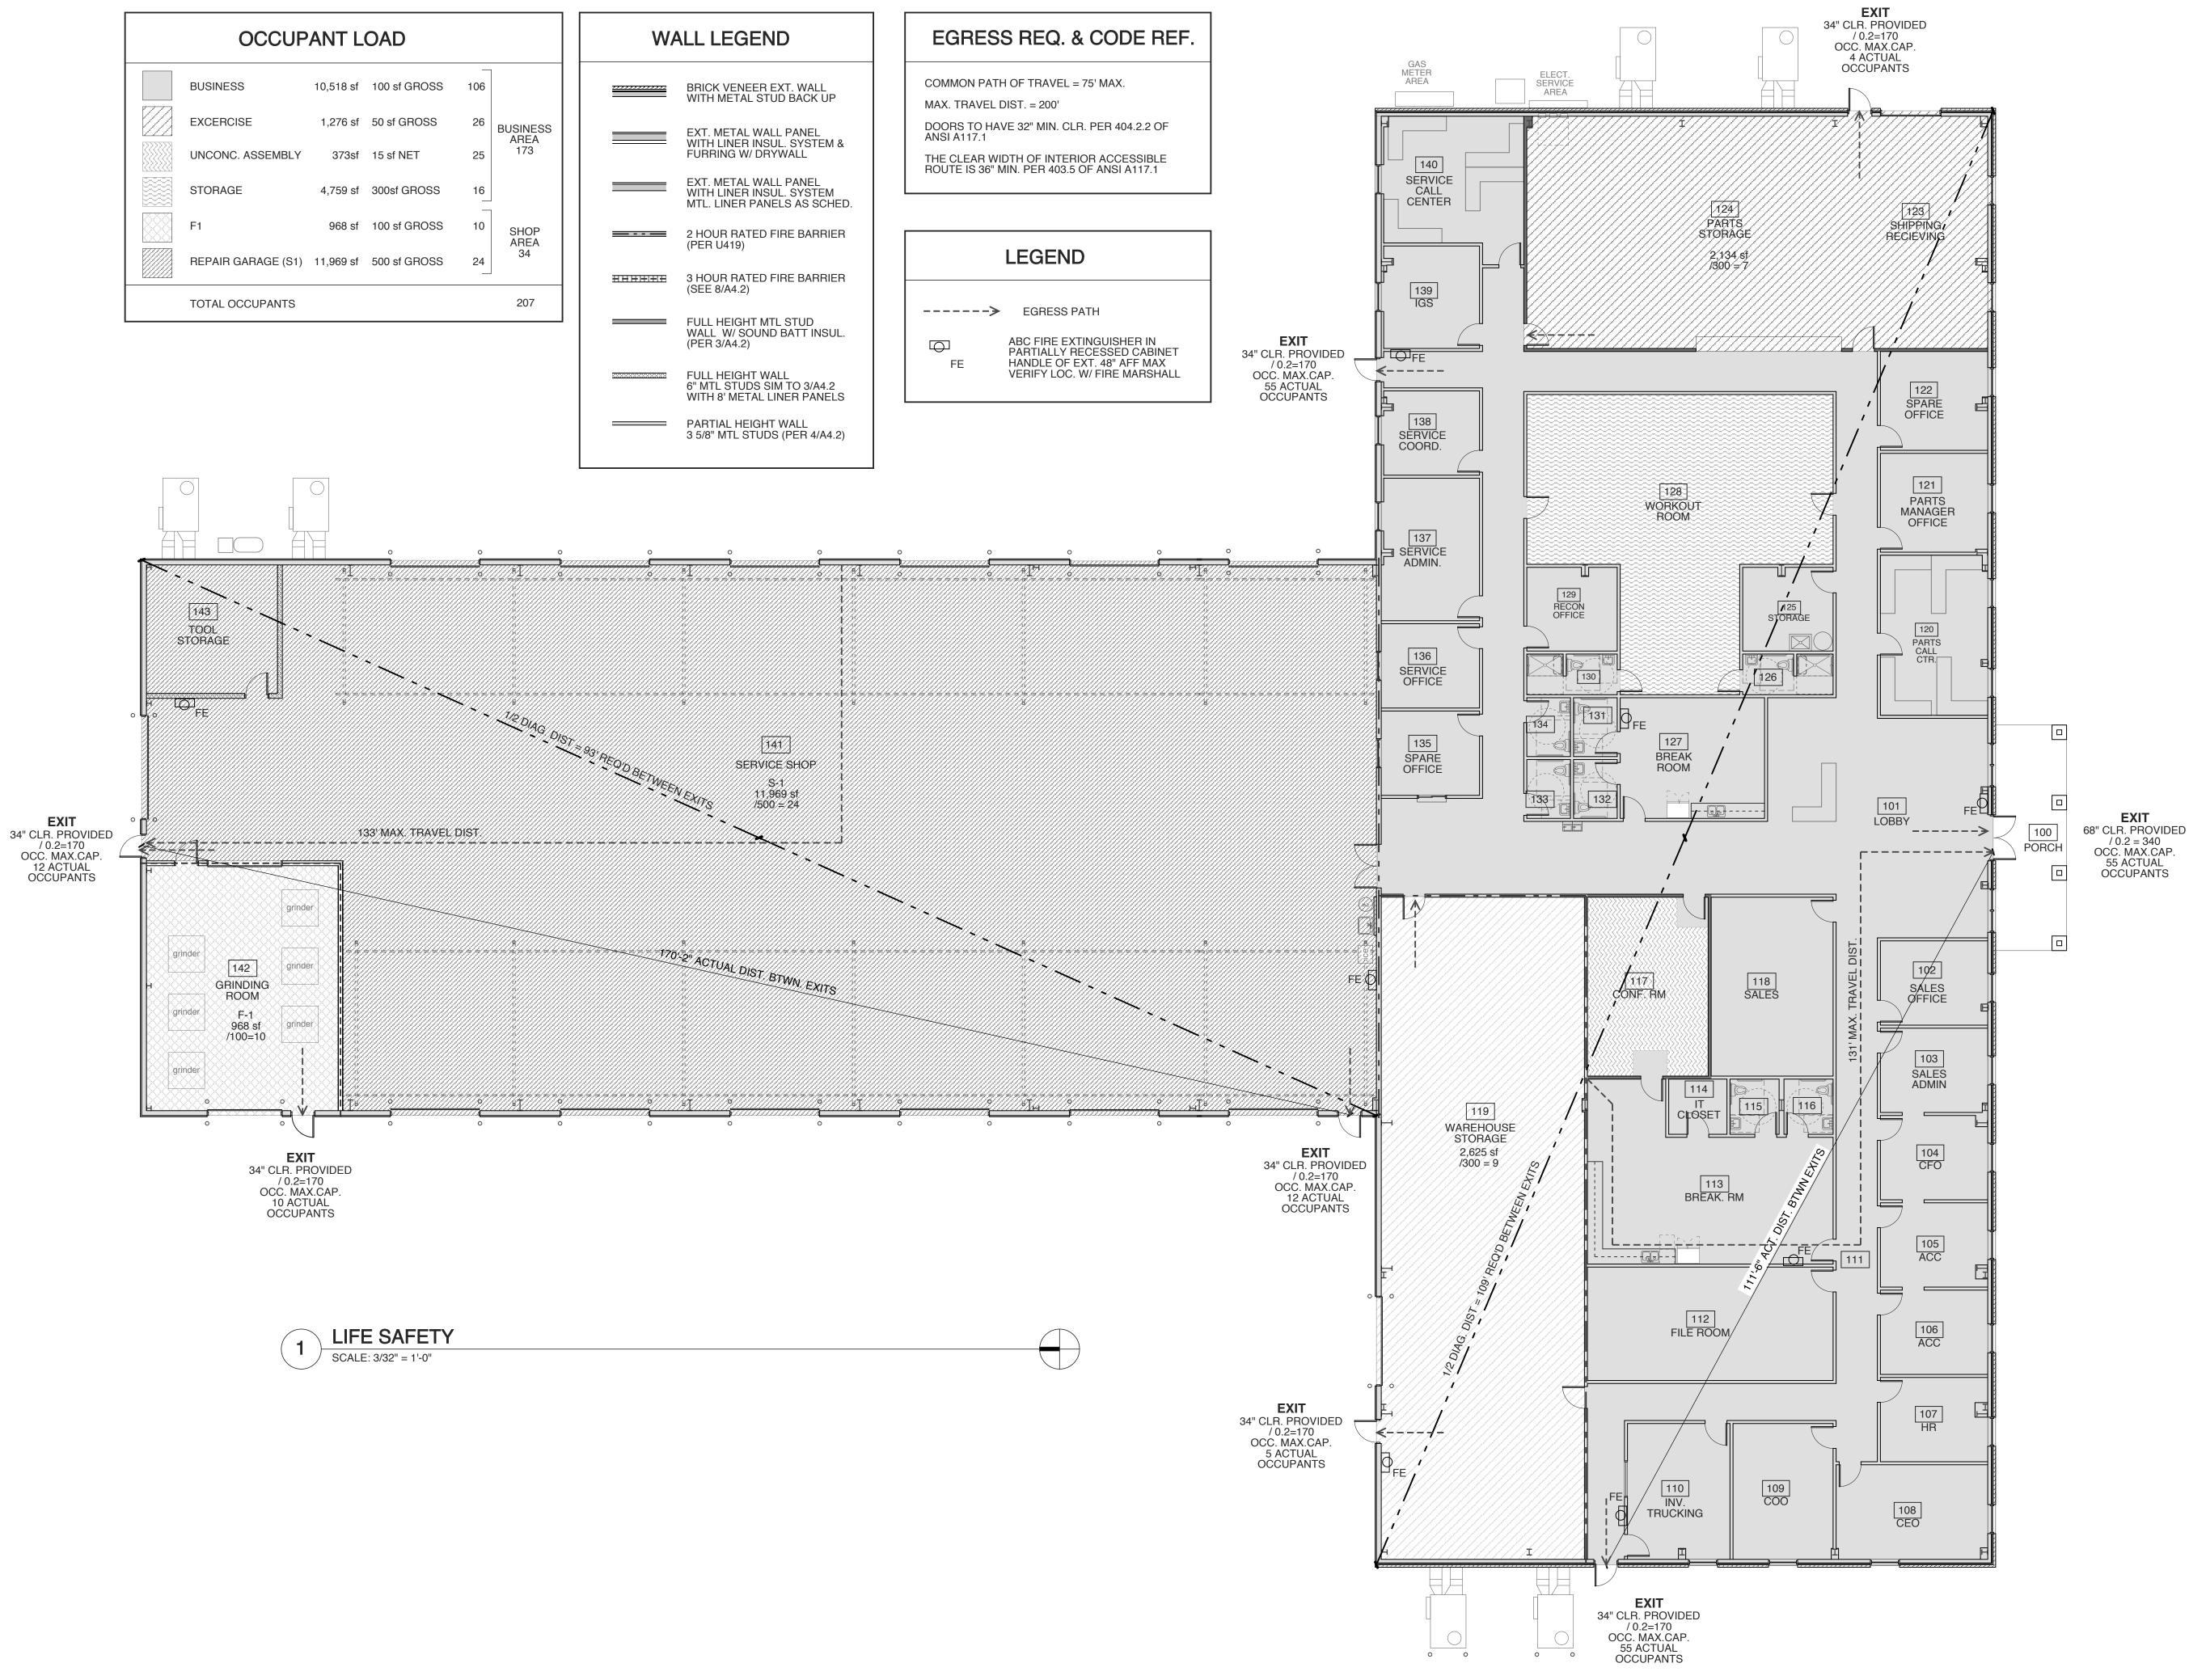10/25/23 ----

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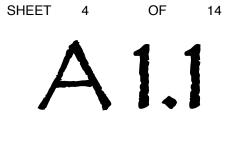
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PROJECT TITLE REVELS TURF & TRACTOR	
RAWLS CHURCH ROAD FUQUAY-VARINA, NORTH CAROLINA	

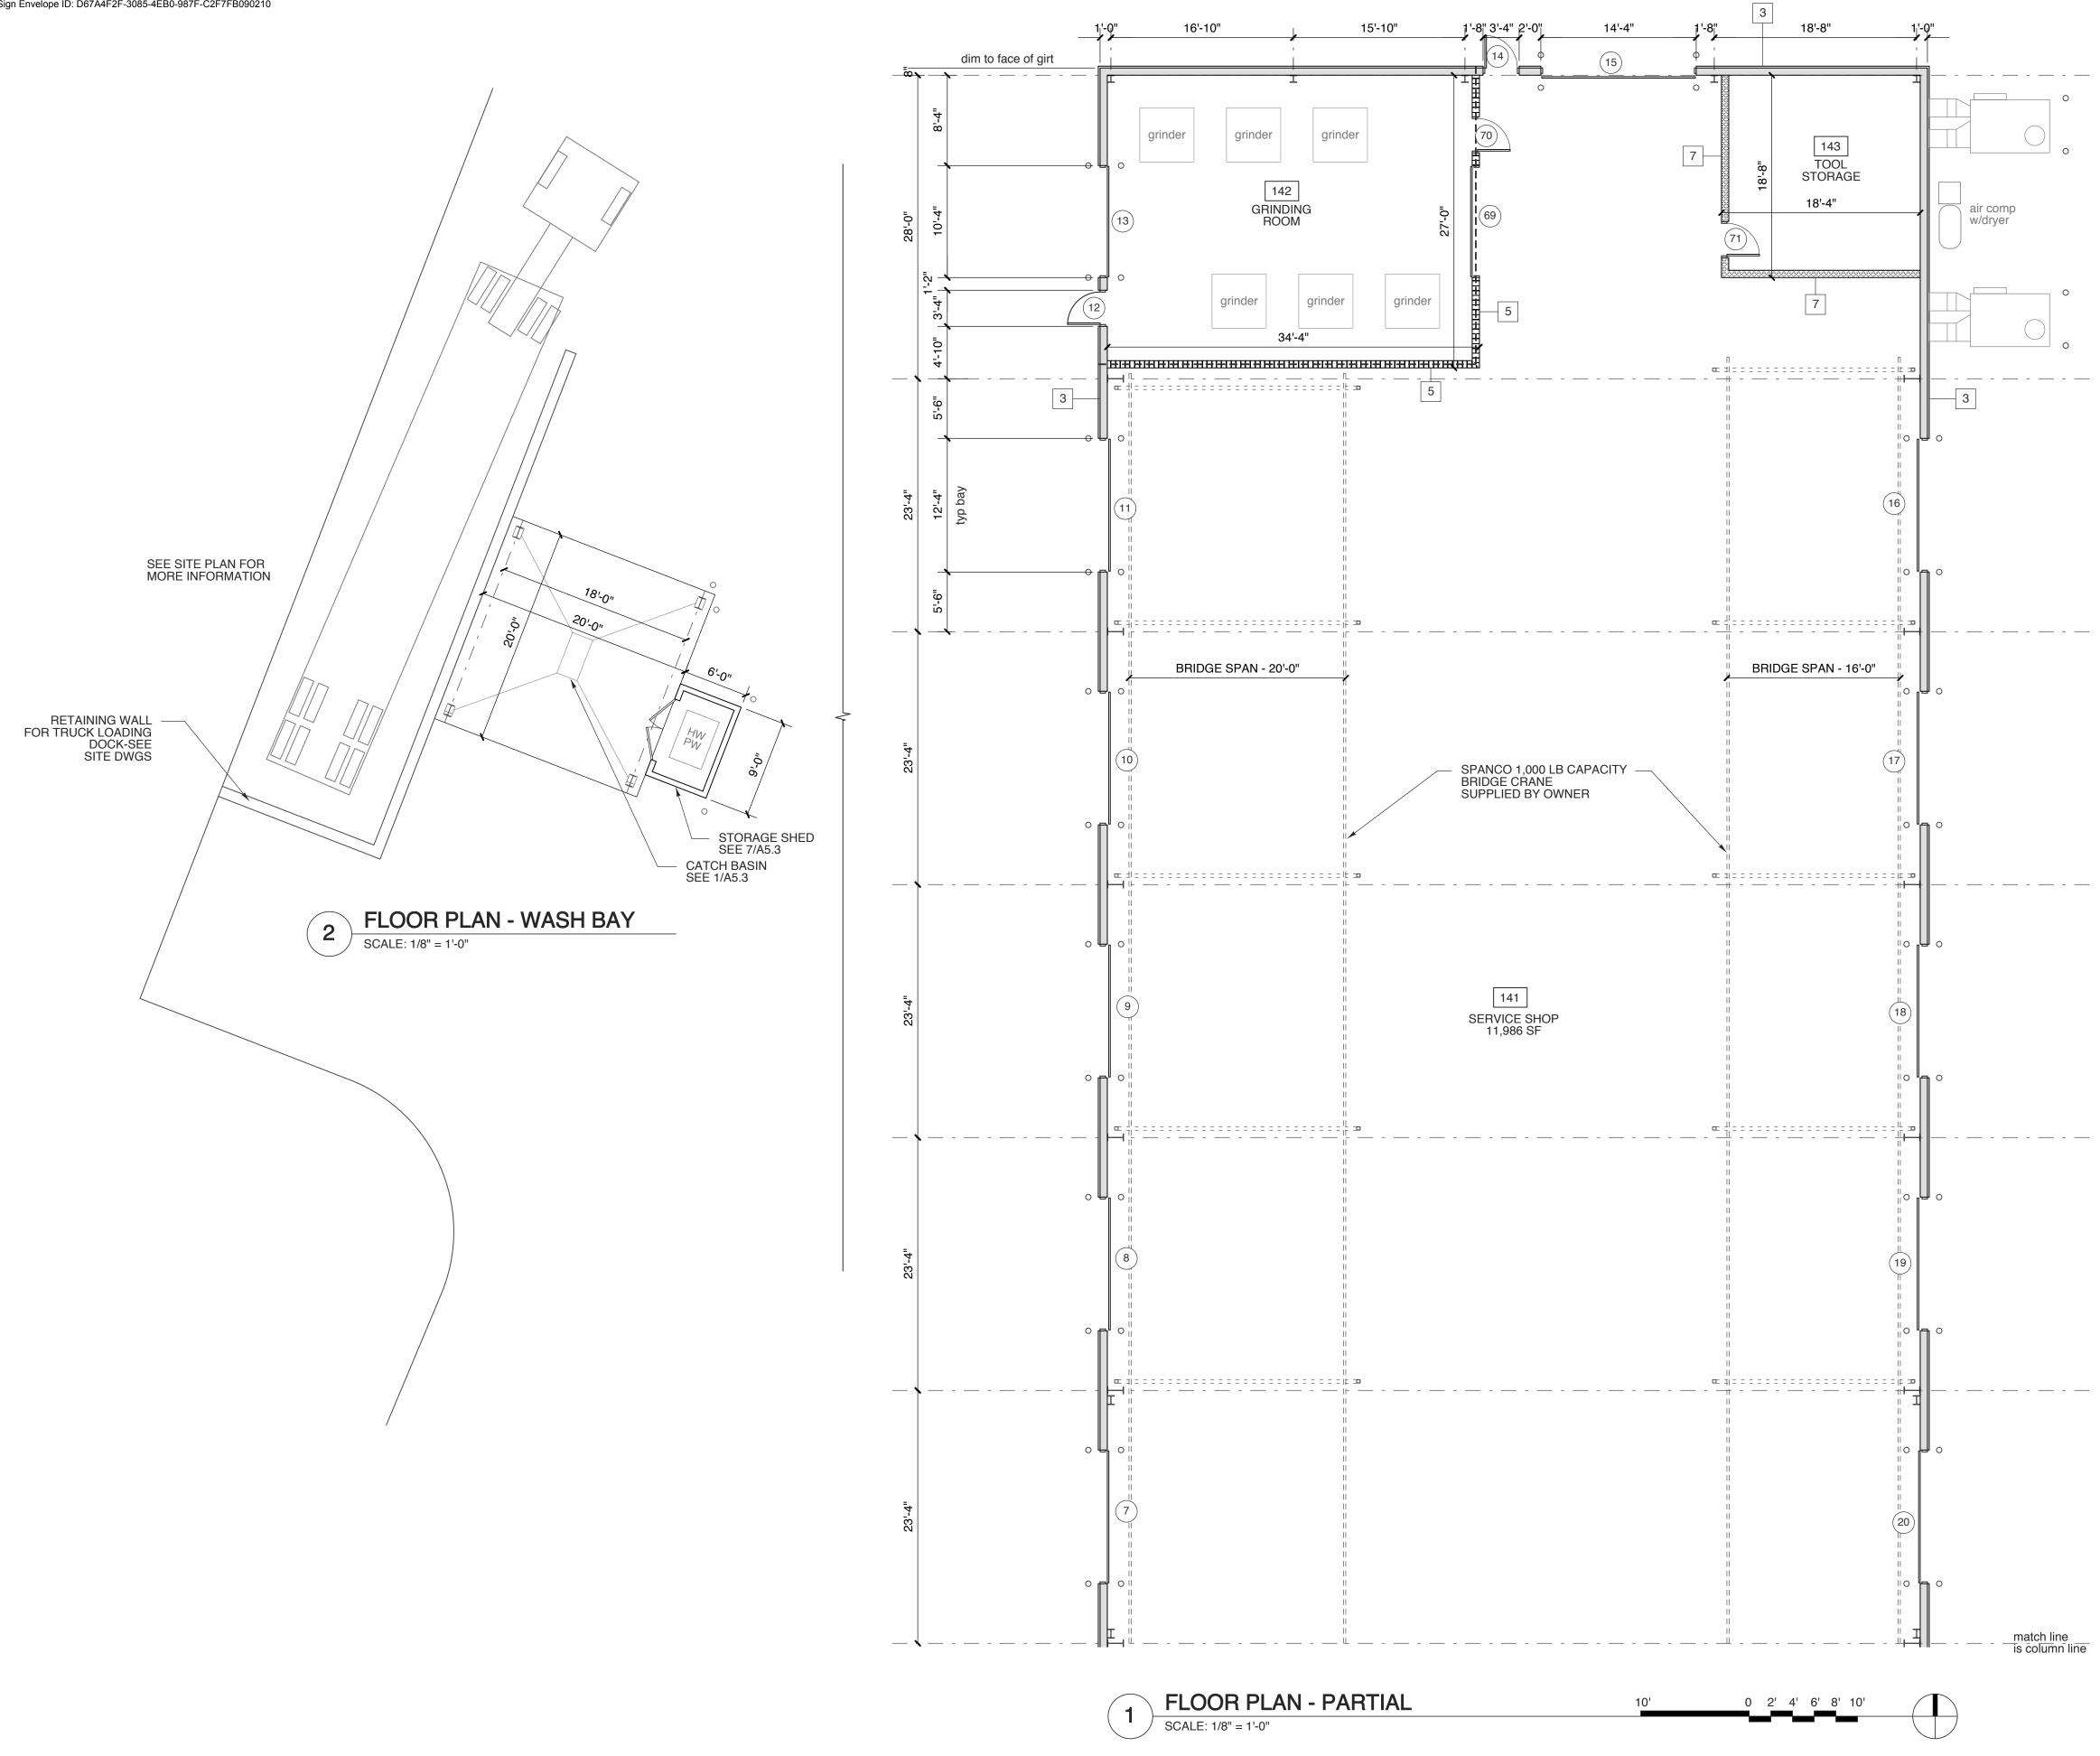PROJECT NO. 2232b DRAWING TITLE

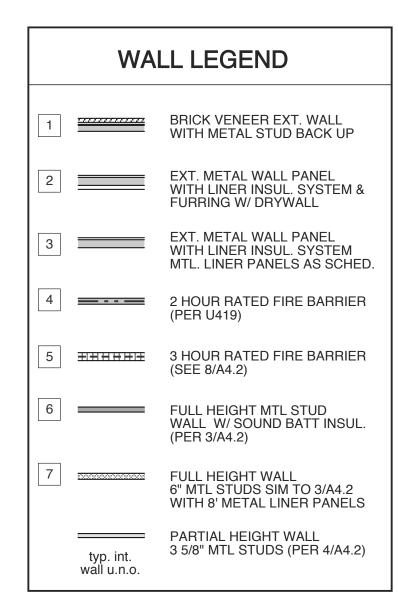
REAR SECT-PLAN



PLOT DATE REVISION


10/25/23

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SCALE: 1/8" = 1'-0"

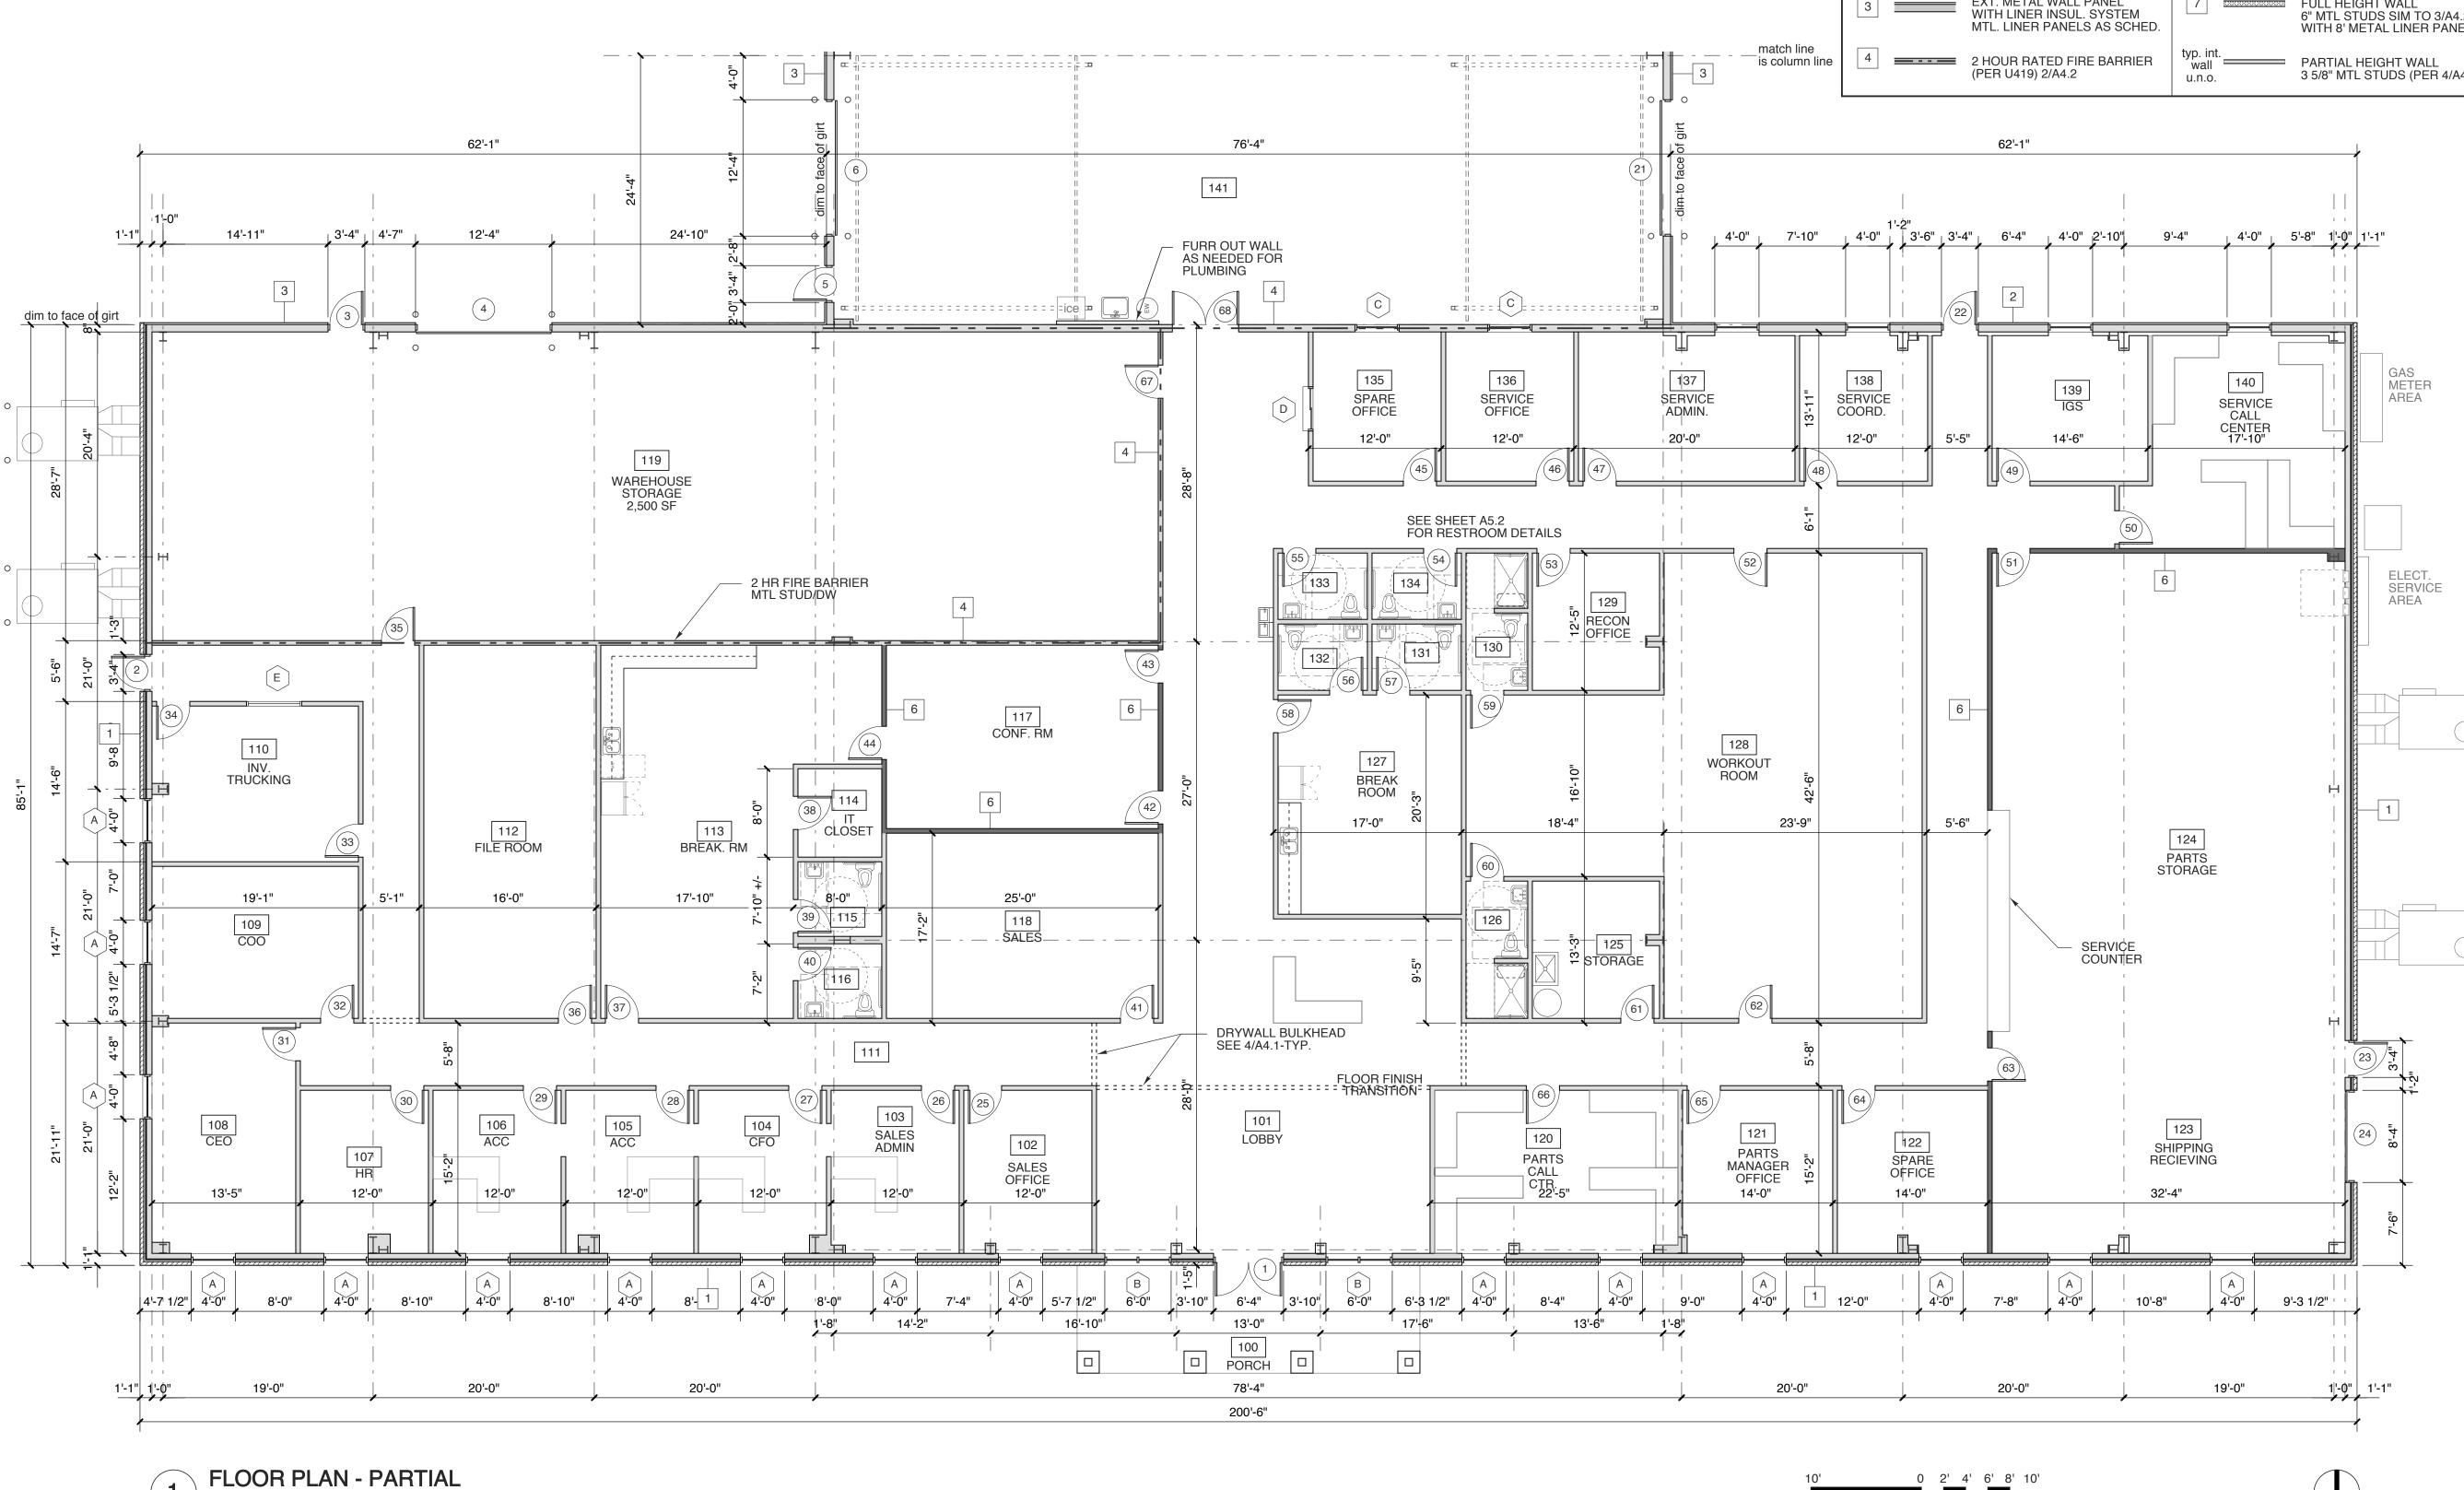10'



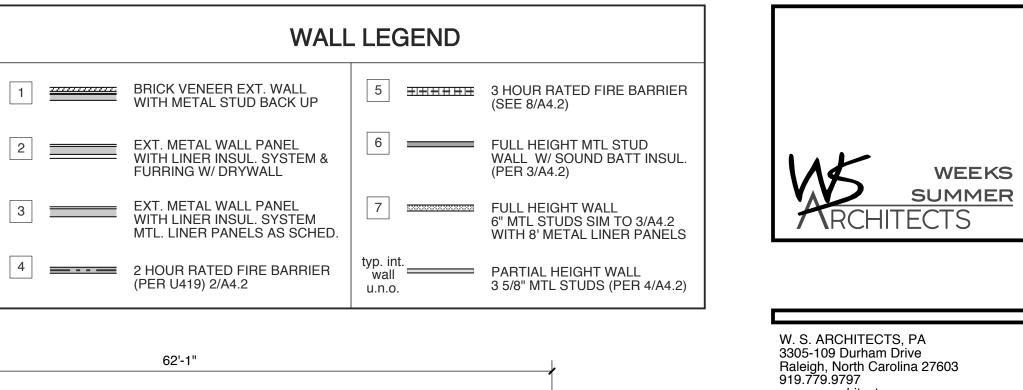

11075 Hinger S. Summer -E9D28345662C422... 10/25/2023

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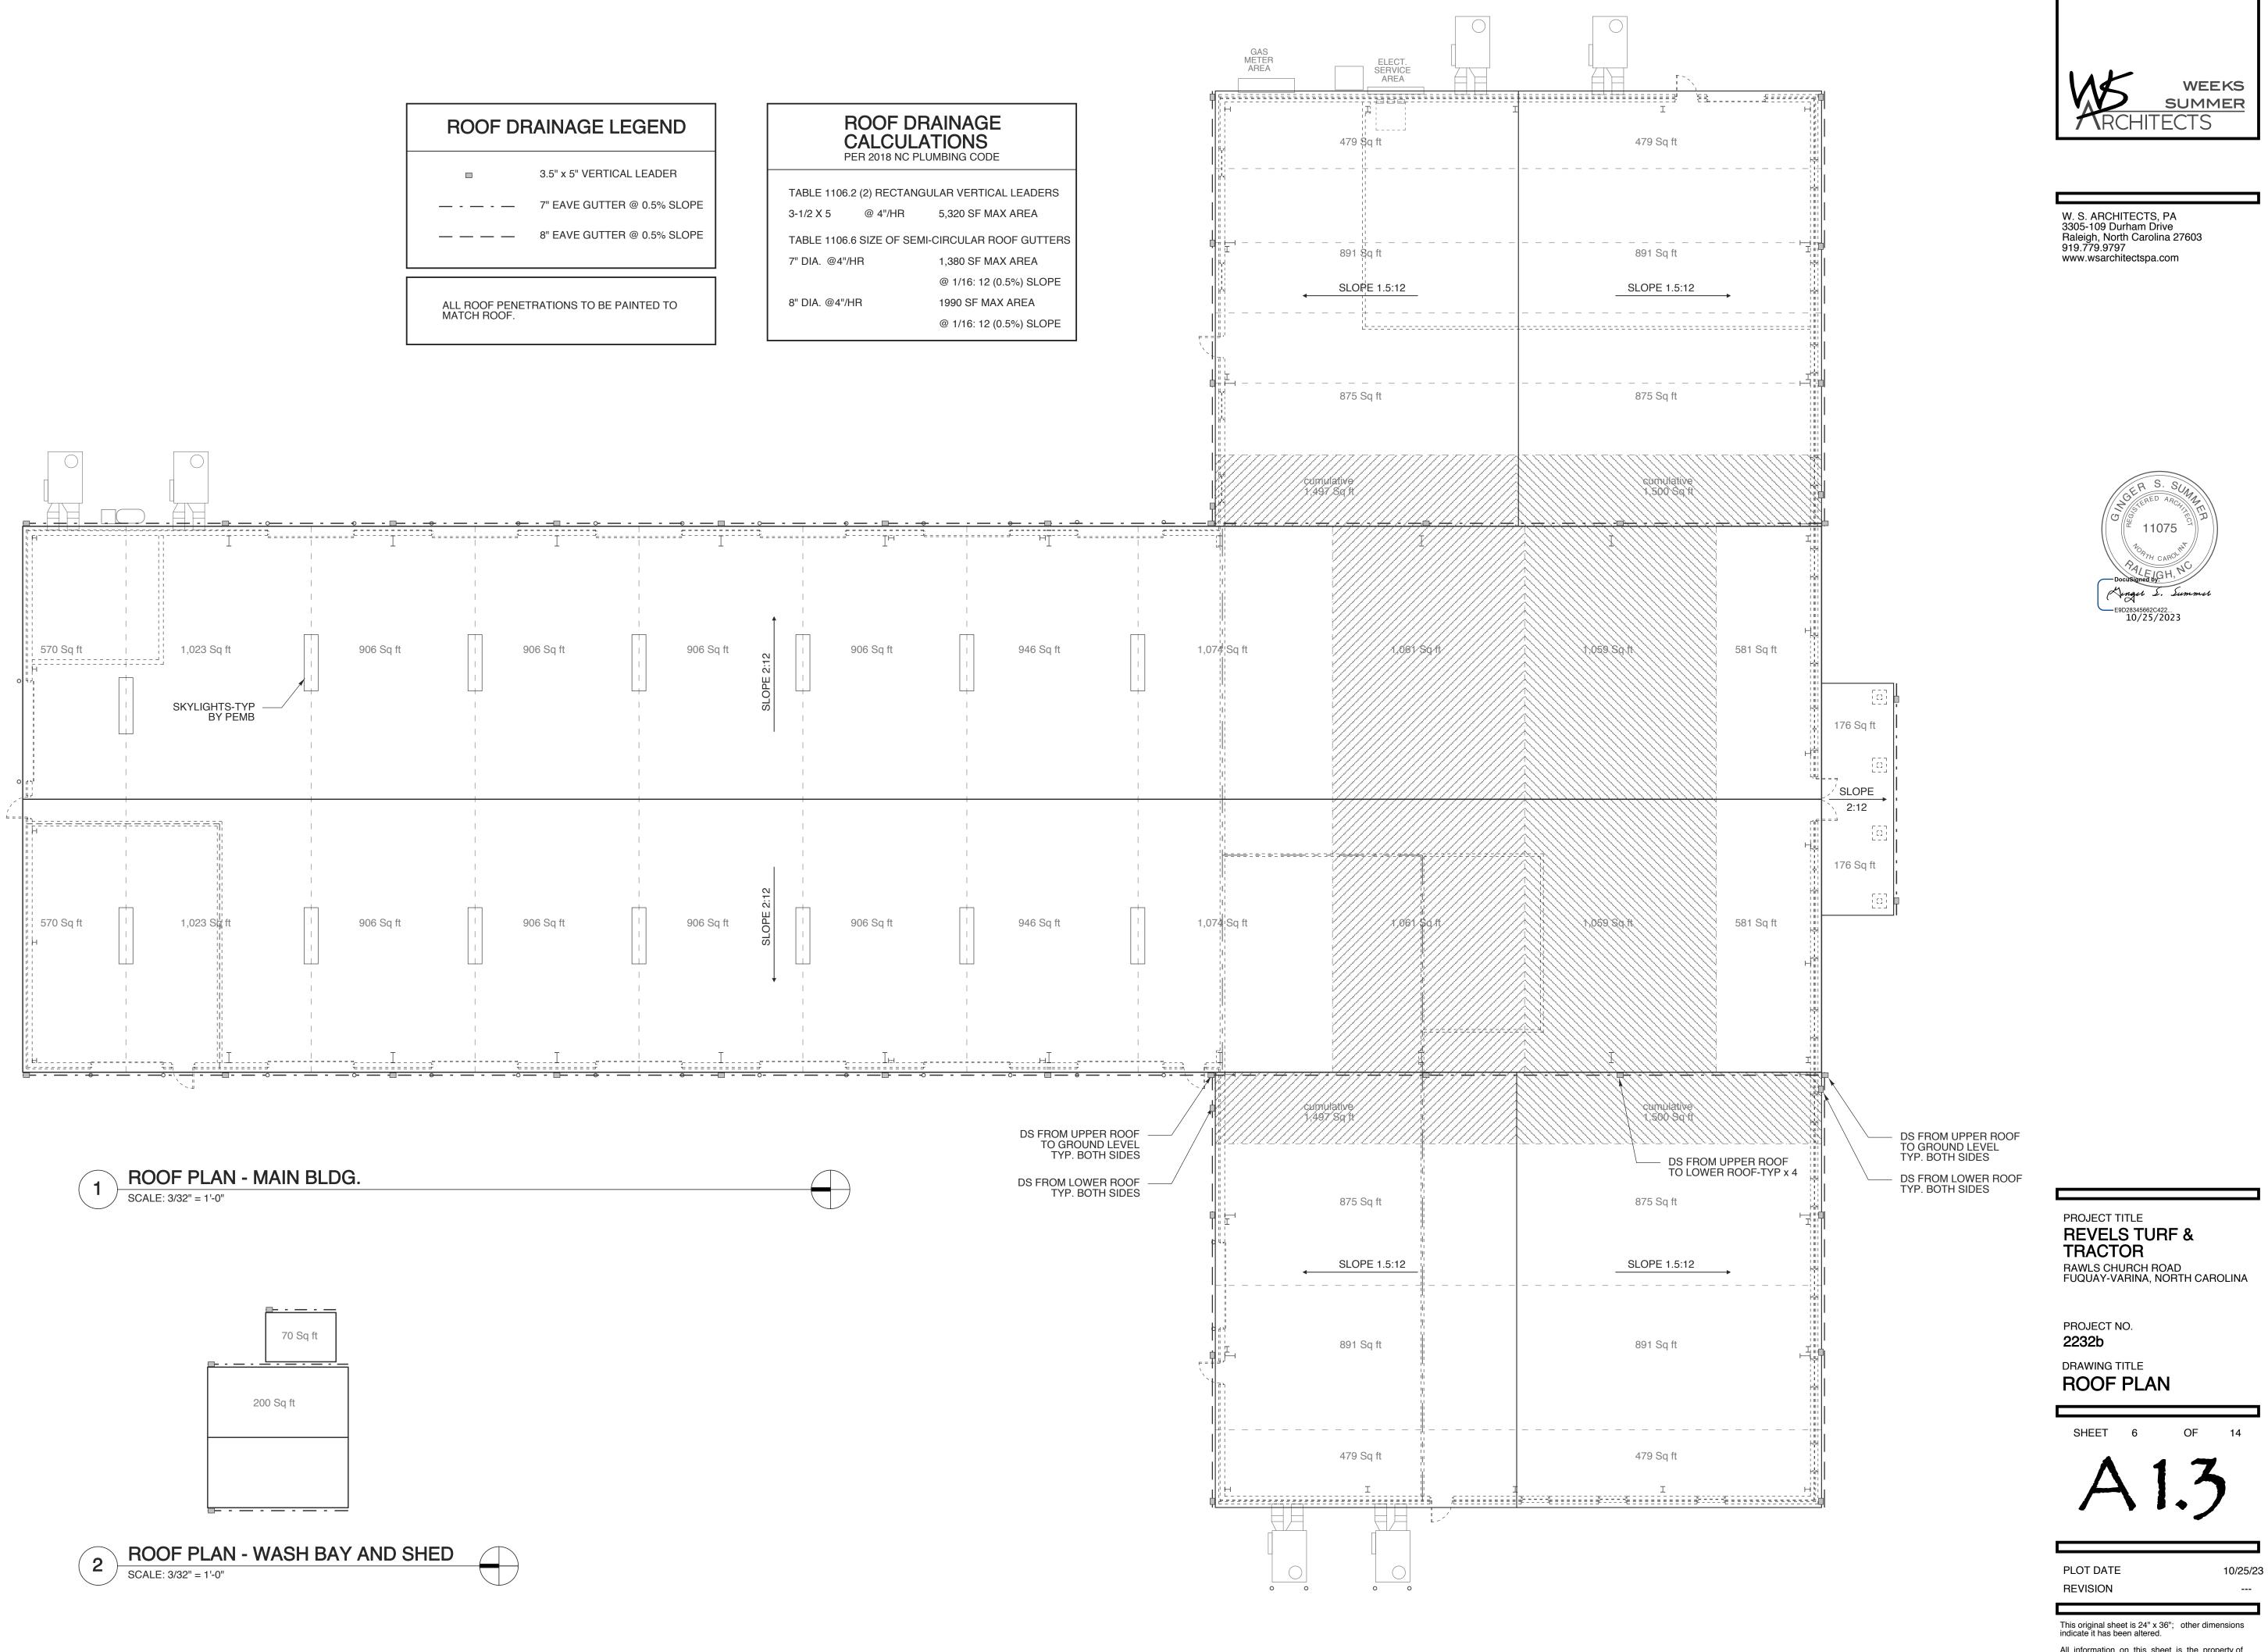
REVELS TRACTO RAWLS CHUI FUQUAY-VAF)R RCH ROAI	D	olina
PROJECT NC 2232).		
DRAWING TI		١	
SHEET	5	OF	14
A	1	•	2
PLOT DATE REVISION			10/25/23

PROJECT TITLE


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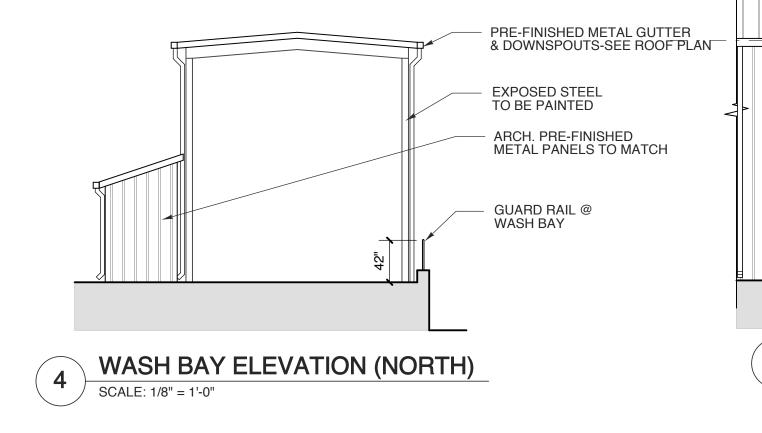
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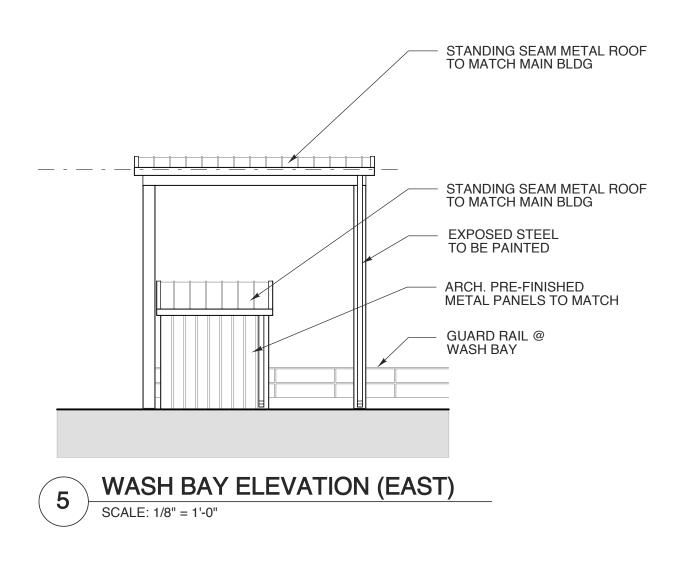
ROOF DR
ALL ROOF PENET




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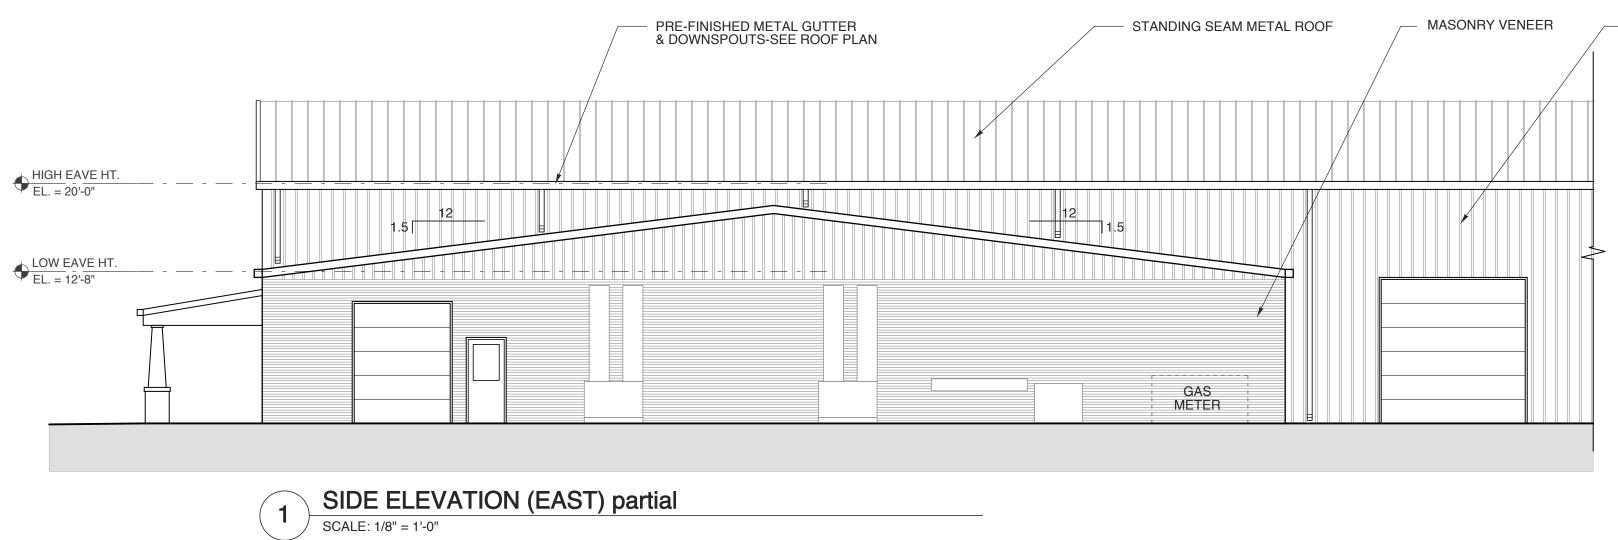







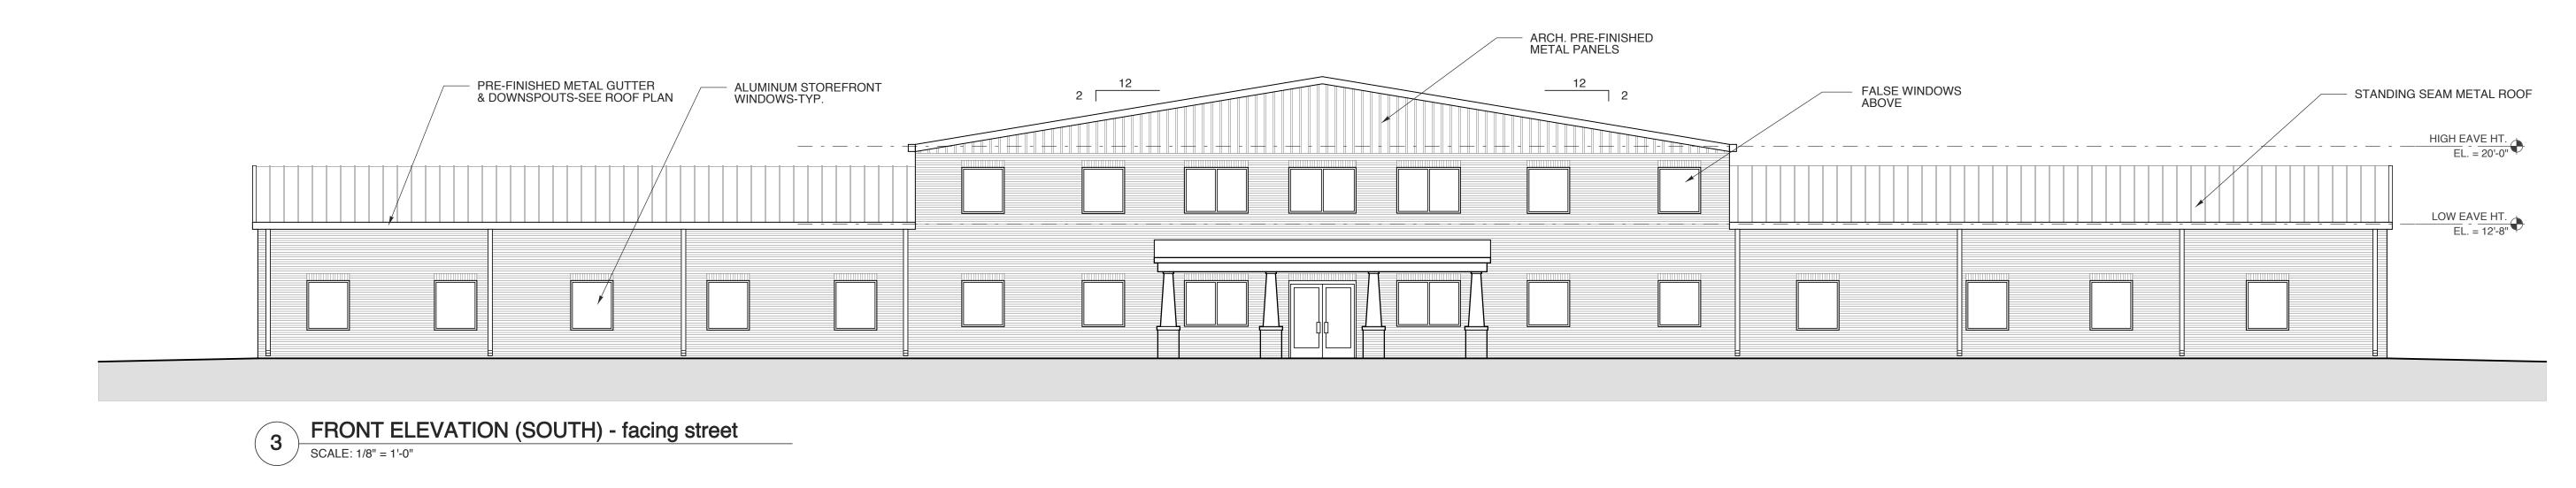


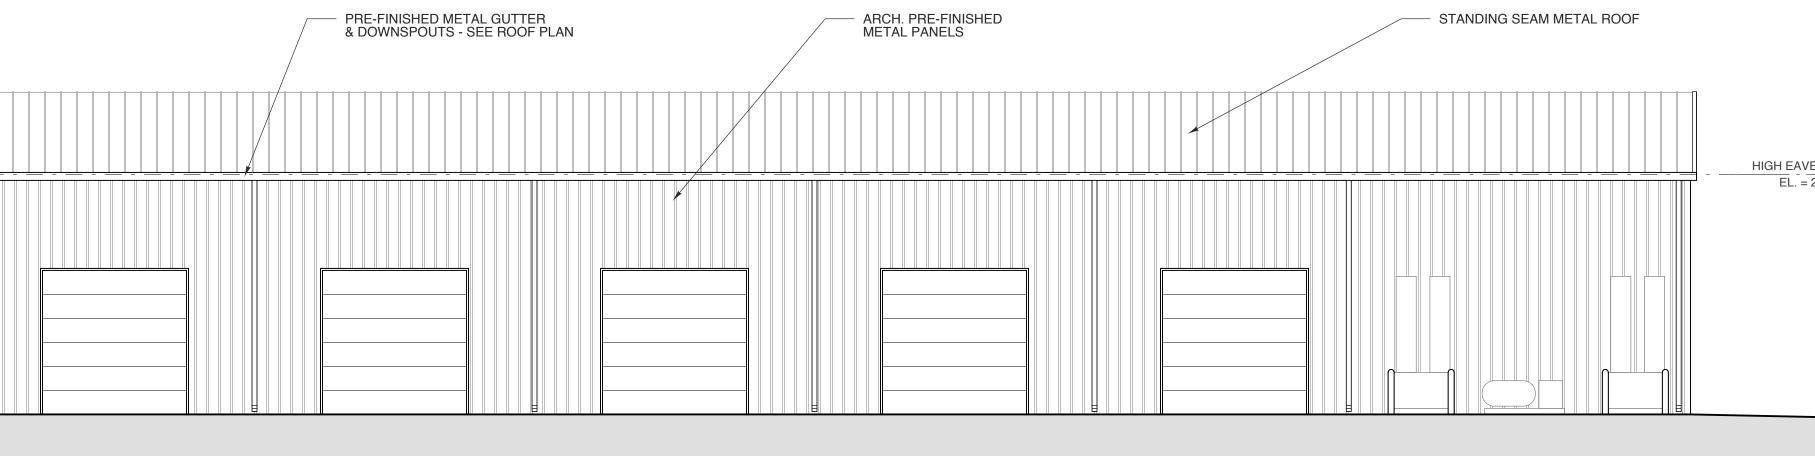SIDE ELEVATION (EAST) partial **2** SCALE: 1/8" = 1'-0"




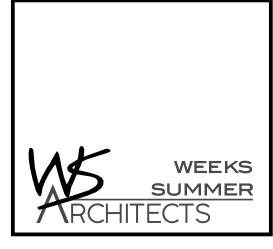


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HIGH EAVE HT. EL. = 20'-0"

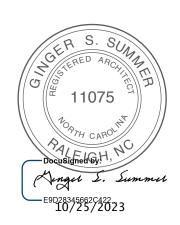

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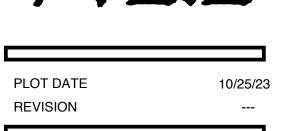
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11075

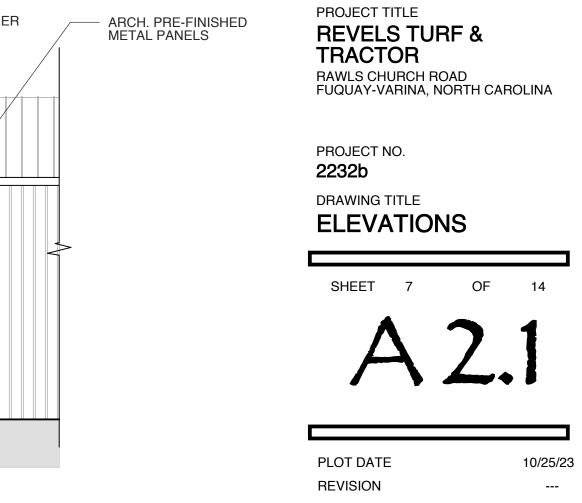
Docusigned by? 11, Henger I. Summer

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BUILDING SECTION

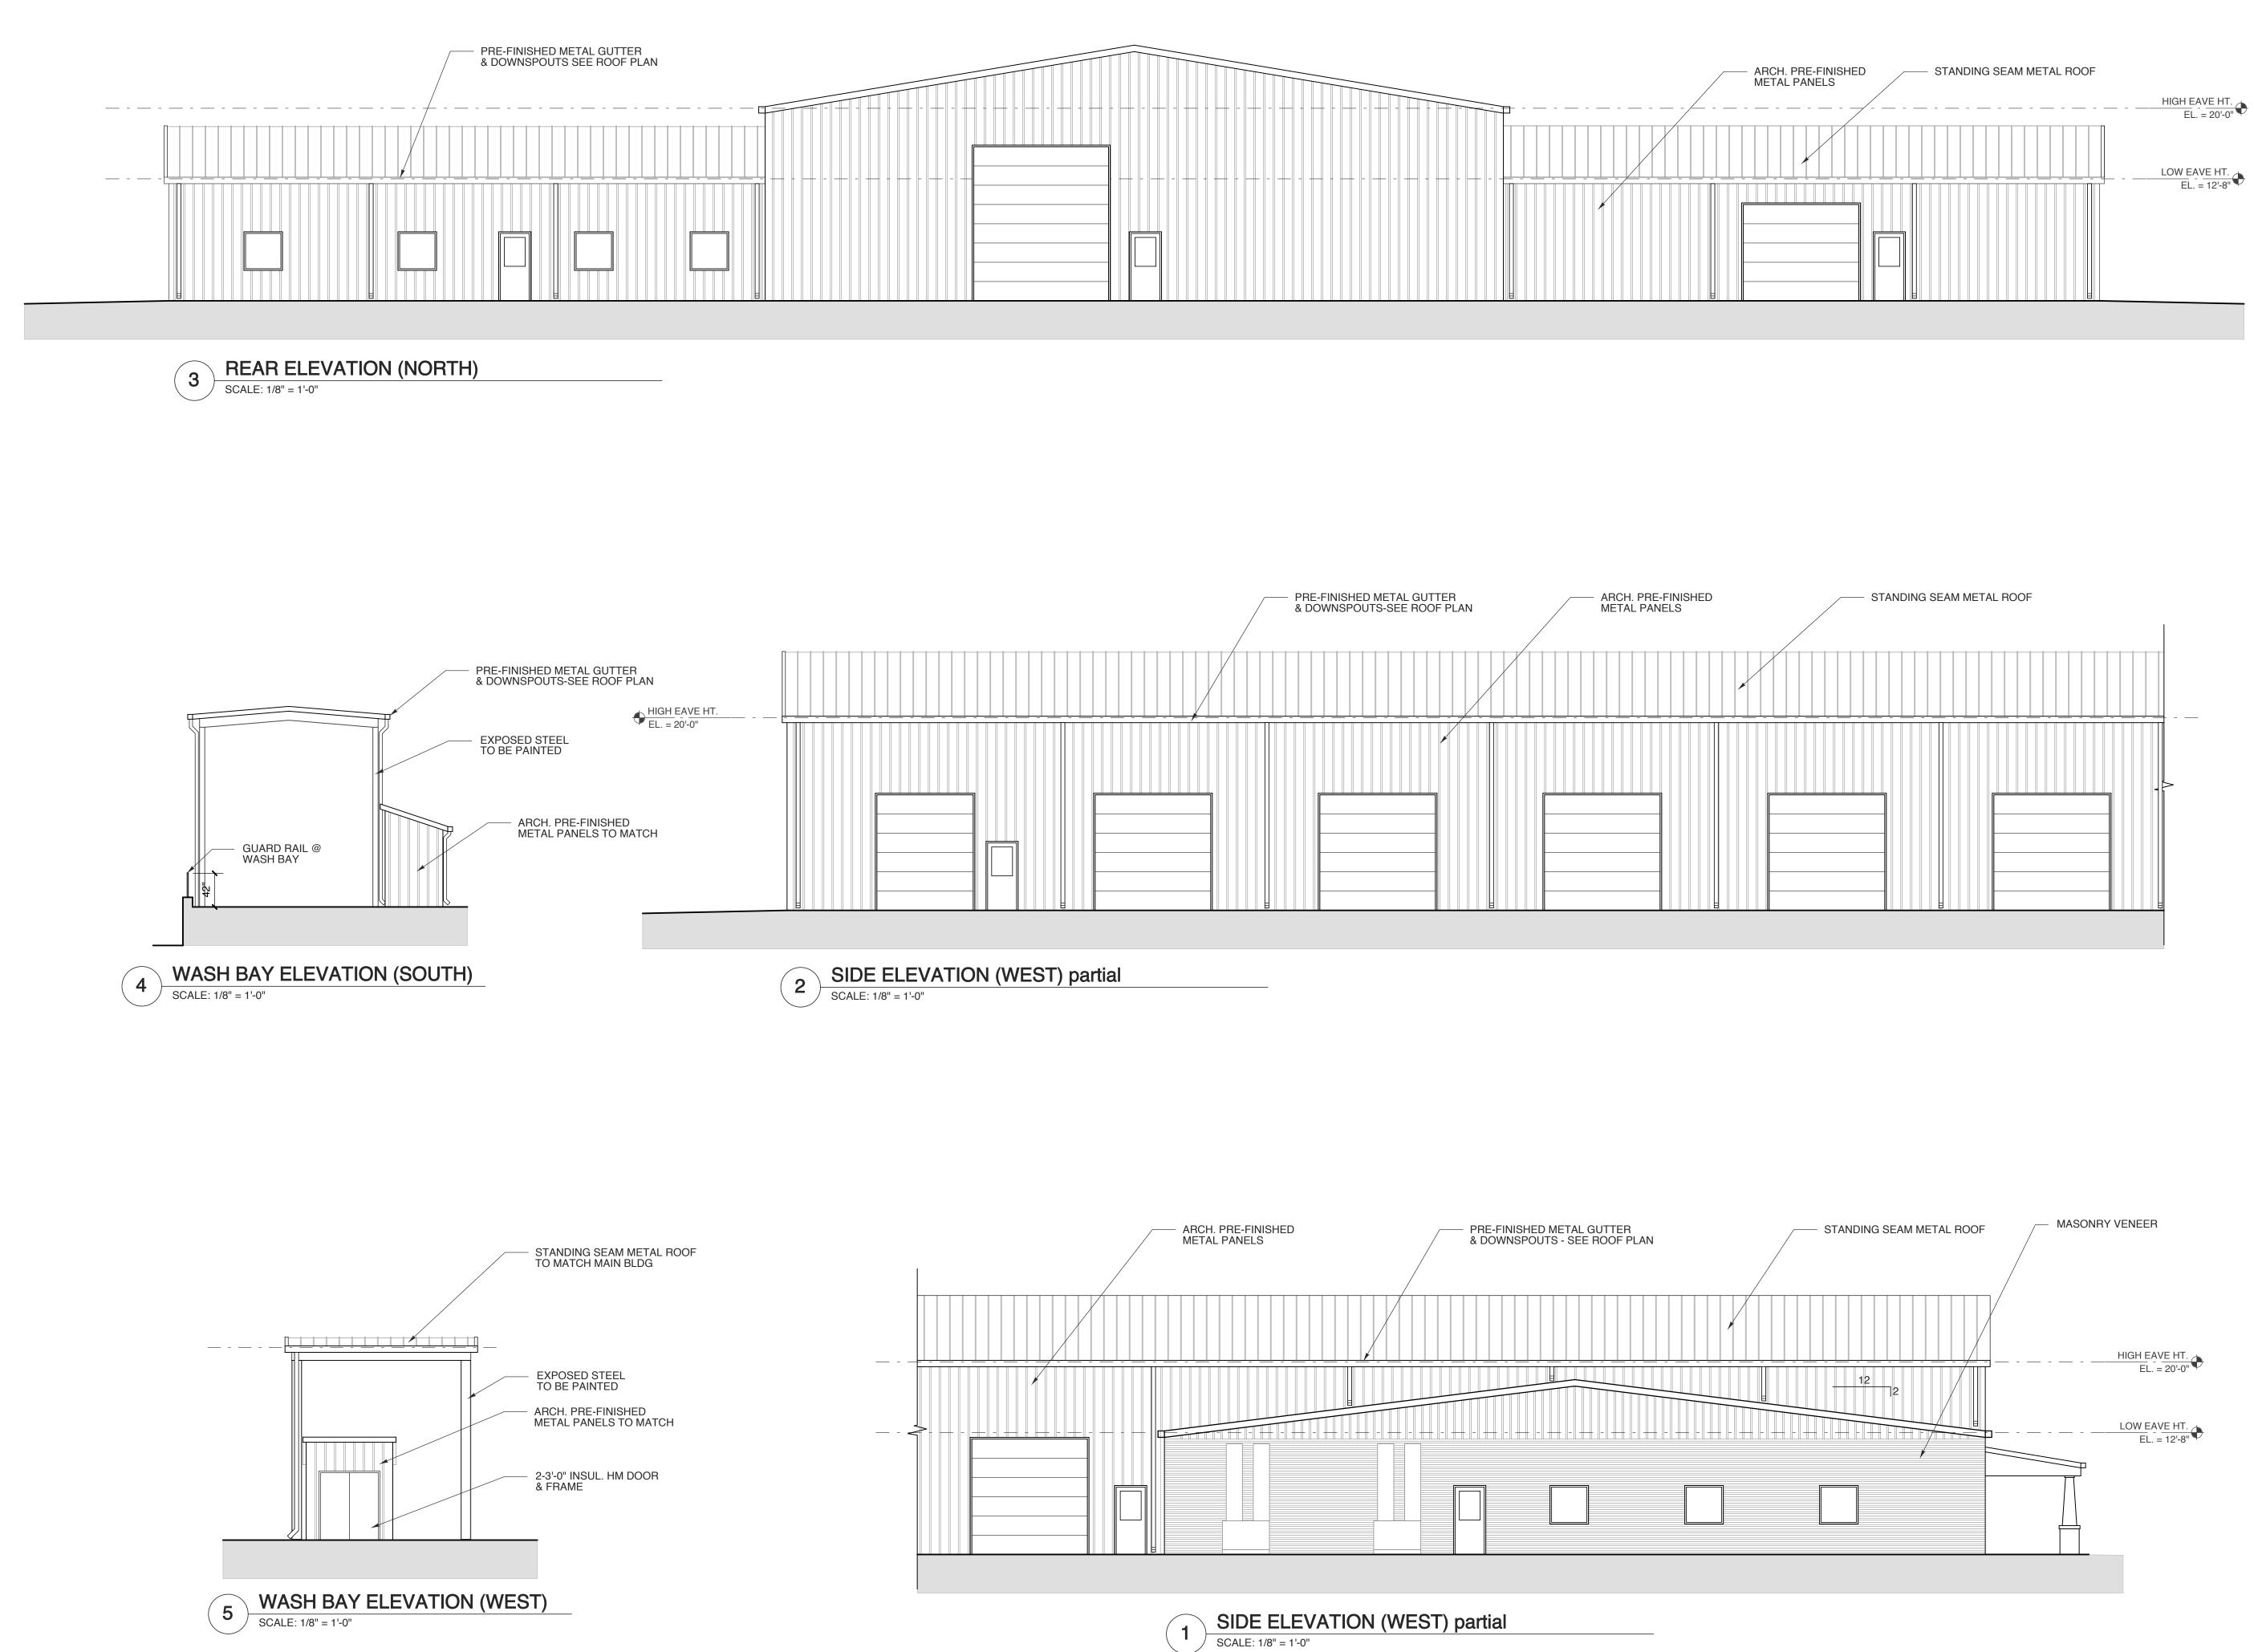
SEE STRUCTURAL DRAWINGS FOR FOUNDATION AND FRAMING INFORMATION

MATERIAL	GLASS	REMARKS
ALUMINUM	1" INSUL. LOW E GLASS	FIXED
ALUMINUM	1" INSUL. LOW E GLASS	FIXED
ALUMINUM	90 MIN. RATED GLASS	FIXED
ALUMINUM	TEMPERED GLASS	SLIDER
ALUMINUM	TEMPERED GLASS	FIXED
	ALUMINUM ALUMINUM ALUMINUM ALUMINUM	MATERIALGLASSALUMINUM1" INSUL. LOW E GLASSALUMINUM1" INSUL. LOW E GLASSALUMINUM90 MIN. RATED GLASSALUMINUMTEMPERED GLASS

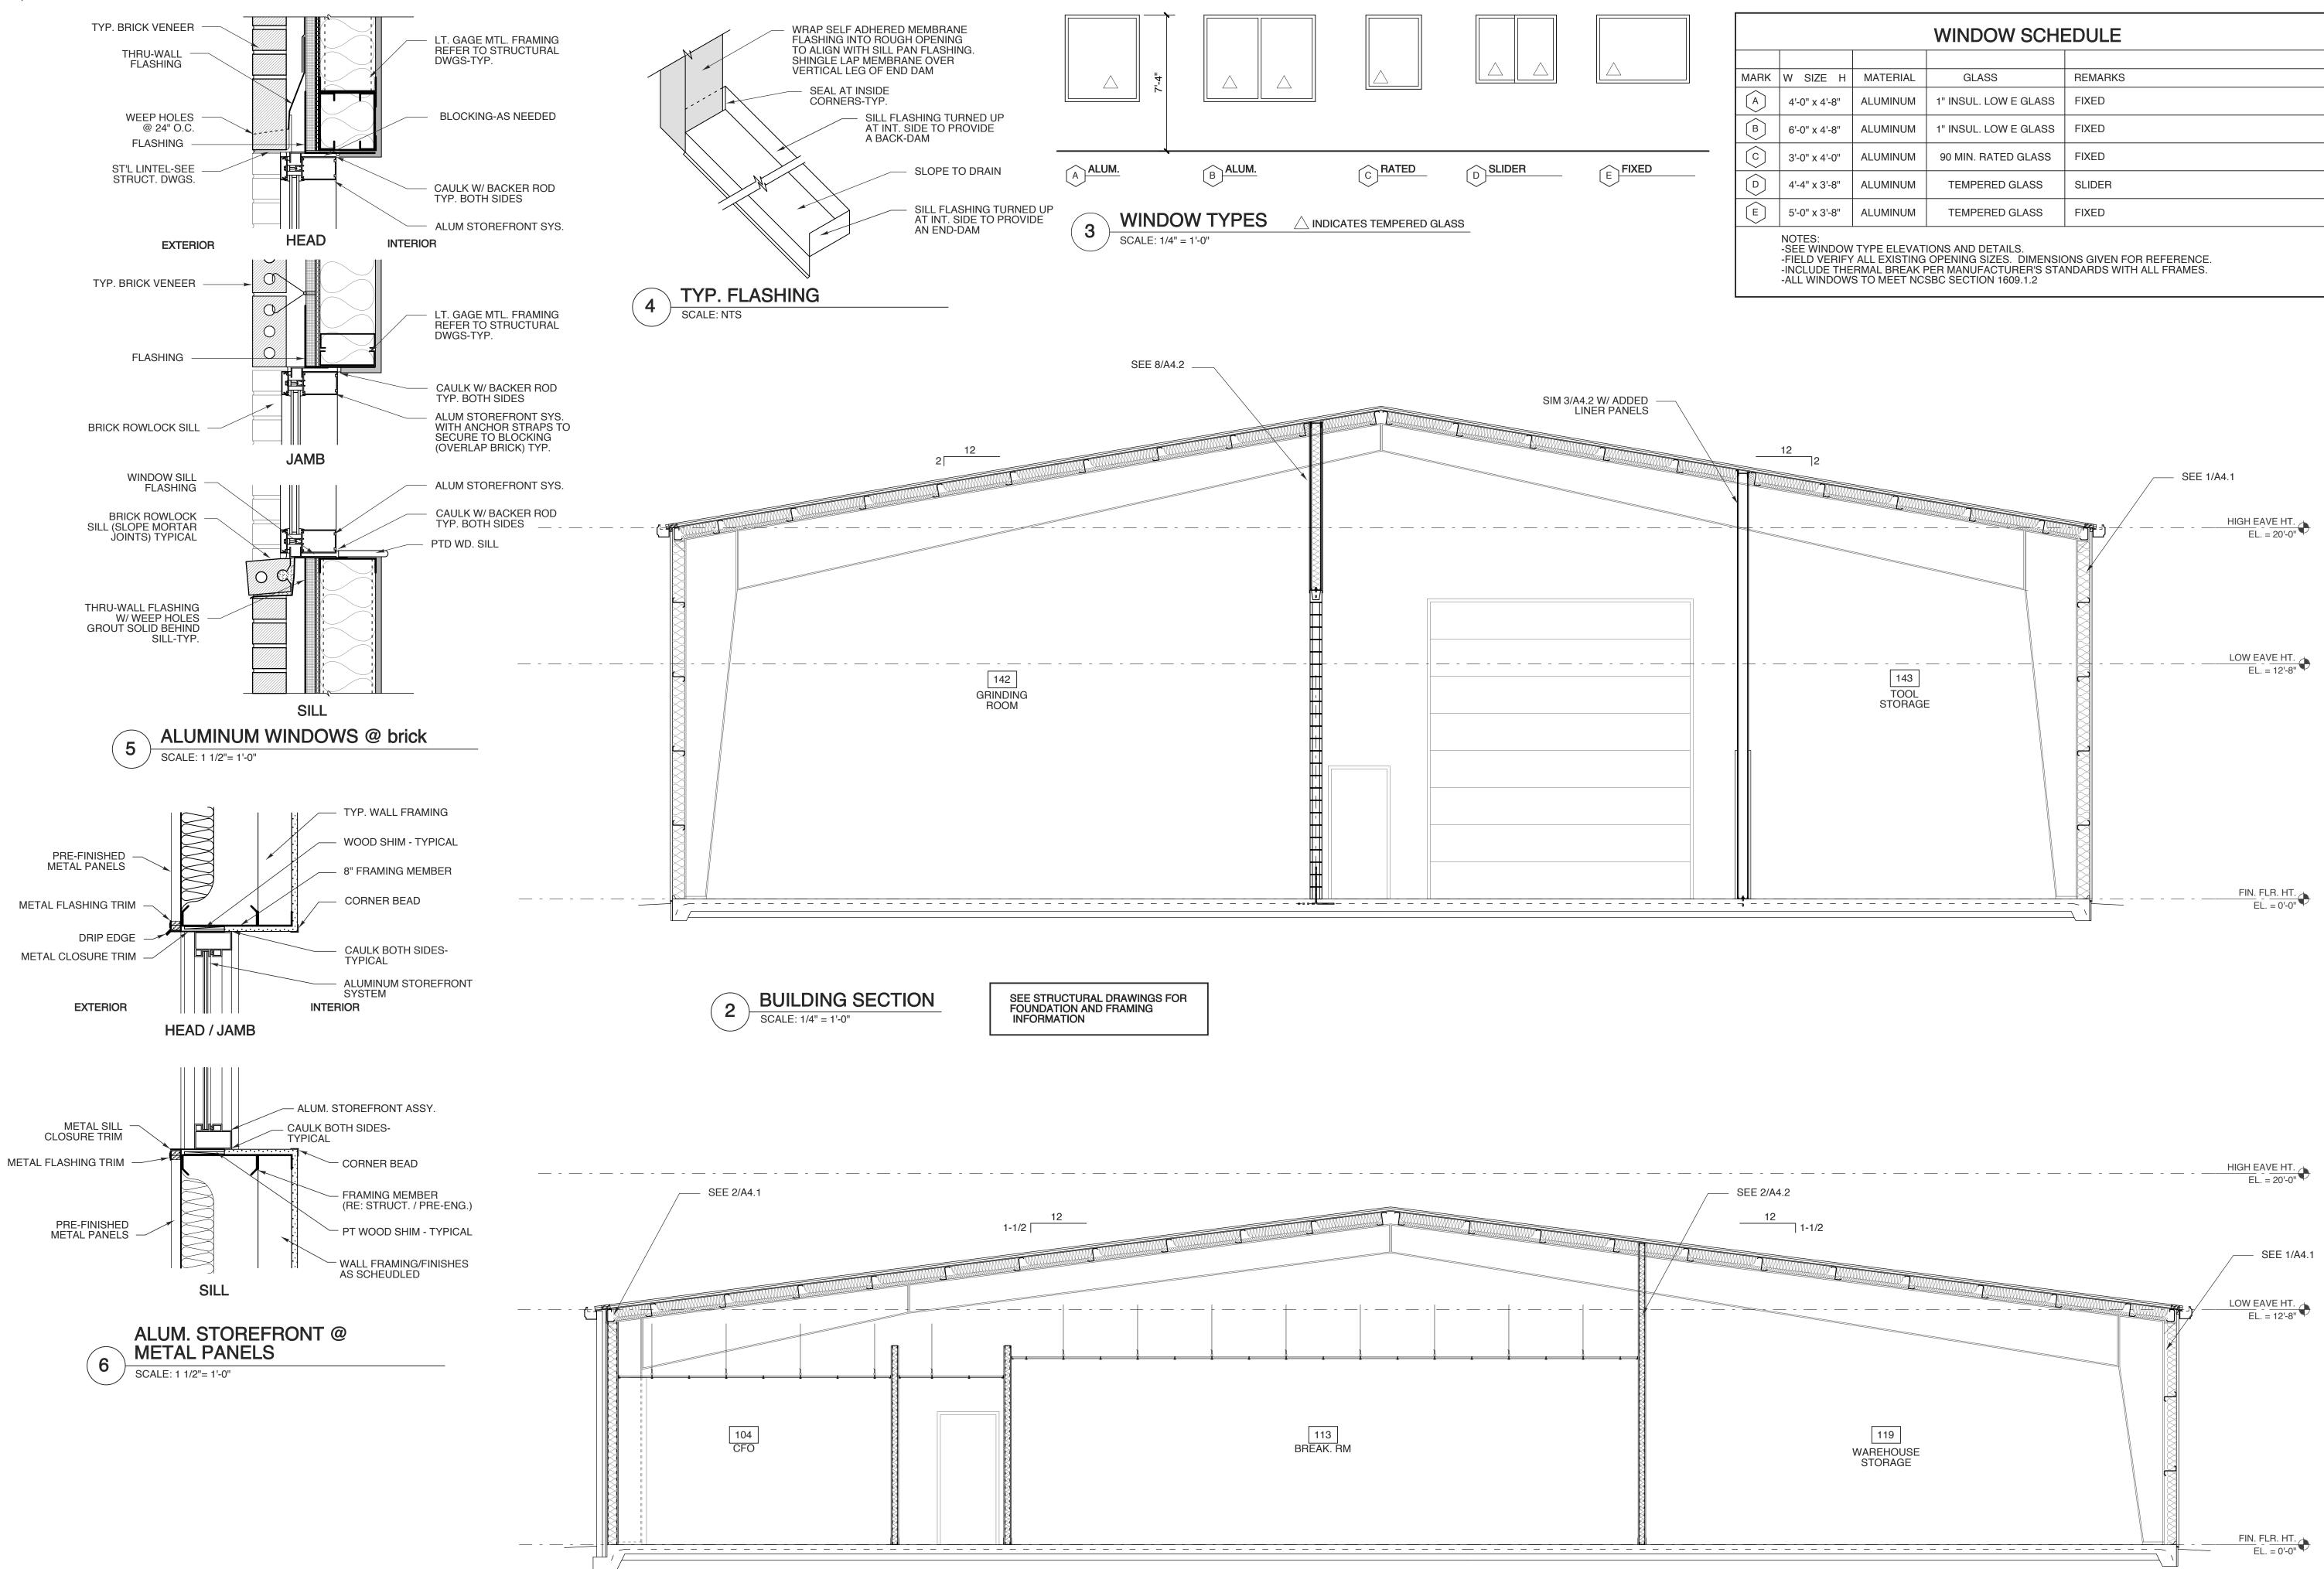



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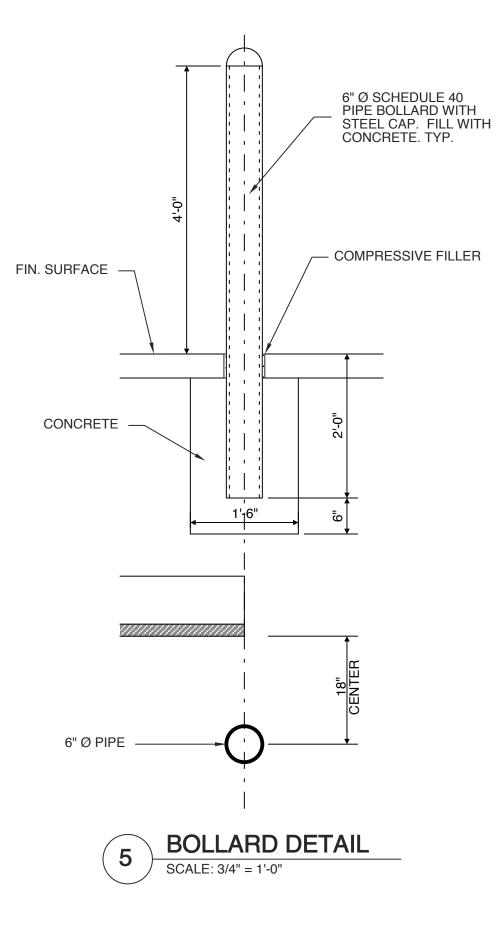


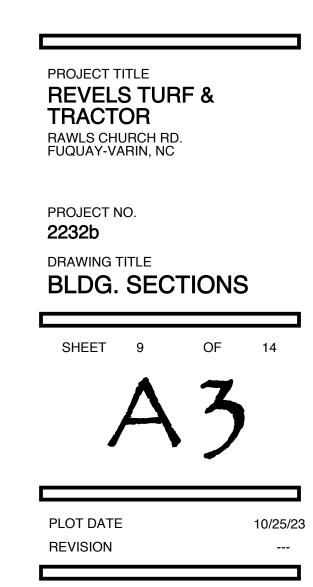



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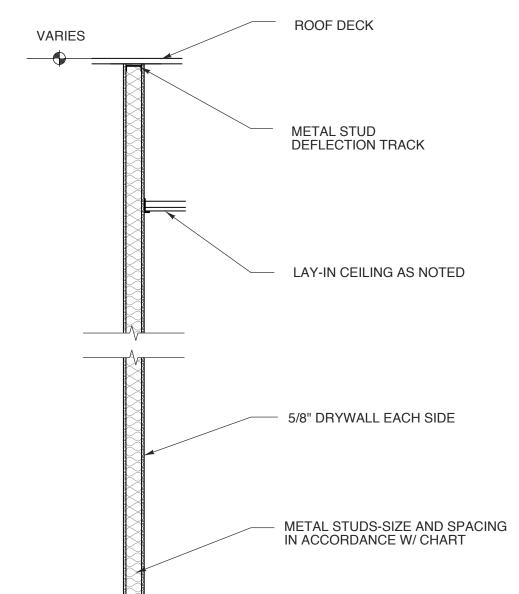




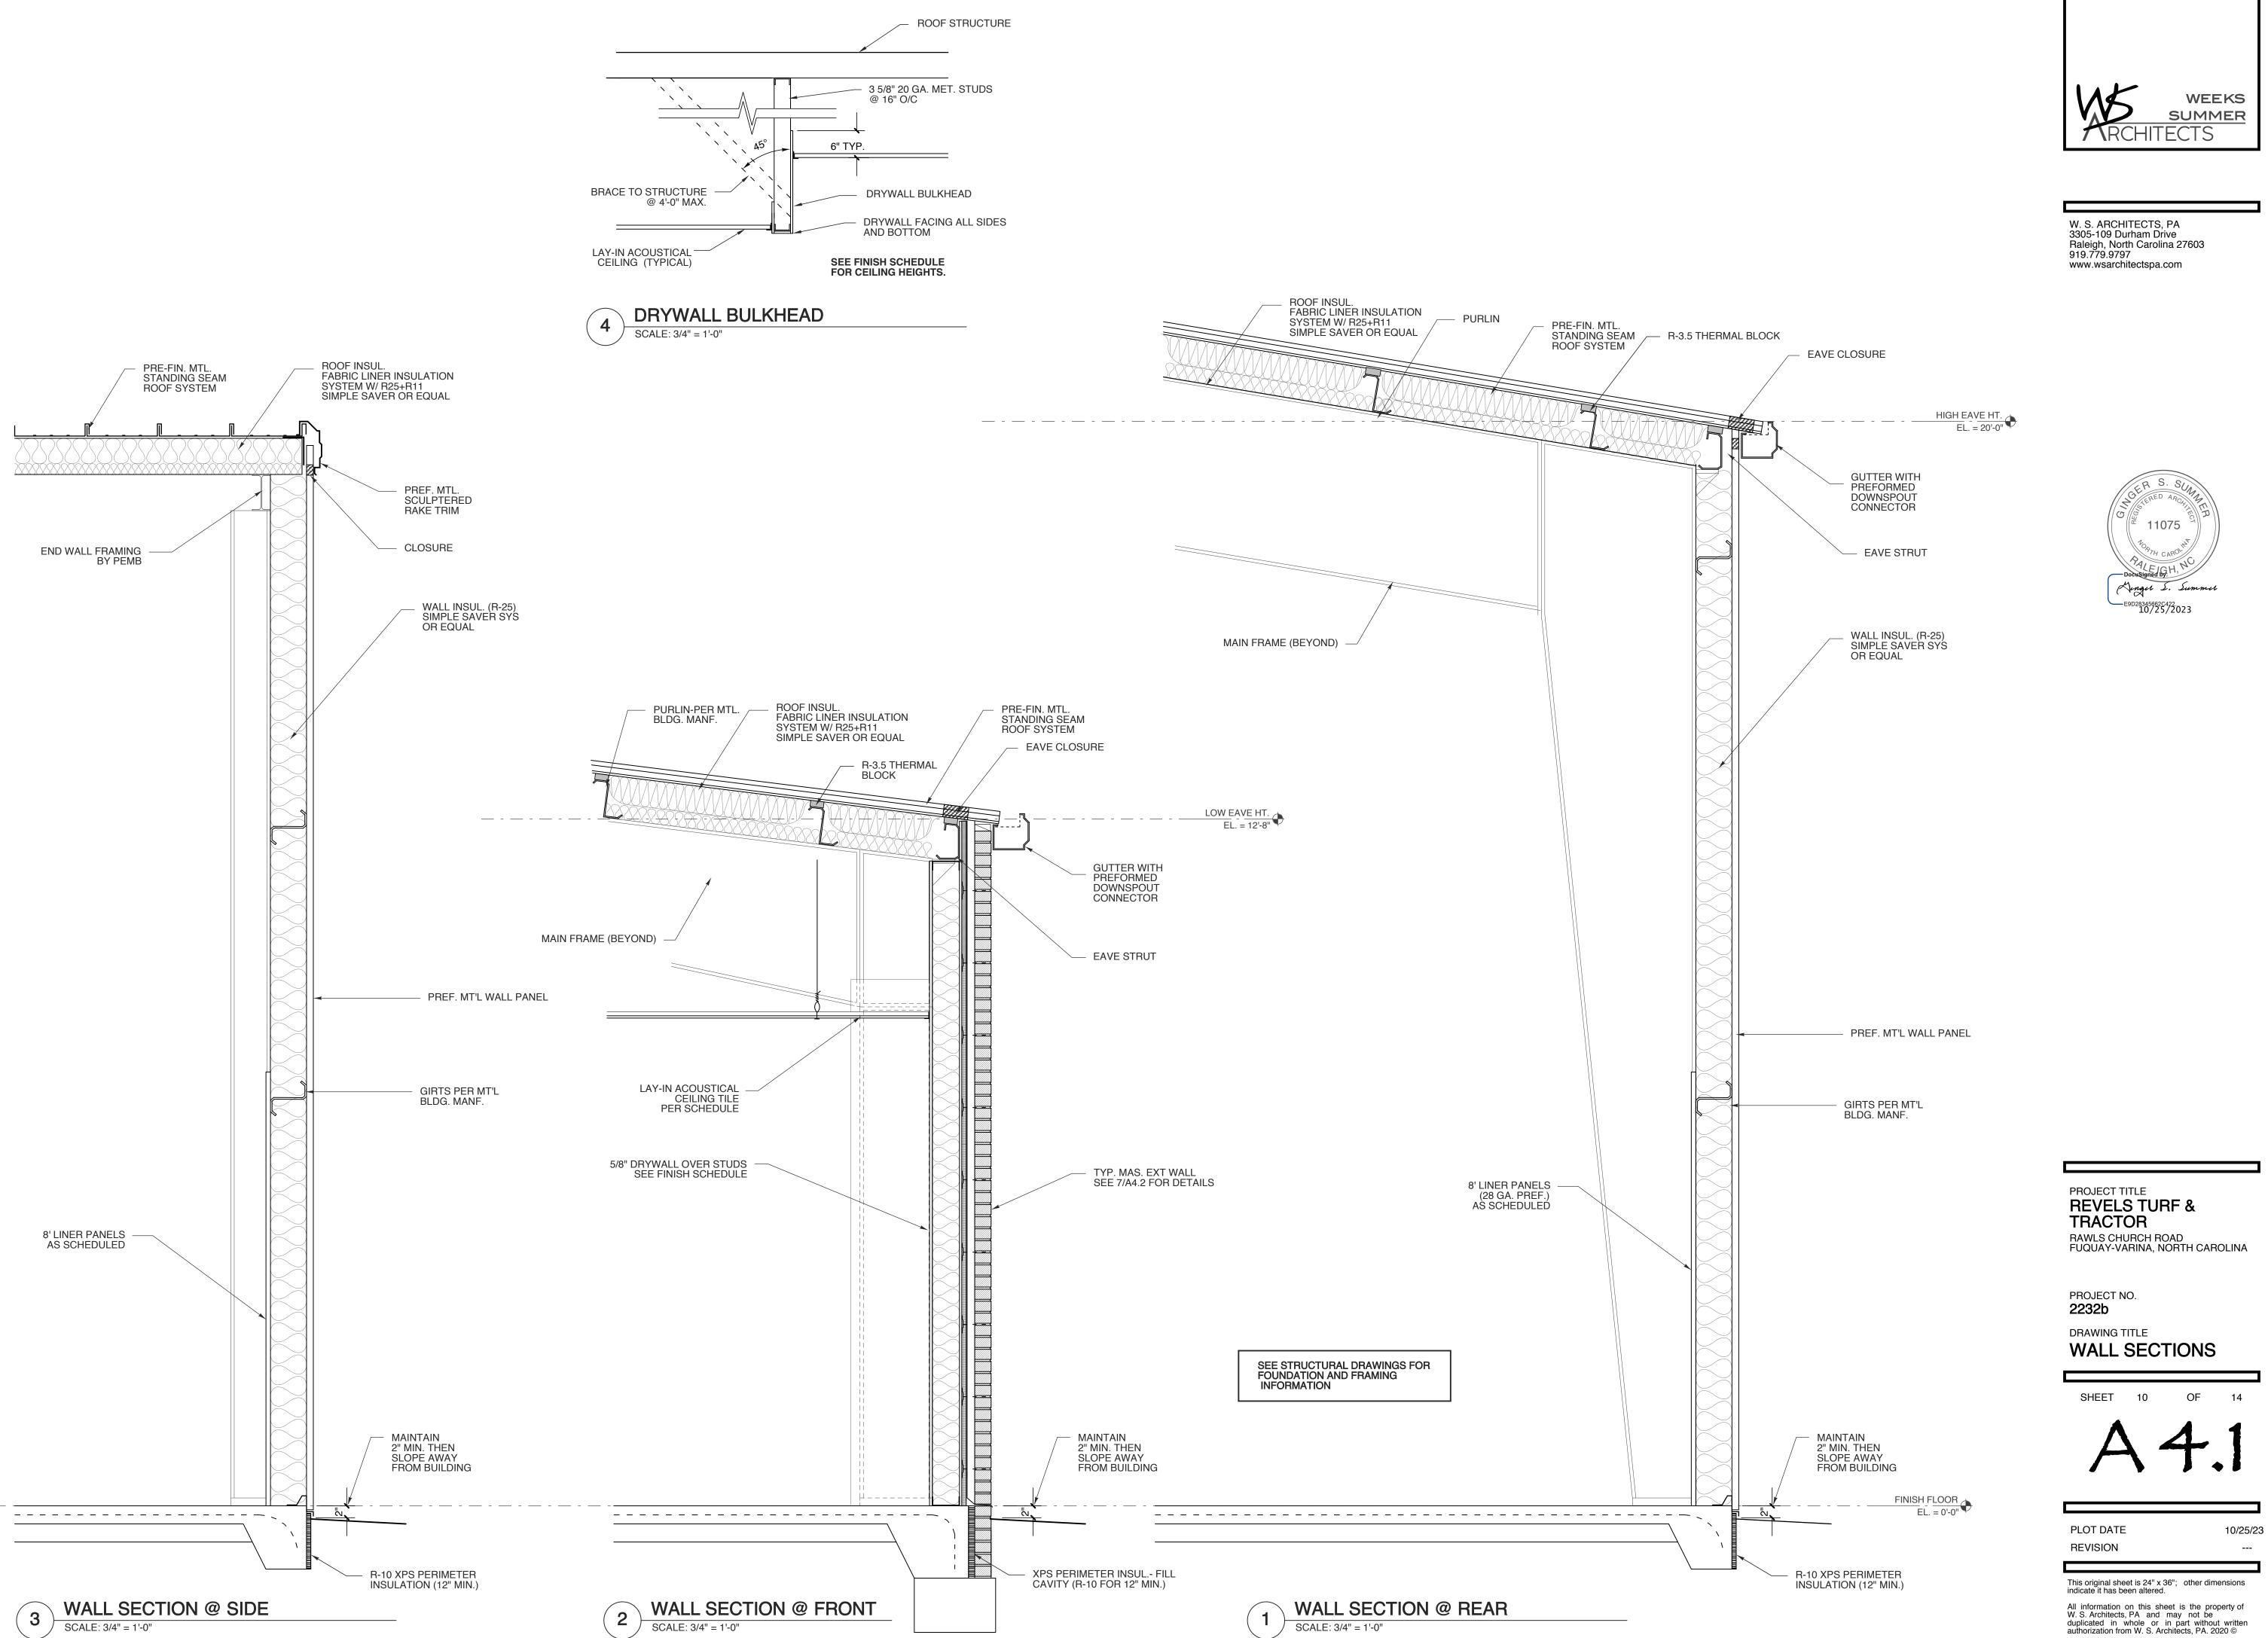

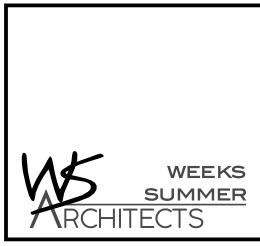

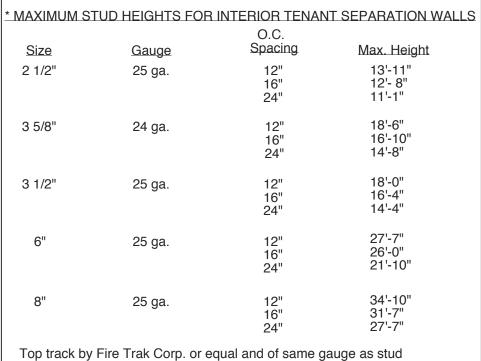

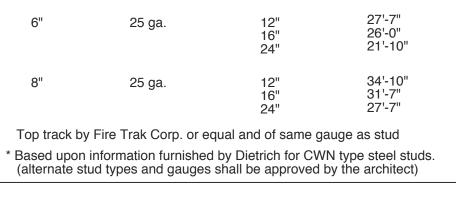



ANCHOR @ 2' O.C.

SCALE: 1/2" = 1'-0"


3

FULL HEIGHT WALL SECTION

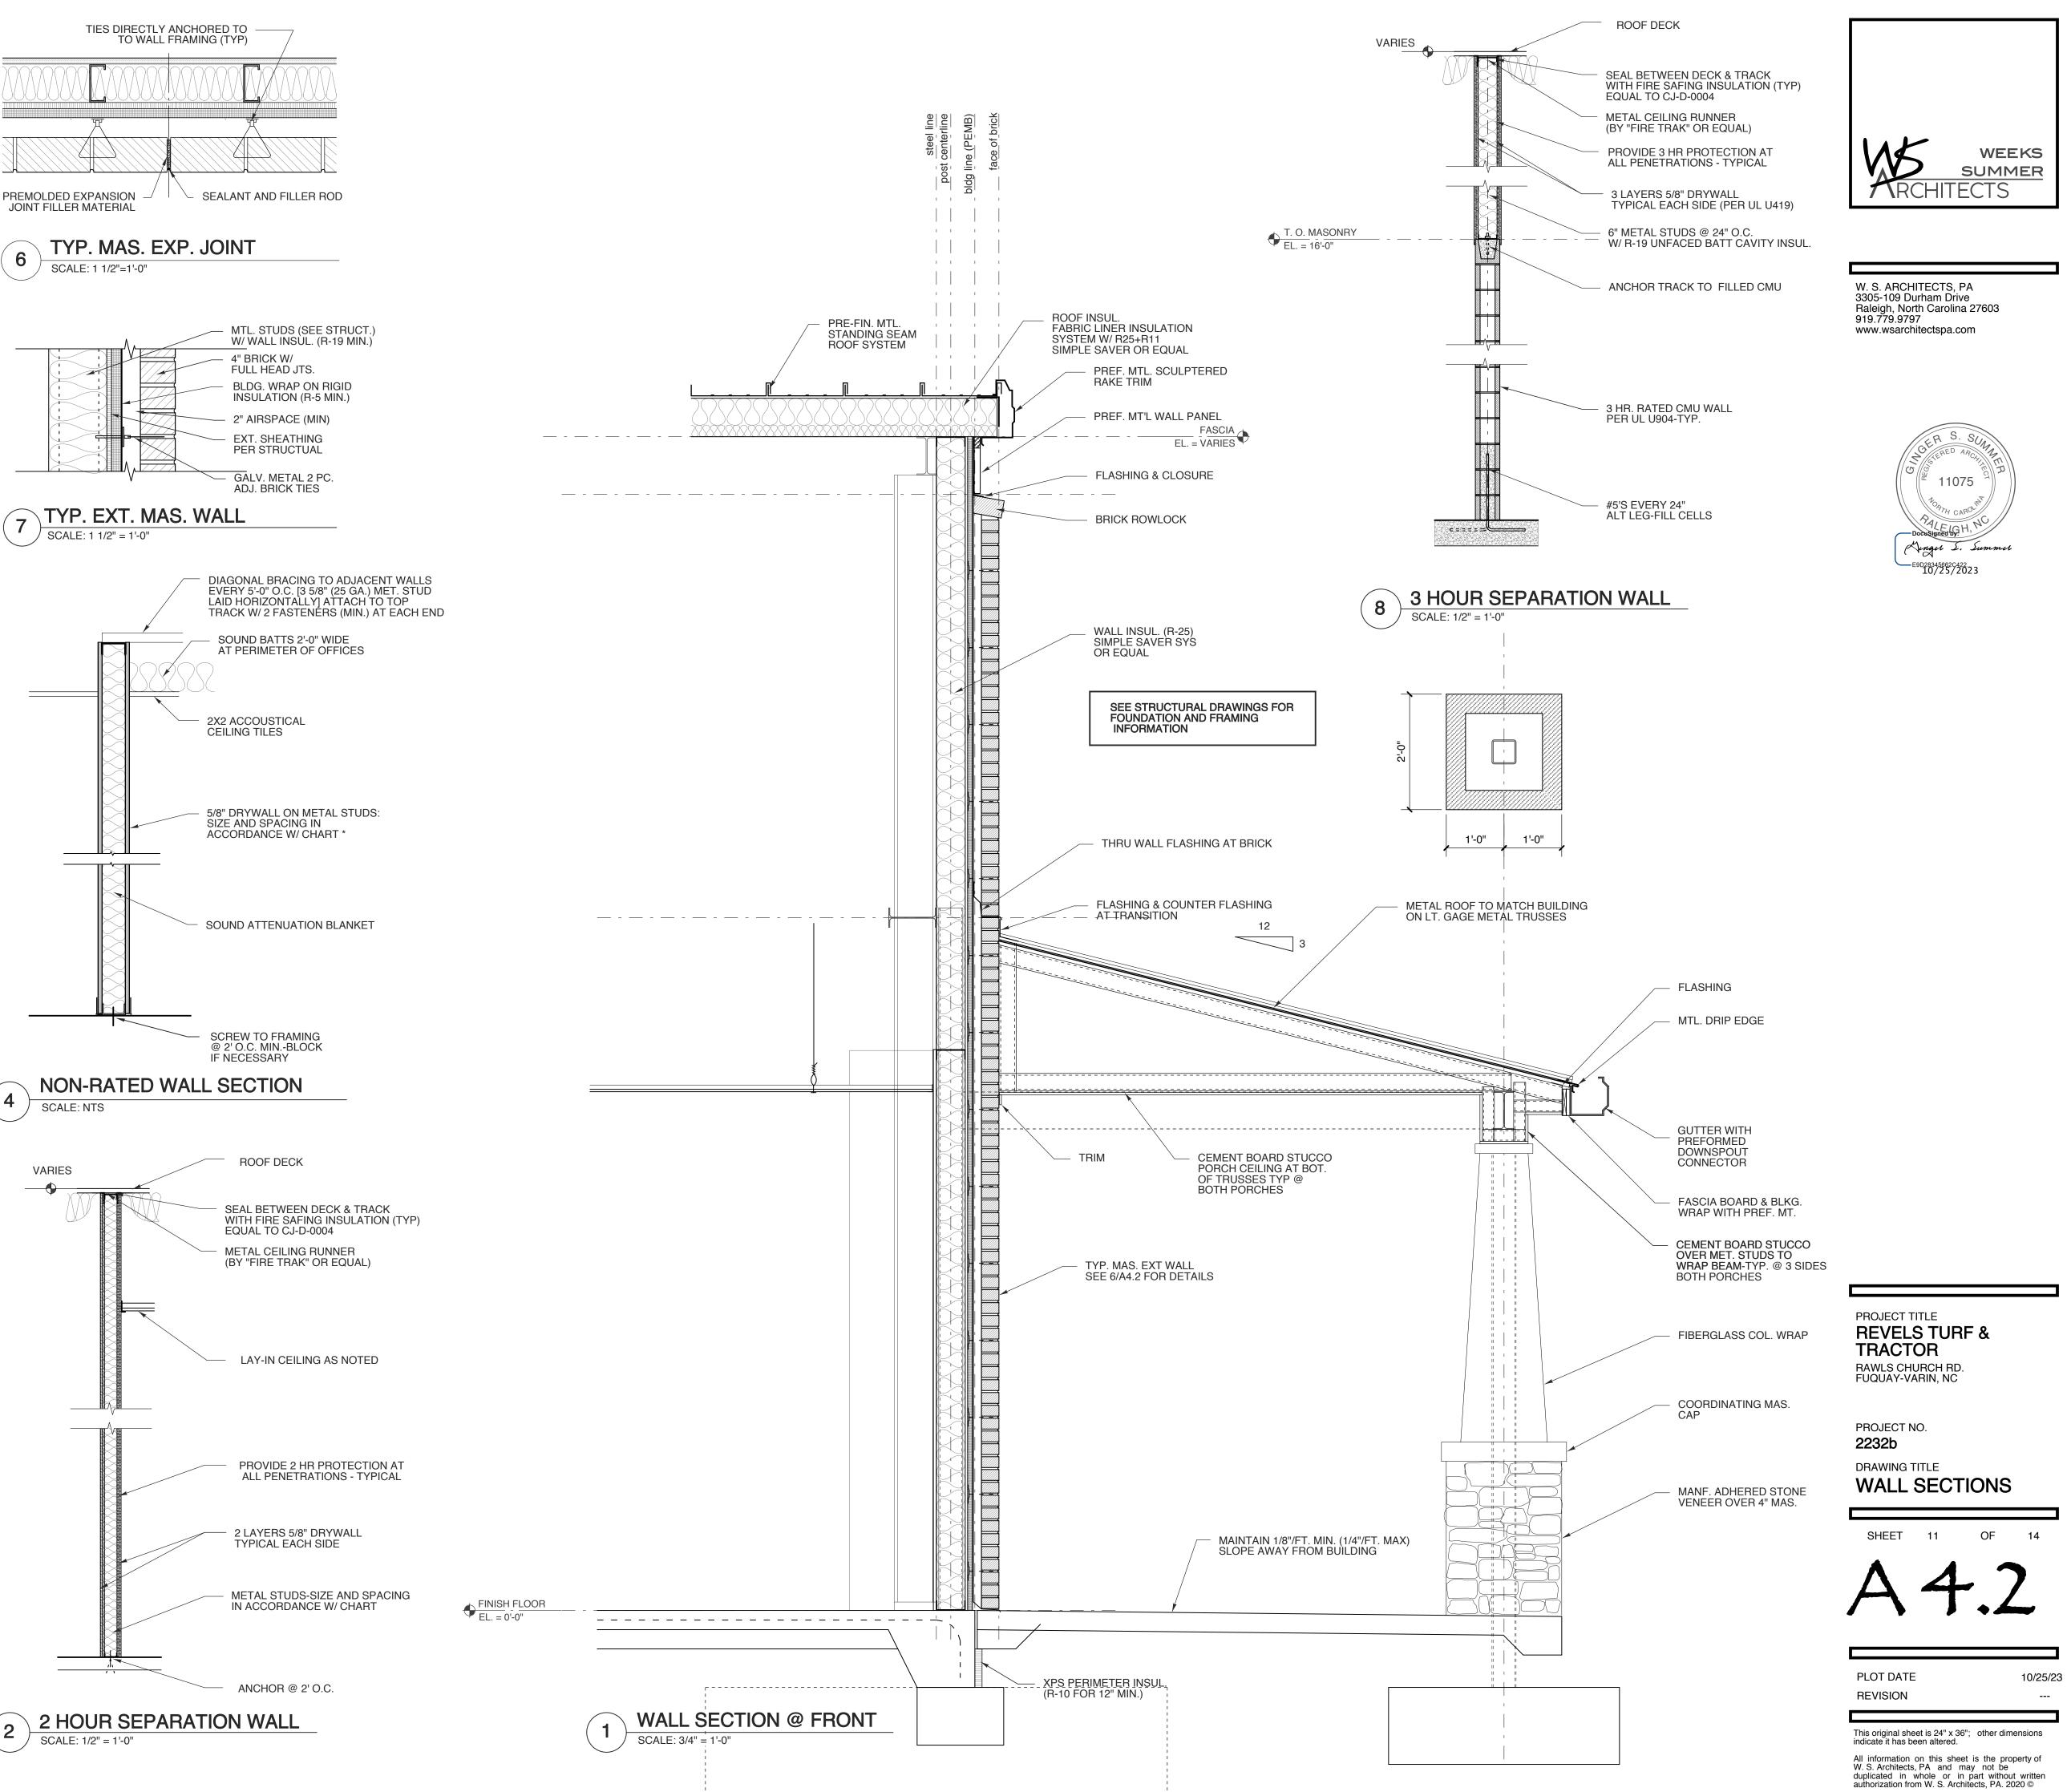

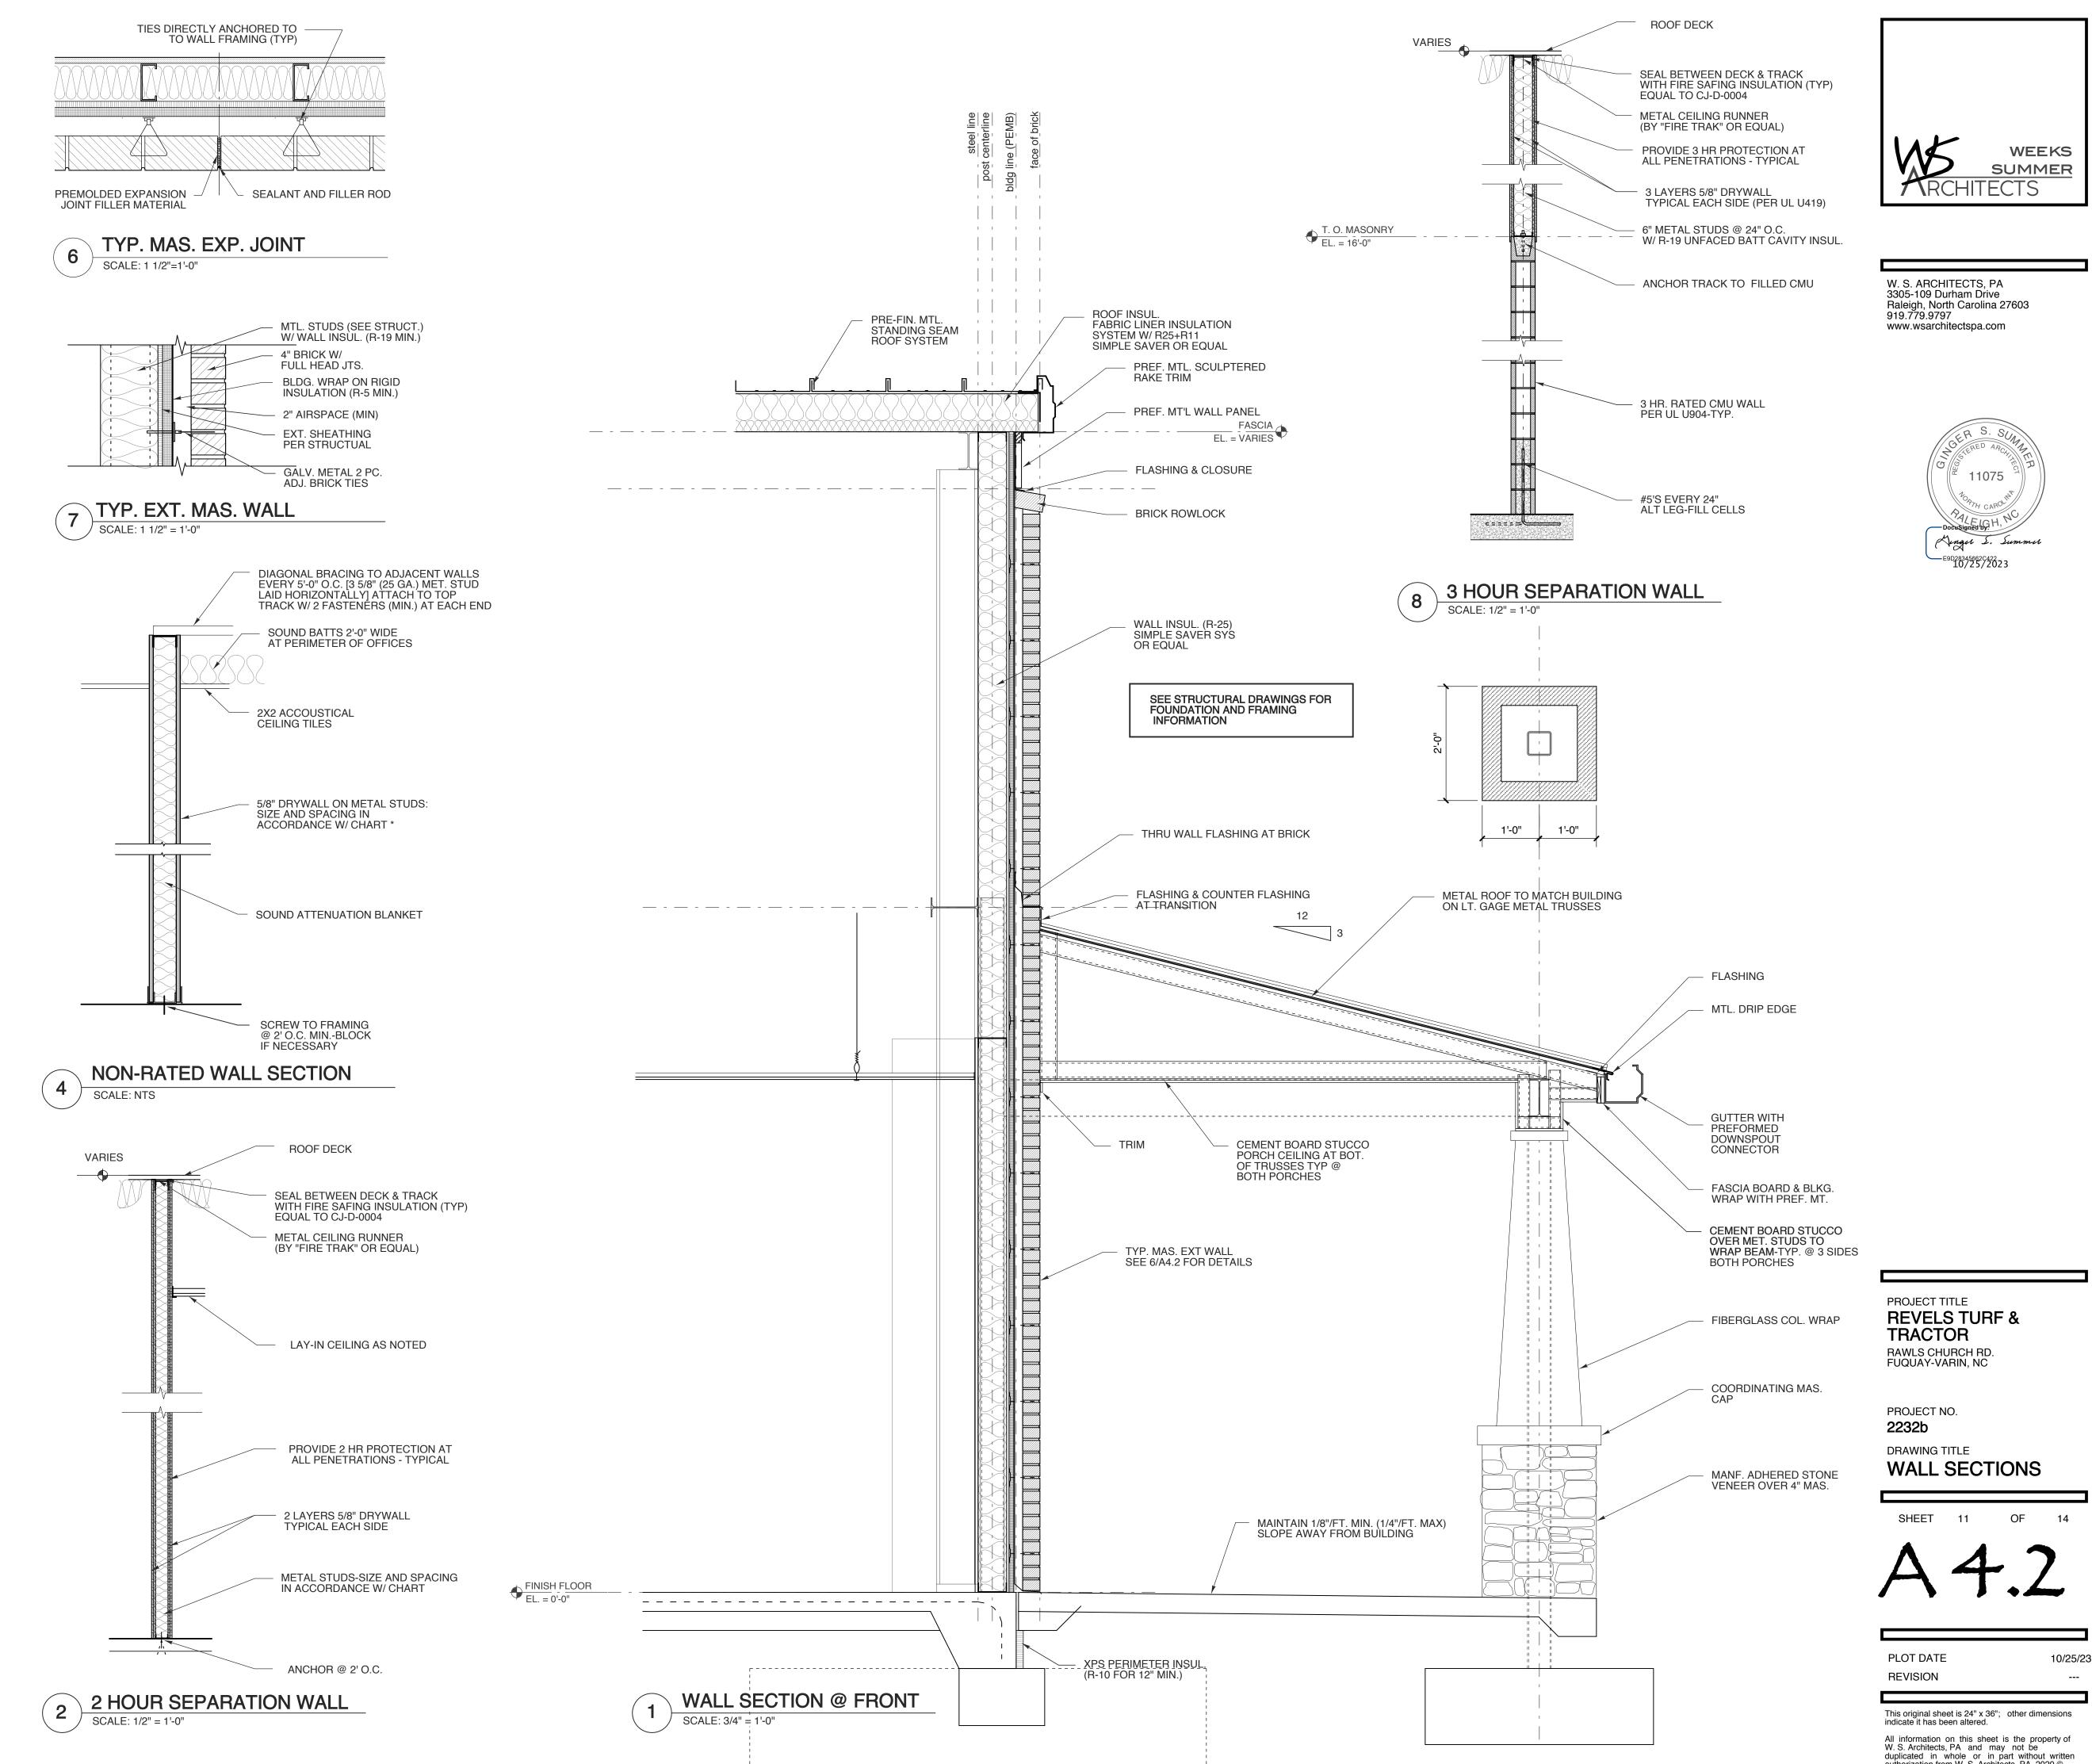

L_____

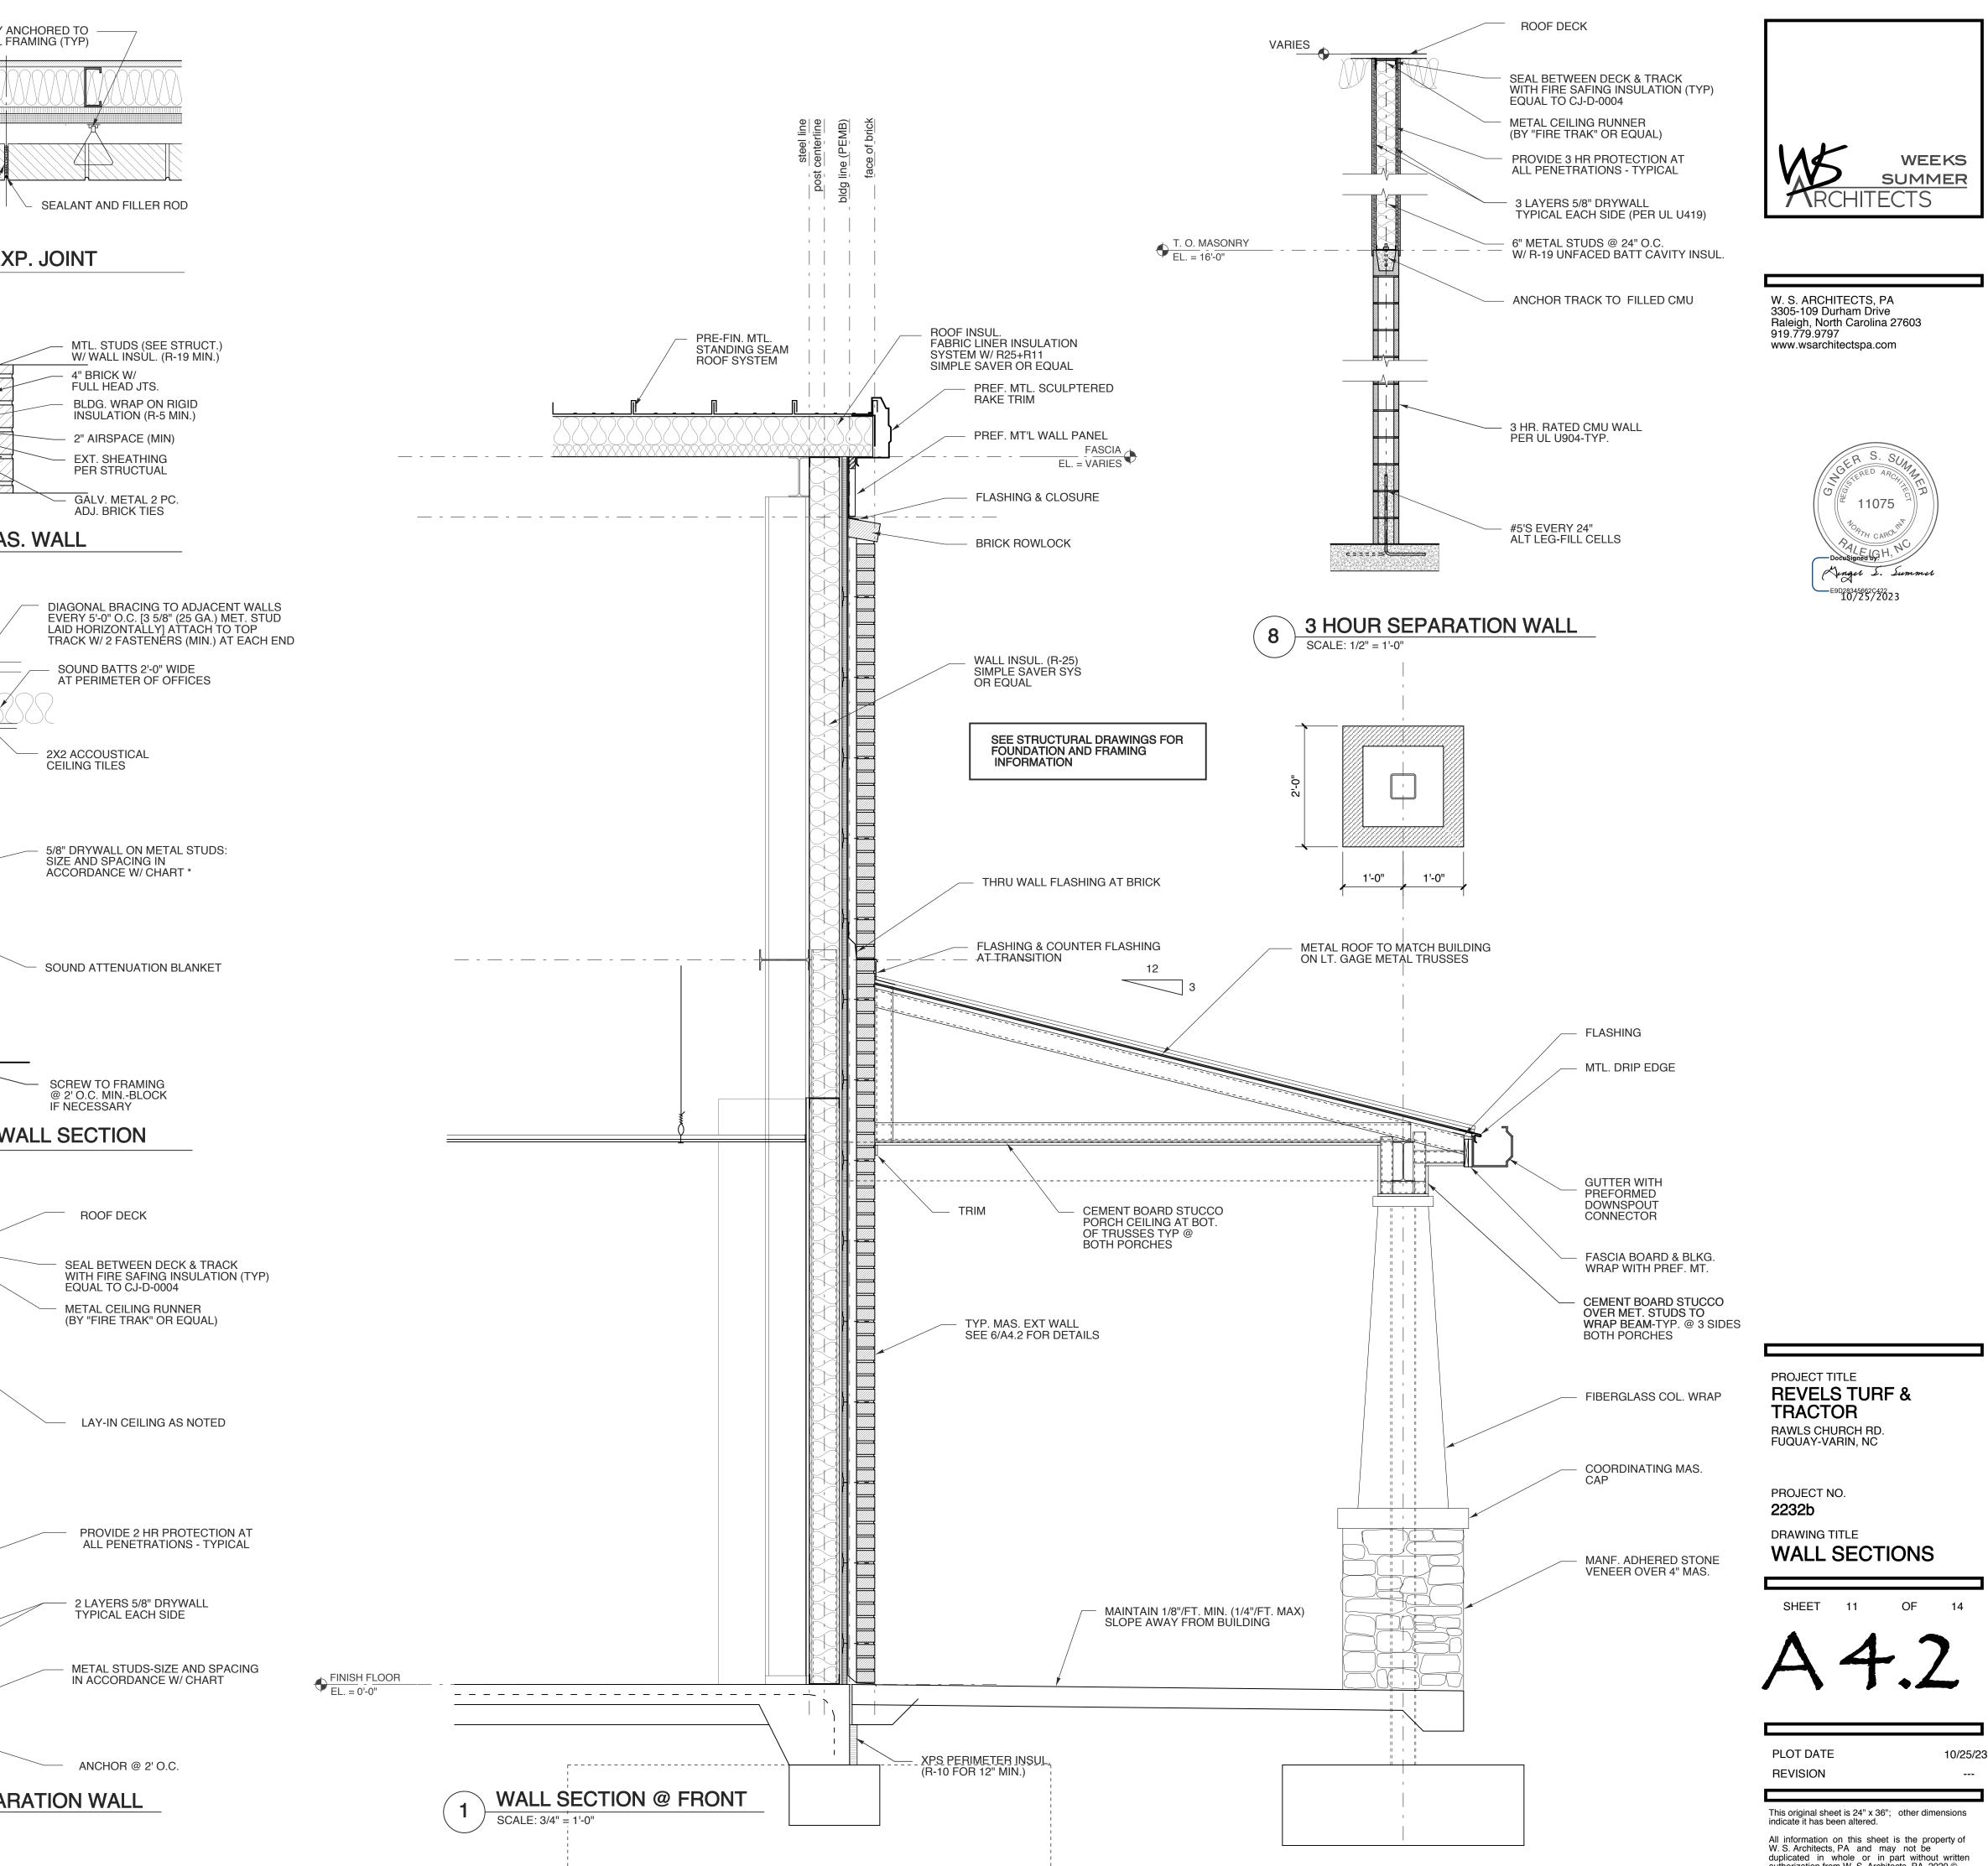

					ILE		1			
MARK	DOOR	MAT'L	TYPE	FR/ TYPE	AME DETAILS	HDWR	REMARKS			
	3'-0" x 7'-0" x 1-3/4"	SC WD	D	C		SET NO.				
(34)	3'-0" x 7'-0" x 1-3/4"	SC WD	D	С						
(35)	3'-0" x 7'-0" x 1-3/4"	SC WD	G	E			90 MIN. RATED			
(36)	3'-0" x 7'-0" x 1-3/4"	SC WD	С	С						
(37)	3'-0" x 7'-0" x 1-3/4"	SC WD	J	С						
(38)	3'-0" x 7'-0" x 1-3/4"	SC WD	F	С						
39	3'-0" x 7'-0" x 1-3/4"	SC WD	С	С						
(40)	3'-0" x 7'-0" x 1-3/4"	SC WD C		С						
(41)	3'-0" x 7'-0" x 1-3/4"	SC WD	C D	C C						
(42)	3'-0" x 7'-0" x 1-3/4"	SC WD								
(43)	3'-0" x 7'-0" x 1-3/4"	SC WD	D	С						
(44)	3'-0" x 7'-0" x 1-3/4"	SC WD	С	С						
(45)	3'-0" x 7'-0" x 1-3/4"	SC WD	D	С						
(46)	3'-0" x 7'-0" x 1-3/4"	SC WD	D	С						
(47)	3'-0" x 7'-0" x 1-3/4"	SC WD	D	С						
(48)	3'-0" x 7'-0" x 1-3/4"	SC WD	D	С						
(49)	3'-0" x 7'-0" x 1-3/4"	SC WD	D	С						
50	3'-0" x 7'-0" x 1-3/4"	SC WD	D	С						
(51)	3'-0" x 7'-0" x 1-3/4"	SC WD	D	С						
52	3'-0" x 7'-0" x 1-3/4"	SC WD	D	С						
53	3'-0" x 7'-0" x 1-3/4"	SC WD	D	С						
(54)	3'-0" x 7'-0" x 1-3/4"	SC WD	С	С						
(55)	3'-0" x 7'-0" x 1-3/4"	SC WD	С	С						
(56)	3'-0" x 7'-0" x 1-3/4"	SC WD	С	С						
57	3'-0" x 7'-0" x 1-3/4"	SC WD	С	С						
58	3'-0" x 7'-0" x 1-3/4"	SC WD	J	С						
(59)	3'-0" x 7'-0" x 1-3/4"	SC WD	С	С						
60	3'-0" x 7'-0" x 1-3/4"	SC WD	С	С						
61	3'-0" x 7'-0" x 1-3/4"	SC WD	С	С						
62	3'-0" x 7'-0" x 1-3/4"	SC WD	D	С						
63	3'-0" x 7'-0" x 1-3/4"	SC WD	D	С						
64	3'-0" x 7'-0" x 1-3/4"	SC WD	D	С						
65	3'-0" x 7'-0" x 1-3/4"	SC WD	D	С						
66	3'-0" x 7'-0" x 1-3/4"	SC WD	D	С						
67	3'-0" x 7'-0" x 1-3/4"	SC WD	G	Е			90 MIN. RATED			
68	2-3'-0" x 7'-0" x 1-3/4"	HM	E	E			90 MIN. RATED			
69	10'-0" x 10'-0"	MTL	н	D			90 MIN. RATED, COILING			
70	3'-0" x 7'-0" x 1-3/4"	НМ	E	E			90 MIN. RATED			
(71)	3'-0" x 7'-0" x 1-3/4"	HM	к	С						

NOTES:

- COORDINATE KEYING OF HARDWARE WITH OWNER

- ALL DOORS TO MEET NCSBC SECTION 1609.1.2 - DOOR HANDLES TO BE SCHLAGE ND-SERIES, TRIM-TBD,

FINISH-SATIN NICKEL - DOOR HINGES TO BE IVES 5BB1/HW OR APPROVED EQUAL

- DOOR CLOSERS TO BE LCN 4040 SERIES OR EQUAL

- PANIC HARDWARE TO BE VON DUPRIN 35 A SERIES - DOOR SLABS TO BE PREFINISHED CLEAR WHITE BIRCH

- PUSH/PULL HARWARE & KICK PLATE FINISHES TO MATCH HANDLESETS

- RATED FRAMES TO BE TGP FIREFRAMES OR APPROVED EQUAL


HARDWARE SETS

1. PANIC HARDWARE WITH CLOSER


2. PUSH / PULL SET WITH CLOSER STOREROOM FUNCTION LOCKSET З.

- 4. STOREROOM FUNCTION LOCKSET WITH CLOSER
- PRIVACY SET 5.
- PASSAGE SET 6.
- PRIVACY SET W/ CLOSER 7. PRIVACY SET W/ CLOSER, INTEGRATED 8.

ASTRAGAL & FLUSH BOLTS

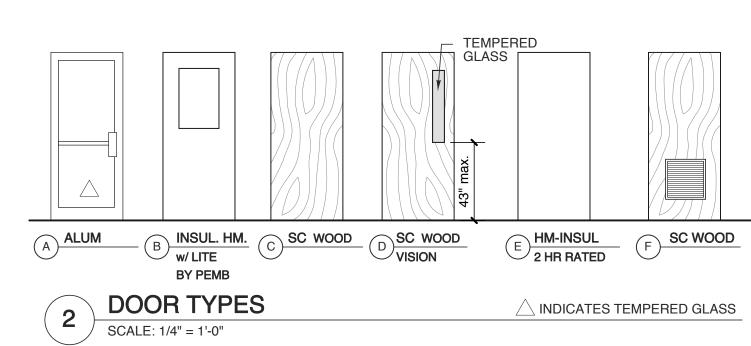

DOOR SCHEDULE							ROOM FINISH SCHEDULE								
IARK	DOOF	1	TYPE		AME DETAILS	HDWR SET NO.	REMARKS	MARK	ROOM NAME	FLOOR	BASE	WALL N E S W	WAINSCOT -	CEIL	LING HGT.
)	2- 3'-0" x 7'-0" x 1-3/4"	ALUM	A	A				100	PORCH	CONCRETE					
	3'-0" x 7'-0" x 1-3/4"	INSUL HM	В	В				101	LOBBY	WALK OFF CARPET TILE	RUBBER	PT. DW.		ACT	9'/10'
	3'-0" x 7'-0" x 1-3/4"	INSUL HM	В	В				102	SALES OFFICE	LVT	RUBBER	PT. DW.		ACT	9'-0"
T	12'-0" x 10'-0"	INSUL MTL.	н	D			INSUL. SECTIONAL OVERHEAD	103	SALES ADMIN	LVT	RUBBER	PT. DW.		ACT	9'-0"
	3'-0" x 7'-0" x 1-3/4"	INSUL HM	В	В				104	CFO	LVT	RUBBER	PT. DW.		ACT	9'-0"
	12'-0" x 12'-0"	INSUL MTL.	н	D			INSUL. SECTIONAL OVERHEAD	105	ACC	LVT	RUBBER	PT. DW.		ACT	9'-0"
)	12'-0" x 12'-0"	INSUL MTL.	н	D			INSUL. SECTIONAL OVERHEAD		ACC	LVT	RUBBER	PT. DW.		ACT	9'-0"
)	12'-0" x 12'-0"	INSUL MTL.	н	D			INSUL. SECTIONAL OVERHEAD		HR	LVT	RUBBER	PT. DW.		ACT	9'-0"
)	12'-0" x 12'-0"	INSUL MTL.	н	D			INSUL. SECTIONAL OVERHEAD		CEO	LVT	RUBBER	PT. DW.		ACT	9'-0"
+	12'-0" x 12'-0"	INSUL MTL.	н	D			INSUL. SECTIONAL OVERHEAD	109	C00	LVT	RUBBER	PT. DW.		ACT	9'-0"
	12'-0" x 12'-0"	INSUL MTL.	н	D			INSUL. SECTIONAL OVERHEAD		INV. TRUCKING	LVT	RUBBER	PT. DW.		ACT	9'-0"
+	3'-0" x 7'-0" x 1-3/4"	INSUL HM	В	В											
+	10'-0" x 12'-0"	INSUL MTL.	н	D			INSUL. SECTIONAL OVERHEAD			LVT		PT. DW.		ACT	9'-0"
+								112			RUBBER	PT. DW.		ACT	9'-0"
╞	3'-0" x 7'-0" x 1-3/4"	INSUL HM		B				113		LVT	RUBBER	PT. DW.		ACT	10'-0"
$\left \right $	14'-0" x 16'-0"	INSUL MTL.	H	D			INSUL. SECTIONAL OVERHEAD		IT CLOSET	LVT	RUBBER	PT. DW.		ACT	9'-0"
	12'-0" x 12'-0"	INSUL MTL.	Н	D			INSUL. SECTIONAL OVERHEAD	115	RESTROOM	LVT	RUBBER	PT. DW.		ACT	9'-0"
	12'-0" x 12'-0"	INSUL MTL.		D			INSUL. SECTIONAL OVERHEAD	116	RESTROOM	LVT	RUBBER	PT. DW.		ACT	9'-0"
	12'-0" x 12'-0"	INSUL MTL.	Н	D			INSUL. SECTIONAL OVERHEAD	117	CONF. ROOM	LVT	RUBBER	PT. DW.		ACT	9'-0"
	12'-0" x 12'-0"	INSUL MTL.	н	D			INSUL. SECTIONAL OVERHEAD	118	SALES	LVT	RUBBER	PT. DW.		ACT	9'-0"
	12'-0" x 12'-0"	INSUL MTL.	н	D			INSUL. SECTIONAL OVERHEAD	119	WAREHOUSE/STORAGE	SEALED CONC.	RUBBER	PT. DW.		ACT	9'-0"
	12'-0" x 12'-0"	INSUL MTL.	н	D			INSUL. SECTIONAL OVERHEAD	120	PARTS CALL CENTER	LVT	RUBBER	PT. DW.		ACT	9'-0"
	3'-0" x 7'-0" x 1-3/4"	INSUL HM	В	В				121	PARTS SERVICE MAN.	LVT	RUBBER	PT. DW.		ACT	9'-0"
	3'-0" x 7'-0" x 1-3/4"	INSUL HM	В	В				122	SPARE OFFICE	LVT	RUBBER	PT. DW.		ACT	9'-0"
	8'-0" x 10'-0"	INSUL MTL.	н	D			INSUL. SECTIONAL OVERHEAD	123	SHIPPING/RECEIVING	SEALED CONC.	RUBBER	PT. DW.			
Τ	3'-0" x 7'-0" x 1-3/4"	SC WD	D	С				124	PARTS STORAGE	SEALED CONC.	RUBBER	PT. DW.			
	3'-0" x 7'-0" x 1-3/4"	SC WD	D	С				125	STORAGE	LVT	RUBBER	PT. DW.		ACT	9'-0"
	3'-0" x 7'-0" x 1-3/4"	SC WD	D	С				126	RESTROOM	LVT	RUBBER	PT. DW.		ACT	9'-0"
t	3'-0" x 7'-0" x 1-3/4"	SC WD	D	С				127	BREAK ROOM	LVT	RUBBER	PT. DW.		ACT	10'-0"
	3'-0" x 7'-0" x 1-3/4"	SC WD	D	С				128	WORK OUT ROOM	LVT	RUBBER	PT. DW.		ACT	10'-0"
-	3'-0" x 7'-0" x 1-3/4"	SC WD	D	С				129	RECON OFFICE	LVT	RUBBER	PT. DW.		ACT	9'-0"
	3'-0" x 7'-0" x 1-3/4"	SC WD	D	С				130	RESTROOM	LVT	RUBBER	PT. DW.		ACT	9'-0"
$\left \right $	3'-0" x 7'-0" x 1-3/4"	SC WD	D	С				131	RESTROOM	LVT	RUBBER	PT. DW.		ACT	9'-0"
		1		1	1		1	132	RESTROOM	LVT	RUBBER	PT. DW.		ACT	9'-0"
-									RESTROOM	LVT	RUBBER	PT. DW.		ACT	9'-0"
								134	RESTROOM	LVT	RUBBER	PT. DW.		ACT	9'-0"
								135	SPARE OFFICE	LVT	RUBBER	PT. DW.		ACT	9'-0"
	54" x 60"	CLR —	 					135	SERVICE OFFICE	LVT	RUBBER	PT. DW.		ACT	9'-0"
	FLOOR A	HEA							SERVICE OFFICE	LVT	RUBBER	PT. DW.		ACT	9'-0"
								137	SERVICE ADMIN.						
	401	_	 					138			RUBBER	PT. DW.		ACT	9'-0"
	48" x 4 FLOOF	8" CLR						139		LVT	RUBBER	PT. DW.		ACT	9'-0"
			~					140	SERVICE CALL CENTER	LVT SEALED	RUBBER	PT. DW. PT. DW/CMU@	 8' LINER	ACT	9'-0"
		<u> </u>	/P	DOOR I				141	SERVICE SHOP AREA	CONC.	RUBBER	ADJ. WALLS	PANELS		
				DOOR I /4"= 1'-0"				142	GRINDING ROOM	SEALED CONC.	RUBBER	PT. CMU	8' LINER PANELS		
								143	TOOL STORAGE	SEALED CONC.	RUBBER	PT. DW.	8' LINER PANELS		
								CON	FIRM FINISHES WITH OWN	ER					

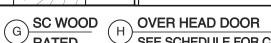


 SC WOOD
 SC WOOD
 OVER HEAD DOOR


 G
 RATED
 H
 SEE SCHEDULE FOR COILING, SECTIONAL, RATING & INSUL

J SC WOOD VISION

K HM-INSUL

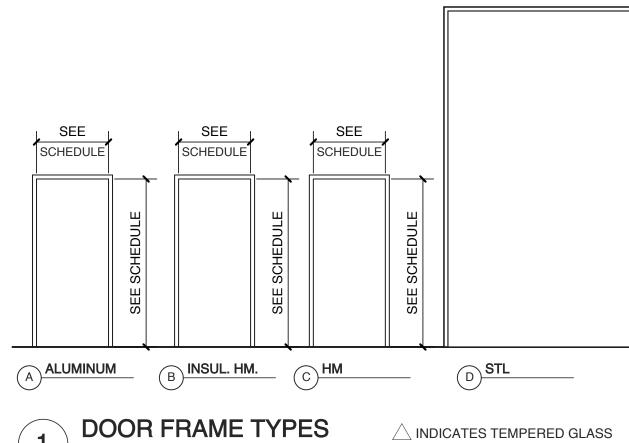

SCALE: 1/4" = 1'-0"

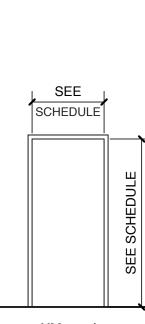

E HM-rated


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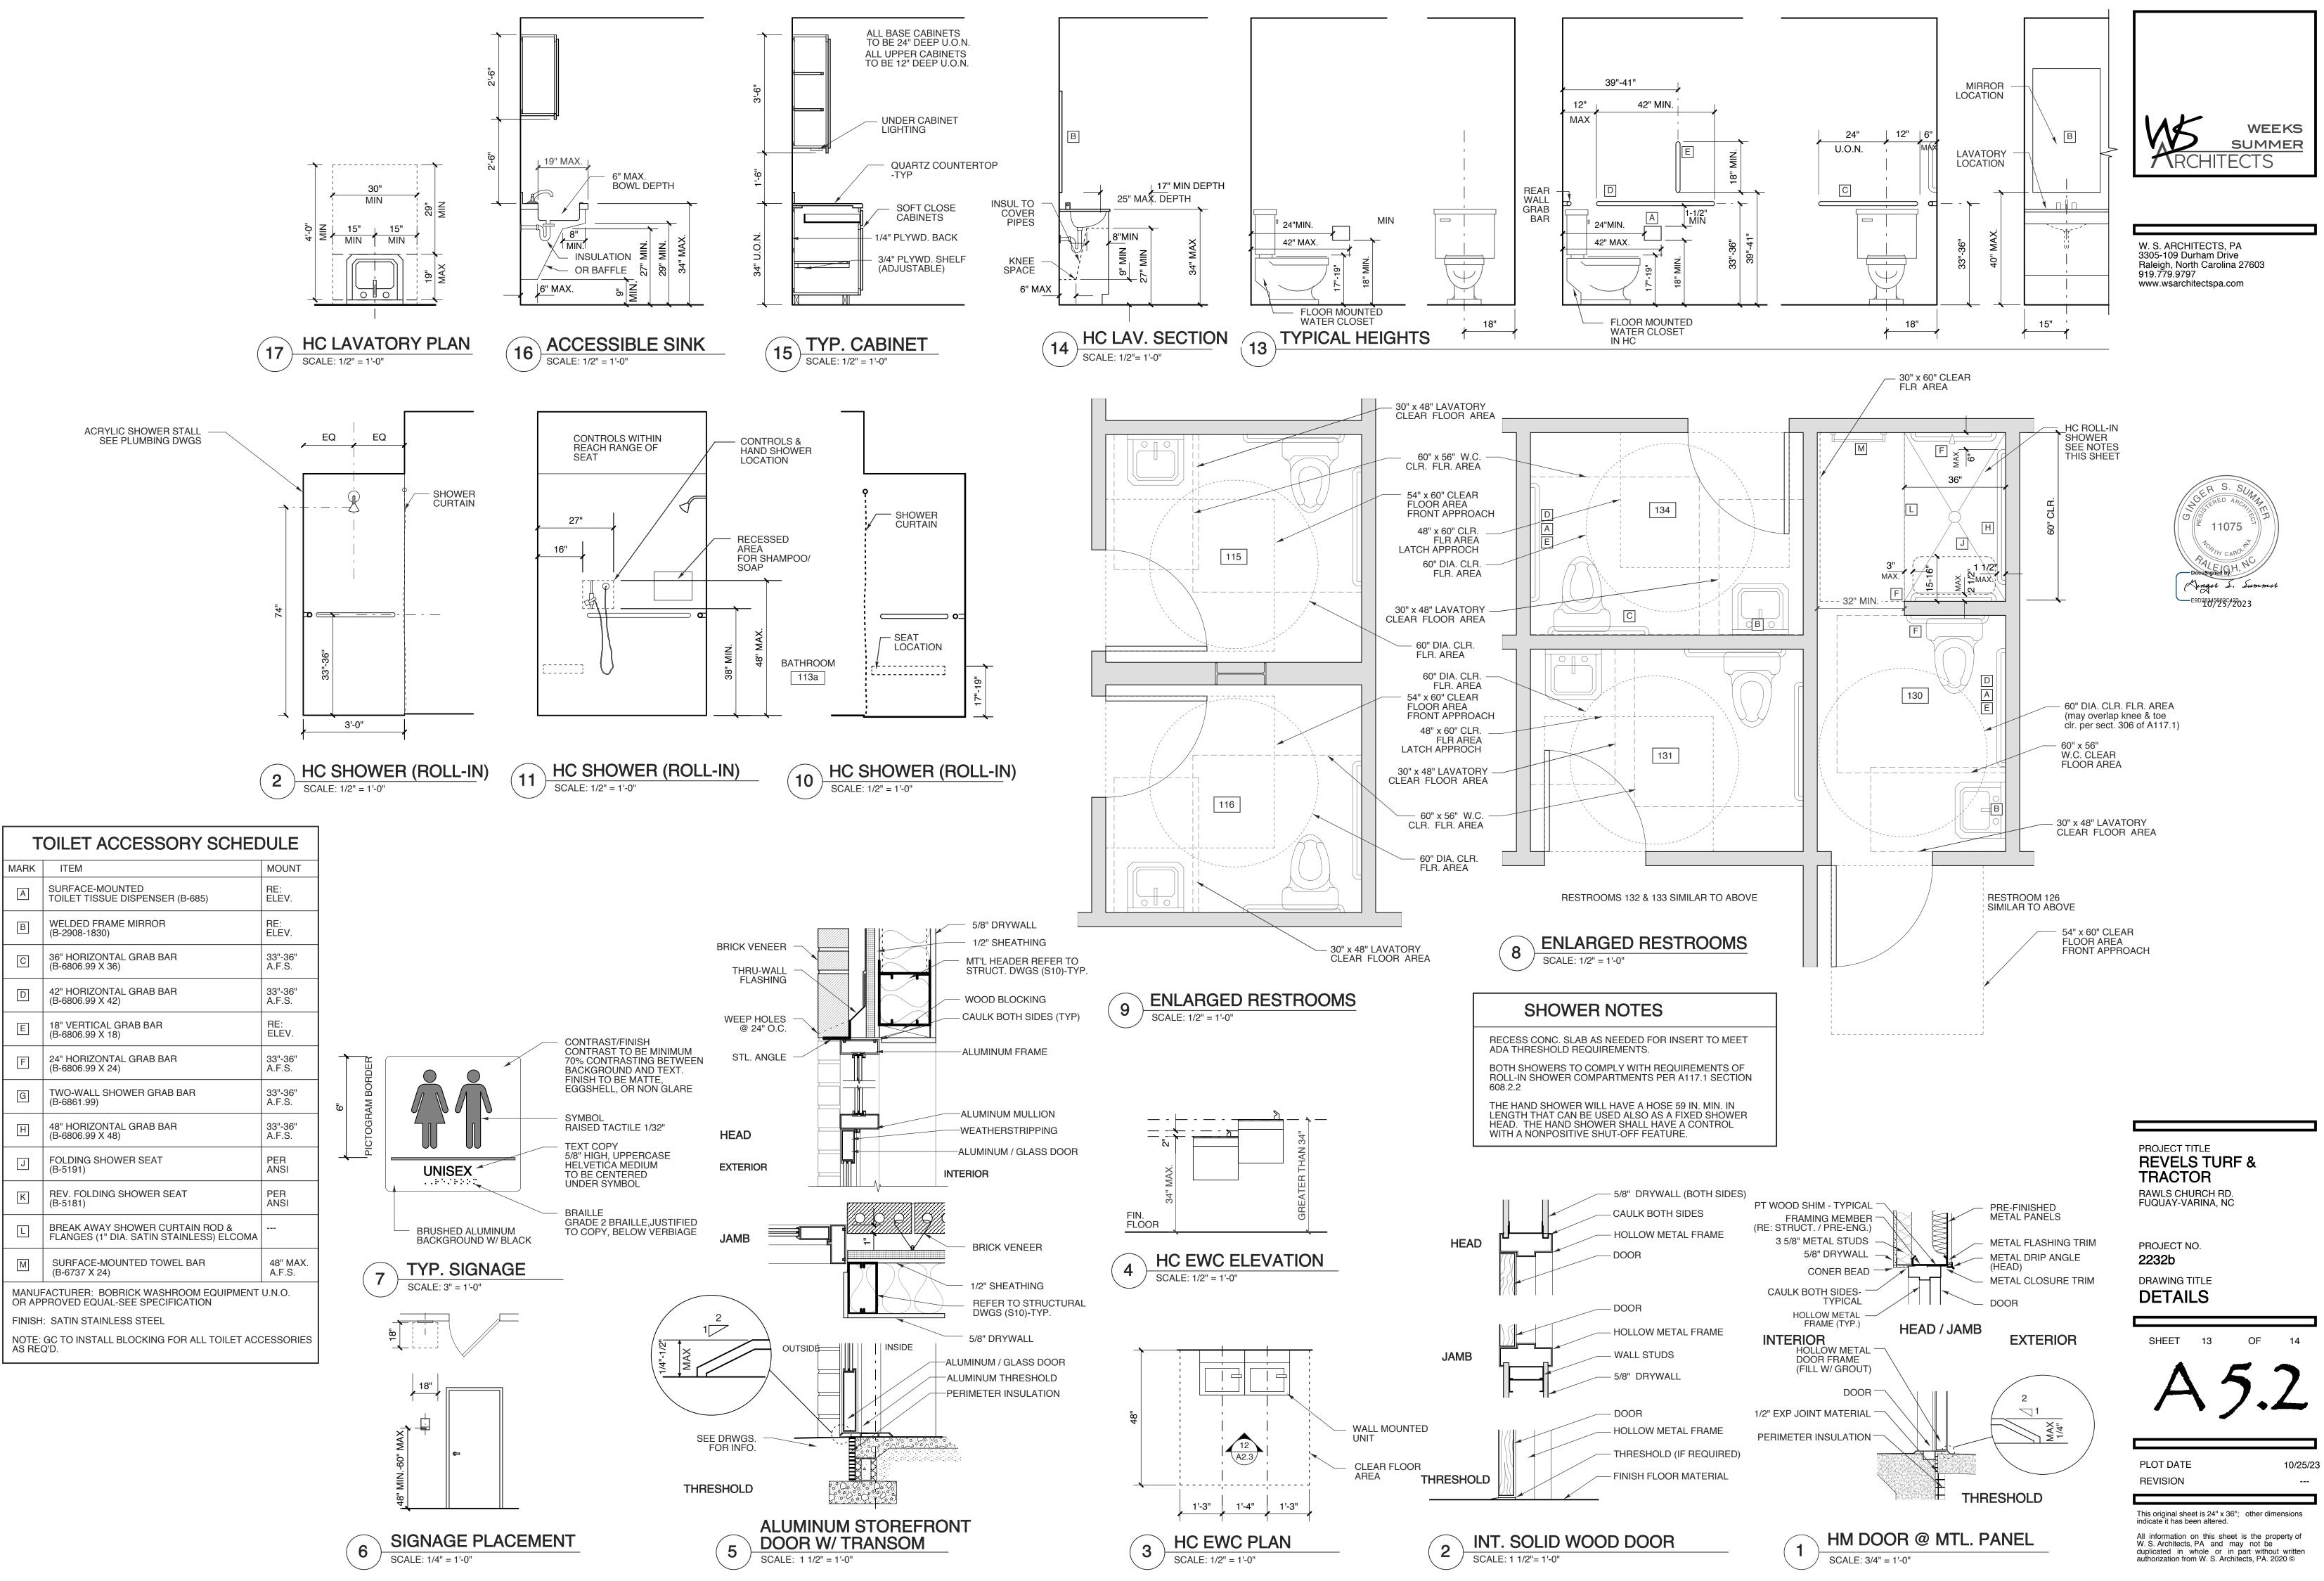
PROJECT TITLE **REVELS TURF &** TRACTOR RAWLS CHURCH RD. FUQUAY-VARINA, NC


PROJECT NO. 2232b DRAWING TITLE SCHEDULES




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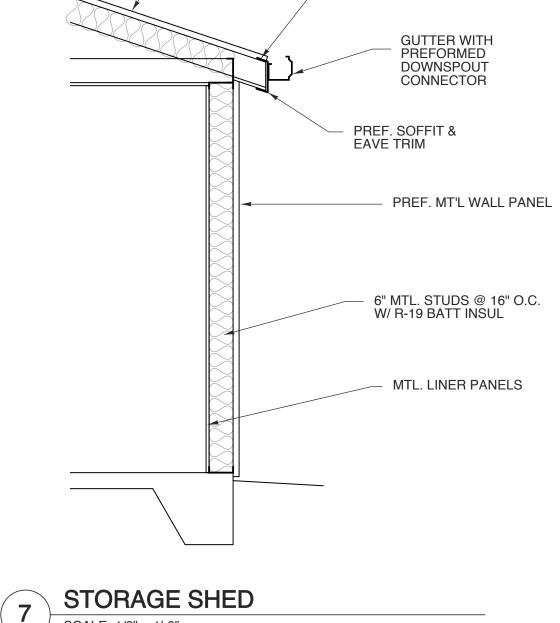
 \triangle INDICATES TEMPERED GLASS



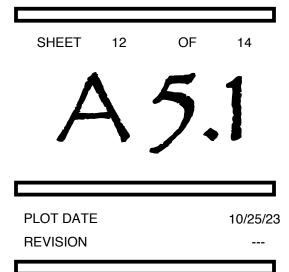

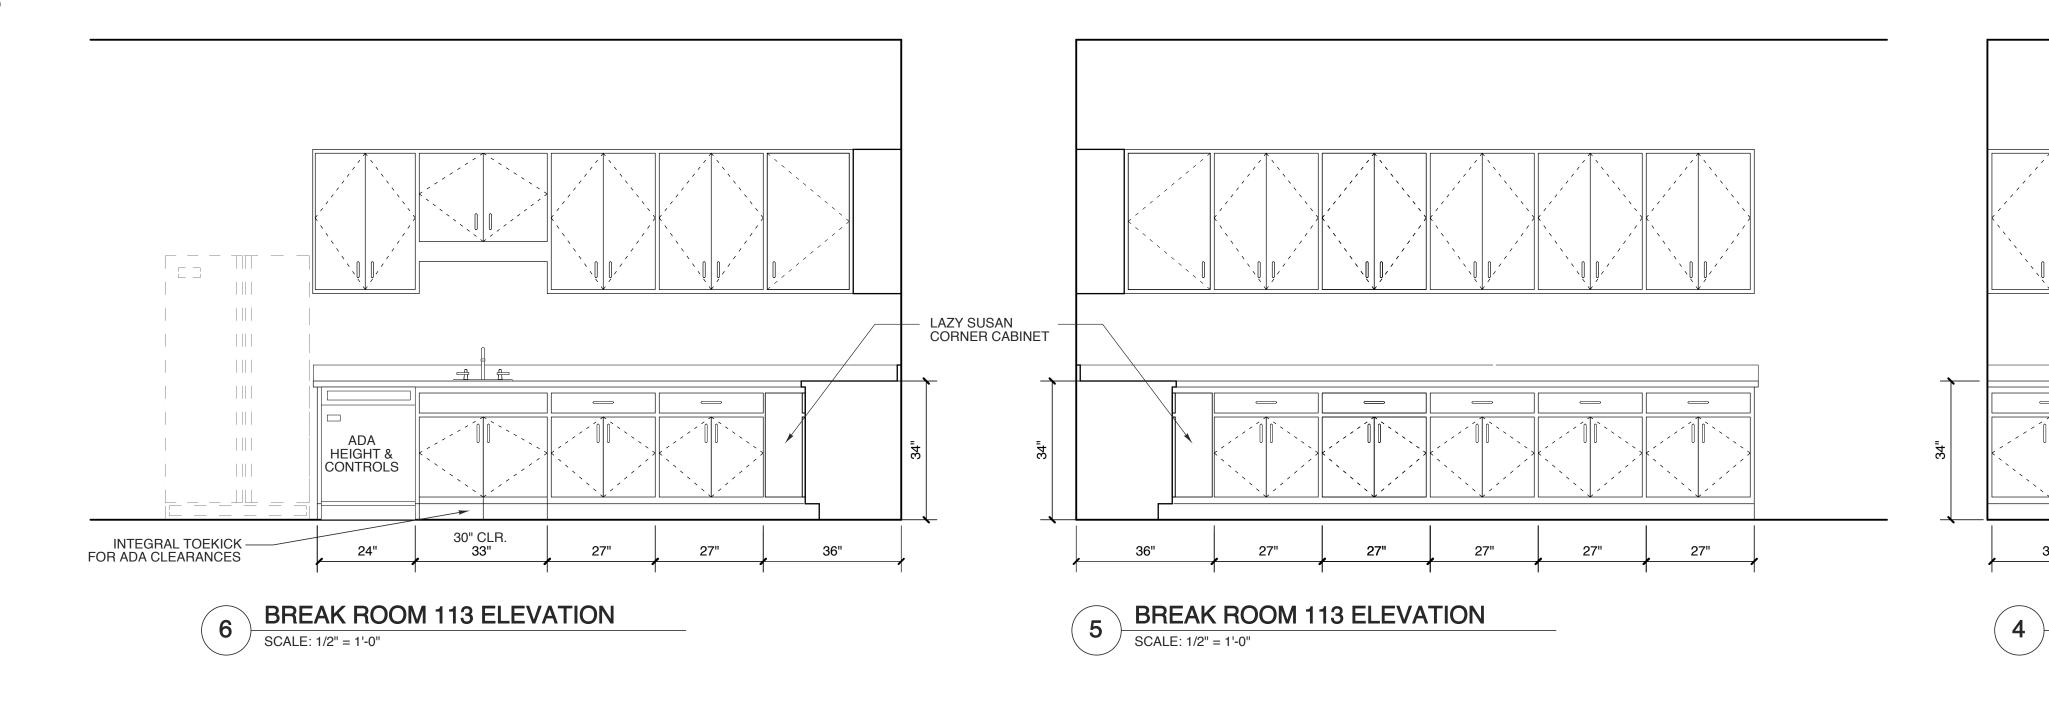


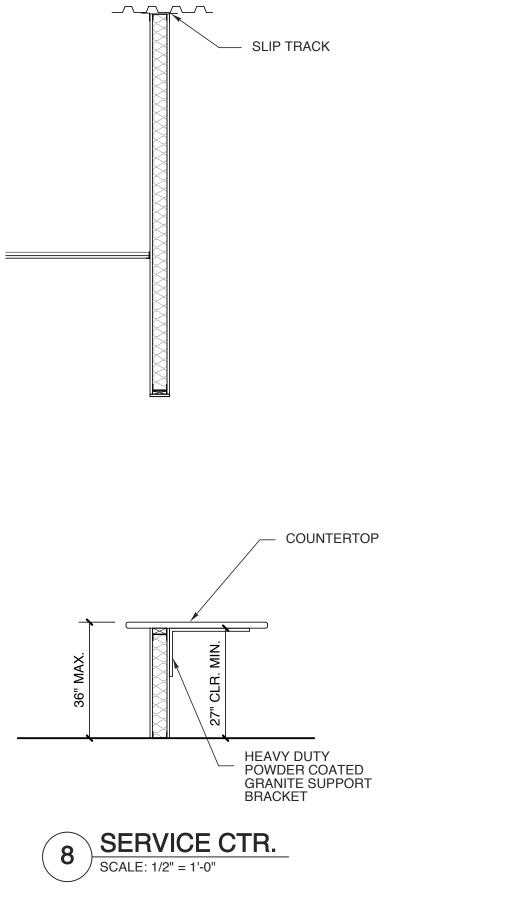




PRE-FIN. MTL. STANDING SEAM ROOF SYSTEM ON LT GAGE MTL FRMING W/ R-19 BATT INSUL


EAVE CLOSURE

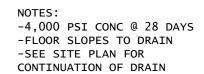





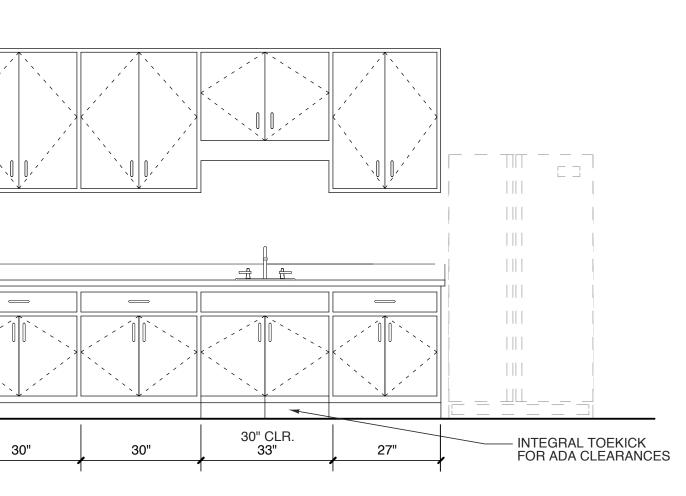


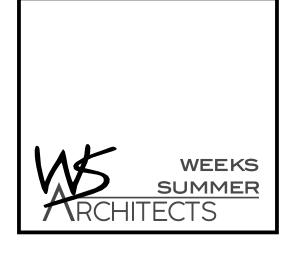


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BREAK ROOM 127 ELEVATION

) SCALE: 1/2" = 1'-0"




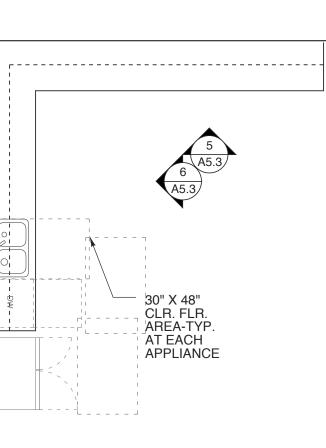

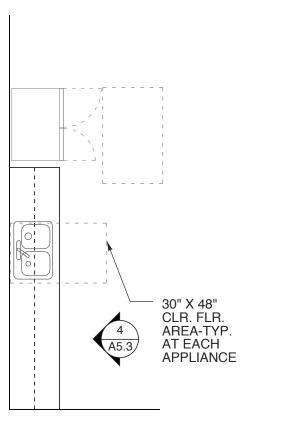2 BREAK ROOM-127 SCALE: 1/4" = 1'-0"



BREAK ROOM-113 SCALE: 1/4" = 1'-0"

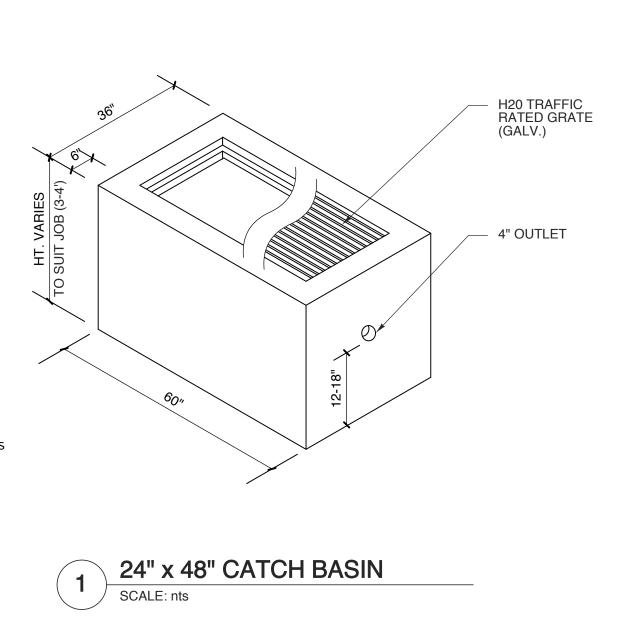

PROJECT TITLE REVELS TU TRACTOR RAWLS CHURCH F FUQUAY-VARINA,	RD.	
PROJECT NO. 2232b DRAWING TITLE DETAILS		
SHEET 14	OF	14
A	5.	5
PLOT DATE REVISION		10/25/23
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