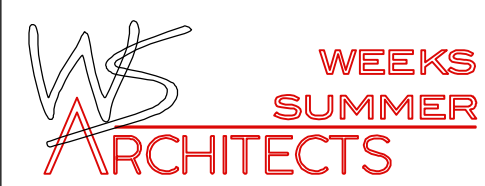


SERVICE SHOP SLAB NOTES
 8" SLAB ON GRADE (4,000 PSI CONCRETE)
 REINFORCED WITH #4 BARS AT 12" E.W.
 (2" CLR. FROM T/SLAB) ON 10 MIL.
 POLYETHYLENE VAPOR BARRIER ON 4"
 COMPACTED ABC STONE.
 FINISHED FLOOR ELEVATION 0'-0".

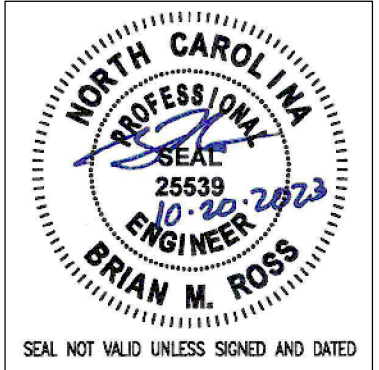
MARK	SIZE			REINFORCEMENT	
	N-S	E-W	THK.	N-S	E-W
A	4'-0"	4'-0"	1'-4"	#5 AT 12"	#5 AT 12"
B	5'-0"	5'-0"	1'-4"	#5 AT 12"	#5 AT 12"
C	8'-0"	8'-0"	2'-0"	#6 AT 12"	#6 AT 12"
D	8'-6"	8'-6"	2'-0"	#6 AT 12"	#6 AT 12"
E	9'-0"	9'-0"	2'-0"	#6 AT 12"	#6 AT 12"

1 PARTIAL SLAB AND FOUNDATION PLAN
 S1.1 1/8" = 1'-0"



W.S. ARCHITECTS, PA
 3305-109 Durham Drive
 Raleigh, North Carolina 27603
 919.779.8787
 www.wsarchitectspa.com

ROSS LINDEN
 ENGINEERS P C
 709 W. JONES STREET RALEIGH, NC 27603
 TEL 919.832.5680 WWW.ROSSLINDEN.COM
 NC LICENSE NO. C-2364



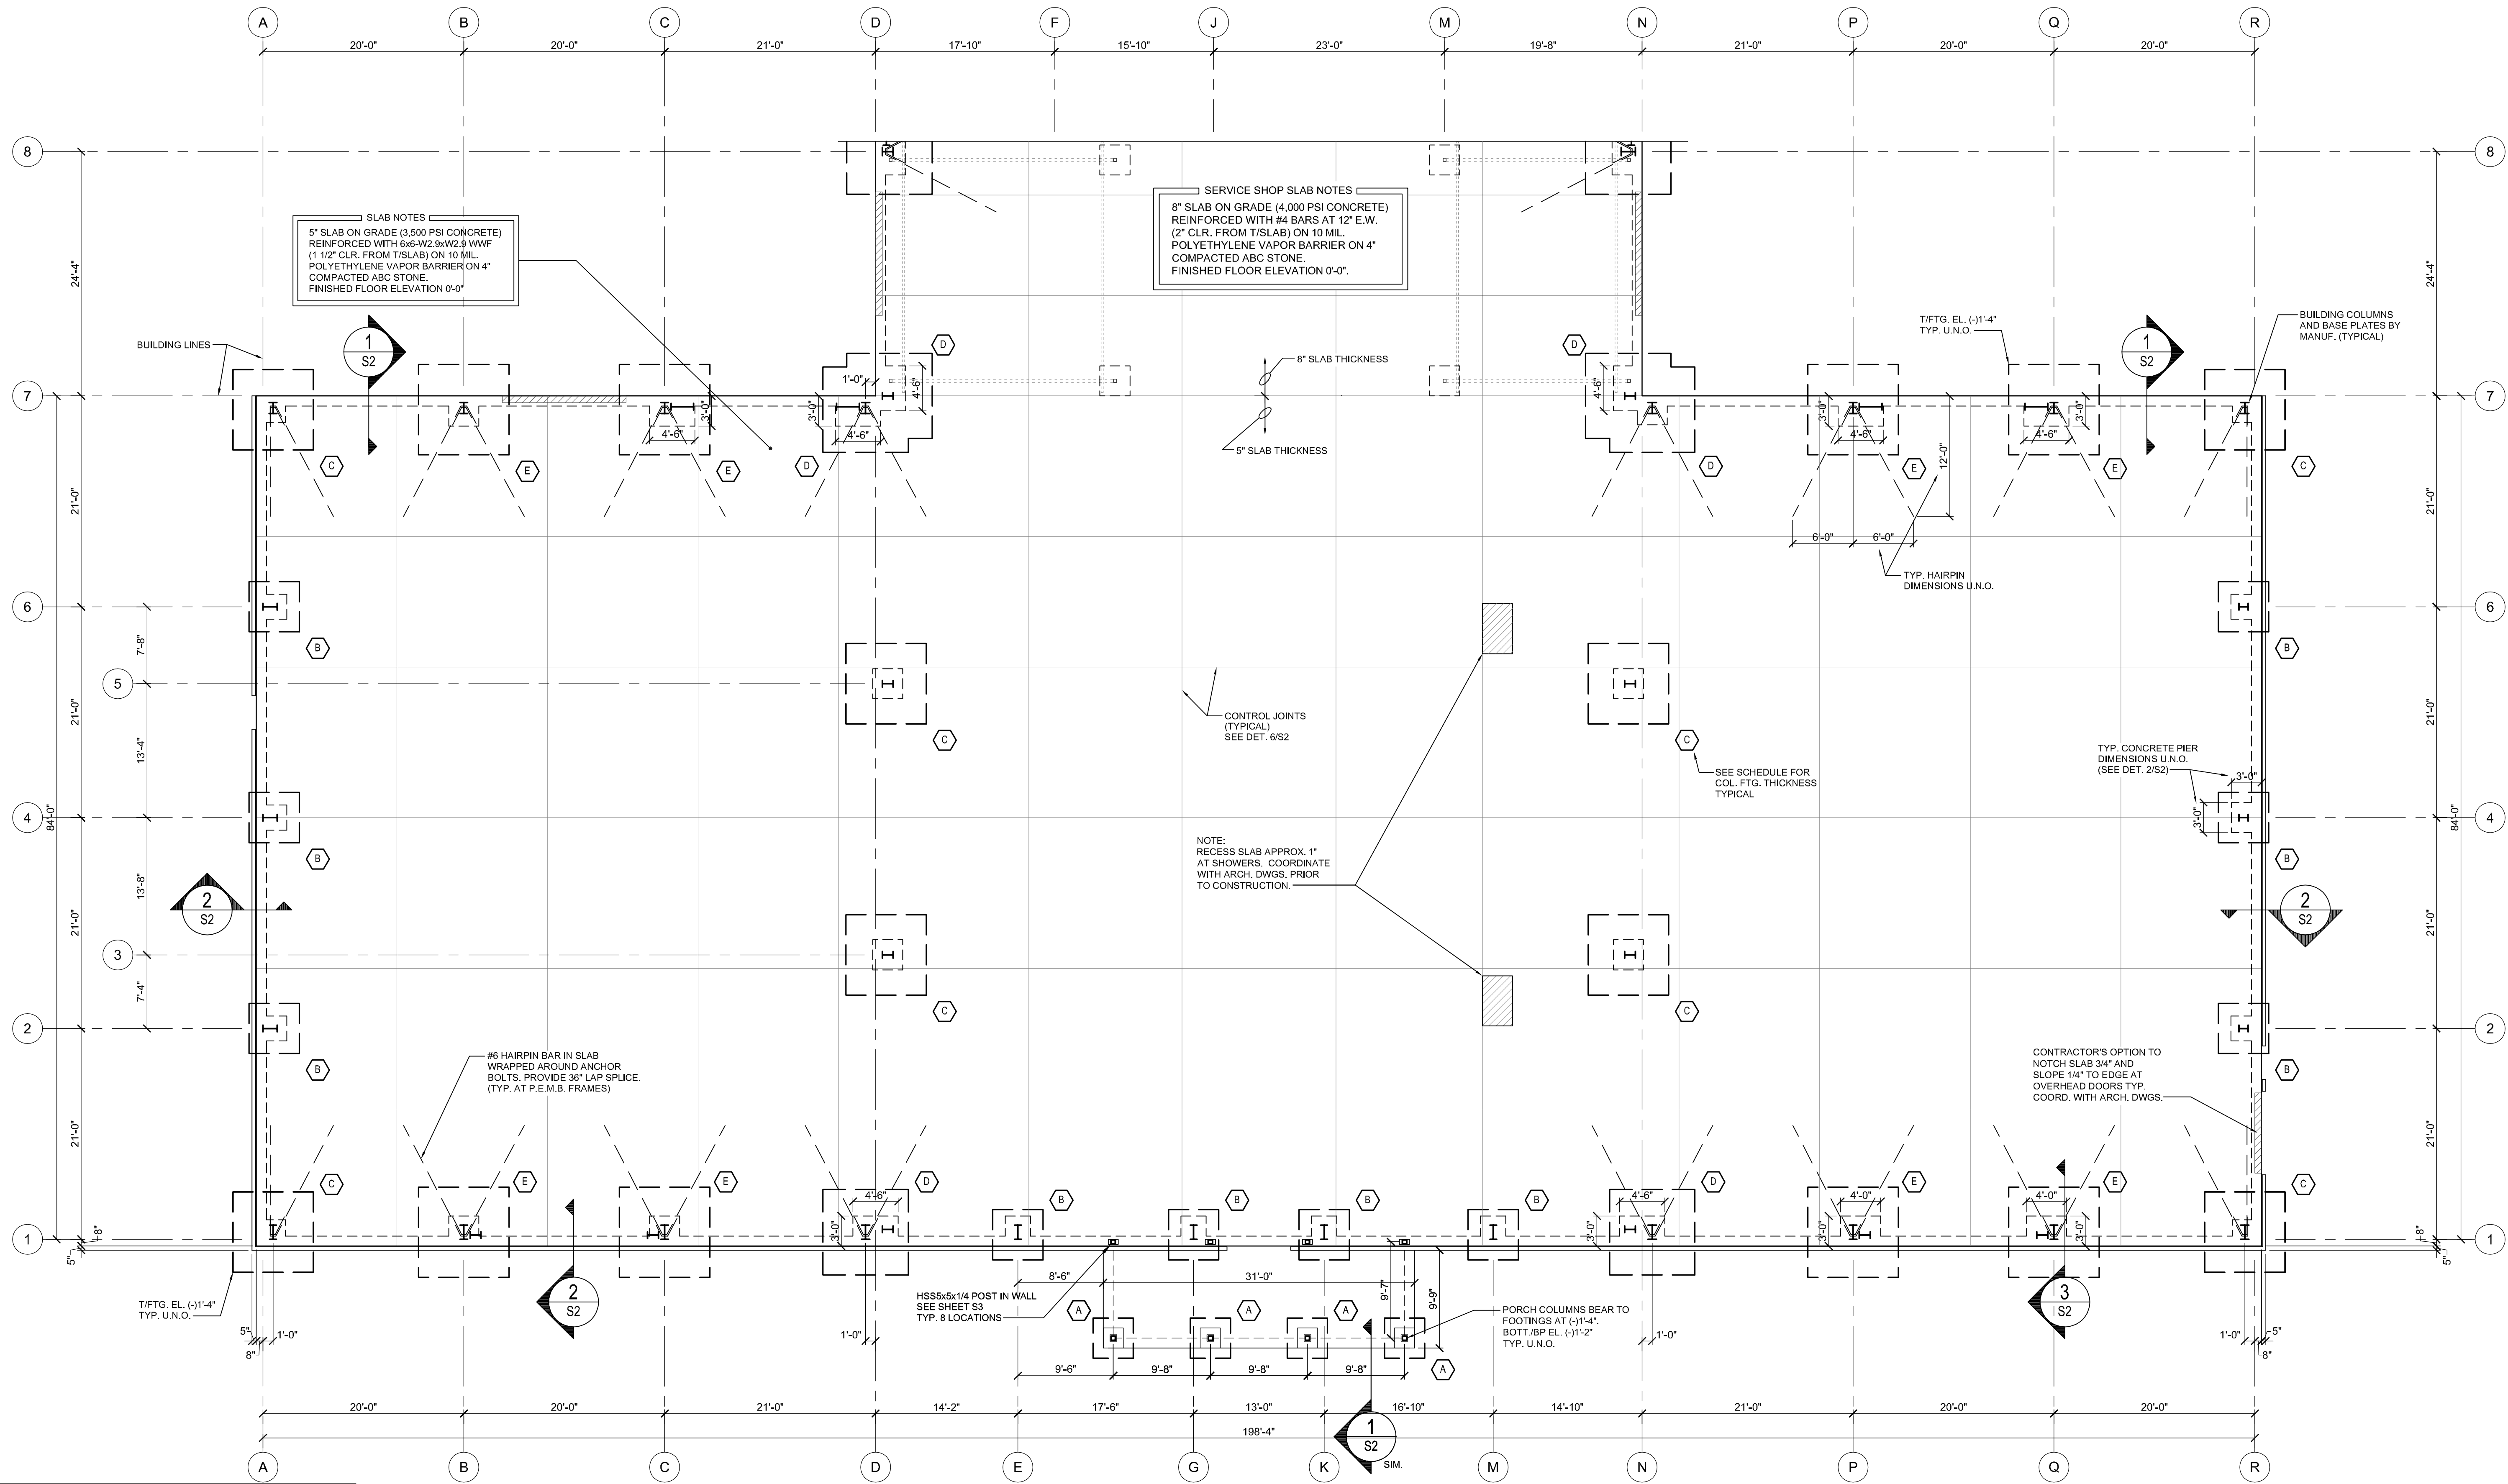
PROJECT TITLE
REVELS TURF & TRACTOR
 RAWLIS CHURCH RD.
 FUQUAY-VARINA, NC

PROJECT NO.
C230405
 DRAWING TITLE
FOUNDATION PLAN

SHEET 0 OF 0

S1.1

PLOT DATE 10/20/2023
 REVISION



MARK	SIZE			REINFORCEMENT	
	N-S	E-W	THK.	N-S	E-W
A	4'-0"	4'-0"	1'-4"	#5 AT 12"	#5 AT 12"
B	5'-0"	5'-0"	1'-4"	#5 AT 12"	#5 AT 12"
C	8'-0"	8'-0"	2'-0"	#6 AT 12"	#6 AT 12"
D	8'-6"	8'-6"	2'-0"	#6 AT 12"	#6 AT 12"
E	9'-0"	9'-0"	2'-0"	#6 AT 12"	#6 AT 12"

1 PARTIAL SLAB AND FOUNDATION PLAN
 S1.2 1/8" = 1'-0"

PROJECT TITLE
REVELS TURF & TRACTOR
 RAWLIS CHURCH RD.
 FUQUAY-VARINA, NC

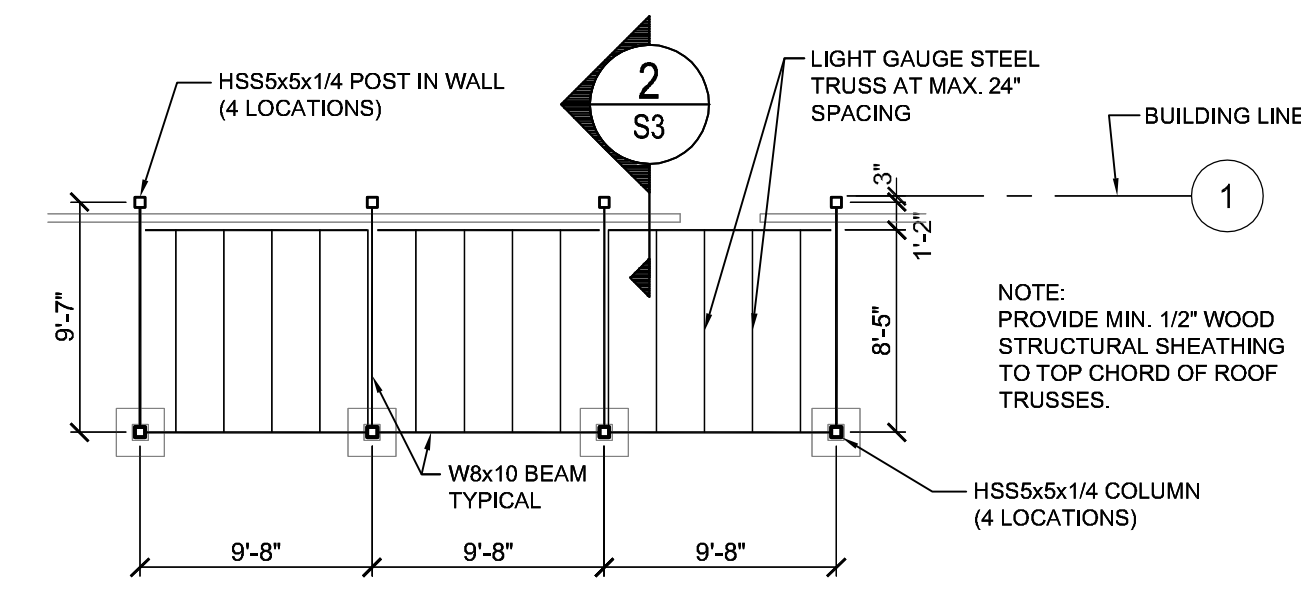
PROJECT NO.
C230405

DRAWING TITLE
FOUNDATION PLAN

SHEET 0 OF 0

S1.2

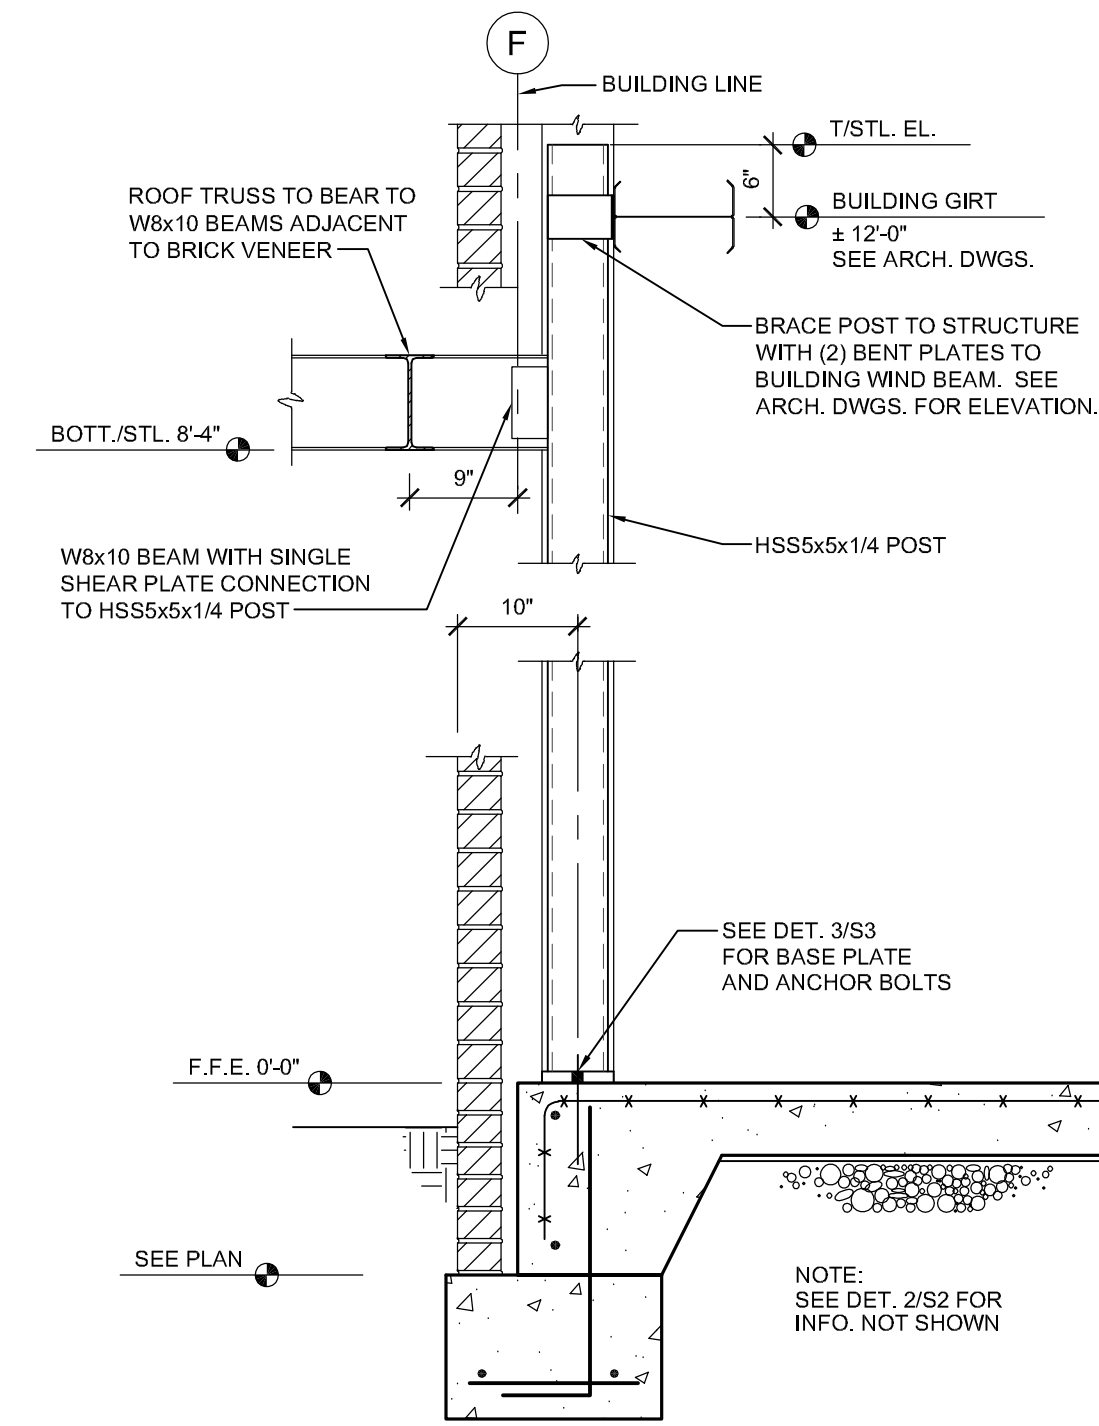
PLOT DATE 10/20/2023
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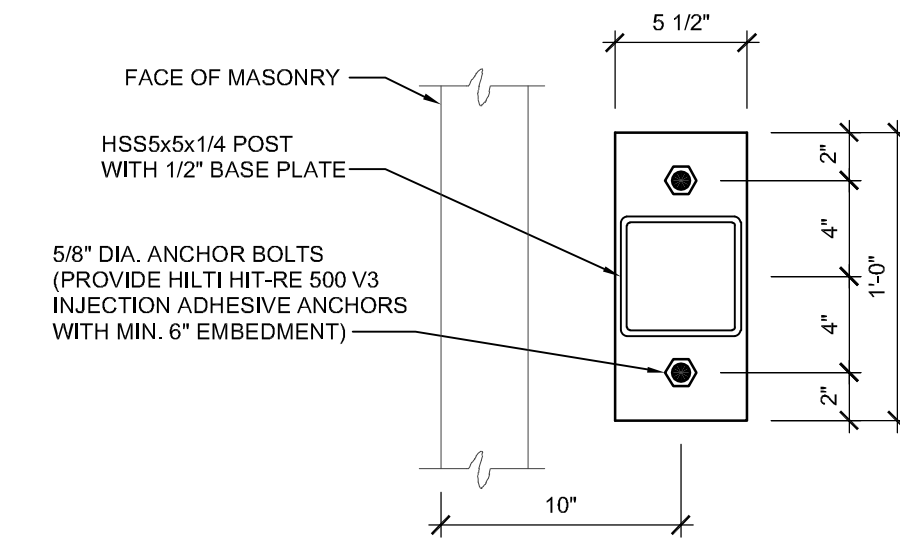
1 PORCH FRAMING PLAN
1/8" = 1'-0"

LIGHT GA. STEEL TRUSS NOTES:

- TRUSS DESIGN LOADS:
20 PSF TOP CHORD LL
10 PSF TOP CHORD DL
10 PSF BOTTOM CHORD DL
115 MPH WIND
- TRUSSES SHALL BE PLACED AT MAX. 24" o.c. SPACING WITH 3:12 PITCH. SEE ARCH. DRAWINGS.
- PROVIDE DETAILED SHOP DRAWINGS FOR REVIEW AND APPROVAL PRIOR TO FABRICATION. TRUSS PROFILES SHALL BE ENGINEERED AND SEALED BY THE TRUSS MANUFACTURER.
- SUPPORT TRUSSES AT BEARING LOCATIONS INDICATED ON PLAN. INSTALLATION SHALL BE IN ACCORDANCE WITH THE MANUFACTURER'S INSTRUCTIONS.



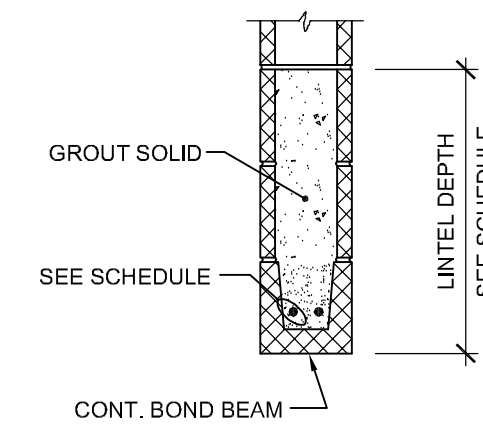
2 SECTION AT STEEL POST
3/4" = 1'-0" PORCH CONNECTION TO BUILDING



3 POST BASE PLATE
1 1/2" = 1'-0"

LINTEL SCHEDULE			
WALL TYPE	CLEAR OPENING WIDTH	DESCRIPTION	LINTEL DEPTH
8" CMU	LESS THAN 4'-0"	8" BOND BEAM WITH (1) #5 BAR	8" (1 COURSE)
8" CMU	4'-0" TO 10'-4"	8" BOND BEAM WITH (2) #5 BAR	16" (2 COURSES)
4" BRICK	4'-0" MAX.	L 3 1/2 x 3 1/2 x 14	
4" BRICK	6'-4" MAX.	L 5 x 3 1/2 x 14 (LLV)	
4" BRICK	8'-4" MAX.	L 6 x 3 1/2 x 5/16 (LLV)	

- LINTEL NOTES:**
- LINTEL SCHEDULE SHALL APPLY UNLESS NOTED OTHERWISE
 - PROVIDE MIN. 8" BEARING FOR ALL LINTEL ANGLES U.N.O.
 - PROVIDE MIN. 8" BEARING FOR CMU LINTELS U.N.O.
 - PLACE BARS IN BOTTOM OF BOND BEAM.
 - FOR LINTELS CONSISTING OF MULTIPLE COURSES OF CMU, PLACE BARS IN BOTTOM OF BOND BEAM AND GROUT THE ENTIRE LINTEL SOLID IN ONE LIFT.
 - SEE DETAIL 4/S3 FOR DEFINITION OF LINTEL DEPTH.



4 LINTEL DETAIL
3/4" = 1'-0"

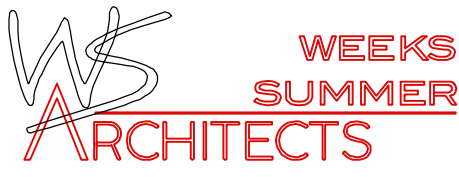
PROJECT TITLE
REVELS TURF & TRACTOR
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PROJECT NO.
C230405
DRAWING TITLE
PORCH PLAN AND DETAILS

SHEET 0 OF 0

S3

PLOT DATE 10/20/2023
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W.S. ARCHITECTS, PA
3305-109 Durham Drive
Raleigh, North Carolina 27603
919.779.9707
www.wsarchitectspa.com

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