

01 MECHANICAL PLAN  
1/4"=1'-0"

**MECHANICAL KEY NOTES**

1. PROVIDE DUCT MOUNTED SMOKE DETECTOR. TIE IN AUDIO-VISUAL ANNUNCIATOR. UPON DETECTION OF SMOKE, ROOFTOP UNIT SHALL SHUT DOWN AND ACTIVATE ALARM. COORDINATE INSTALLATION LOCATION WITH ACCESS REQUIREMENTS.
2. PROVIDE HONEYWELL VISION PRO 8000 TOUCHSCREEN 7-DAY PROGRAMMABLE THERMOSTAT WITH AUTO-CHANGEOVER AND AUTOMATIC START CAPABILITY. MOUNT THERMOSTAT 48" ABOVE FINISHED FLOOR. COORDINATE FINAL INSTALLATION LOCATION OF THERMOSTAT WITH OWNER'S REPRESENTATIVE.
3. PROVIDE MICROPROCESSOR REMOTE INTERFACE. MOUNT MICROPROCESSOR REMOTE INTERFACE 48" ABOVE FINISHED FLOOR. COORDINATE FINAL INSTALLATION LOCATION OF MICROPROCESSOR REMOTE INTERFACE WITH OWNER'S REPRESENTATIVE.
4. PROVIDE COMBINATION TEMPERATURE/HUMIDITY SENSOR. MOUNT SENSOR 48" ABOVE FINISHED FLOOR. HUMIDITY SENSOR SHALL OPERATE REFRIGERATION SYSTEM AND INITIATE HOT GAS REHEAT AS REQUIRED TO MAINTAIN SPACE HUMIDITY AT 55% RH.
5. INSTALL OWNER FURNISHED TYPE I GREASE EXHAUST HOOD. SUPPORT HOOD PER MANUFACTURER'S INSTALLATION INSTRUCTIONS. PROVIDE TRAPEZE HANGERS FOR ALL THREAD SUPPORT UNDER DUCTWORK AS REQUIRED. REFER TO HOOD DRAWING SET ON SHEET M3.1-M3.4 FOR HOOD SPECIFICATION AND ADDITIONAL INFORMATION.
6. INSTALL OWNER FURNISHED UL-2221 LISTED DOUBLE-WALL GREASE DUCT, EQUAL TO FRANKE SYSTEMS MODEL FRDW-2R ROUND 20 GAUGE 430 STAINLESS INNER DUCT INSULATED WITH A 24 GAUGE 430 STAINLESS OUTER SHELL FROM HOOD COLLAR EXHAUST FROM ROOF. INSTALL EXHAUST DUCT PER MANUFACTURER'S INSTRUCTIONS. PROVIDE CLEANOUTS AT EVERY CHANGE OF DIRECTION IN THE DUCT AND/OR EVERY 10 FEET WITH MINIMUM OF 3 FEET OF CLEARANCE IN FRONT OF CLEAN-OUT.
7. DUCT UP TO EQUIPMENT ON ROOF. REFER TO SHEET M1.2 FOR EQUIPMENT LOCATION.
8. INSTALL ROOM TEMPERATURE SENSOR FOR HOOD THERMOSTATIC CONTROL. SEE HOOD DRAWING SET ON M3.1-M3.4 FOR HOOD SPECIFICATIONS AND ADDITIONAL INFORMATION.
9. PROVIDE AIR CURTAIN. MOUNT UNIT ON WALL DIRECTLY ABOVE DOOR PER MANUFACTURER'S INSTALLATION INSTRUCTIONS.
10. UNDERCUT DOOR BY 3/4" FOR AIR TRANSFER.
11. PULL STATION & TENSION CABLE FOR KITCHEN HOOD FIRE SUPPRESSION SYSTEM ACTIVATION TO BE PROVIDED BY FIRE SUPPRESSION SUBCONTRACTOR. GENERAL CONTRACTOR TO COORDINATE WITH ELECTRICAL CONTRACTOR FOR JUNCTION BOX AND CONDUIT TO PULL STATION. LINE-SIZED MECHANICAL (OR ELECTRICAL) GAS SHUT OFF VALVE PROVIDED BY HOOD VENDOR. FIRE SUPPRESSION SUBCONTRACTOR SHALL VERIFY APPROVED LOCATION WITH LOCAL AUTHORITY AND COORDINATE THE COMPLETE INSTALLATION WITH ALL OTHER TRADES.

**GENERAL NOTES**

- A. CONTRACTORS AND SUB-CONTRACTORS SHALL CAREFULLY REVIEW THE CONSTRUCTION DOCUMENTS. INFORMATION REGARDING THE COMPLETE WORK IS DISPERSED THROUGHOUT THE DOCUMENT SET AND CANNOT BE ACCURATELY DETERMINED WITHOUT REFERENCE TO THE COMPLETE DOCUMENT SET.
- B. COORDINATE WITH THE WORK OF OTHER SECTIONS, EQUIPMENT FURNISHED BY OTHERS, REQUIREMENTS OF THE OWNER, AND WITH THE CONSTRAINTS OF THE EXISTING CONDITIONS OF THE PROJECT SITE. PROVIDE DUCT RISES AND DROPS AS REQUIRED FOR FIELD INSTALLATION AND TRADE COORDINATION. NOTIFY ARCHITECT OF ANY DISCREPANCIES BEFORE STARTING WORK.
- C. DRAWINGS FOR HVAC WORK ARE DIAGRAMMATIC, SHOWING THE GENERAL LOCATION, TYPE, LAYOUT, AND EQUIPMENT REQUIRED. THE DRAWINGS SHALL NOT BE SCALED FOR EXACT MEASUREMENT. REFER TO ARCHITECTURAL DRAWINGS FOR DIMENSIONS. REFER TO MANUFACTURER'S STANDARD INSTALLATION DRAWINGS FOR EQUIPMENT CONNECTIONS AND INSTALLATION REQUIREMENTS. PROVIDE DUCTWORK, CONNECTIONS, ACCESSORIES, OFFSETS, AND MATERIALS NECESSARY FOR A COMPLETE SYSTEM.
- D. ALL WORK SHALL COMPLY WITH STATE AND LOCAL CODE REQUIREMENTS AS APPROVED AND AMENDED BY THE GOVERNING CITY. PURCHASE ALL PERMITS ASSOCIATED WITH THE WORK. OBTAIN ALL INSPECTIONS REQUIRED BY CODE.
- E. SUPPORT NEW MECHANICAL SYSTEMS WITH SEISMIC RESTRAINTS IN ACCORDANCE WITH SEISMIC HAZARD LEVEL 'A' OF THE SEISMIC RESTRAINT MANUAL, AS PUBLISHED BY SMACNA, AND IN ACCORDANCE WITH THE CALIFORNIA BUILDING CODE, LATEST EDITION.

**AIR DISTRIBUTION SIZING - ROUND DUCT**

UNLESS NOTED OTHERWISE ON PLANS, THE FOLLOWING CHART SHALL APPLY TO ROUND DUCT SIZES FOR SUPPLY AIR\*, EXHAUST AIR, AND RETURN AIR.

SUPPLY AND EXHAUST AIR CFM RANGE	DUCT SIZE	RETURN AIR CFM RANGE
0-100	6"	0-70
105-200	8"	75-155
205-395	10"	160-285
400-605	12"	290-465
610-920	14"	470-710
925-1200	16"	715-1015

\* DIFFUSER NECK SIZES SHALL MATCH SUPPLY AIR DUCT SIZING.

**ISSUE TABLE**

No.	Date (mm/dd/yy)	Description

**REVISIONS**

No.	Date	Description
1	8/01/2023	RESPONSE TO CITY

**DRAWINGS REVISED AS PER DESIGN BULLETIN**

No.	Date	Description

PROJECT NORTH

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8.2.2023

Company Logo

ARCHITECTURE • CIVIL ENGINEERING • MEP ENGINEERING  
10755 SANDHILL ROAD, DALLAS, TEXAS 75238  
TEL: 214-343-9400 www.dimensiongroup.com

Project

Store Type  
US 2112 PROTOTYPE  
2112-21

Location


1517 NC 24-87  
CAMERON, NC

Drawing Title

**MECHANICAL PLAN**

Drawn	Checked
NI	AH
Scale	Date
1/4" = 1'-0"	JUNE 2023
Project No.	Drawing No.
C22-129	M1.1

Digitally signed by Ashraf Hasan PE Lic No. 41082 NC  
DN: c=US, ou=MEP Unit, o=The Dimension Group, cn=Ashraf Hasan PE Lic No. 41082 NC,  
E=ahasan@dimensiongroup.com  
Reason: I am the author of this document  
Date: 2023-08-02 21:36:51  
Foxit PhantomPDF Version: 9.7.5

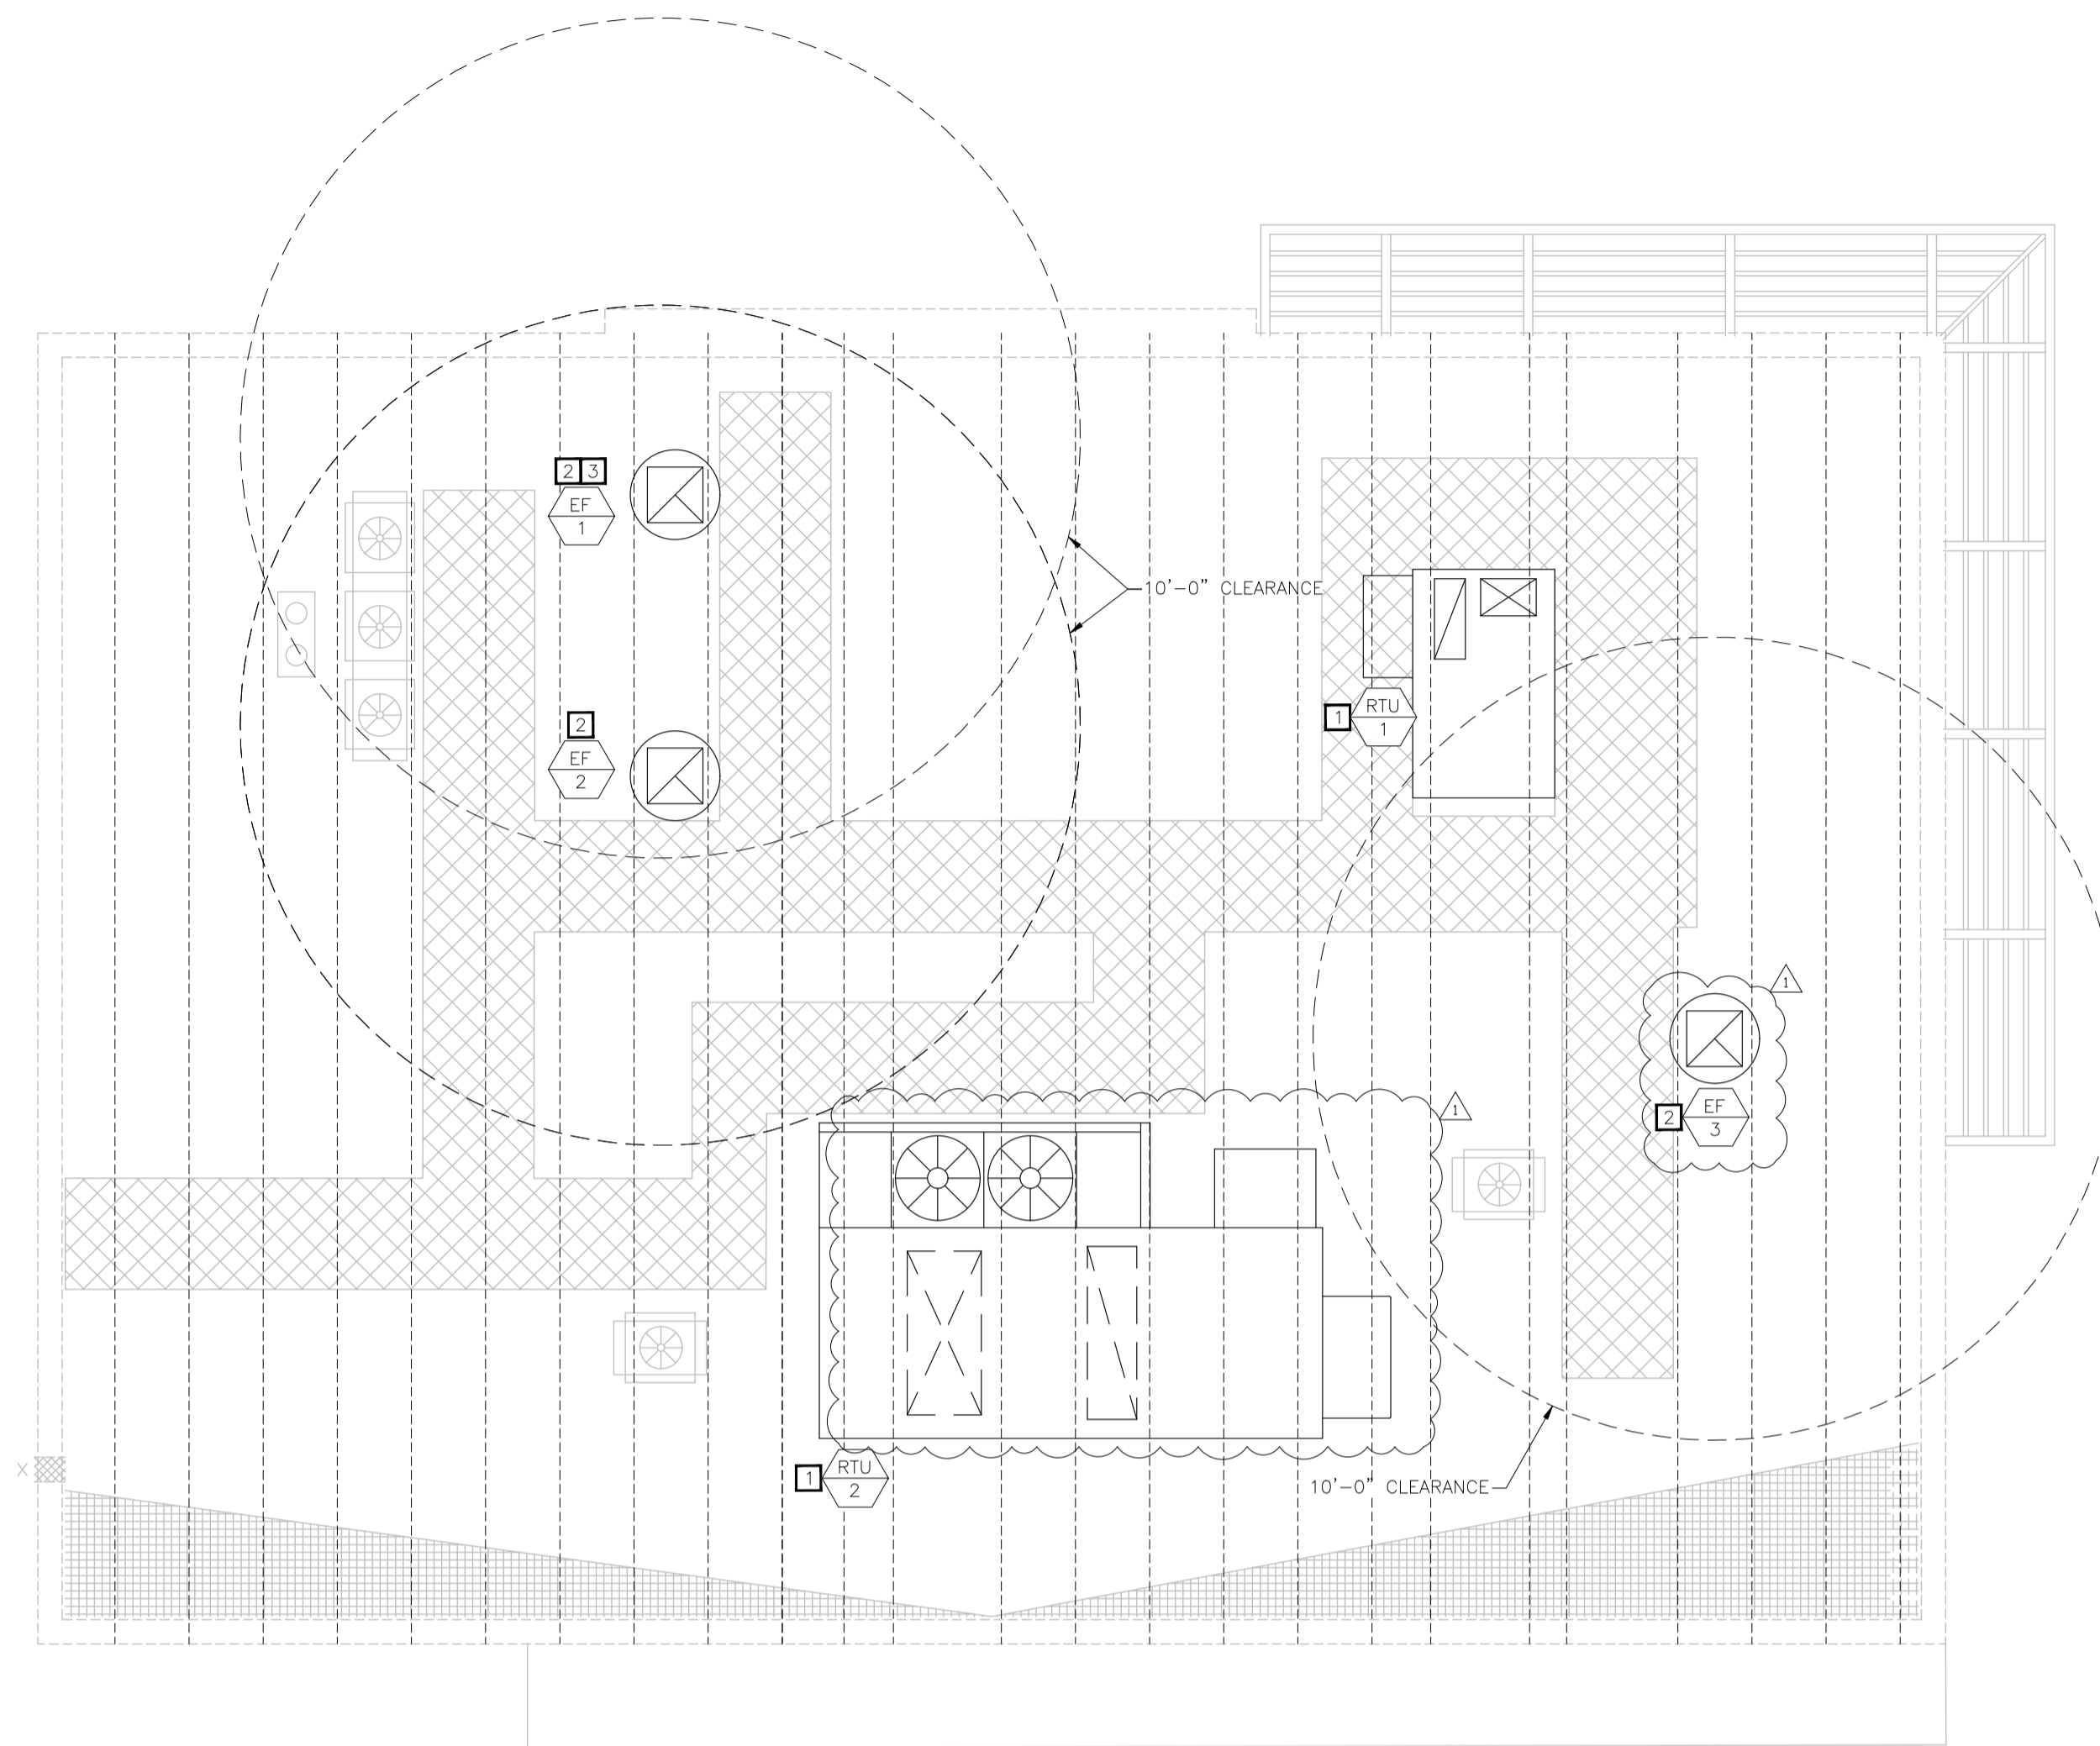

01 MECHANICAL ROOF PLAN  
1/4" = 1'-0"

MECHANICAL KEY NOTES

- 1 PROVIDE ROOFTOP UNIT AND CURB, COORDINATE UNIT WITH STRUCTURE. SHIM UNIT AND CURB LEVEL FOR PROPER CONDENSATE DRAINAGE. PROVIDE FLEXIBLE CONNECTORS ON SUPPLY AND RETURN AIR DUCT CONNECTIONS. TRANSITION TO DUCT SIZES SHOWN ON SHEET M1.1.
- 2 INSTALL OWNER FURNISHED ROOF MOUNTED EXHAUST FAN AND CURB.
- 3 INSTALL OWNER FURNISHED WIND BAND EXTENSION FOR GREASE EXHAUST FAN. EXHAUST TERMINATION MUST BE EQUAL OR HIGHER THAN ANY WALL OR PARAPET WITHIN 5'-0" OF FAN. VERIFY REQUIRED HEIGHT PRIOR TO BID AND COORDINATE WITH HOOD MANUFACTURER FOR ADDITION TO EQUIPMENT PRIOR TO BID.

GENERAL NOTES

- A. SEAL ALL ROOF PENETRATIONS WATER TIGHT. COORDINATE ALL PENETRATIONS WITH GENERAL CONTRACTOR AND ROOFING CONTRACTOR.
- B. ALL OUTDOOR INTAKES SHALL BE LOCATED AT LEAST 10 FEET FROM EXHAUST OUTLETS, APPLIANCE FLUES AND PLUMBING VENTS.
- C. MAINTAIN ALL CODE AND MANUFACTURER'S RECOMMENDED CLEARANCES AROUND ALL ROOF EQUIPMENT.

ISSUE TABLE

No.	Date (mm/dd/yy)	Description

REVISIONS

No.	Date	Description
1	8/01/2023	RESPONSE TO CITY

DRAWINGS REVISED AS PER DESIGN BULLETIN

No.	Date	Description



PROJECT NORTH

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8.2.2023

Company Logo



Project



Store Type

US 2112 PROTOTYPE  
2112-21

Location

1517 NC 24-87  
CAMERON, NC

Drawing Title

MECHANICAL ROOF PLAN

Drawn	Checked
NI	AH
Scale	Date
1/4" = 1'-0"	JUNE 2023
Project No.	Drawing No.
C22-129	M1.2

POPEYES LOUISIANA KITCHEN MODEL 2112, 1517 NC 24-87, CAMERON, NC (JUNE 01, 2023) STORE NO. C22-129

**2018 INTERNATIONAL MECHANICAL CODE - TABLE 403.3.1.1 VENTILATION SUMMARY**

OCCUPANCY CATEGORY	PEOPLE OUTDOOR AIR RATE - (Rp) (CFM/PERSON)	AREA OUTDOOR AIR RATE - (Ra) (CFM/SQ.FT.)	OCCUPANCY DENSITY P/1,000 SQ.FT.	OCCUPANCY CLASSIFICATION P/1,000 SQ.FT.	CALCULATED OCCUPANCY DENSITY	ZONE OCCUPANCY OVERRIDE	PEOPLE EXPECTED TO OCCUPY THE ZONE - (Pz)	Rp/Pz	Ra/Az	AREA - (Az) SQ.FT.	ZONE AIR DISTRIBUTION EFFECTIVENESS Ez	BREATHING ZONE OUTDOOR AIRFLOW - (Vbz) CFM	ZONE OUTDOOR AIRFLOW (Voz) Voz=Vbz/Ez	ZONE PRIMARY AIRFLOW (Vpz)	PRIMARY OUTDOOR AIR FRACTION (Zp) Zp=Voz/Vpz	OCCUPANT DIVERSITY RATIO (D)	UNCORRECTED OUTDOOR AIR INTAKE (Vou) CFM	SYSTEM VENTILATION EFFICIENCY Ev	CORRECTED OUTDOOR AIRFLOW (Vot) CFM	PROVIDED OUTDOOR AIRFLOW CFM
<b>RTU-1</b>																				
DINING	7.5	0.18	70	DINING	26	—	26	194	67	370	0.8	261	326	1400	0.23	—	261	—	284	—
SALES	7.5	0.12	20	KITCHEN	3	—	3	20	16	130	0.8	35	44	400	0.11	—	35	—	35	—
VESTIBULE	—	0.06	—	CORRIDOR	—	—	—	—	2	40	0.8	2	3	150	0.02	—	2	—	3	—
RESTROOM	—	—	—	RESTROOM	—	—	—	—	—	55	0.8	—	—	50	—	—	—	—	—	—
SYSTEM POPULATION INCLUDING DIVERSITY (Ps) =							26	—	—	—	—	—	—	MAX Zp =	0.23	1.00	298	0.92	324	400
<b>DOAS-1</b>																				
KITCHEN	7.5	0.12	20	KITCHEN	4	—	4	32	25	210	0.8	57	71	1600	0.04	—	57	—	57	—
BOH	7.5	0.12	20	KITCHEN	14	—	14	107	85	710	0.8	192	240	2800	0.09	—	192	—	192	—
DRIVE THRU	7.5	0.12	20	KITCHEN	2	—	2	17	13	110	0.8	30	37	400	0.09	—	30	—	30	—
SYSTEM POPULATION INCLUDING DIVERSITY (Ps) =							21	—	—	—	—	—	—	MAX Zp =	0.09	1.00	278	1.00	278	2,500

**ROOFTOP UNIT SCHEDULE**

MARK (RTU-#)	1	2
MANUFACTURER	CARRIER	GREENHECK
MODEL	50GCBK06	RV-45-15
AIR FLOW (CFM)	2,000	5,000
OA FLOW (CFM)	400	2,500
AMBIENT OAT (°F)	95.5	95.5
EXTERNAL STATIC (IN. W.C.)	0.60	1.00
DX COOLING COIL		
EAT (°FDB/WB)	80/67	80/67
TOTAL (BTU/HR)	59,000	202,000
SENSIBLE (BTU/HR)	46,800	141,100
ELECTRIC HEAT		
FUEL	ELECTRIC (332A)	ELECTRIC
ELECTRIC HEAT (KW)	18.4	57.4
WINTER SA TEMP (°F)	87	81
FLA (Amps)	51.1	159.3
ELECTRICAL		
VOLTS/Ø/HZ	208-230/3/60	208/3/60
UNIT MCA	83	181.3
MOCAP AMPS	90	200
APPROX. WEIGHT (LBS)	844	3,012 (±5%)
EER (SEER)	12.8 (17.4)	11
NOTES	1-14	1-11,13-15

- NOTES:**
- 1) PROVIDE FACTORY FABRICATED 14" HIGH ROOF CURB. CURB SHALL MATCH SLOPE OF ROOF. REFER TO ARCHITECTURAL DRAWINGS FOR ADDITIONAL INFORMATION
  - 2) PROVIDE FACTORY MOUNTED WEATHERHOOD AND BIRDSCREEN AT OUTSIDE AIR INTAKE.
  - 3) PROVIDE FACTORY INSTALLED LOW-LEAK DRY BULB ECONOMIZER WITH FAULT DETECTION AND DIAGNOSTICS.
  - 4) PROVIDE UNIT WITH LOUVERED HAIL GUARDS.
  - 5) PROVIDE 5 MINUTE COMPRESSOR RESTART TIME DELAY.
  - 6) PROVIDE FILTER RACK AND 2 SETS OF MERV 8 FILTERS.
  - 7) PROVIDE FACTORY MOUNTED AND WIRED DISCONNECT SWITCH.
  - 8) CONTRACTOR SHALL INSTALL ALL COMPONENTS SHIPPED LOOSE TO THE FIELD.
  - 9) PROVIDE WITH FACTORY CONDENSATE OVERFLOW SWITCH, FOIL FACED INSULATION, AND HINGED ACCESS PANELS.
  - 10) SET MINIMUM OUTSIDE AIR AS SPECIFIED ABOVE. FIELD SET 2 MINIMUM POSITIONS TO MAINTAIN SCHEDULED OUTSIDE AIR FLOW RATE AT SUPPLY FAN MINIMUM AND MAXIMUM SPEEDS. OUTSIDE AIR DAMPER SHALL FULLY CLOSE UPON UNIT SHUTDOWN
  - 11) PROVIDE POWERED GFCI CONVENIENCE OUTLET. OUTLET TO BE POWERED BY LINE SIDE OF DISCONNECT.
  - 12) PROVIDE FAN WITH 2-SPEED FAN CONTROL.
  - 13) PROVIDE FACTORY MOUNTED POWER EXHAUST.
  - 14) PROVIDE HOT GAS REHEAT COIL FOR DEHUMIDIFICATION WITH HUMIDISTAT SET TO 55% R.H.
  - 15) PROVIDE FACTORY MOUNTED SINGLE ZONE VAV AND DIGITAL SCROLL COMPRESSOR.

**AIR BALANCE SCHEDULE**

	RTU-1	RTU-2	EF-1	EF-2	EF-3	TOTALS
OUTSIDE AIR FLOW (CFM)	400	2,500	0	0	0	2,900
RETURN AIR FLOW (CFM)	1,600	2,500	0	0	0	4,100
SUPPLY AIR FLOW (CFM)	2,000	5,000	0	0	0	7,000
EXHAUST AIR FLOW (CFM)	0	0	1,230	1,230	75	2,535
BUILDING PRESSURE (CFM)	400	2,500	-1,230	-1,230	-75	365
RESULTING BUILDING PRESSURIZATION (CFM)						365

**EXHAUST AND VENTILATION FAN SCHEDULE - OWNER FURNISHED**

MARK (EF-#)	1	2	3
MANUFACTURER	FRANKE	FRANKE	FRANKE
MODEL	FR-DU50HFA	FR-DU50HFA	FR-DR10HFA
TYPE	UPBLAST	UPBLAST	DOWNBLAST
DRIVE TYPE	DIRECT	DIRECT	DIRECT
PERFORMANCE			
AIR FLOW (CFM)	1,230	1,230	75
EXT. STATIC (IN. W.C.)	0.8	0.8	0.125
FAN SPEED (RPM)	1,500	1,500	1,015
ELECTRICAL			
VOLTS/Ø/HZ	120/1/60	120/1/60	120/1/60
FAN MOTOR HP	1/2	1/2	1/8
ACCESSORIES	GDC,RC,WB	GDC,RC	BD,BS,DS,RC,SC
APPROX. WEIGHT (LBS)	120	120	75
SERVES	HOOD	HOOD	RESTROOM
NOTES	1,2,3	1,2,3	3,4

- ACCESSORIES:**  
BD-BACKDRAFT DAMPER, BS-BIRD SCREEN, DS-DISCONNECT SWITCH, GDC-GREASE DRAIN AND CUP, RC-ROOF CURB PER HOOD PACKAGE SPECIFICATION, SC-FACTORY MOUNTED AND WIRED SPEED CONTROL, WB-WIND BAND EXTENSION, WP-NEMA 3R DISCONNECT SWITCH
- NOTES:**
- 1) FAN SHALL BE CONTROLLED BY SWITCH AT KITCHEN HOOD. INTERLOCK RTU-1 AND RTU-2 TO OPERATE IN OCCUPIED MODE WHILE HOOD EXHAUST FAN IS ENERGIZED. SEE HOOD PACKAGE ON M3.x SHEETS FOR MORE INFORMATION.
  - 2) PROVIDE WITH VARIABLE SPEED CONTROLLER.
  - 3) COORDINATE WITH MANUFACTURER FOR FINAL SELECTION.
  - 4) ELECTRICAL CONTRACTOR SHALL INTERLOCK FAN WITH TIMECLOCK.

**GRILLE, REGISTER, AND DIFFUSER SCHEDULE**

MARK	A	B	C
MANUFACTURER	TITUS	TITUS	TITUS
MODEL	TMS-AA	TMS-AA	PAR-AA
TYPE	SQUARE CONE DIFFUSER	SQUARE CONE DIFFUSER	PREFORATED FACE DIFFUSER
NECK SIZE (L"XW")	PER PLAN	PER PLAN	PER PLAN
FACE SIZE (L"XW")	24"X24"	24"X24"	24"X24"
FRAME TYPE	LAY-IN	LAY-IN	LAY-IN
FINISH	WHITE	WHITE	WHITE
NOISE CRITERIA LEVEL	<30	<30	<30
ACCESSORIES		TRM	

MARK	D	E	F
MANUFACTURER	TITUS	TITUS	TITUS
MODEL	TMS-AA	35FL	50F
TYPE	SQUARE CONE DIFFUSER	LOUVERED EXHAUST GRILLE	EGGCRATE GRILLE
NECK SIZE (L"XW")	PER PLAN	10"X10"	22"X22"
FACE SIZE (L"XW")	12"X12"	12"X12"	24"X24"
FRAME TYPE	LAY-IN	SURFACE	LAY-IN
FINISH	WHITE	WHITE	WHITE
NOISE CRITERIA LEVEL	<30	<30	<30
ACCESSORIES	TRM	STR	

- ACCESSORIES:**  
STR-SQUARE TO ROUND TRANSITION (AS REQUIRED), TRM-RAPID MOUNT SHEETROCK FRAME

**AIR CURTAIN SCHEDULE**

MARK (AC-#)	1
MANUFACTURER	MARS
MODEL	LPV236-1UA-OB
AIR FLOW (CFM)	900
ELECTRICAL	
VOLTS/Ø/HZ	115
MOTOR QUANTITY	1
MOTOR HP	1/6
MCA (AMPS)	3
MOCAP (AMPS)	15
FINISH	OBSDIAN BLACK
APPROX. WEIGHT (LBS)	32
NOTES	1-3

- NOTES:**
- 1) PROVIDE WITH INTEGRAL DISCONNECT SWITCH.
  - 2) PROVIDE WITH DOOR MICRO-SWITCH.
  - 3) PROVIDE WITH FILTER.
  - 4) PROVIDE MOUNTING HARDWARE REQUIRED BY MANUFACTURER FOR COMPLETE INSTALLATION.

**ISSUE TABLE**


No.	Date (mm/dd/yy)	Description

**REVISIONS**

No.	Date	Description
1	8/01/2023	RESPONSE TO CITY

**DRAWINGS REVISED AS PER DESIGN BULLETIN**

No.	Date	Description

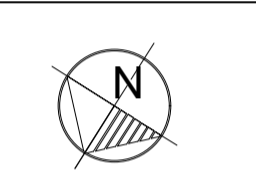

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8.2.2023

Company Logo



Project



POPEYES

Store Type

US 2112 PROTOTYPE

2112-21

Location

1517 NC 24-87

CAMERON, NC

Drawing Title

MECHANICAL SCHEDULES

Drawn

NI

Checked

AH

Scale

1/4" = 1'-0"

Date

JUNE 2023



Project No.

C22-129

Drawing No.

M2.1

POPEYES LOUISIANA KITCHEN MODEL 2112, 1517 NC 24-87, CAMERON, NC (JUNE 01, 2023) STORE NO. C22-129

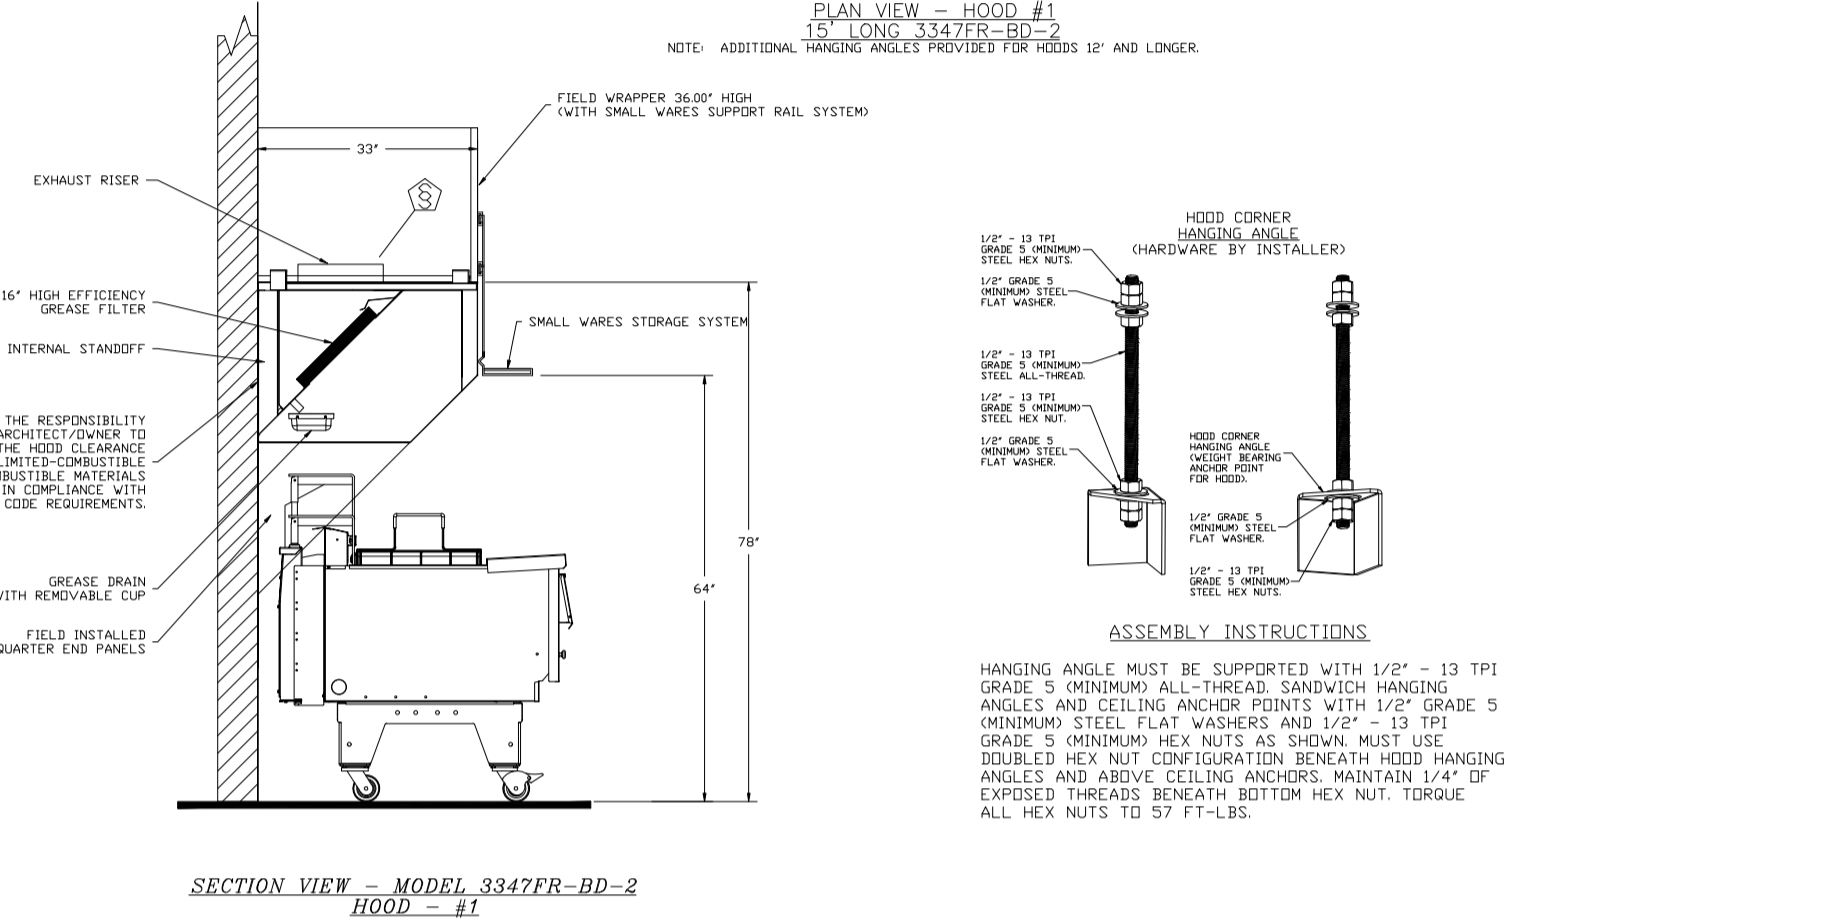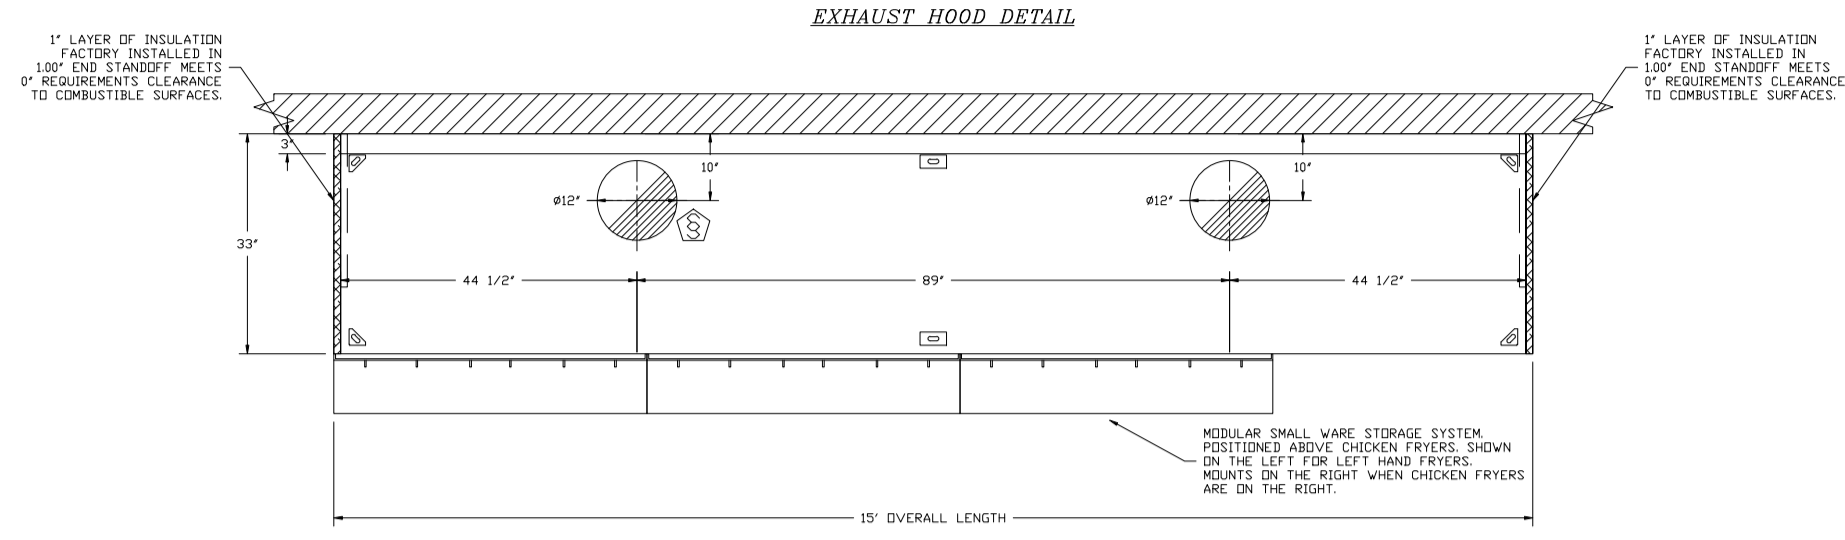


1 EXHAUST HOOD DETAIL  
SCALE: NO SCALE



# PLK 2112 15' HOOD PACKAGE

FRANKE FOODSERVICE SYSTEMS AMERICAS, INC.  
800 AVIATION PARKWAY  
SMYRNA, TN USA 37167  
PHONE: 1-800-877-5178  
WWW.FRANKESUPPLY.COM  
FS-BKSALES.US@FRANKE.COM

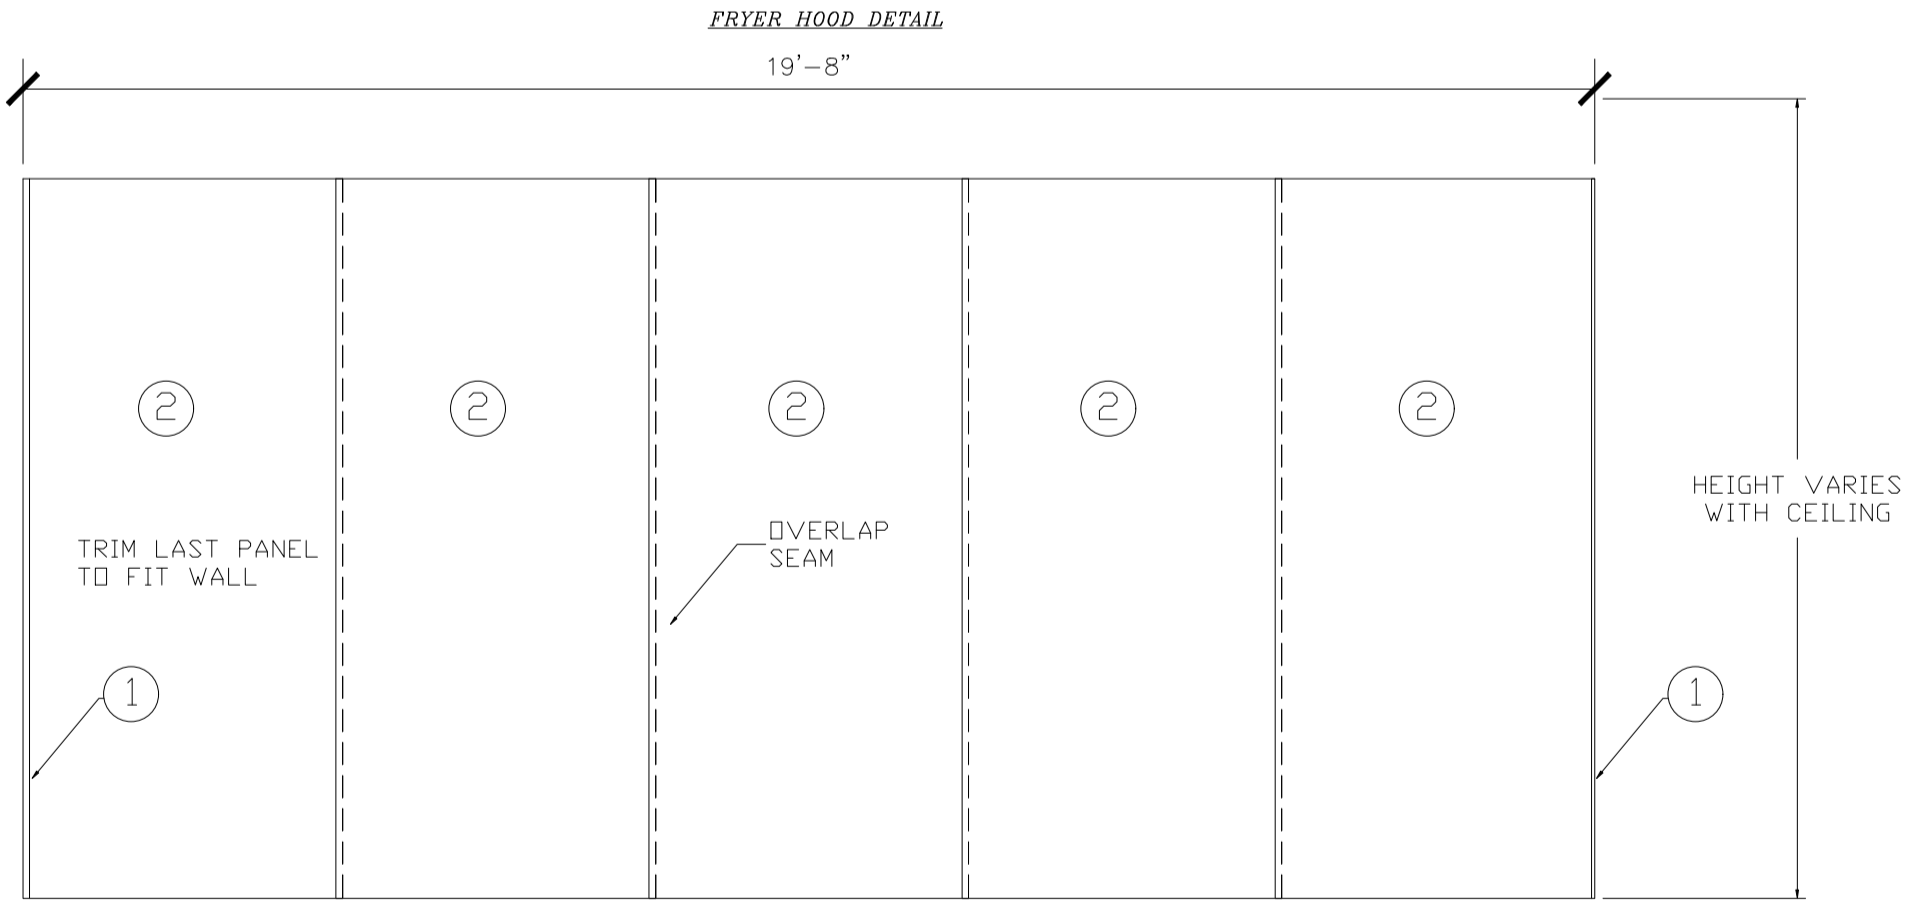

COVERS ENTIRE WALL BEHIND HOOD

ITEM	QTY	DESCRIPTION
1	2	S/S CAP STRIP
2	5	WALL FLASHING 48" WIDE

2 BACKSPLASH DETAIL  
SCALE: NO SCALE

Revision #	Date	Description
A	10/01/20	INITIAL ISSUE

ISSUE TABLE

No.	Date (mm/dd/yy)	Description
-----	-----------------	-------------

REVISIONS

No.	Date	Description
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Account: POPEYES Restaurant # PLK 2112  
Title: WALL MOUNTED INSTALLATION DETAIL  
Site ID: -  
Operator: -  
Site Address: -  
City: -  
State: - Zip Code: - Country: -  
Region: -  
Building Type: -  
Electrical Service: -  
Gas Service: -  
Market Manager: -  
Frankie Project Number: -  
Created by: HP033  
Date Issued: 10/01/20  
Modified By: AM029  
Drawing Scale: AS NOTED  
Units: INCHES  
Drawing Number: -  
Revision: A  
Sheet Name: 1 OF 4



8.2.2023



Store Type: US 2112 PROTOTYPE 2112-21  
Location: 1517 NC 24-87 CAMERON, NC

Drawing Title: MECHANICAL HOOD DRAWINGS


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Scale: 1/4" = 1'-0"	Date: JUNE 2023
Project No: C22-129	Drawing No: M3.1

POPEYES LOUISIANA KITCHEN MODEL 2112, 1517 NC 24-87, CAMERON, NC (JUNE 01, 2023) STORE NO. C22-129



**ELECTRICAL PACKAGE - JOB#4702950**


NO	TAG	PACKAGE #	LOCATION	SWITCHES		OPTION	FANS CONTROLLED					
				LOCATION	QUANTITY		FAN TAG	TYPE	Ø	HP	VOLT	FLA
1		SC-120109A_M4	WALL MOUNT IN SS BOX	OS - SS WALL MOUNT BOX	1 LIGHT 1 FAN	SMART CONTROLS THERMOSTATIC CONTROL W/ RELAY ON/OFF WITH SUPPLY	EF-LEFT	EXHAUST	1	0.500	115	6.3

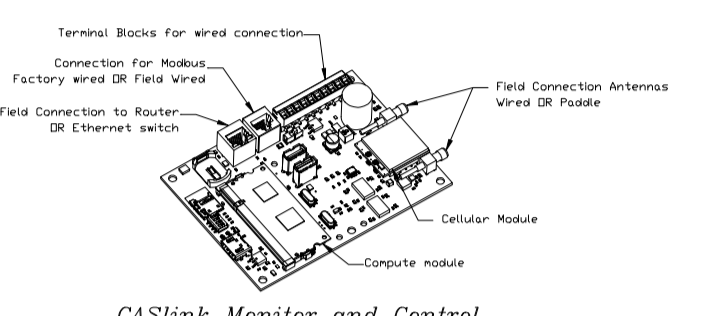


**CASink Monitor and Control**  
 - Hood control panel to support communications to cloud-based Building Management System.  
 - Hood Control Panel to allow cloud-based Building Management System to monitor real time parameters outlined as MONITOR on the points list.  
 - Hood Control Panel to allow cloud-based Building Management System to control parameters outlined as CONTROL on the points list.  
 - Hood Control Panel to allow cloud-based Building Management System to implement SYSTEM RECONFIGURE control strategies for fully integrated Building Management.

**MONITORING AND CONTROL POINTS LIST**

DC Package	Function	DC Package	Function
Room Temperature	MONITOR	Room Temperature(s)	MONITOR
Duct Temperature(s)	MONITOR	Duct Temperature(s)	MONITOR
WMA Discharge Temperature	MONITOR	WMA Discharge Temperature	MONITOR
Exhaust RTV Discharge Temperature	MONITOR	Exhaust RTV Discharge Temperature	MONITOR
Fan Speed	MONITOR	Controlled Fan(s)	MONITOR
Fan Amperage	MONITOR	Fan Fault(s)	MONITOR
Fan Power	MONITOR	Fan Status	MONITOR
RTV Fault(s)	MONITOR	PCV Fault(s)	MONITOR
Controlled Fan(s)	MONITOR	PCV Filter Clip Percentage	MONITOR
Fan Status	MONITOR	Fan Condition	MONITOR
Fan Status	MONITOR	COSE Fan System	MONITOR
PCV Fault(s)	MONITOR	Building Pressure	MONITOR
PCV Filter Clip Percentage	MONITOR	Fan Amperage	MONITOR & CONTROL
Fan Condition	MONITOR	Light(s) On/Off	MONITOR & CONTROL
COSE Fan System	MONITOR	Peak Button	MONITOR & CONTROL
Building Pressure	MONITOR		
Peak Temp Button	MONITOR & CONTROL		
Fan Button	MONITOR & CONTROL		
Light Button	MONITOR & CONTROL		
Peak Button	MONITOR & CONTROL		

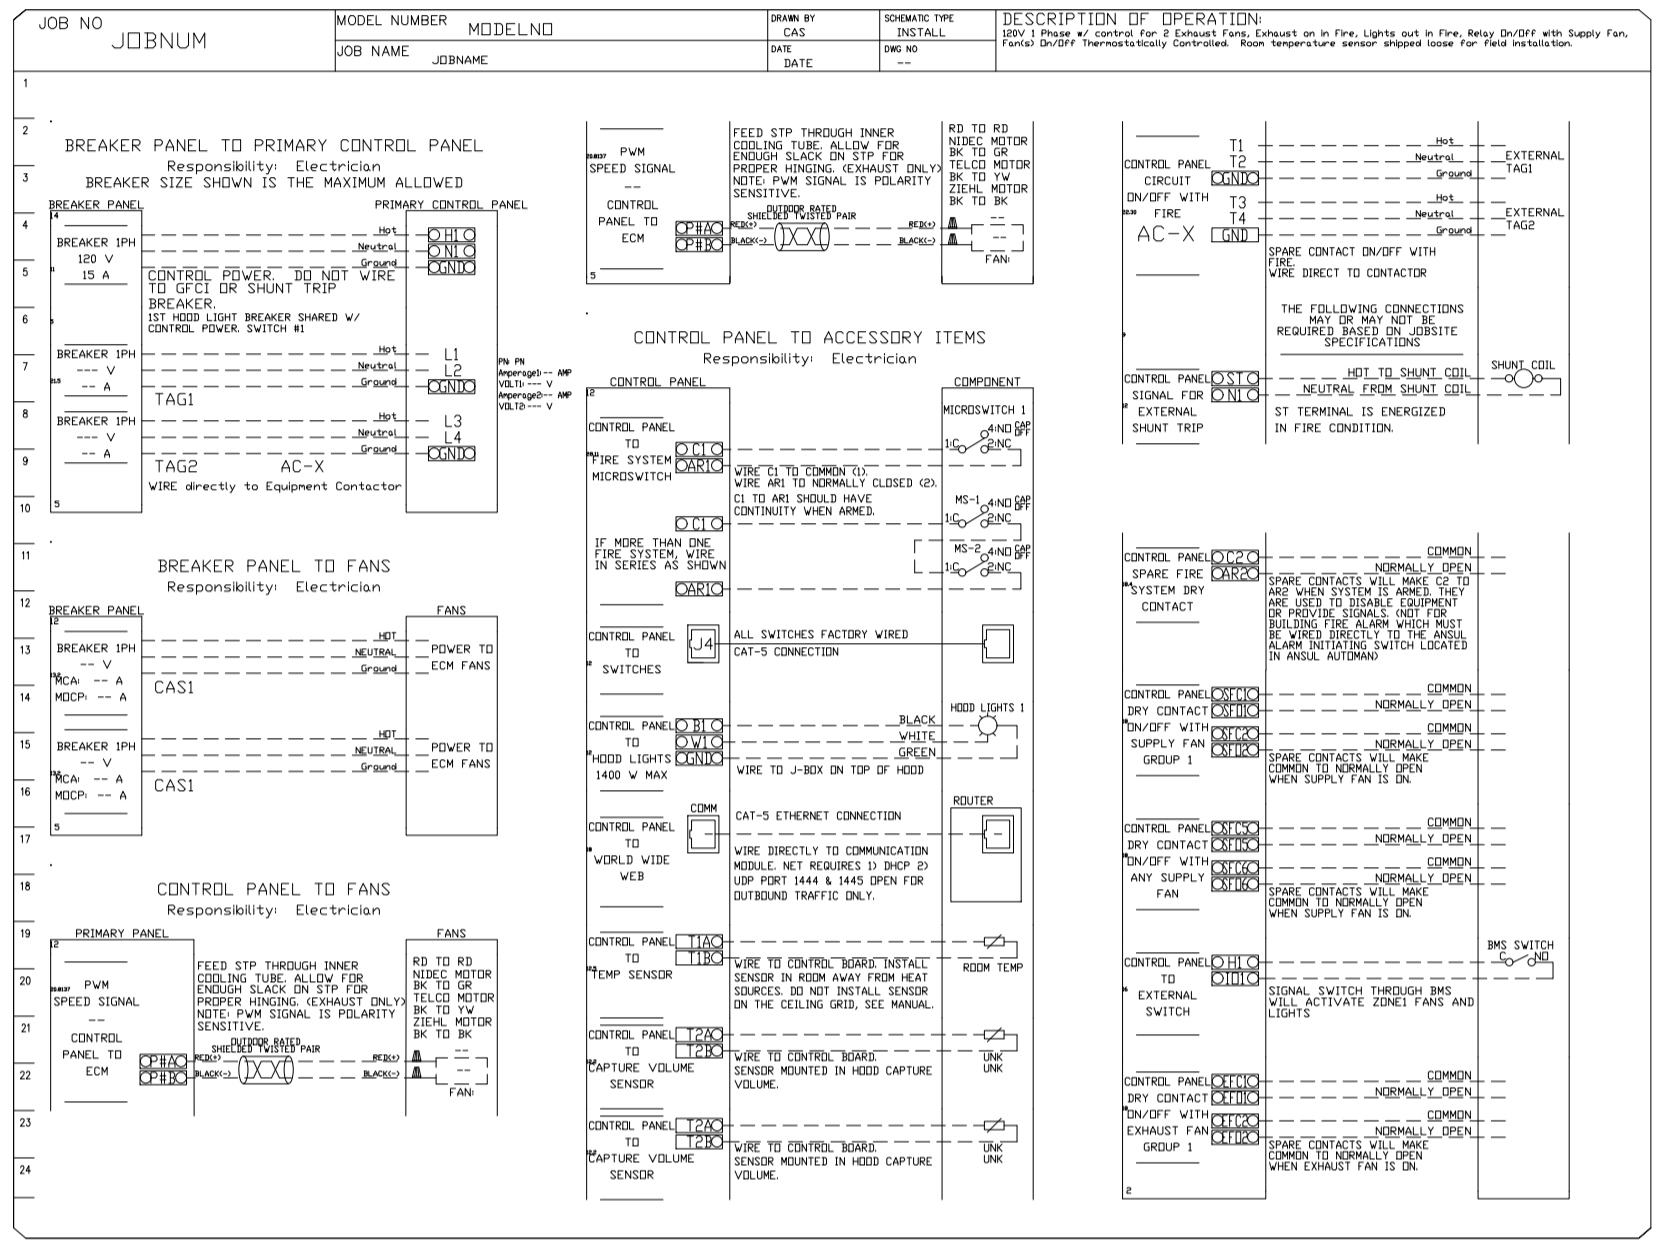


**CONTROL SCHEMATIC - EXHAUST FANS**


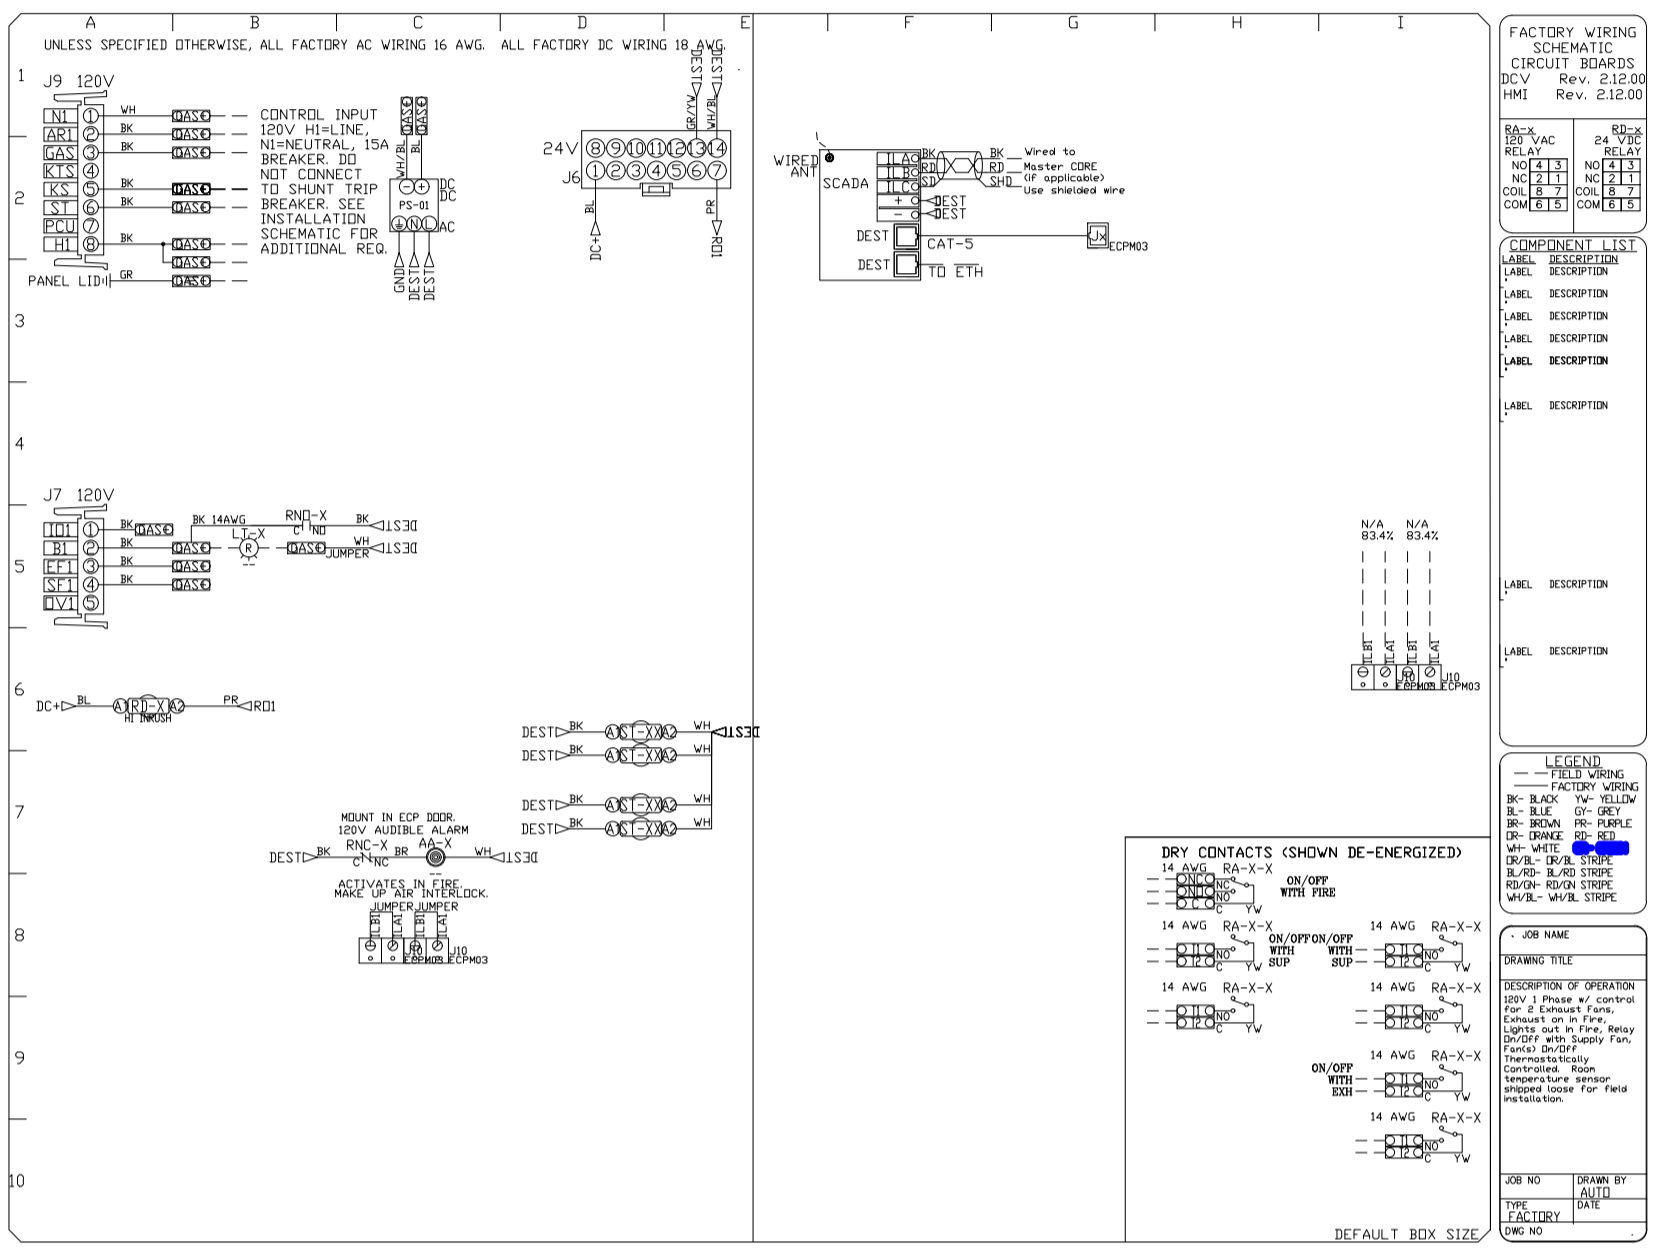


**CONTROL SCHEMATIC - RESTROOM**

**EXHAUST FAN - 12' HOOD**

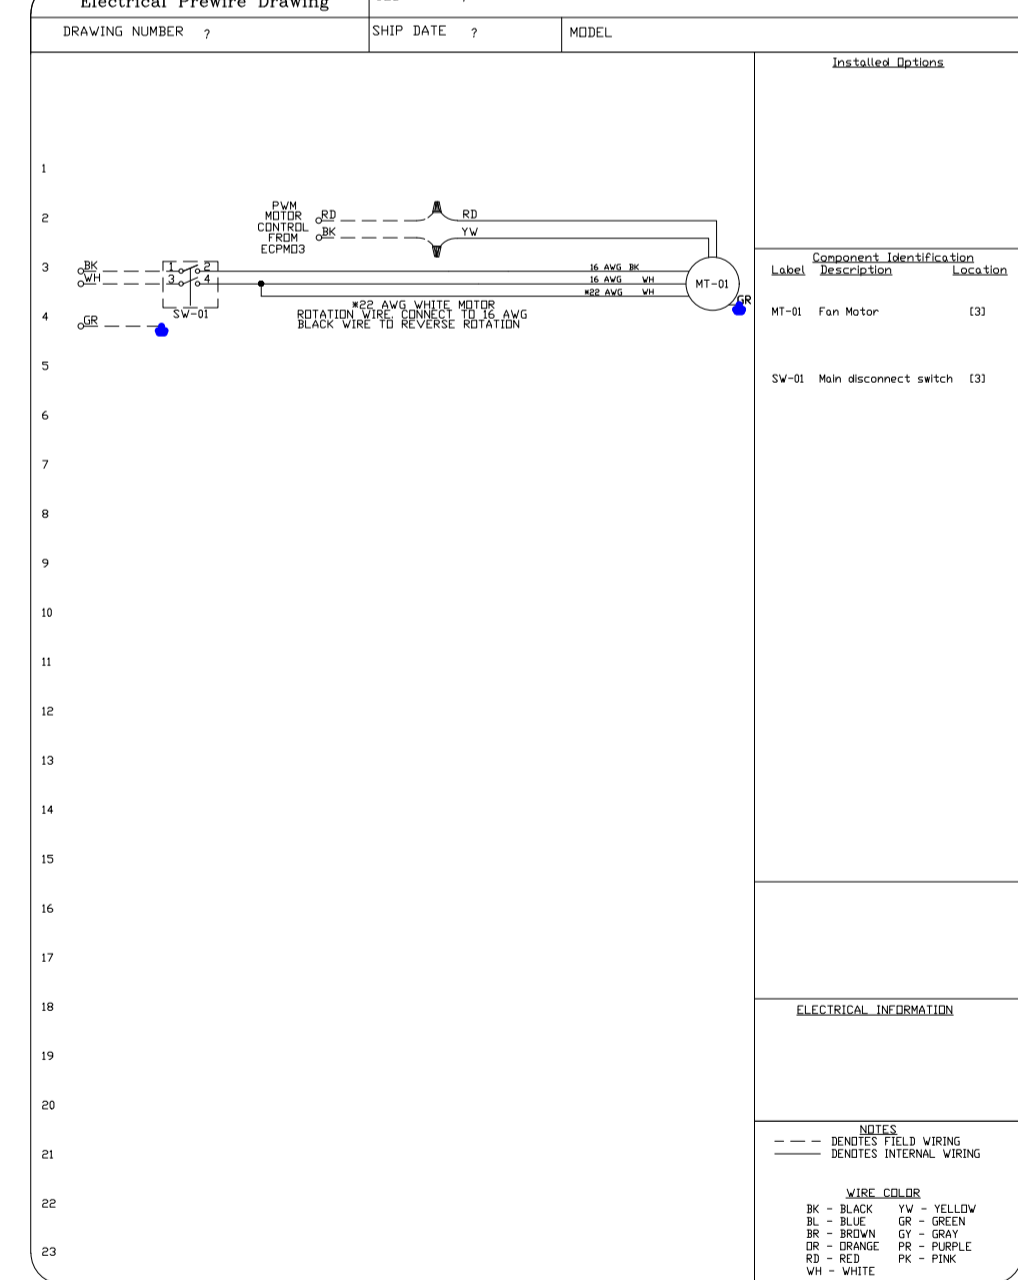

**EXHAUST FAN - RESTROOM**

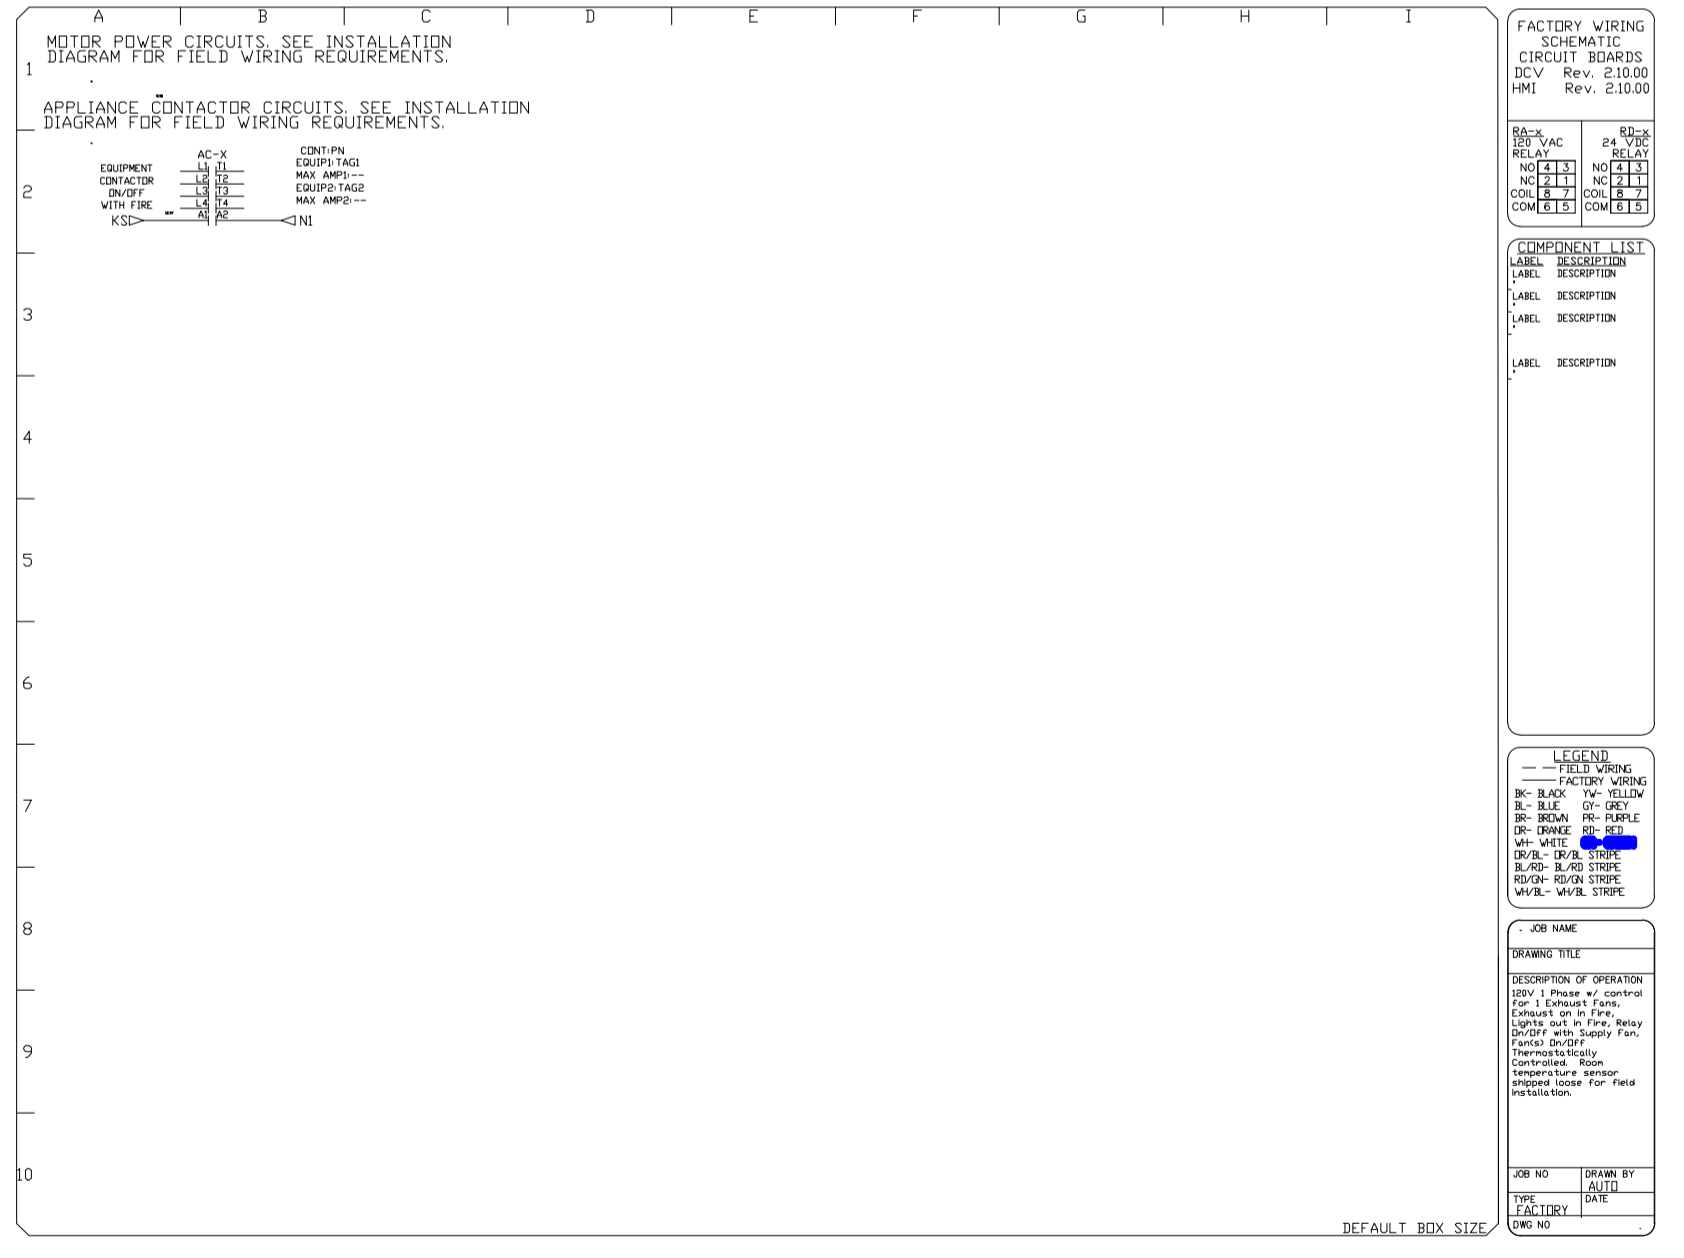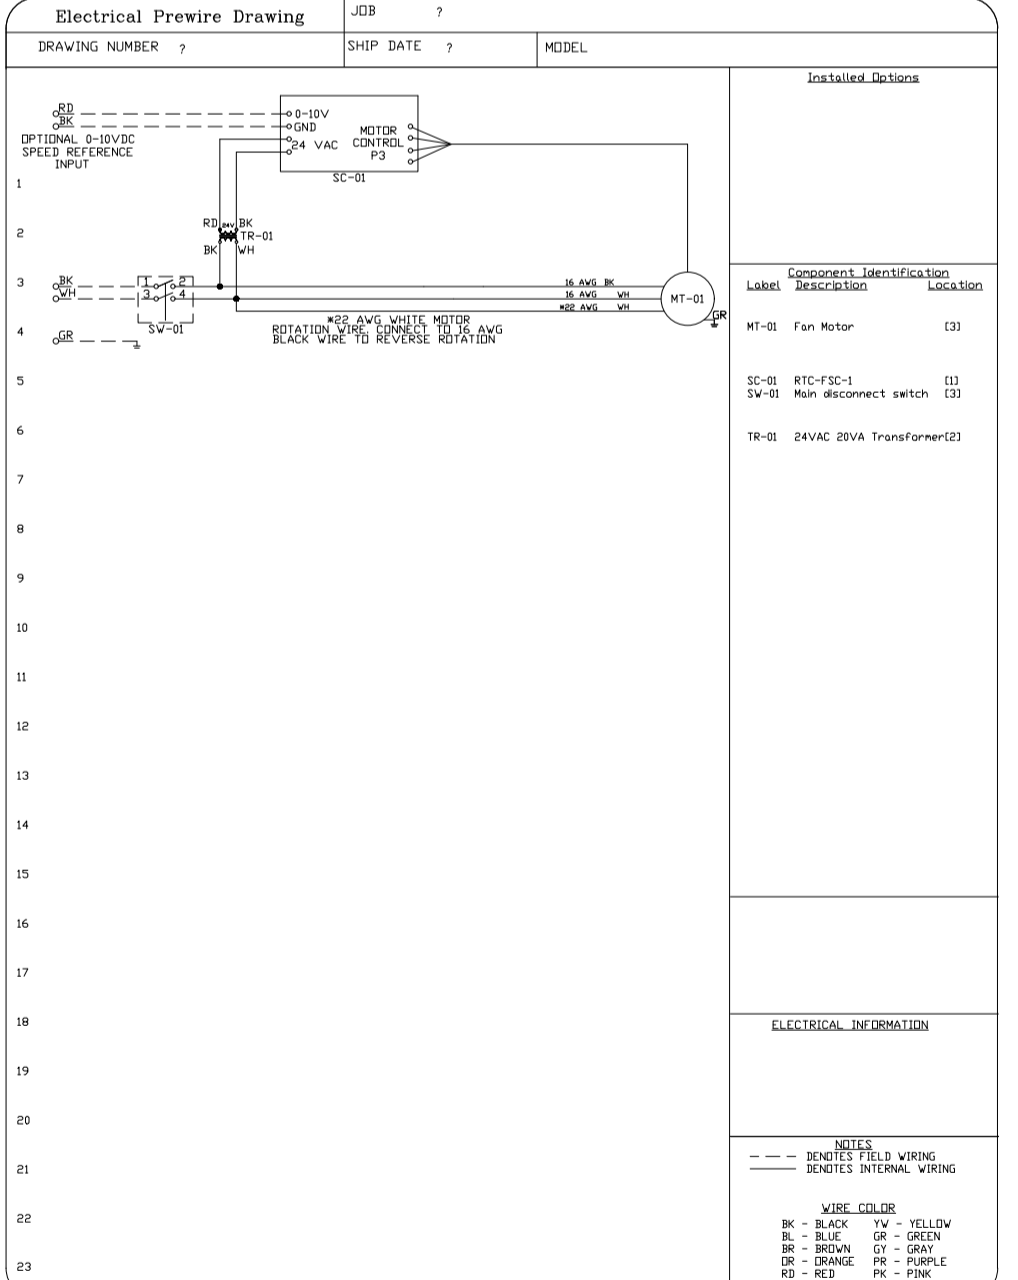

ISSUE TABLE		
No.	Date (mm/dd/yy)	Description
REVISIONS		
No.	Date	Description
1	8/01/2023	RESPONSE TO CITY
DRAWINGS REVISED AS PER DESIGN BULLETIN		
No.	Date	Description

PROJECT NORTH

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8.2.2023

**FRANKE**  
 Franke Foodservice Systems  
 Americas, Inc.  
 800 Aviation Parkway  
 Smyrna, TN USA 37167  
 Tel. +800 472-2954  
 rs\_customerservice.us@franke.com  
 www.frankeusg.com

Company Logo

Project


Account:  
**POPEYES**  
 Restaurant:  
**PLK 2112**  
 Title:  
**WALL MOUNTED INSTALLATION DETAIL**

Site ID:  
 -  
 Operator:  
 -  
 Site Address:  
 -  
 City:  
 -  
 State: Zip Code: Country:  
 -  
 Region:  
 -  
 Building type:  
 -  
 Electrical Service:  
 -  
 Gas Service:  
 -  
 Market Manager:  
 -  
 Franke Project Number:  
 -  
 Created by:  
**HP033**  
 Date Issued:  
**10/01/20**  
 Modified by:  
**AM029**  
 Drawing Scale:  
**AS NOTED**  
 Units:  
**INCHES**  
 Drawing Number:  
**AS NOTED**  
 Sheet Name:  
**3 OF 4**


Drawing Title:  
**MECHANICAL HOOD DRAWINGS**

Drawn	Checked
NI	AH
Scale	Date
1/4" = 1'-0"	JUNE 2023
Project No.	Drawing No.
C22-129	M2.1



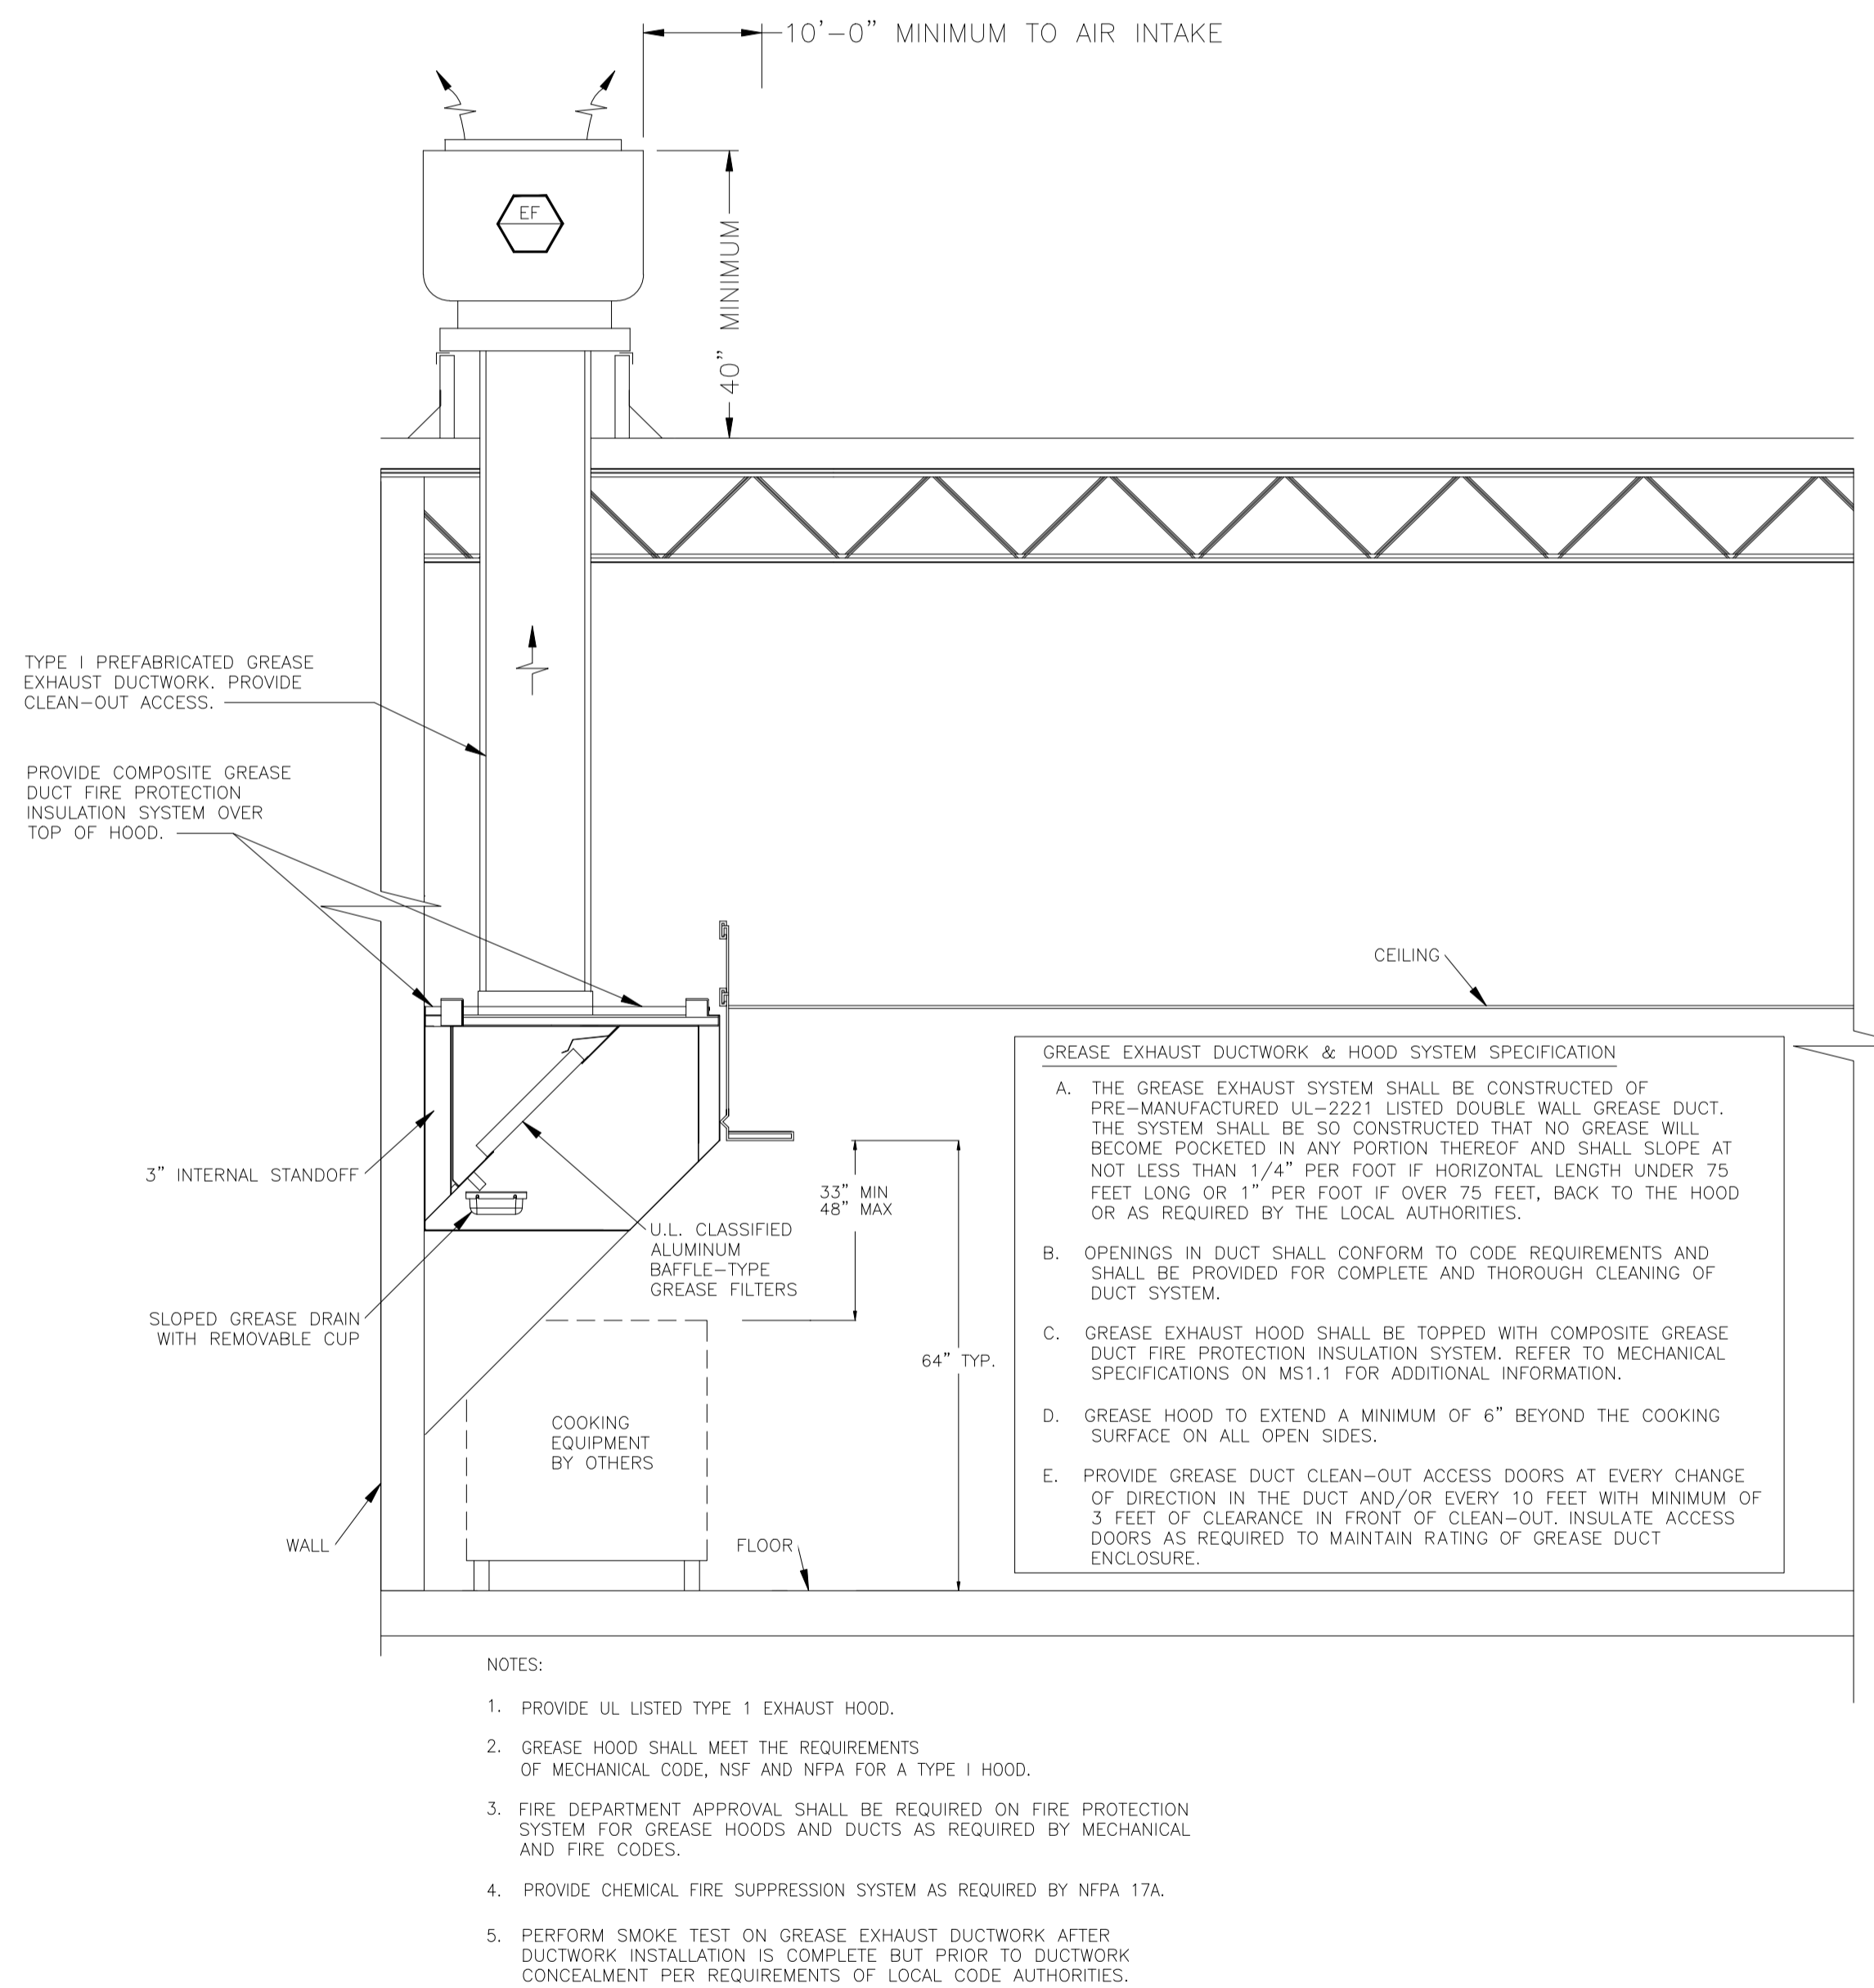


05 KITCHEN HOOD SCHEMATICS  
NOT TO SCALE

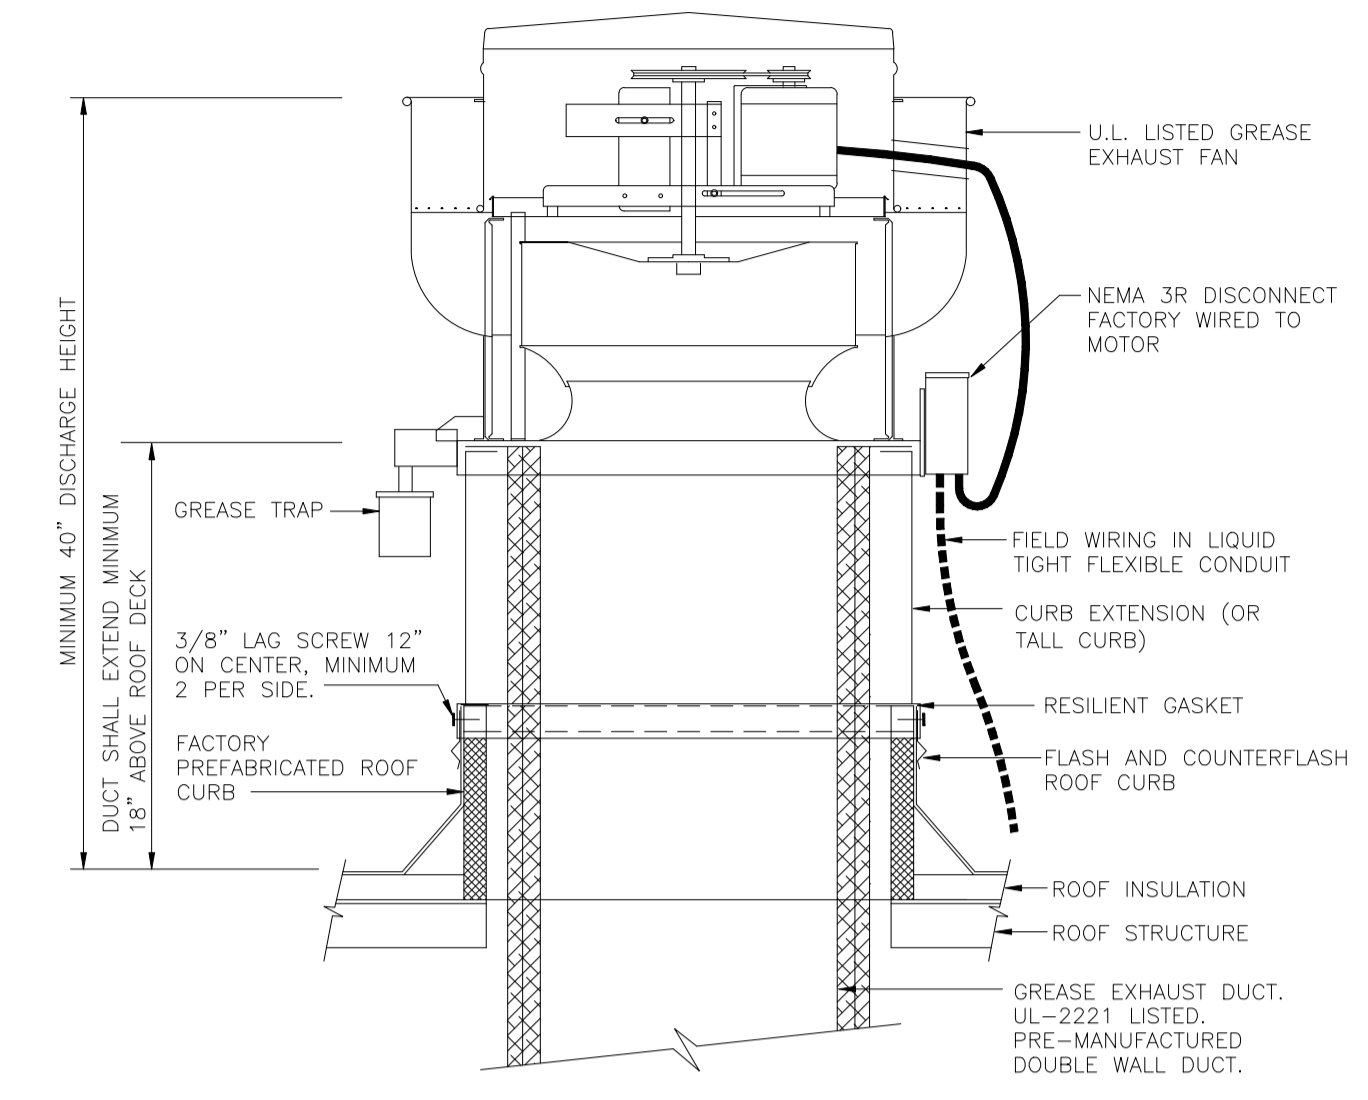


NOTE: INSTALLATION SHALL BE IN ACCORDANCE WITH NFPA 96 REQUIREMENTS.


01 ROOF MOUNTED GREASE EXHAUST FAN DETAIL  
NOT TO SCALE

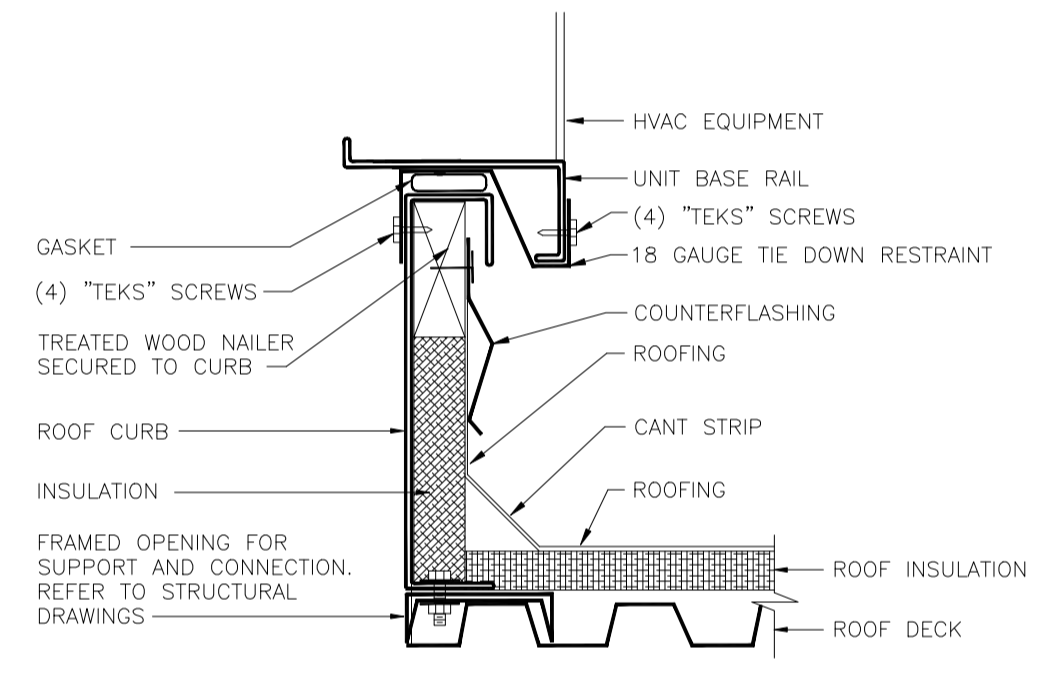

03 ROOFTOP UNIT CURB DETAIL  
NOT TO SCALE

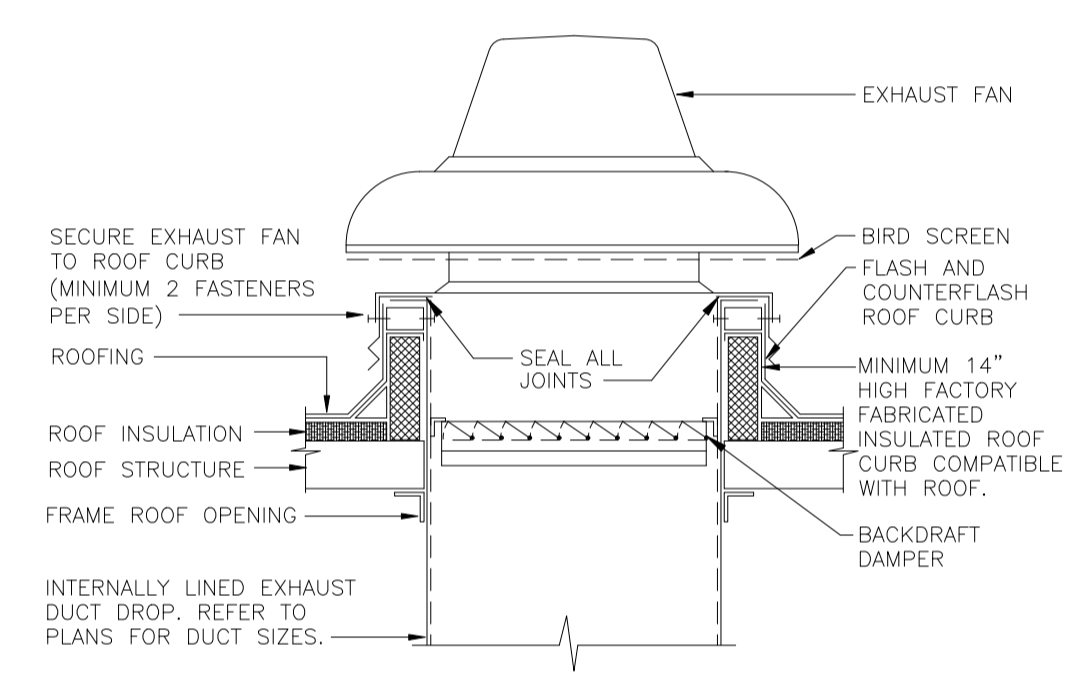

02 EXHAUST FAN DETAIL  
NOT TO SCALE

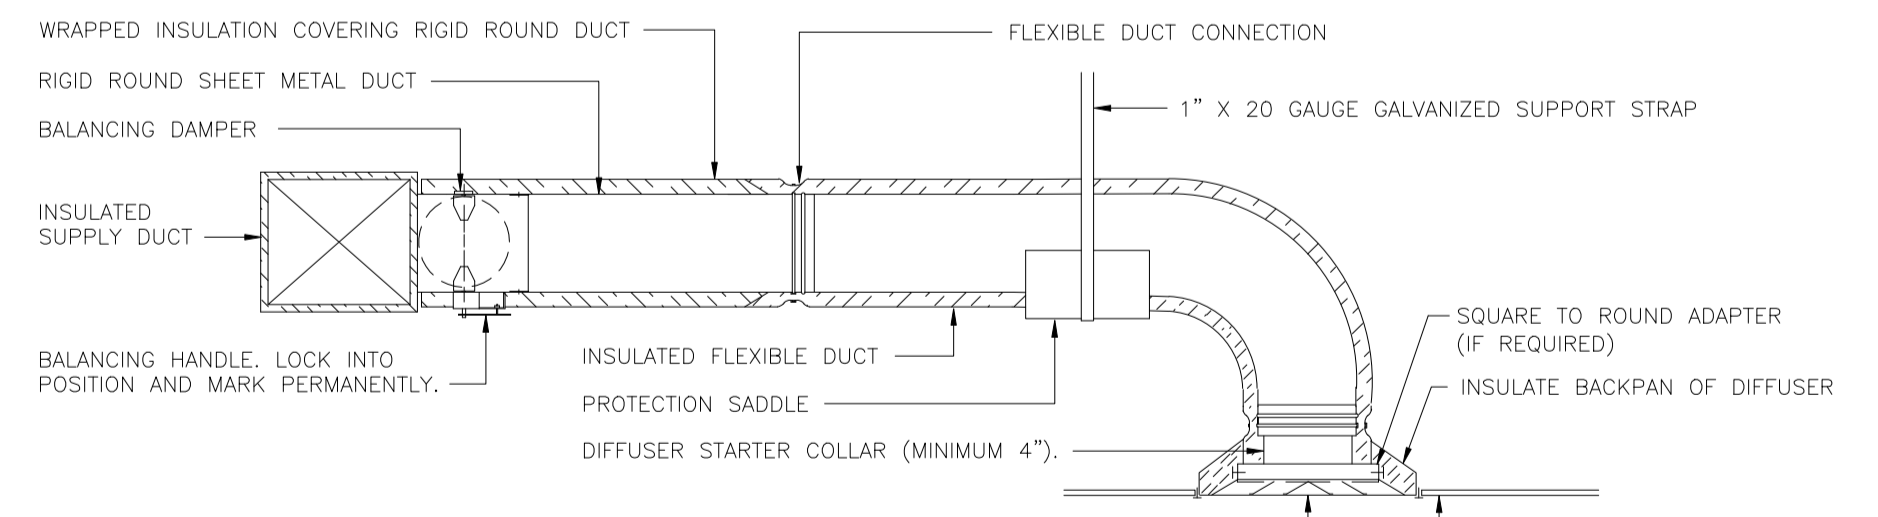

**NOTES:**


- PROVIDE METAL OR "PANDUIT" DRAW BAND AT FLEXIBLE DUCT CONNECTION ON INTERIOR FLEXIBLE DUCT HELIX. SECURE INSULATION OVER DRAW BAND WITH ADDITIONAL DRAW BAND.
- PROVIDE BEADING ON ROUND METAL DUCT 12" OR LARGER IN DIAMETER.
- PROVIDE MINIMUM 4" COLLARS FOR ATTACHMENT OF FLEXIBLE DUCT TO ROUND DUCT, DAMPERS AND DIFFUSERS.
- BAND RIGID ROUND DUCT INSULATION TO DUCT AND PROVIDE TAPE FOR INSULATION OVERLAP.

04 DIFFUSER CONNECTION DETAIL  
NOT TO SCALE

ISSUE TABLE		
No.	Date (mm/dd/yy)	Description


REVISIONS		
No.	Date	Description
1	8/01/2023	RESPONSE TO CITY

DRAWINGS REVISED AS PER DESIGN BULLETIN		
No.	Date	Description

  
**PROJECT NORTH**


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
  
**SEAL 41082**  
 ENGINEER  
 ARCHITECTURE

8.2.2023

Company Logo

  
**THE DIMENSION GROUP**  
 ARCHITECTURE - CIVIL ENGINEERING - MEP ENGINEERING  
10755 SANDHILL ROAD, DALLAS, TEXAS 75238  
 TEL: 214-343-9400 www.dimensiongroup.com

Project

  
**POPEYES**

Store Type  
**US 2112 PROTOTYPE 2112-21**

Location  
**1517 NC 24-87 CAMERON, NC**

Drawing Title  
**MECHANICAL DETAILS**

Drawn	Checked
NI	AH
Scale	Date
1/4" = 1'-0"	JUNE 2023
Project No.	Drawing No.
C22-129	M4.1

POPEYES LOUISIANA KITCHEN MODEL 2112, 1517 NC 24-87, CAMERON, NC (JUNE 01, 2023) STORE NO. C22-129



**GENERAL NOTES**

- A. CONTRACTORS AND SUB-CONTRACTORS SHALL CAREFULLY REVIEW THE CONSTRUCTION DOCUMENTS. INFORMATION REGARDING THE COMPLETE WORK IS DISPERSED THROUGHOUT THE DOCUMENT SET AND CANNOT BE ACCURATELY DETERMINED WITHOUT REFERENCE TO THE COMPLETE DOCUMENT SET.
- B. COORDINATE WITH THE WORK OF OTHER SECTIONS, EQUIPMENT FURNISHED BY OTHERS, REQUIREMENTS OF THE OWNER, AND WITH THE CONSTRAINTS OF THE EXISTING CONDITIONS OF THE PROJECT SITE. PROVIDE PIPE RISERS, DROPS, AND OFFSETS AS REQUIRED FOR FIELD INSTALLATION AND TRADE COORDINATION. NOTIFY ARCHITECT OF ANY DISCREPANCIES BEFORE STARTING WORK.
- C. DRAWINGS FOR PLUMBING WORK ARE DIAGRAMMATIC, SHOWING THE GENERAL LOCATION, TYPE, LAYOUT AND EQUIPMENT REQUIRED. THE DRAWINGS SHALL NOT BE SCALED FOR EXACT MEASUREMENT. REFER TO ARCHITECTURAL DRAWINGS FOR DIMENSIONS. REFER TO MANUFACTURER'S STANDARD INSTALLATION DRAWINGS FOR EQUIPMENT CONNECTIONS AND INSTALLATION REQUIREMENTS. PROVIDE PIPING, CONNECTIONS, FITTINGS, VALVES, OFFSETS AND ALL MATERIALS NECESSARY FOR A COMPLETE SYSTEM.
- D. ALL WORK SHALL COMPLY WITH STATE AND LOCAL CODE REQUIREMENTS AS APPROVED AND AMENDED BY THE GOVERNING CITY AND THE AUTHORITY HAVING JURISDICTION. PURCHASE ALL PERMITS ASSOCIATED WITH THE WORK. OBTAIN ALL INSPECTIONS REQUIRED BY CODE.
- E. PROVIDE WATER HAMMER ARRESTORS THROUGHOUT WATER SYSTEMS AS REQUIRED PER "WATER HAMMER ARRESTERS" DETAIL.
- F. PROVIDE BACKFLOW PREVENTION DEVICES IN WATER LINES FEEDING PLUMBING FIXTURES AND/OR EQUIPMENT AS SHOWN ON PLANS AND ELSEWHERE AS REQUIRED BY AUTHORITY HAVING JURISDICTION. USE DEVICES OF APPROVED MANUFACTURER AND TYPE IN ACCORDANCE WITH REQUIREMENTS OF THE AUTHORITY HAVING JURISDICTION.
- G. CONTRACTOR SHALL VERIFY WATER PRESSURE PRIOR TO CONSTRUCTION. IF PRESSURE AT BUILDING ENTRY PRIOR TO ALL LOCALLY REQUIRED DEVICES IS LESS THAN 60 PSIG STATIC, CONTACT OWNER'S REPRESENTATIVE. IF PRESSURE EXCEEDS 80 PSIG, PROVIDE PRESSURE REDUCING VALVE.
- H. SUSPEND HORIZONTAL SERVICE PIPING FROM UNDERSIDE OF ROOF OR FLOOR STRUCTURE UNLESS OTHERWISE INDICATED. INSTALL PIPING AS HIGH AS POSSIBLE. EXTEND PIPING DOWN IN WALLS, PARTITIONS AND CHASES TO SERVE FIXTURES AND EQUIPMENT.
- I. VERIFY SERVICE CONNECTION POINTS, SIZES, ELEVATIONS AND METERING LOCATIONS FOR PROJECT WITH LOCAL UTILITY COMPANIES AND/OR CIVIL ENGINEER, AS APPLICABLE.
- J. WATER ENTRY SERVICE PIPING, NEW AND/OR REVISED, CONTRACTOR SHALL ENSURE AND PROVIDE MINIMUM 10'-0" LINEAR FEET OF METAL PIPING MATERIAL BELOW GRADE IN CONTACT WITH EARTH FOR CONNECTION OF ELECTRICAL SERVICE GROUNDING.
- K. PLUMBING CONTRACTOR SHALL EXECUTE ALL WORK SO THAT IT PROCEEDS WITH A MINIMUM OF INTERFERENCE.
- L. FLOOR DRAINS SHALL HAVE 6" DEEP SEAL TRAPS.
- M. PLUMBING CONTRACTOR SHALL BE RESPONSIBLE FOR CONNECTING WATER SUPPLY TO THE COFFEE MAKERS, TEA BREWERS, AND ICE MACHINES.
- N. WRAP ALL CONDENSATE PIPE IN FREEZER WITH HEAT TRACING TAPE AND INSULATE ALL CONDENSATE DRAIN PIPING, ROUTE COOLER CONDENSATE DRAIN PIPING TO HUB DRAIN/FLOOR DRAIN AS INDICATED.
- O. POT SINKS SHALL BE ANCHORED TO WALL AND SEALED WITH SILICONE CAULKING.
- P. INSTALL GAS VALVE (FBC) IN GAS LINE TO COOKING EQUIPMENT, INTERLOCK WITH HOOD FIRE PROTECTION SYSTEM. VERIFY REQUIREMENTS WITH HOOD SUPPLIER. INSTALL UNIONS AT THE SOLENOID VALVE.
- Q. PROVIDE SHUTOFF COCKS, QUICK DISCONNECTS AND FLEXIBLE LINES AT GAS EQUIPMENT.
- R. PROVIDE VACUUM BREAKERS AT FIXTURES WITH HOSE THREAD CONNECTIONS.
- S. PROVIDE DIELECTRIC UNIONS AT ALL DISSIMILAR METAL PIPE CONNECTIONS.
- T. LAVATORY FAUCETS SHALL LIMIT HOT WATER FLOW TO 0.5 GPM AND HOT WATER TEMPERATURE TO 110° F.
- U. PROVIDE 1"Ø SCH 40 BLACK STEEL PIPE FOR GREASE DISCHARGE. RUN LINE FLUSH ON WALL BESIDE FRYERS, VERTICALLY UP IN WALL THROUGH CEILING. SLOPE LINE @ 1"/FT TOWARDS REAR OF BUILDING. RUN LINE DOWN THROUGH CEILING ON FACE OF EXTERIOR WALL TO 75" AFT THEN THROUGH REAR WALL FOR DISCHARGE. HEAT TAPE SHALL BE INSTALLED ON ENTIRE LINE @ 5 WATTS/LINEAR FT. G.C. TO PROVIDE STAINLESS STEEL COVERS FOR LINE MOUNTED FLUSH ON WALLS (ENTIRE LENGTH - CEILING DOWN).

**PLUMBING SYMBOLS LEGEND**

**ABBREVIATIONS:**

AFF/AFG	ABOVE FINISHED FLOOR/GRADE
FFCO/FGCO/WCO/CO	FLUSH FLOOR/FLUSH GRADE/WALL/CLEANOUT
FSEC	FOOD SERVICE EQUIPMENT CONTRACTOR
TYP	TYPICAL
VTR	VENT THRU ROOF
(E)	EXISTING

**LINETYPES:**

-----	EXISTING PLUMBING LINE - SEE DRAWING
----	COLD WATER (CW)
-----	COLD WATER (CW) - BELOW SLAB/GRADE
—FW—	FILTERED WATER SUPPLY (FW)
----	HOT WATER (HW) 140'
-----	HOT WATER RETURN (HWR)
—G—	NATURAL GAS LINE
----	CONDENSATE LINE (D)
----	PLUMBING VENT (V)
-----	PLUMBING VENT (V) - BELOW SLAB/GRADE
----	SANITARY WASTE (SAN) - BELOW SLAB/GRADE
—GW—	GREASE WASTE (GW) - BELOW SLAB/GRADE
----	WATER HEATER VENT
-----	SODA CHASE
----	USED COOKING OIL
-----	STORM LINE (ST)
—OST—	OVERFLOW STORM LINE (OST)

**GENERAL REFERENCES/NOTATIONS:**

01/P1	DETAIL OR SECTION		REVISION
	CONNECT TO EXISTING		PLAN NOTE
	HVAC EQUIPMENT		FOOD SERVICE EQUIPMENT

**PIPE SYMBOLS:**

	PIPE UP/DOWN		BALL/PLUG VALVE
	TEE UP/DOWN		BALANCING/CHECK VALVE
	END CAP		

**SYMBOLS LEGEND NOTES:**  
REFER TO SPECIFICATIONS AND PLAN NOTES FOR DETAILED DESCRIPTION OF ALL DEVICES SHOWN IN THIS SCHEDULE, PROVIDED BY THIS CONTRACTOR.

**PLUMBING FIXTURE SCHEDULE**

SYMBOL	FIXTURE TYPE	MANUF.	MODEL	DESCRIPTION	ACCESSORIES/OPTIONS
WC	WATER CLOSET (ACCESSIBLE)	AMERICAN STANDARD	3043.001 "MADERA"	FLOOR MOUNT, WHITE VITREOUS CHINA, 1.1-1.6 GPF ELONGATED SIPHON JET BOWL, 1-1/2" TOP SPUD, & RIM HEIGHT 17" A.F.F. PROVIDE WITH SLOAN MANUAL DUAL FLUSH 1.6/1.1 GPF WATER CLOSET FLUSH VALVE. PROVIDE FLUSH LEVER ON ACCESSIBLE SIDE. INSTALL IN ACCORDANCE TO ADA ACCESSIBILITY REQUIREMENTS.	MAINLINE #ML1055SSC00 WHITE OPEN FRONT ELONGATED TOILET SEAT LESS COVER.
LAV	LAVATORY (ACCESSIBLE)	AMERICAN STANDARD	#0356.921.020 LUCERNE	WALL HUNG, 20"x18" WHITE VITREOUS CHINA, BACK OVERFLOW. PROVIDE WITH SLOAN EBF-650 4" CENTER SET, BATTERY POWERED SENSOR FAUCET WITH FACTORY SET 0.175 GPC 0.35 GPM AERATOR. INSTALL IN ACCORDANCE TO ADA ACCESSIBILITY REQUIREMENTS.	PROVIDE WITH QUARTER TURN BRASS ANGLE COMPRESSION STOPS WITH LOOSE KEY HANDLES, STAINLESS BRAIDED SUPPLIES, CHROME ESCUTCHEONS, CHROME GRID STRAINER DRAIN WITH TAILPIECE, & CHROME PLATED CAST BODY P-TRAP WITH CLEANOUT. INSULATE WASTE AND WATER PIPING WITH TRUEBRO "LAY-GUARD2" #101-EZ. FURNISH WITH ZURN #Z-1231-81 LAVATORY CARRIER.
FPWH	FROST PROOF WALL HYDRANT	WOODFORD	MODEL 65	ANTI-SIPHON, AUTOMATIC DRAINING, WALL HYDRANT, NON-FREEZE INTEGRAL VACUUM BREAKER, ALL BRONZE INTERIOR PARTS, KEY OPERATED, 3/4" SOLDER INLET.	MOUNT 18" ABOVE FINISHED GRADE. PROVIDE APPROPRIATE MODEL FOR WALL THICKNESS AND SITE SPECIFIC TEMPERATURE REQUIREMENTS.
ID	TRENCH DRAIN	ZURN	Z886-SOG	6-1/4"x24" HOPE TRENCH DRAIN WITH STAINLESS DECORATIVE GRATE. FIELD CUT TRENCH DRAIN AS REQUIRED. COORDINATE FINISHED WIDTH AND LOCATION WITH ARCHITECT PRIOR TO INSTALLATION.	SET TRENCH DRAIN LEVEL WITH FINISH FLOOR.
FD	FLOOR DRAIN	SIOUX CHIEF / ZURN	832-35D-NR / #Z1415-B-3NH	FLOOR DRAIN WITH 5" ROUND NICKEL BRONZE ADJUSTABLE STRAINER & 3" BOTTOM OUTLET.	PROVIDE WITH TRAP PRIMER CONNECTION AND WITH ASSE 1072 APPROVED TRAP SEAL DEVICE. TRAP SEAL DEVICE SHALL BE TRAP PROSET TRAPGUARD OR APPROVED EQUAL. INSTALL PER MANUFACTURER'S RECOMMENDATIONS. PROVIDE DRAINS IN CUSTOMER AREAS WITH VANDAL RESISTANT SCREWS.
ES	FLOOR SINK	SIOUX CHIEF / ZURN	#861-3PN-D / #Z1900-3NH-K-4	12" SQUARE TOP FLOOR SINK W/8" DEEP & 3" BOTTOM OUTLET	SET FLOOR SINK LEVEL WITH FINISH FLOOR.
RD	ROOF DRAIN	WATTS	RD-250	CAST IRON COMBINATION ROOF DRAIN/OVERFLOW WITH DECK FLANGE, FLASHING CLAMPS WITH INTEGRAL GRAVEL GUARD, OVERFLOW STANDPIPE, SELF LOCKING CAST IRON DOME, AND NO HUB OUTLETS. PROVIDE OUTLET SIZE AS SHOWN ON PLANS.	INSTALL PER MANUFACTURER'S INSTALLATION INSTRUCTIONS. UNDERDECK CLAMP AND SUMP RECEIVER - FIELD VERIFY ROOF INSTALLATION REQUIREMENTS AND COORDINATE INSULATION THICKNESS.
DSN	DOWNSPOUT NOZZLE	WATTS	Z199	ALL NICKEL BRONZE BODY WITH DECORATIVE FACE OF WALL FLANGE AND OUTLET NOZZLE.	COORDINATE MOUNTING LOCATION WITH ARCHITECTURAL ELEVATIONS.
IP	TRAP PRIMER	PPP	P1-500	AUTOMATIC OPERATION 1/2" INLET AND OUTLET. SERVICE UP TO FOUR FLOOR DRAINS WITH DISTRIBUTION UNIT.	INSTALL IN ACCESSIBLE LOCATION WITH PRIMER LOCATED MINIMUM OF 6" ABOVE FLOOD LEVEL OF FLOOR DRAIN RIM. PROVIDE ACCESS PANEL AS REQUIRED.
MV	MIXING VALVE	SYMMONS	7-225-CK "MAXLINE"	1/2" INLETS AND OUTLET, THERMOSTATIC CONTROLLER WITH INTEGRAL CHECKS, ALL BRASS BODY WITH DUAL STAINLESS STEEL STRAINER, VANDAL RESISTANT TEMPERATURE ADJUSTMENT HANDLE.	SET TO 105°F. MOUNT IN ACCESSIBLE LOCATION.

**TANK ELECTRIC WATER HEATER SCHEDULE**

SYMBOL	MANUFACTURER	MODEL	KW (BTU)	V/PH	GPH @ 60°F RISE	SET POINT (°F)	NOTES (#)
WH-1	RHEEM	ES120-24-G	24 (81,893)	208/3	70	120	(1), (2), (3)

**NOTES:**

- WATER HEATER TANK SHALL HAVE A WORKING PRESSURE OF 150PSI, PER MANUFACTURER'S REQUIREMENTS.
- FURNISH WITH EXPANSION TANK AS SPECIFIED ON PLANS.
- PROVIDE WITH 1-1/2" COLD WATER AND HOT WATER LINES

**EXPANSION TANK SCHEDULE**

SYMBOL	MANUFACTURER	MODEL	TOTAL VOLUME (GALLONS)	ACCEPTANCE VOLUME (GALLONS)	CONNECTION LOCATION	CONNECTION SIZE	MOUNTING	NOTES (#)
EI	AMTROL	ST-5	2	.45	TOP	3/4"	NEAR WH-1	(1), (2)

**NOTES:**

- EXPANSION TANK: STEEL SHELL, HEAVY DUTY BUTYL NSF/ANSI 61, FACTORY PRECHARGED TO 40 PSIG. MAX OPERATING TEMPERATURE 100', MAX OPERATING PRESSURE 150 PSI, 1 YEAR MANUFACTURER'S WARRANTY. INSTALL PER MANUFACTURER'S INSTRUCTIONS.
- FIELD CHARGE EXPANSION TANK TO SYSTEM PRESSURE BEFORE CONNECTION TO DOMESTIC WATER SYSTEM. FIELD VERIFY PRESSURE REQUIREMENTS.

**PUMP SCHEDULE**

SYMBOL	MANUFACTURER	MODEL	GPM	HEAD (FT)	VOLTAGE	PHASE	WATTS	AMPS	NOTES (#)
RCP	GRUNDFOS	ALPHA2	5	12	115	1	5 - 65	0.65	(1)

**NOTES:**

- RECIRCULATING PUMP: BRONZE BODY RECIRCULATING PUMP WITH "AUTOADAPT" VARIABLE SPEED MOTOR. INSTALL NEAR WATER HEATER PER MANUFACTURER'S INSTRUCTIONS. PROVIDE WITH ALPHA 3-PRONG PLUG AND COORDINATE CONNECTION WITH ELECTRICAL CONTRACTOR. PROVIDE WITH HONEYWELL L6006C SURFACE MOUNT AQUASTAT SET TO 5°F BELOW WATER HEATER OPERATING TEMPERATURE.

**HEAT TRACING**

SYMBOL	MANUFACTURER	MODEL	TEMP	LENGTH (MAX)	VOLTAGE	PHASE	WATTS/FOOT	AMP (MAX)	NOTES (#)
HC	RAYCHEM	8XL2-CR/CT	105°F	350	208	1	8	15	(1), (2)

**NOTES:**

- SELF-REGULATING HEATING CABLE TO MAINTAIN TEMPERATURE OF USED COOKING OIL LINE. REFER TO PLANS FOR ROUTING. MAXIMUM CIRCUIT LENGTH IS 350'-0" OF CABLE. 208-1V AT 8W/FT (2800 WATT / 15 AMP MAX).
- PROVIDE WITH EC-W-GF CONTROLLER WITH GROUND FAULT PROTECTION, AND NECESSARY COMPONENTS TO PUT IN WORKING ORDER. INSTALL CABLE PER MANUFACTURER'S RECOMMENDATIONS.

**FOODSERVICE PLUMBING SCHEDULE**

ID	DESCRIPTION	REMARKS
A10.30	MULTIPLE FRYER SYSTEM, GAS	
A24.U2	MULTIPLE FRYER SYSTEM, GAS	
A35.00	1 COMPARTMENT SINK	
A35.10	PRE-RINSE FAUCET ASSEMBLY	
C10.32	POPEYES DUAL SIDE SANDWICH PREP	
D29.00	PACKING TABLE, DOUBLE SIDED	
D40.00	3 COMPARTMENT SINK	
D40.01	PRE-RINSE FAUCET ASSEMBLY	
D50.00	DISHWASHER	
D70.00	HOT WATER DISPENSER	
D81.00	REETHERMALIZER	
E10.00	WALK-IN COOLER/FREEZER	
E30.84	CHICKEN CRATE	
H10.00	DUAL LINE PRODUCTION COUNTER	
K10.00	ICE MAKER, CUBE-STYLE	
K11.00	ICE MAKER, CUBE-STYLE	
K15.00	ICE BIN	
K20.00	WATER FILTER SYSTEM	
K40.00	GREASE TANK	
K41.00	CO TANK	
K42.00	BAG N BOX	
K71.00	TEA BREWER	
N10.00	HAND SINK	
N20.00	MOP SINK	

THIS SCHEDULE IS A PARTIAL LISTING OF THE EQUIPMENT SUPPLIED BY THE FOOD SERVICE EQUIPMENT CONTRACTOR (FSEC). REFER TO FSEC DRAWINGS FOR A COMPLETE LISTING OF EQUIPMENT, TYPES, SIZES, AND LOCATIONS. PLUMBING CONTRACTOR (PC) TO PROVIDE NECESSARY ITEMS TO INSTALL FSEC EQUIPMENT (INCLUDING VALVES, UNIONS, FITTINGS, ETC.) TO MAKE COMPLETE SYSTEM. THIS LISTING DOES NOT SUPERSEDE THE FSEC DRAWINGS.

**BACKFLOW PREVENTER SCHEDULE**

LOCATION	TAG	MODEL	ASSE
MAIN WATER SUPPLY	BPZ	WATTS 0090TS	1013
CARBONATOR	DCV-1	WATTS SD-3	1022
SODA DISPENSERS	DCV-2	WATTS SD-2	1032
OTHER EQUIPMENT	DCV-3	WATTS SERIES 7	1024

**NOTE:** VERIFY BACKFLOW VALVE REQUIREMENTS AND APPROVAL FOR ALL EQUIPMENT WITH AUTHORITIES HAVING JURISDICTION PRIOR TO INSTALLATION.

**GRAVITY GREASE INTERCEPTOR SIZING**

FIXTURE	QTY	FLOW RATE (30 MIN)	TOTAL	FLOW RATE (15 MIN)	TOTAL
FLOOR DRAIN	4	0.00	0.00	0.00	0.00
FLOOR SINK	3	7.50	22.50	3.75	11.25
MOP BASIN	1	140.25	140.25	70.13	70.13
THREE COMP SINK	1	450.00	450.00	30.00	30.00

TOTAL FIXTURE FLOW RATE (30 MIN) 612.75  
 TOTAL FIXTURE FLOW RATE (15 MIN) 103.88  
 PIPE SIZE FLOW RATE (4 IN) 75

[[CU IN / 231] = GAL X 0.75 / 2 MIN = 2 MIN FLOW RATE]

NUMBER OF SEATS	GREASE PRODUCTION (LBS OF FOG)
22	116.0
AVG. MEALS PER SEAT PER DAY	4
FAST FOOD - FULL PREP	0.035
(HIGH / NO FLATWARE: 0.035 LBS PER SERVING)	
DAYS BETWEEN PUMP OUTS	90
[SERVINGS PER DAY X GREASE PRODUCTION VALUE X DAYS BETWEEN PUMP-OUTS = GREASE OUTPUT]	

**ISSUE TABLE**

No.	Date (mm/dd/yy)	Description
1	8/01/2023	RESPONSE TO CITY

**REVISIONS**

No.	Date	Description
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**DRAWINGS REVISED AS PER DESIGN BULLETIN**

No.	Date	Description
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TEL: 214-343-9400 www.thedimensiongroup.com

Project

**POPEYES**

Store Type

**US 2112 PROTOTYPE  
2112-21**


Location

**1517 NC 24-87  
CAMERON, NC**

Drawing Title

**PLUMBING SCHEDULES &  
NOTES**


Drawn	Checked
NI	AH
Scale	Date
1/4" = 1'-0"	JUNE 2023
Project No.	Drawing No.
C22-129	P1.1

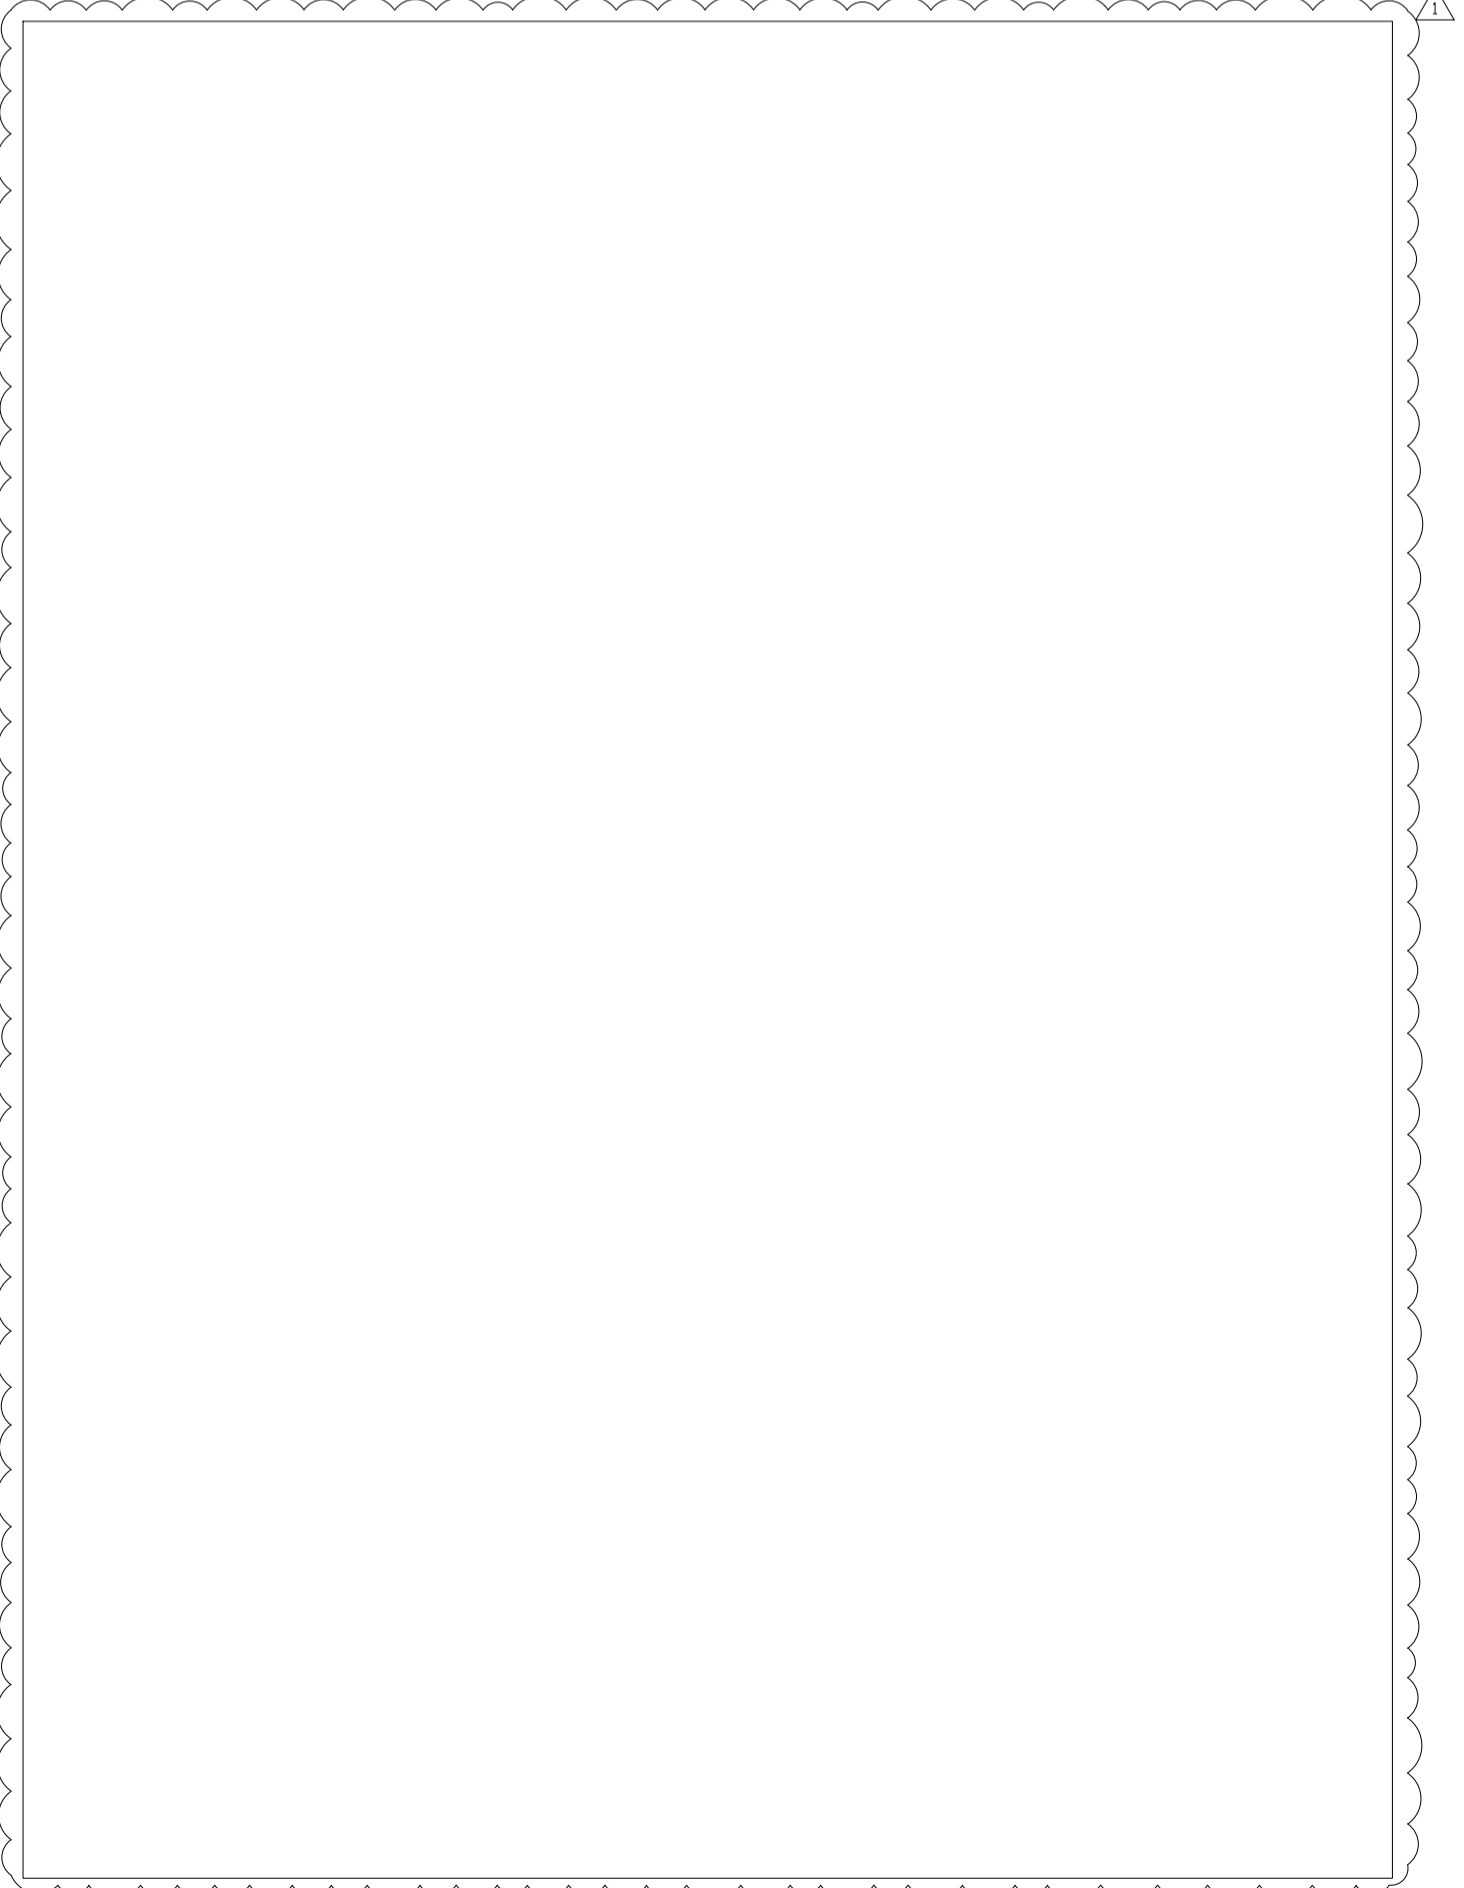

**HOT WATER DEMAND CALCULATIONS**

FIXTURE	QTY	LENGTH (IN)	WIDTH (IN)	DEPTH (IN)	VOLUME (N³)	GPH (@37.5%)	
3-COMPARTMENT SINK	1	20	15	14	12600	20.45	
		MANF. RATE (GPM)	WATER USAGE (GPH)	STD. RATE (GPM)	GPH	COMBINED GPH	
PRE-RINSE SPRAYER	2	1.15	32	2.5	14.72	29.44	
LAVATORY	1	0.5	5	2.2	1.14	1.14	
HAND SINK	3	2.2	5	2.2	5.0	15.0	
PREP SINK	1	2.2	5	2.2	5.0	5.0	
MOP SINK	1	---	---	---	15.0	15.0	
DISHWASHER	1	---	---	---	29.6	29.6	
					<b>TOTAL GPH</b>	<b>115.63</b>	
*HOT WATER USE REDUCTION CALCULATIONS: GPH = (MANF. RATE x WATER USAGE VALUE) / STD. RATE							
	<b>TOTAL GPH</b>	<b>TEMP RISE (°F)</b>	<b>BTU/(LB * °F)</b>	<b>LB/GAL</b>	<b>ELEC EFFICIENCY</b>	<b>BTU/KW-H</b>	<b>MINIMUM KW</b>
	115.63	70	1,002	8.33	98%	3412	20.2

POPEYES LOUISIANA KITCHEN MODEL 2112, 1517 NC 24-87, CAMERON, NC (JUNE 01, 2023) STORE NO. C22-129

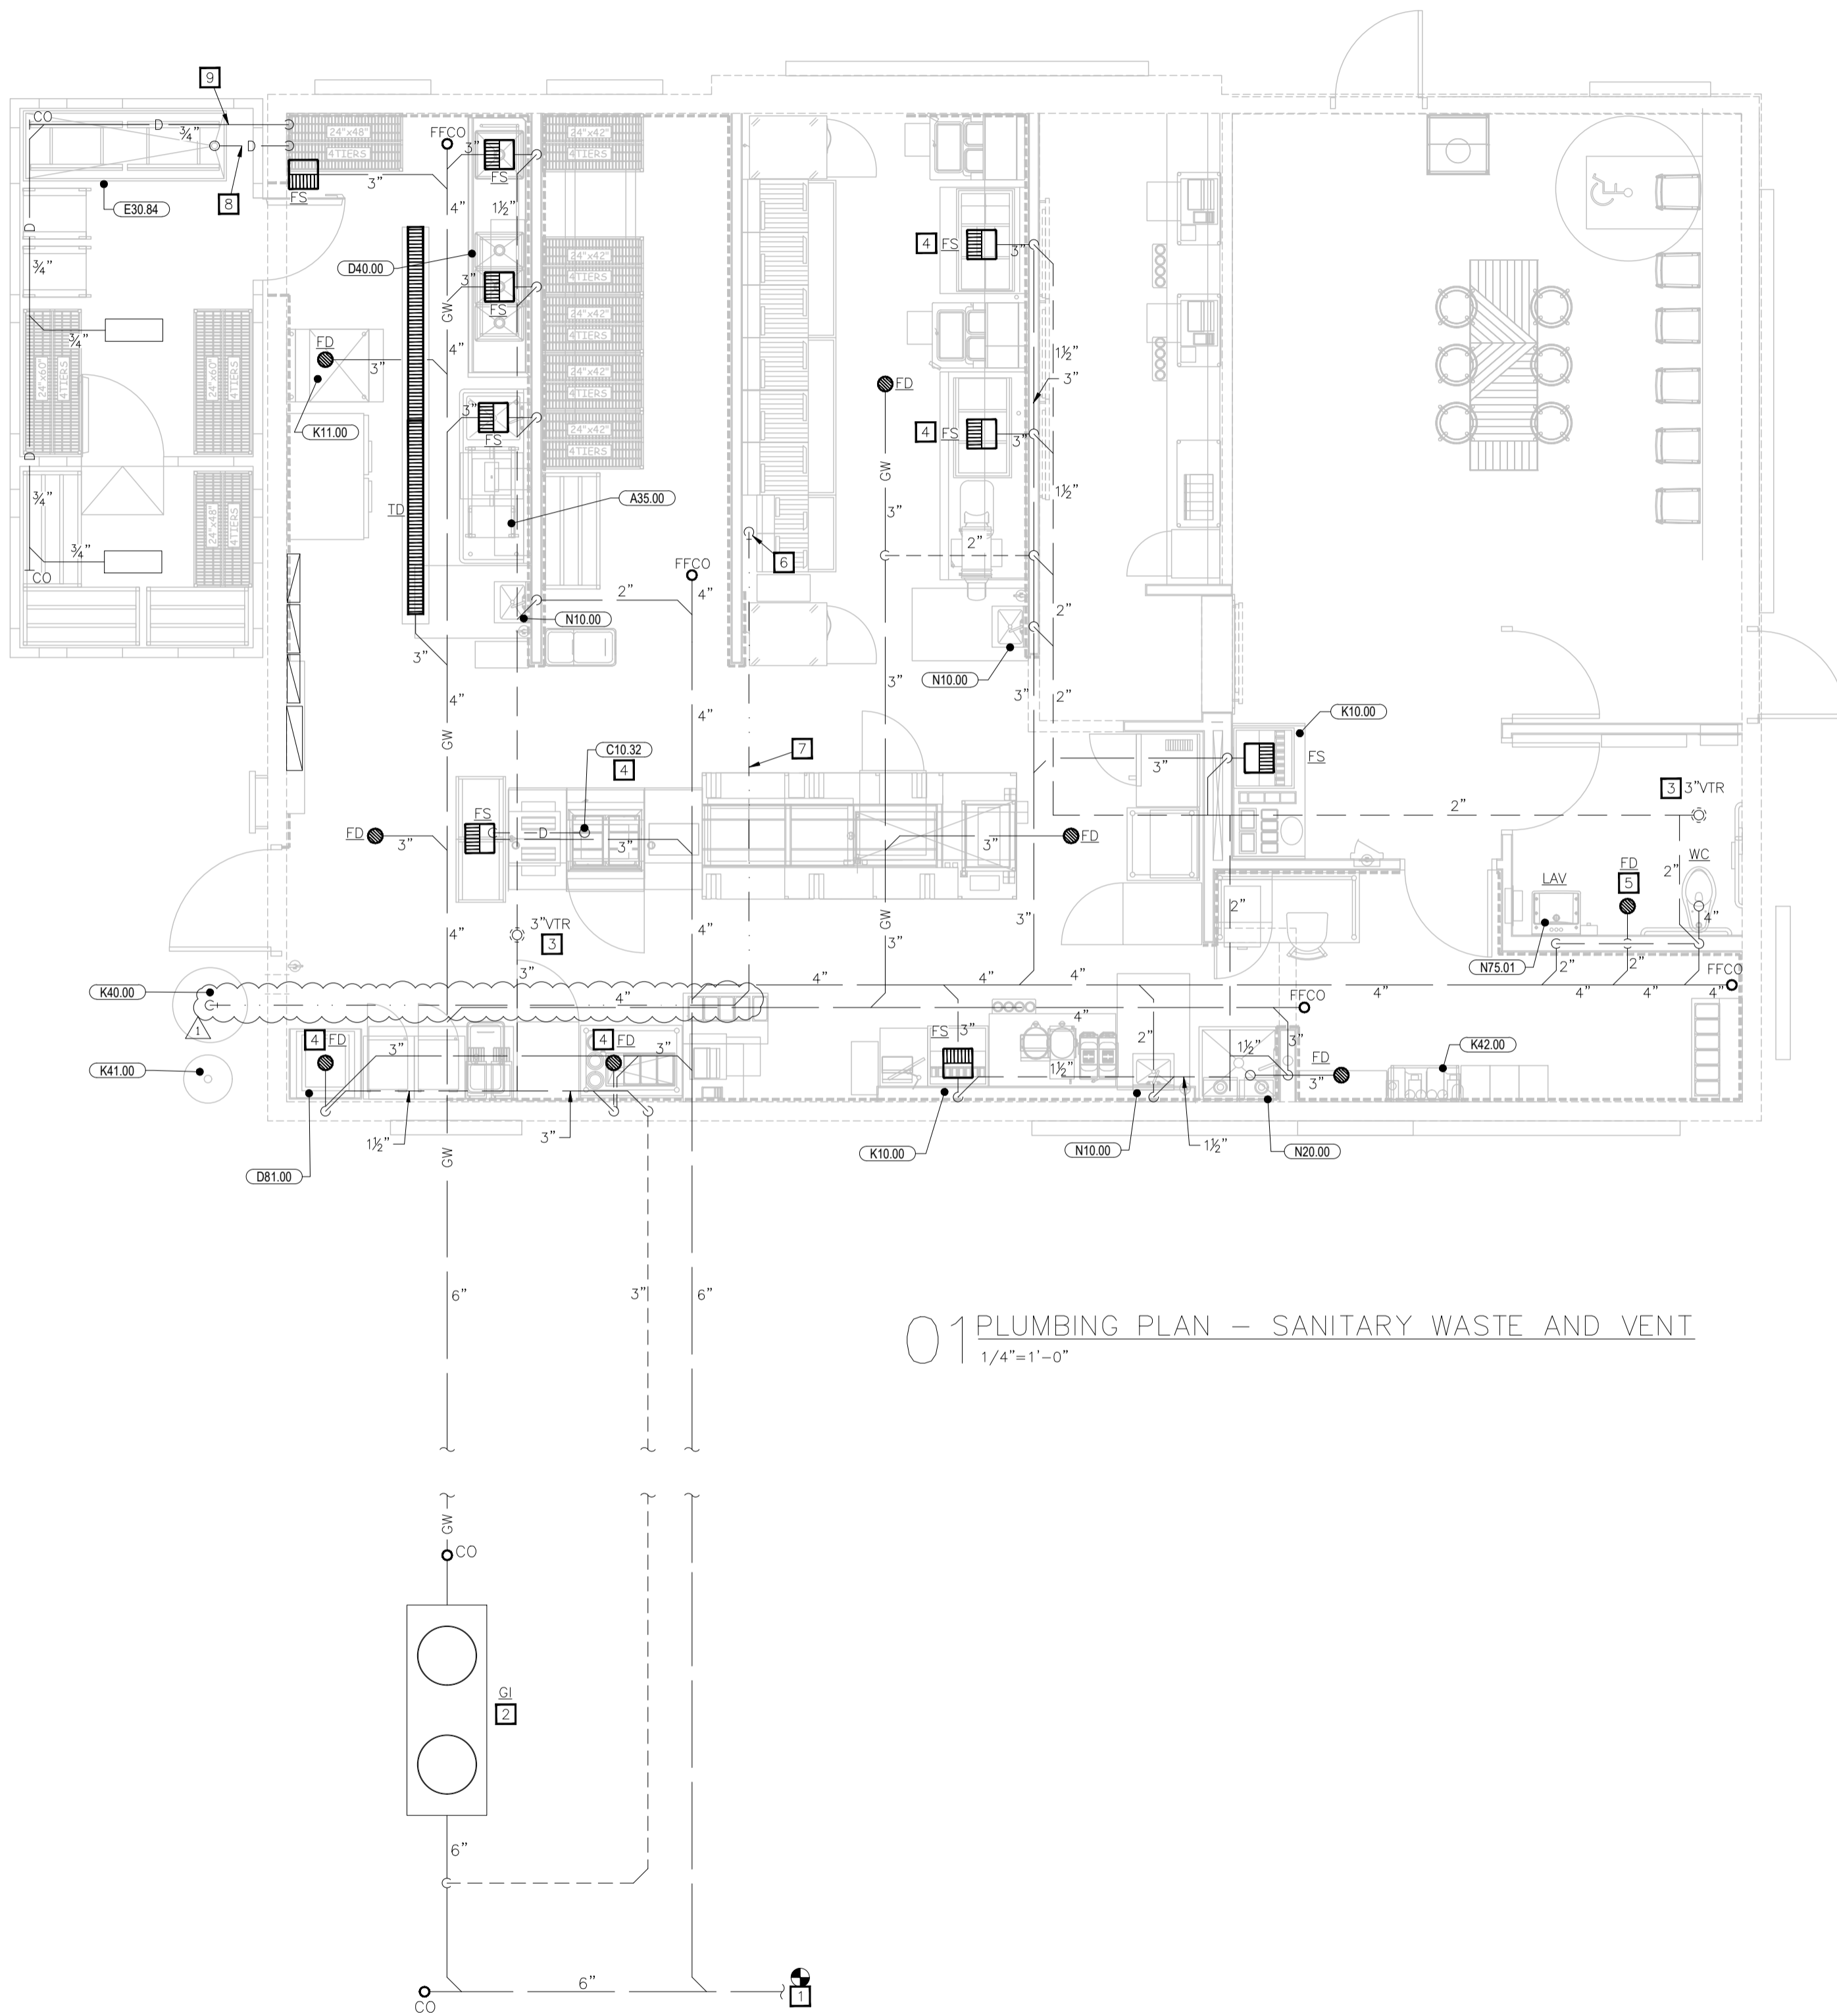

01 PLUMBING PLAN - SANITARY WASTE AND VENT  
1/4"=1'-0"

PLUMBING KEY NOTES

- 1 CONNECT TO SANITARY WASTE LINE ON EXTERIOR OF BUILDING PROVIDED BY OTHERS. REFER TO CIVIL DRAWINGS FOR CONTINUATION.
- 2 PROVIDE 1500 GALLON GREASE INTERCEPTOR AS SHOWN PER PLANS. REFER TO "GREASE INTERCEPTOR" DETAIL. LOCATE INTERCEPTOR OUTSIDE OF DRIVE LANES. COORDINATE WITH CIVIL DRAWINGS FOR FINAL LOCATION.
- 3 PROVIDE SANITARY VENT THROUGH ROOF AS SHOWN PER PLAN PER "VENT THRU ROOF (VTR)" DETAIL. LOCATE VENT MINIMUM OF 10'-0" AWAY FROM AIR INTAKES ON ROOF, UNLESS APPROVED BY ENGINEER PRIOR TO INSTALLATION.
- 4 PROVIDE DRAIN LINE FROM KITCHEN EQUIPMENT TO FLOOR SINK. REFER TO KITCHEN EQUIPMENT PLANS.
- 5 EMERGENCY DRAIN IN RESTROOM SHALL BE INSTALLED FLUSH TO GRADE WITH NO SLOPE. COORDINATE INSTALLATION HEIGHT WITH GENERAL CONTRACTOR TO ENSURE PROPER INSTALLATION.
- 6 USED COOKING OIL LINE MOUNTED FLUSH AGAINST WALL @ 3'-0" AFF. REFER TO "USED COOKING OIL RECOVERY" DETAIL. G.C. SHALL PROVIDE STAINLESS STEEL COVER TO CEILING.
- 7 PROVIDE HC HEAT TRACE TAPE ON USED COOKING OIL LINE FROM BUILDING TO TANK. INSTALL HEAT TRACE PER MANUFACTURER'S RECOMMENDATIONS. REFER TO PLUMBING FIXTURE SCHEDULE FOR MORE INFORMATION.
- 8 EXTEND CHICKEN VAT'S 2" COPPER INDIRECT WASTE LINE THROUGH COOLER WALL TO DISCHARGE INTO FLOOR SINK.
- 9 ROUTE FREEZER/COOLER CONDENSATE DRAIN TO FLOOR SINK PER "WALK-IN COOLER/FREEZER DRAIN" DETAIL.


DFU CALCULATIONS

FIXTURE	QTY.	DFU	TOTAL
WATER CLOSET	1	4	4
LAVATORY	1	1	1
MOP BASIN	1	3	3
HAND SINK	3	1	3
3" FLOOR SINK	9	5	45
3" TRENCH DRAIN (EMERGENCY)	1	-	-
2"/3" FLOOR DRAIN (EMERGENCY)	7	-	-
*DFU VALUES PER IPC*		DFU TOTAL	56.0

ISSUE TABLE		
No.	Date (mm/dd/yy)	Description

REVISIONS		
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1	8/01/2023	RESPONSE TO CITY

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No.	Date	Description

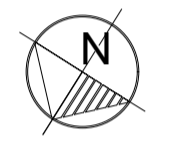

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Project


Store Type  
US 2112 PROTOTYPE  
2112-21

Location  
**1517 NC 24-87  
CAMERON, NC**

Drawing Title  
**PLUMBING PLAN -  
SANITARY WASTE AND  
VENT**

Drawn NI	Checked AH
Scale 1/4" = 1'-0"	Date JUNE 2023
Project No. C22-129	Drawing No. P2.1

POPEYES LOUISIANA KITCHEN MODEL 2112, 1517 NC 24-87, CAMERON, NC (JUNE 01, 2023) STORE NO. C22-129

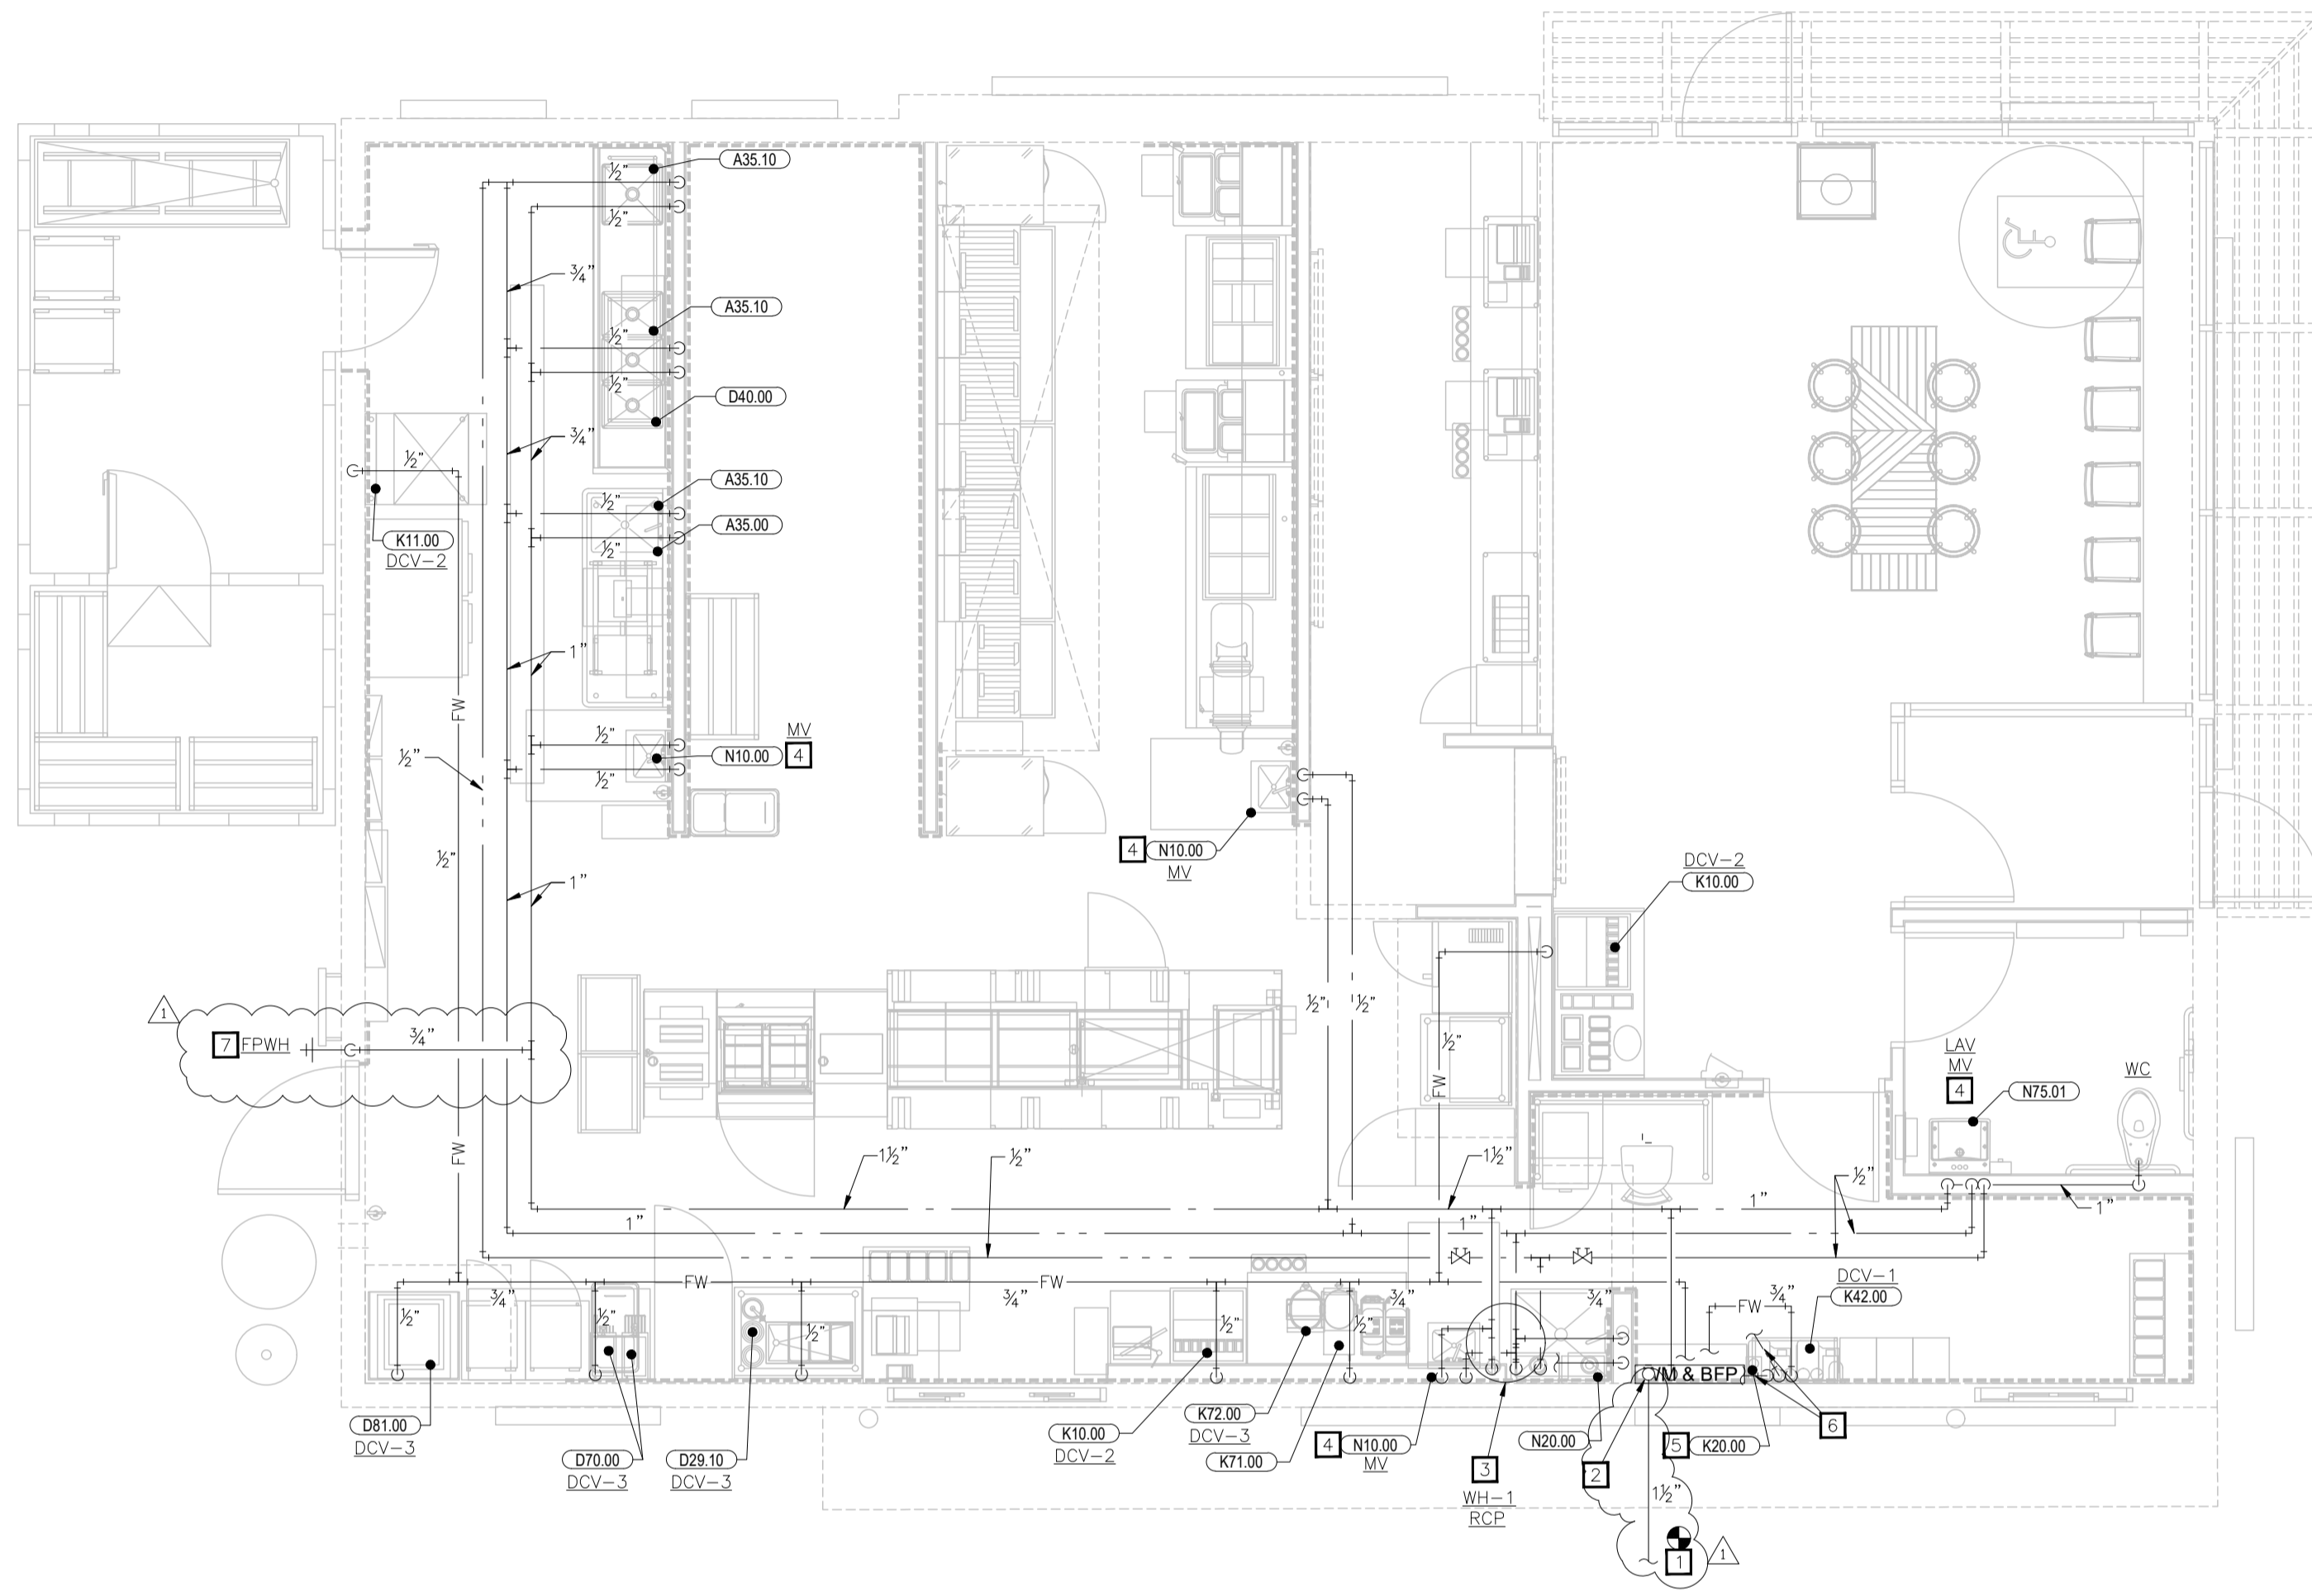

01 PLUMBING PLAN - DOMESTIC WATER  
1/4" = 1'-0"

### PLUMBING KEY NOTES

- 1 CONNECT TO DOMESTIC WATER SERVICE 5'-0" OUTSIDE BUILDING PROVIDED BY OTHERS. REFER TO CIVIL DRAWINGS FOR CONTINUATION.
- 2 PROVIDE WATER SERVICE ENTRANCE AS SHOWN PER PLANS. REFER TO "DOMESTIC WATER SERVICE ENTRY" DETAIL.
- 3 ROUTE 1" HW, 1" CW AND 3/4" HWR LINES TO WATER HEATER, EXPANSION TANK, AND RECIRCULATING PUMP AS SHOWN PER PLANS AND PER "TANK ELECTRIC WATER HEATER", "RECIRCULATION PUMP", AND "SMALL EXPANSION TANK" DETAILS. DISCHARGE T&P RELIEF VALVE AND OVERFLOW TO FLOOR DRAIN PER "INDIRECT DRAIN" DETAIL. PROVIDE VALVE AND UNION ON INLET AND OUTLET. PROVIDE BALANCING VALVES AS REQUIRED FOR RECIRCULATING SYSTEM.
- 4 PROVIDE INDIVIDUAL MIXING VALVE FOR ALL HAND SINKS AND LAVATORIES IN AN ACCESSIBLE LOCATION.
- 5 WATER FILTER MOUNTED ON WALL. STUB-OUT WATER SUPPLY @ 8'-4" A.F.F. REFER TO "WATER FILTER" DETAIL.
- 6 BEVERAGE CONDUIT ABOVE CEILING TO DRINK STATION. REFER TO "BEVERAGE CONDUIT - ABOVE SLAB" DETAIL.
- 7 MOUNT FREEZE-PROOF WALL HYDRANT 18" ABOVE FINISHED GRADE. VERIFY EXACT LOCATION WITH ARCHITECTURAL ELEVATIONS.

### WSFU CALCULATIONS

FIXTURE	QTY.	WSFU	TOTAL
WATER CLOSET (FLUSH)	1	10	10
LAVATORY	1	2	2
MOP BASIN	1	3	3
HAND SINK	3	2	6
1-COMP SINK	1	3	3
3-COMP SINK	1	3	3
WAREWASH	1	3	3
BEVERAGE STATION	2	2	4
ICE MAKER	3	1	3
HOT WATER DISPENSER	2	1	2.0
TEA BREWER	1	1	1.0
*WSFU VALUES PER IPC*		WSFU TOTAL	40.00

### WATER CALCULATION

CRITICAL ELEVATIONS AND DISTANCES:	FEET
ELEVATION OF CONTROLLING FIXTURE (WH-1,2,3)	6.0
ELEVATION OF FINISHED FLOOR	0.0
ELEVATION OF WATER MAIN CONNECTION	-4.0
VERTICAL DIST. FROM WATER MAIN CONNECTION TO CONTROLLING FIXTURE	10.0
SYSTEM PRESSURE REQUIREMENTS:	PSI
ELEVATION (VERTICAL DISTANCE) X 0.434 PSI/FT	4.3
PRESSURE NEEDED AT CONTROLLING FIXTURE	35
BACKFLOW PREVENTER: 1-1/2" (INTERIOR**)	10.0
WATER METER: 1-1/2" (INTERIOR**)	8.0
TOTAL	39.3
PIPE RUNS:	FEET
EXTERIOR, MAIN TO BUILDING ENTRY (VERIFY**)	200
INTERIOR, ENTRY TO CONTROLLING FIXTURE	42
INTERIOR, VERTICAL RISE	10.0
ALLOWANCE FOR FITTINGS, ETC. (LENGTH X 0.25)	13.0
TOTAL	265.0
SYSTEM PRESSURE DATA:	PSI
MINIMUM SYSTEM PRESSURE REQUIRED AT MAIN (VERIFY**)	65.0
SYSTEM PRESSURE REQUIRED FOR SYSTEM	39.3
PRESSURE AVAILABLE FOR (PIPING) FRICTION LOSS	25.7
PIPE SIZING:	PSI/100'
PRESSURE AVAILABLE X 100 / (TOTAL PIPE RUN)	9.7

\* NOTE: ALL PIPING IS SIZED FOR 5 PSI/100' PRESSURE LOSS  
 \*\* NOTE: FIELD VERIFY SYSTEM PRESSURE, LINE SIZES, BACKFLOW LOCATION, AND METER LOCATION PRIOR TO STARTING WORK. NOTIFY ENGINEER IMMEDIATELY IF SYSTEM PRESSURE IS LOWER THAN REQUIRED PRESSURE OR ANY CONDITIONS EXIST THAT CONFLICT WITH INFORMATION SHOWN ABOVE.

### ISSUE TABLE


No.	Date (mm/dd/yy)	Description

### REVISIONS

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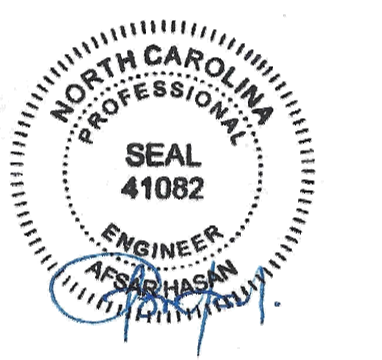
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
  
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Project

  
**POPEYES**

Store Type

US 2112 PROTOTYPE  
2112-21

Location


**1517 NC 24-87  
CAMERON, NC**

Drawing Title

**PLUMBING PLAN -  
DOMESTIC WATER**

Drawn	Checked
NI	AH
Scale	Date
1/4" = 1'-0"	JUNE 2023
Project No.	Drawing No.
C22-129	P2.2

POPEYES LOUISIANA KITCHEN MODEL 2112, 1517 NC 24-87, CAMERON, NC (JUNE 01, 2023) STORE NO. C22-129

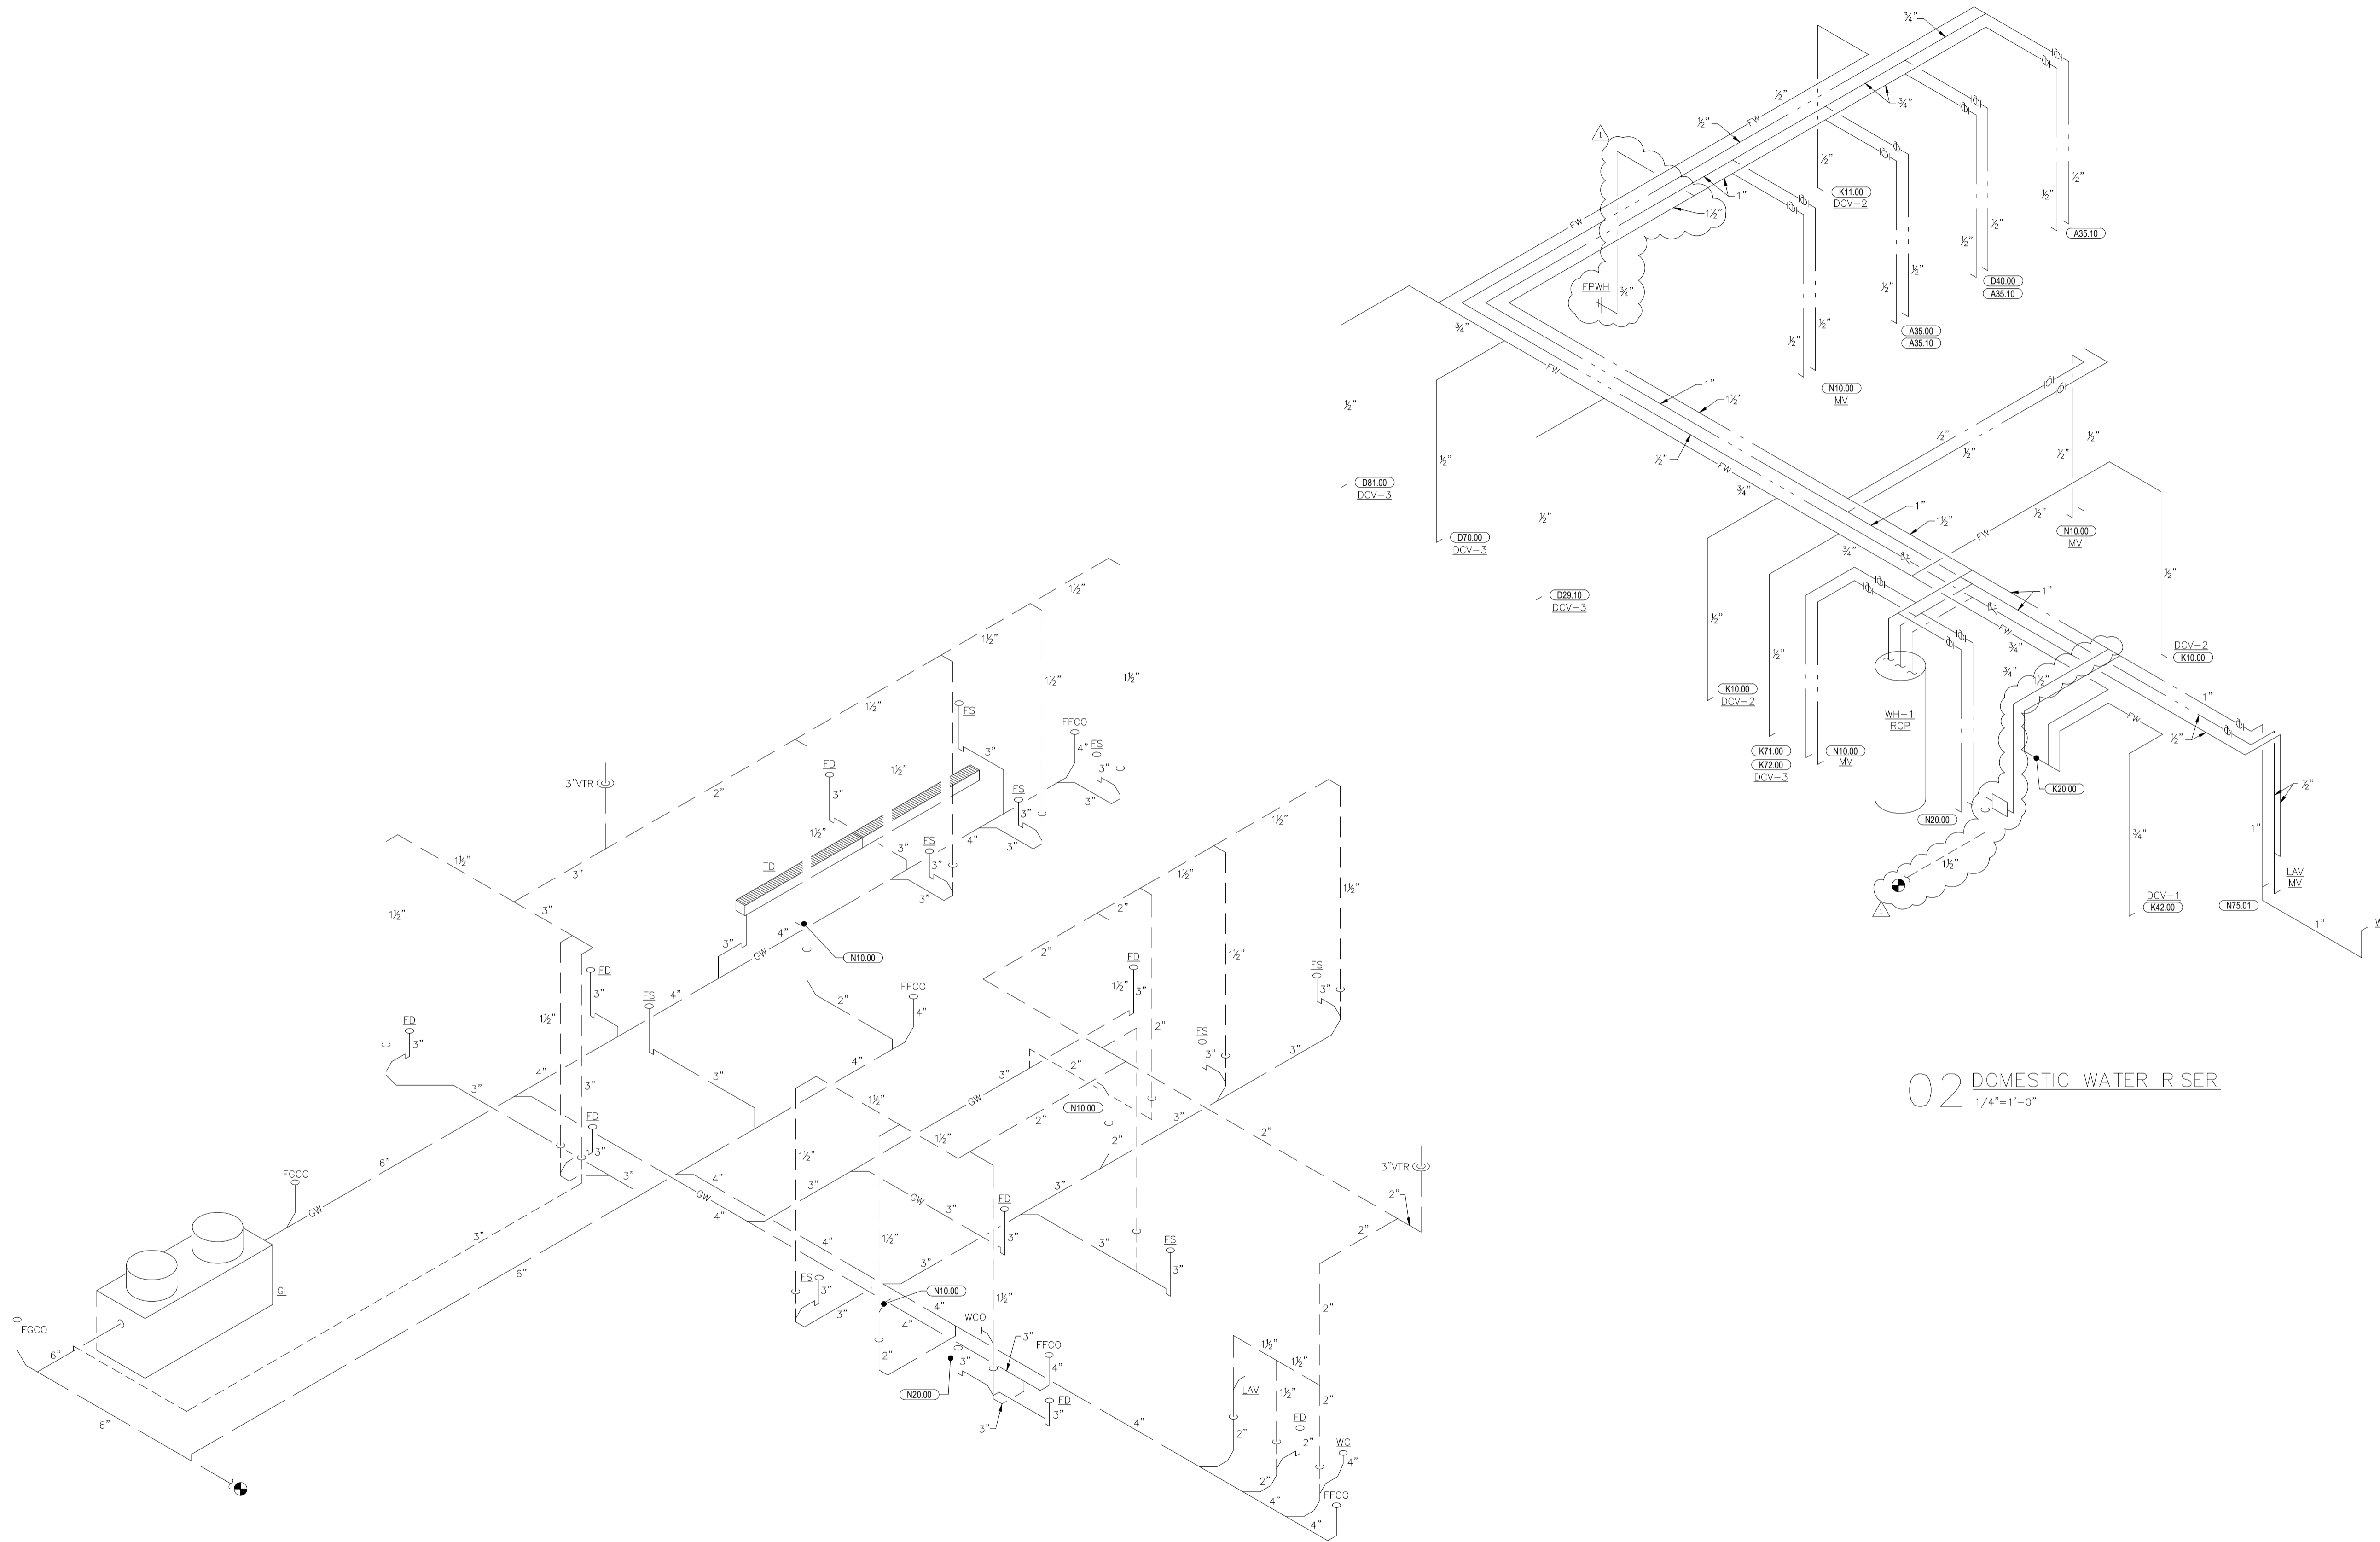

01 SANITARY WASTE AND VENT RISER  
1/4"=1'-0"

02 DOMESTIC WATER RISER  
1/4"=1'-0"

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No.	Date (mm/dd/yy)	Description

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Store Type  
US 2112 PROTOTYPE  
2112-21


Location  
1517 NC 24-87  
CAMERON, NC

Drawing Title  
PLUMBING RISERS

Drawn	Checked
NI	AH
Scale	Date
	JUNE 2023
Project No.	Drawing No.
C22-129	P3.1

POPEYES LOUISIANA KITCHEN MODEL 2112, 1517 NC 24-87, CAMERON, NC (JUNE 01, 2023) STORE NO. C22-129




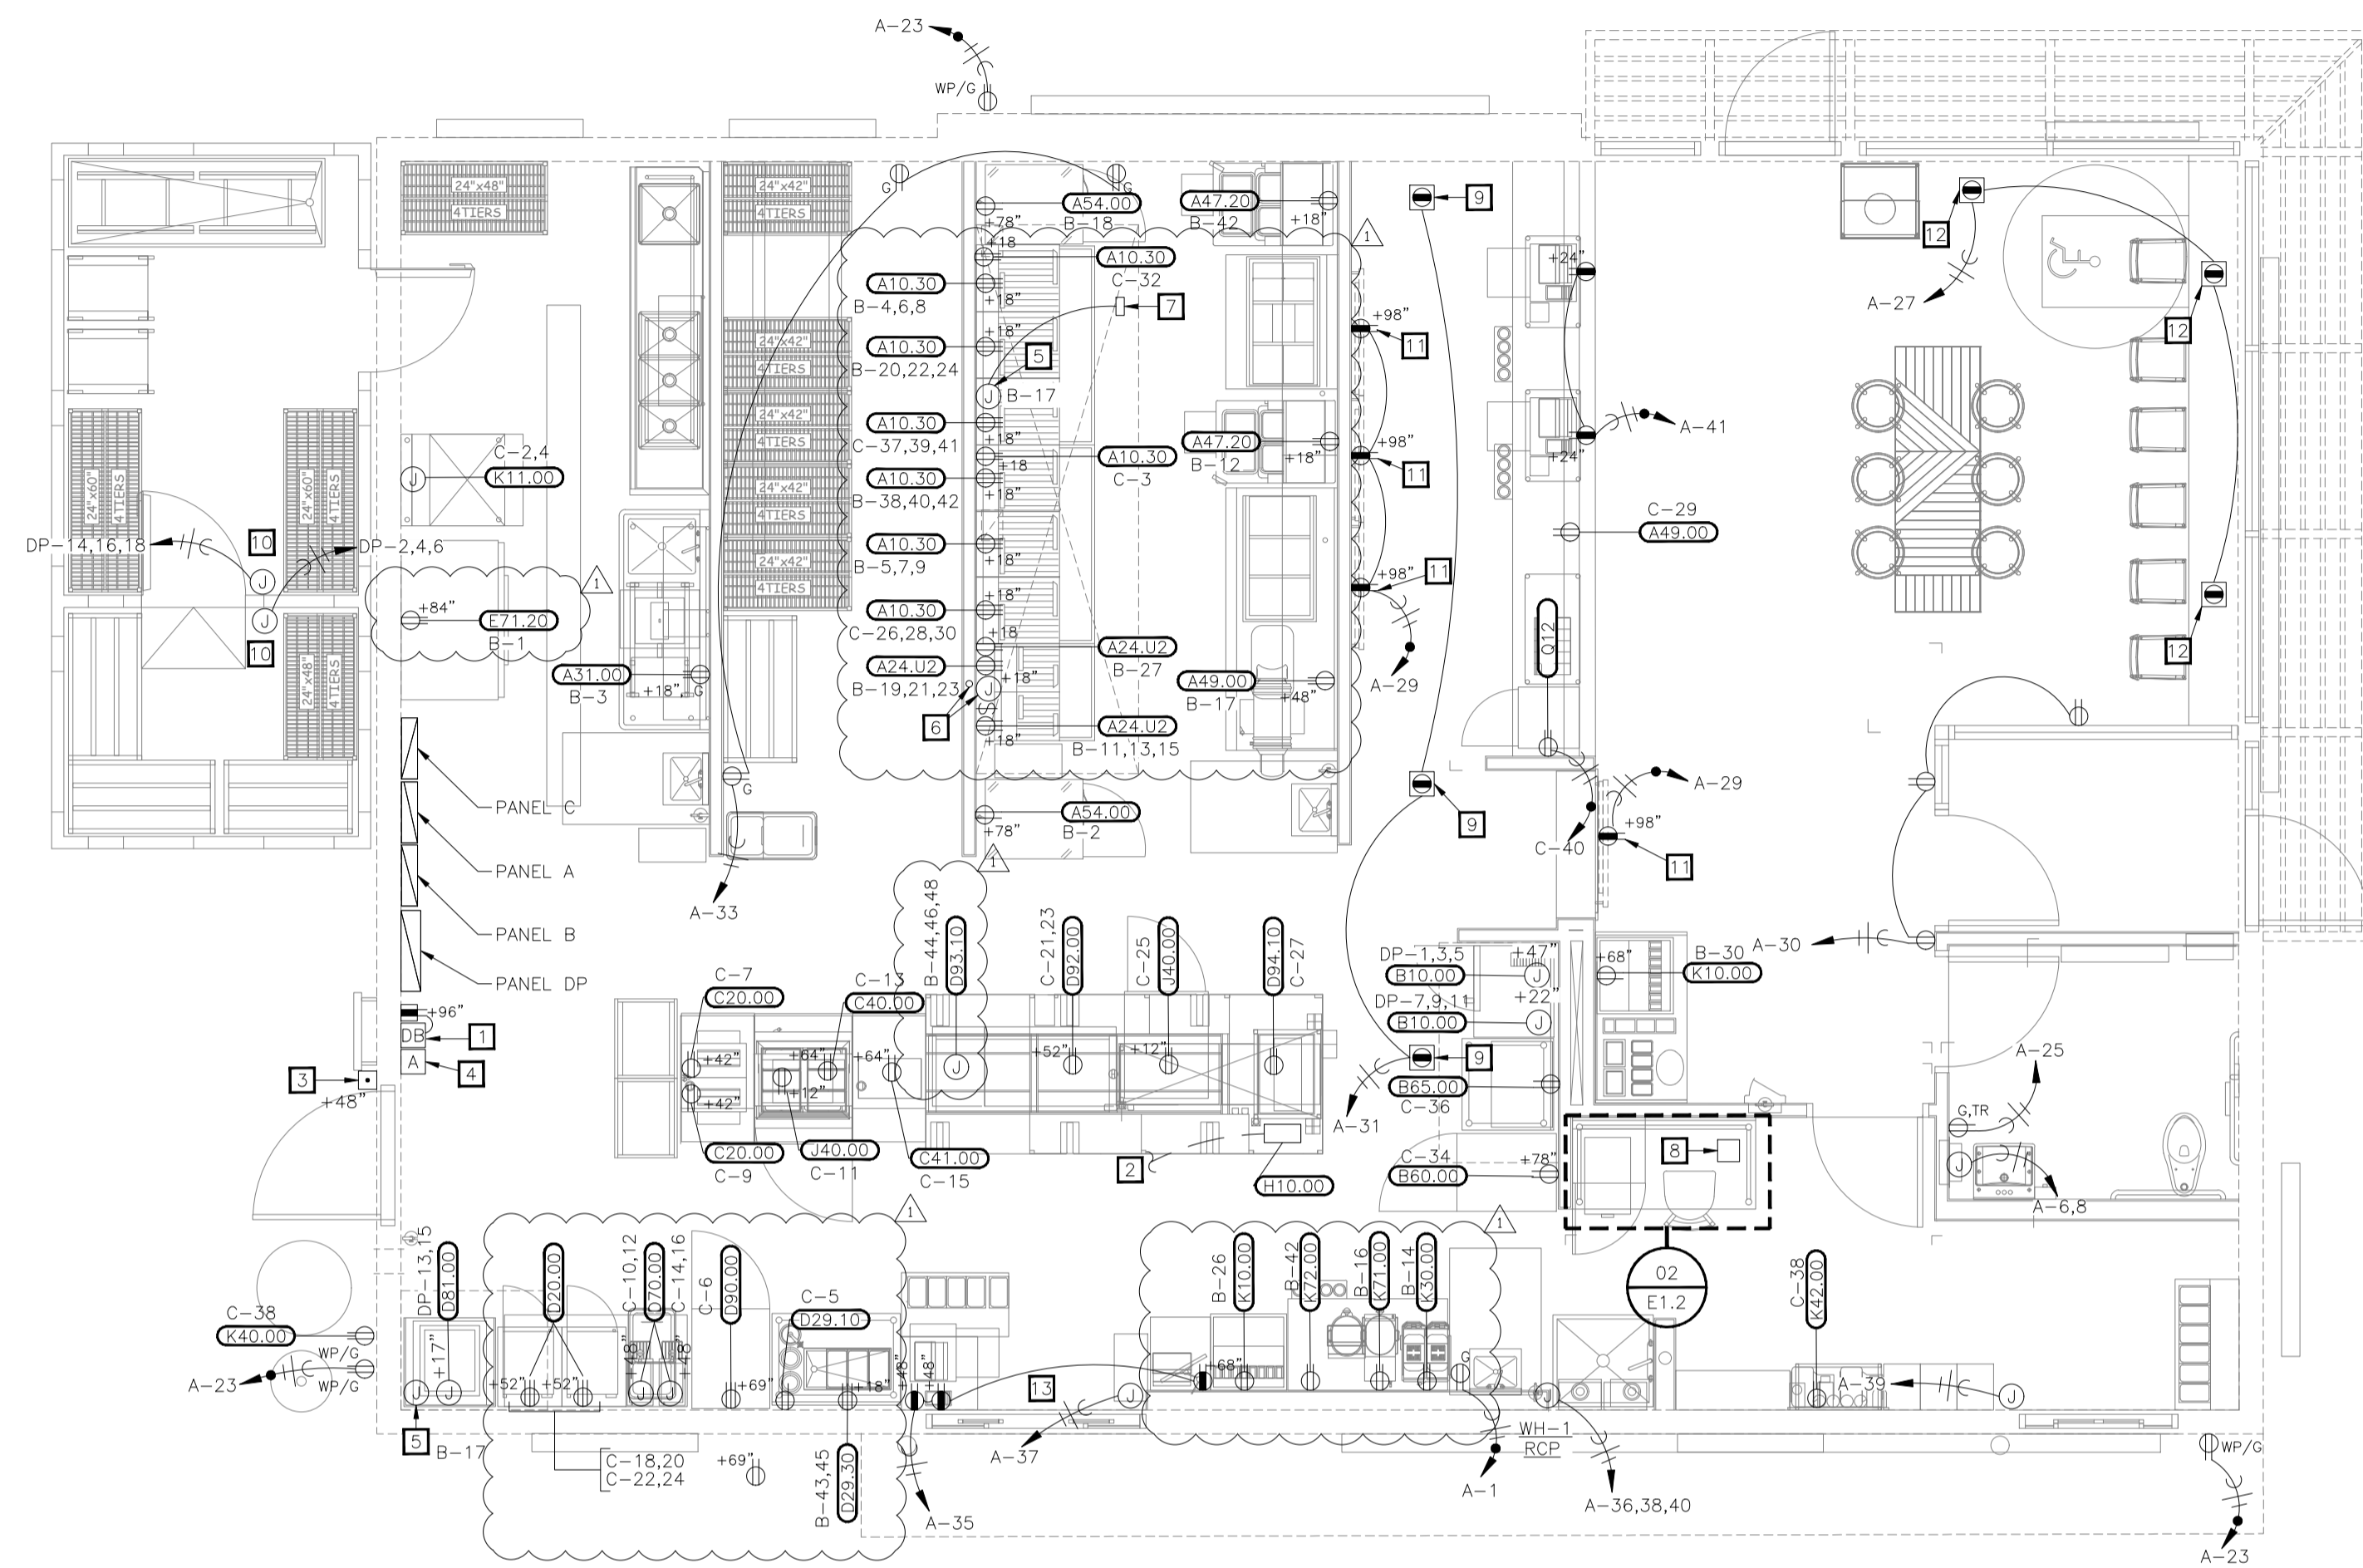

01 POWER PLAN  
1/4"=1'-0"

ELECTRICAL KEYNOTES

- 1 PROVIDE DOUBLE DUPLEX RECEPTACLE ADJACENT TO TELEPHONE BOARD. PROVIDE #6 CU GROUND TO SERVICE ENTRANCE GROUND. SEE ARCHITECTURAL ELEVATIONS.
- 2 ALL POWER FOR ISLAND KITCHEN EQUIPMENT TO RUN THROUGH LOAD CENTER H10.00. CONDUIT TO RUN UNDER SLAB AND STUB AT H10.00.
- 3 SERVICE SIGN AND PUSHBUTTON FOR DOORBELL.
- 4 E.C. TO WIRE AND CONNECT REMOTE ANSUL PULLSTATION.
- 5 E.C. TO INSTALL AND WIRE RELAY CONTROL PANEL PACKAGE FOR HOOD EXHAUST FANS HEF-1 AND HEF-2. PROVIDE POWER AND INTERLOCK CONTROL WIRING FOR HP1-F CONTROL PANEL AND HOOD FIRE SUPPRESSION SYSTEM. SEE EXHAUST HOOD WIRING DETAIL SHEET E3.2.
- 6 HOOD ANSUL FIRE SUPPRESSION SYSTEM. PROVIDE 3/4" CONDUIT STUBBED ABOVE CEILING.
- 7 "ON/OFF" SELECTOR SWITCH AND PILOT LIGHT IN NEMA 4X STAINLESS STEEL ENCLOSURE MOUNTED ON THE FACE OF THE HOOD. PROVIDED BY HOOD MANUFACTURER.
- 8 OFFICE EXHAUST FAN SHALL BE CONNECTED TO OPERATE WITH AREA LIGHTING. INTERLOCK EXHAUST FAN WITH LIGHTS.
- 9 PROVIDE CEILING OUTLET WITH ISOLATED GROUND RECEPTACLES SUPPORTED FROM BUILDING STRUCTURE FOR VIDEO MONITOR, PRINTER, AND/OR HEADSET. VERIFY EXACT REQUIREMENTS AND LOCATION.
- 10 POWER CONNECTION TO WALK-IN FREEZER, EVAP, DEFROSTER, HEAT TAPE, AND DOOR HEATER.
- 11 POWER FOR MENUBOARDS. REFER TO "MONITOR BRACKET DETAIL" ON SHEET E3.1 FOR MORE INFORMATION.
- 12 CEILING MOUNTED SHOW WINDOW RECEPTACLE.
- 13 SEE DETAIL 07, E3.1 FOR DRIVE-THRU AUDIO AND TIMERS DIAGRAM.

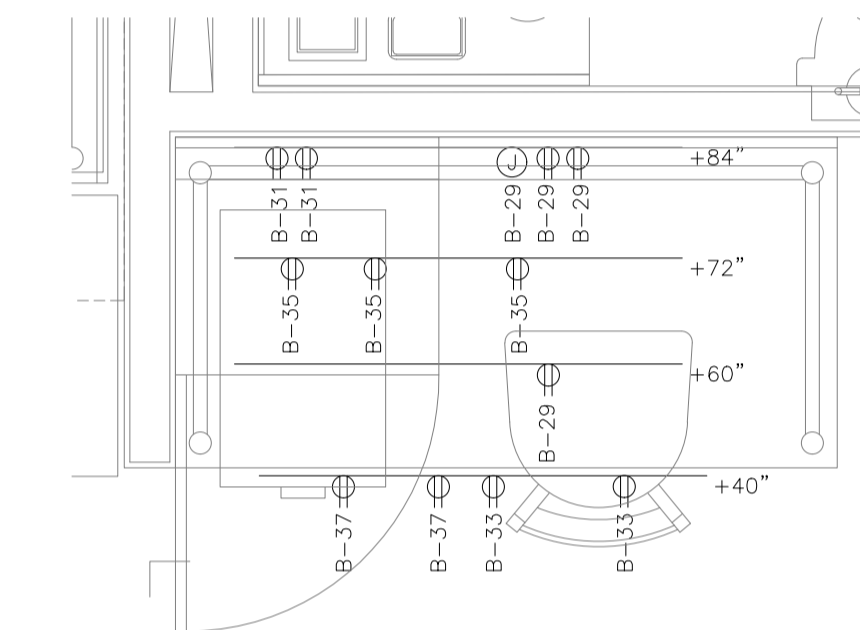

02 MANAGER'S DESK POWER PLAN  
3/4"=1'-0"

ISSUE TABLE		
No.	Date (mm/dd/yy)	Description

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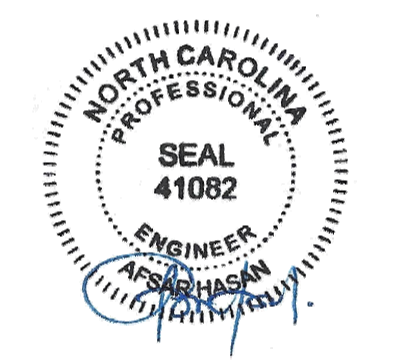
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No.	Date	Description



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Project

Store Type  
US 2112 PROTOTYPE  
2112-21

Location  
1517 NC 24-87  
CAMERON, NC

Drawing Title  
ELECTRICAL POWER PLAN

Drawn JP	Checked AH
Scale AS SHOWN	Date JUNE 2023
Project No. C22-129	Drawing No. E1.2

POPEYES LOUISIANA KITCHEN MODEL 2112, 1517 NC 24-87, CAMERON, NC (JUNE 01, 2023) STORE NO. C22-129


**ELECTRICAL KEYNOTES**

- 1 PROVIDE CONNECTION TO ASSOCIATED SWITCH ON HOOD. COORDINATE ALL REQUIREMENTS WITH MECHANICAL DRAWINGS AND HOOD WIRING DIAGRAM PRIOR TO ROUGH-IN.
- 2 UNIT IS PROVIDED WITH UNIT MOUNTED UNIT POWERED CONVENIENCE RECEPTACLE.


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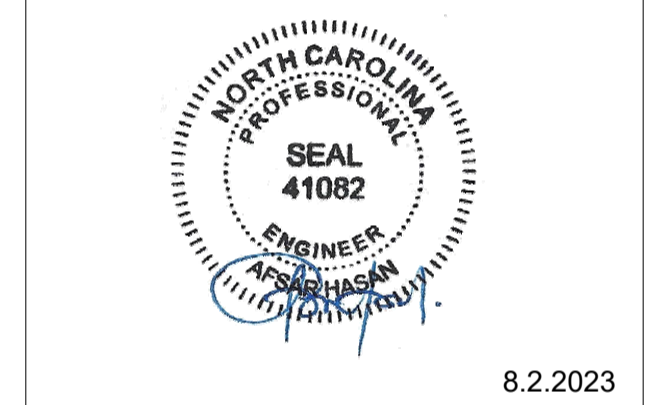


01 ROOF POWER PLAN  
1/4" = 1'-0"


  
**PROJECT NORTH**
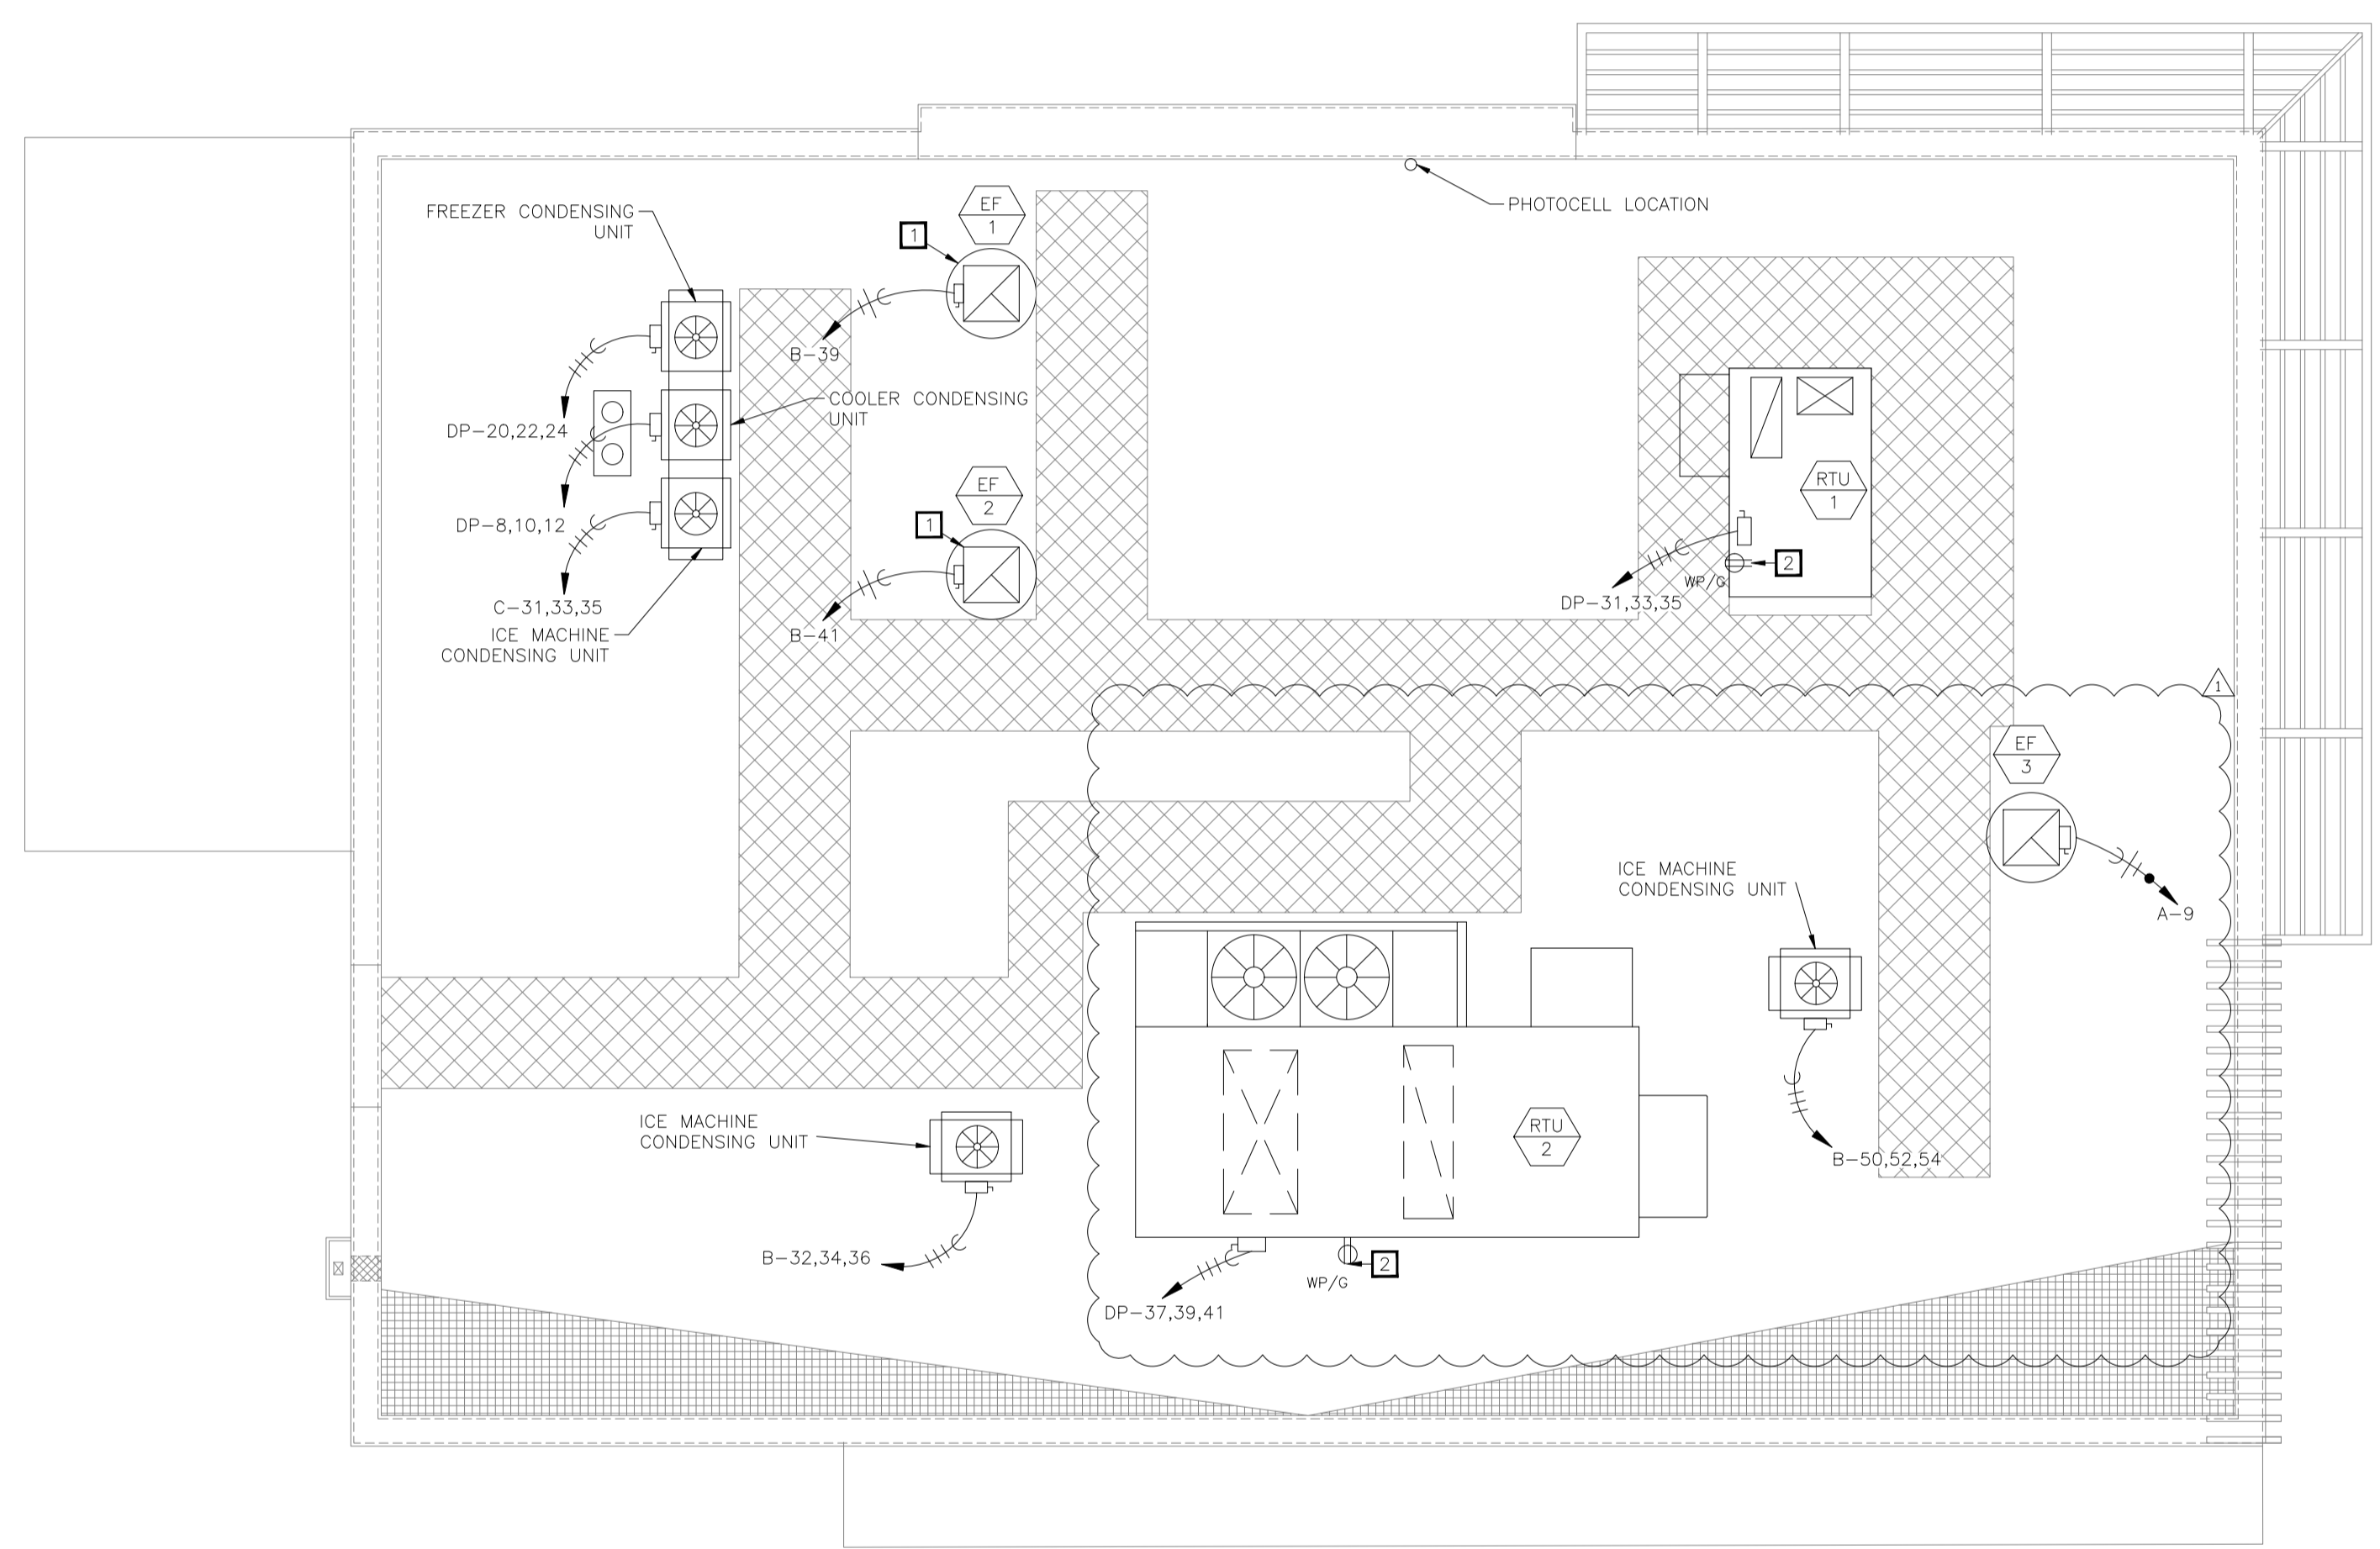
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


Company Logo



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Project




Store Type  
US 2112 PROTOTYPE  
2112-21

Location  
**1517 NC 24-87  
CAMERON, NC**

Drawing Title  
**ELECTRICAL ROOF PLAN**

Drawn JP	Checked AH
Scale 1/4" = 1'-0"	Date JUNE 2023
Project No. C22-129	Drawing No. E1.3

POPEYES LOUISIANA KITCHEN MODEL 2112, 1517 NC 24-87, CAMERON, NC (JUNE 01, 2023) STORE NO. C22-129

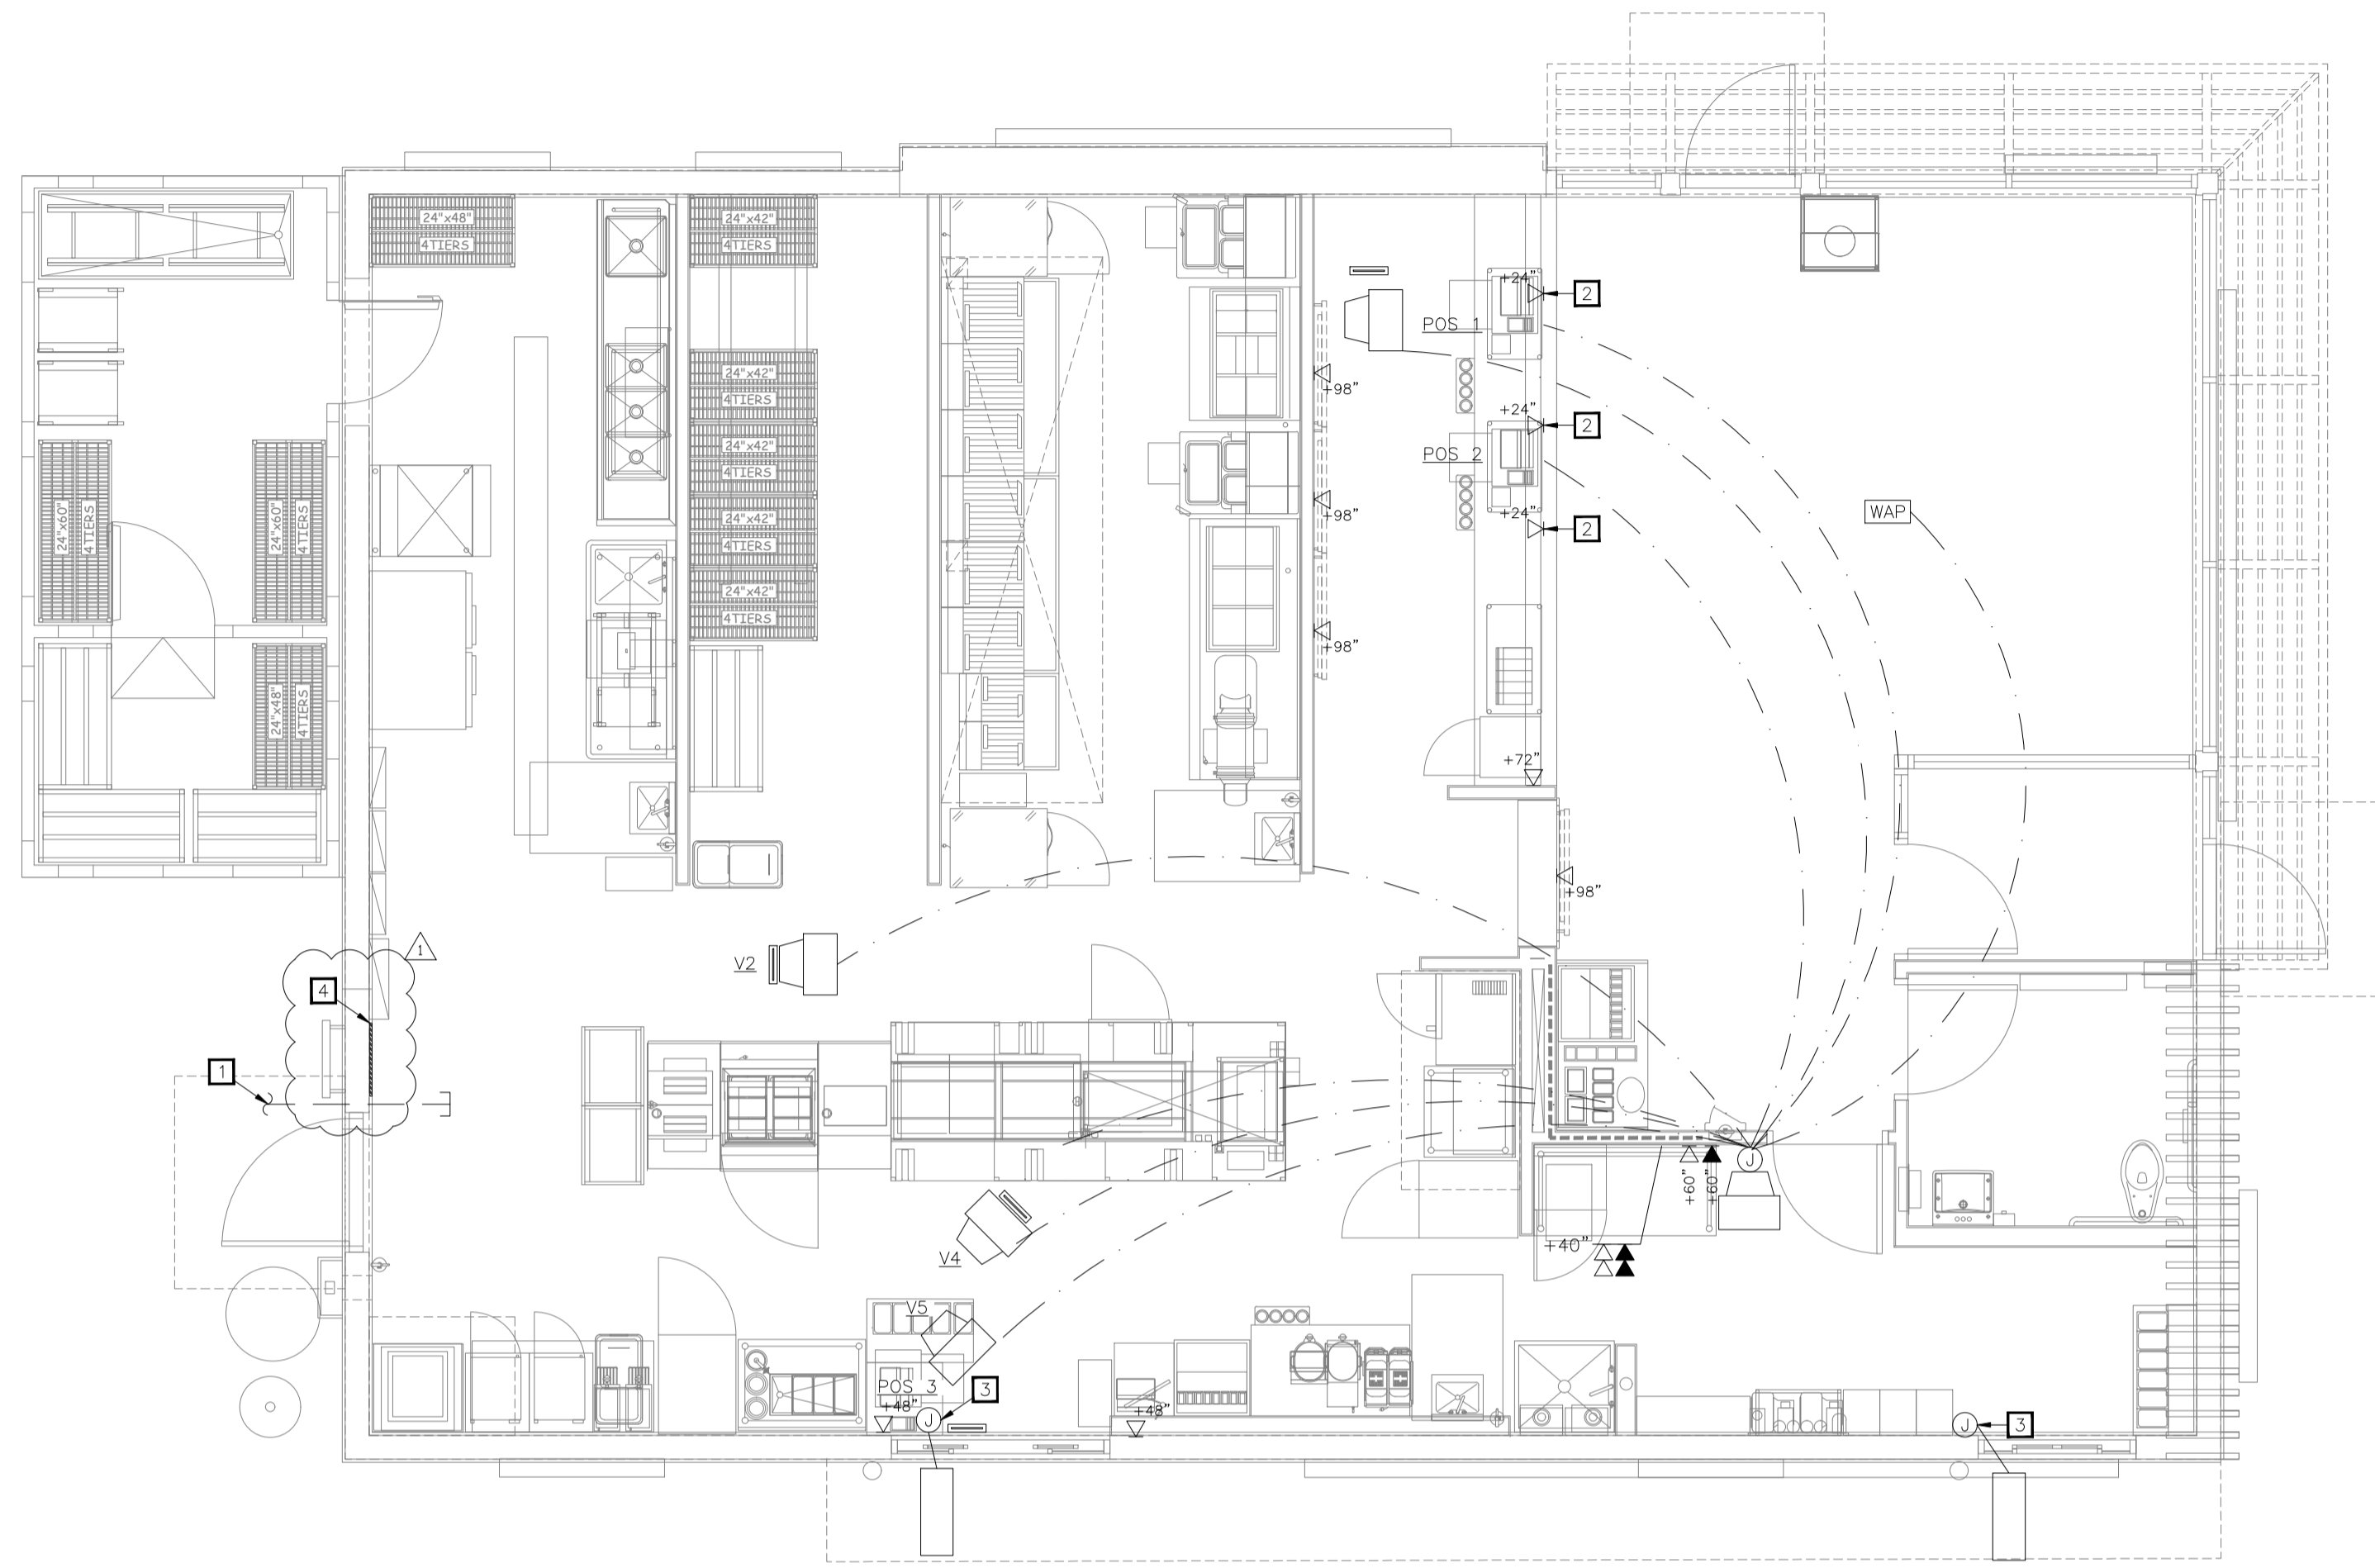

01 LOW VOLTAGE PLAN  
1/4"=1'-0"

ELECTRICAL KEYNOTES

- 1 (2) 2" CONDUITS FROM TELEPHONE BOARD TO A LOCATION COORDINATED WITH LOCAL TELEPHONE COMPANY. OWNER REQUIRED SERVICE. CONDUITS SHALL BE SIZED FOR 25 PAIR (MINIMUM). TELEPHONE SERVICE CONDUITS SHALL BE INSTALLED WITH PULL WIRE. CONDUITS RISE FROM U.G. INSIDE EXTERIOR WALL, TURN 90 DEGREES, AND TERMINATE IN BUILDING. SEE ARCHITECTURAL ELEVATIONS.
- 2 FRONT COUNTER REGISTER DATA OUTLETS MOUNTED ON INSIDE OF MILLWORK. PROVIDE 1" CONDUIT WITH PULL STRING FOR POS DATA BOXES.
- 3 PROVIDE JUNCTION BOX WITH 1" CONDUIT WITH PULL STRING THROUGH CURB TO 2" BELOW PAVEMENT LINE FOR CAR SENSOR DETECTOR LOOP. COORDINATE WITH CIVIL PLANS AND COORDINATE INSTALLATION IN FIELD WITH SUPPLIER.
- 4 PROVIDE 3/4" X 18" X 24" W PLYWOOD TELEPHONE BOARD PAINTED WITH 2 COATS OF "LISTED" FIRE RETARDANT LIGHT GRAY COLOR PAINT.

No.	Date (mm/dd/yy)	Description

REVISIONS		
No.	Date	Description
1	8/01/2023	RESPONSE TO CITY

DRAWINGS REVISED AS PER DESIGN BULLETIN		
No.	Date	Description



PROJECT NORTH

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8.2.2023

Company Logo

Project

Store Type  
US 2112 PROTOTYPE  
2112-21

Location  
**1517 NC 24-87  
CAMERON, NC**

Drawing Title  
**ELECTRICAL POS PLAN**

Drawn JP	Checked AH
Scale 1/4" = 1'-0"	Date JUNE 2023
Project No. C22-129	Drawing No. E1.4

- REGISTER CONNECTION NOTES
- A. CABLES SHALL BE CAT6.
  - B. BUMP BARS SHALL BE MOUNTED TO DELIVER SYSTEM AT AREAS MARKED "BB".
  - C. BUMP BAR CABLES SHALL BE RUN THROUGH DELIVERY SYSTEM FROM MOUNT UP THROUGH WALLS TO ABOVE THE CEILING AND BACK TO THE MANAGER STATION.
  - D. CRT MONITORS SHALL BE MOUNTED ON CEILING BRACKETS PROVIDED BY REGISTER SYSTEM.
  - E. WHERE CABLING IS INSTALLED IN WALLS, IT SHALL BE ROUTED IN 1" CONDUIT THROUGH THE WALL TO ABOVE ACCESSIBLE CEILING.

POPEYES RADIO SYSTEM  
PROVIDED BY OWNER

DESCRIPTION	MAKE	MODEL	QUANTITY
RECESSED SPEAKERS*(DINING)	BOSE	MODEL #16, BLACK	4
RECESSED SPEAKERS*(KITCHEN)	MUZAK	MBS 8-ST3, BLACK	2
OUTDOOR BOX SPEAKERS*	OWI	701	4
AMPLIFIER	PASO	MU 3130 BGM	1
SPEAKER SUPPORT	QUAM	SSB-2	2
SPEAKER BACKCAN	QUAM	ERD-B	2
CABLE, CONNECTORS, HARDWARE AND SHELF	VARIOUS	VARIOUS	1
AREA VOLUME CONTROL	QUAM	QC-10	3
RECEIVER	ECOHO STAR	3000	1
DISH	CH MASTER	1.0 ANTENNA	1

\* NUMBER OF SPEAKERS MAY VARY DUE TO DESIGN CONSIDERATIONS  
\*\* LABOR INCLUDES INSTALLATION OF 150' OF 12 GAUGE SPEAKER WIRE. SEE THE NATIONAL ACCOUNT VENDOR LIST FOR EQUIPMENT SUPPLIER.

POS LEGEND

- BUMP BAR WIRING
- VIDEO MONITOR AND POS WIRING
- SECURITY WIRING (CAT6)
- BB - BUMP BARS
- V1 = VIDEO 1
- V2 = VIDEO 2
- V3 = VIDEO 3
- V4 = VIDEO 4
- V5 = VIDEO 5
- POS - POINT OF SALE TERMINAL
- MONITOR
- [WAP] WIRELESS APPLICATION PROTOCOL

NOTES TO ARCHITECT:  
\* ENGINEER NEEDS LOCATIONS FOR ALL SPEAKERS

SYMBOLS LEGEND NOTES:  
MOUNTING HEIGHTS INDICATED ARE MEASURED FROM FINISHED FLOOR TO THE CENTERLINE OF THE DEVICE UNLESS NOTED OTHERWISE.

POPEYES LOUISIANA KITCHEN MODEL 2112, 1517 NC 24-87, CAMERON, NC (JUNE 01, 2023) STORE NO. C22-129



**KITCHEN EQUIPMENT SCHEDULE**

EQUIPMENT MARK	ITEM DESCRIPTION	VOLTAGE-PHASE	MOCP	FEEDER			CONNECTION				HEIGHT	REMARKS
				CONDUCTOR & GROUND	PIPE	MATERIAL	TYPE	AMPERAGE	POLES	FUSES		
A10.30	MULTIPLE LE FRYER SYSTEM, ELECTRIC	120V-3P	70A	1 SET(6)H#10G	1"	COPPER	RECEPTACLE	56A	3	5-15	18"	Amperage per vat. Needs power for controls
A24.U2	MULTIPLE LE FRYER SYSTEM, ELECTRIC	208V-3P	60A	1 SET(4)H#8G	3/4"	COPPER	RECEPTACLE	47A	3	5-15	18"	Amperage per vat. Needs power for controls
A31.00	MARINATOR	120V-1P	15A	1 SET(2)H#12G	1/2"	COPPER	RECEPTACLE	15A	1	5-15	18"	
A47.10	BATTER CART	120V-1P	15A	1 SET(2)H#12G	1/2"	COPPER	RECEPTACLE	15A	1	5-15	18"	
A47.20	BATTER CART	120V-1P	15A	1 SET(2)H#12G	1/2"	COPPER	RECEPTACLE	15A	1	5-15	18"	
A47.30	BATTER CART	120V-1P	15A	1 SET(2)H#12G	1/2"	COPPER	RECEPTACLE	15A	1	5-15	18"	
A49.00	DRUMROLL	120V-1P	15A	1 SET(2)H#12G	1/2"	COPPER	RECEPTACLE	15A	1	5-15	18"	
A54.00	REACH-IN-FREEZER	120V-1P	15A	1 SET(2)H#12G	1/2"	COPPER	RECEPTACLE	15A	1	5-15	78"	
AB54.00	REACH-IN-FREEZER	120V-1P	15A	1 SET(2)H#12G	1/2"	COPPER	RECEPTACLE	15A	1	5-15	78"	
B10.00	CONVECTION OVEN	120/208-3P	40A	1 SET(4)H#8G	3/4"	COPPER	HARDWIRE	24A	2		22"-47"	
B20.00	COUNTERTOP MIXER	120V-1P	15A	1 SET(2)H#12G	1/2"	COPPER	RECEPTACLE	15A	1	5-15	78"	
B60.00	REACH-IN REFRIGERATOR	120V-1P	15A	1 SET(2)H#12G	1/2"	COPPER	RECEPTACLE	15A	1	5-15	78"	
865.00	BISCUIT HOLDING UNIT	120V-1P	15A	1 SET(2)H#12G	1/2"	COPPER	RECEPTACLE	15A	1	5-15	78"	
C20.00	TOASTER	120V-1P	15A	1 SET(2)H#12G	1/2"	COPPER	RECEPTACLE	15A	1	5-15	42"	
C40.00	PRODUCT HOLDING BIN	120V-1P	15A	1 SET(2)H#12G	1/2"	COPPER	RECEPTACLE	15A	1	5-15	42"	
C41.00	PRODUCT HOLDING BIN	120V-1P	20A	1 SET(2)H#12G	1/2"	COPPER	RECEPTACLE	20A	1	5-20	64"	
D20.00	MICROWAVE OVEN	208V-1P	15A	1 SET(2)H#12G	1/2"	COPPER	RECEPTACLE	15A	2	6-15	40"-52"	
D29.00	DIPPER WELL	120V-1P	15A	1 SET(2)H#12G	1/2"	COPPER	RECEPTACLE	15A	1	5-15	40"-52"	
D20.10	UTENSIL HOLDER	120V-1P	15A	1 SET(2)H#12G	1/2"	COPPER	RECEPTACLE	15A	1	5-15	40"-52"	
D29.30	HOT WELLS	208V-1P	20A	1 SET(2)H#12G	1/2"	COPPER	RECEPTACLE	5A	2			PROVIDE FOR (2) HOT WELLS
D29.80	HOT WELLS	208V-1P	15A	1 SET(2)H#12G	1/2"	COPPER	HARDWIRE	1				
D50.00	ELECTRIC BOOSTER HEATER	208V-3P	30A	1 SET(3)H#10G	1/2"	COPPER	HARDWIRE	3			48"	
D70.00	HOT WATER DISPENSER	208V-1P	15A	1 SET(2)H#12G	1/2"	COPPER	HARDWIRE	2			17"	
D81.00	REHEAT/REHEAT, WATER TANK, ELECTRIC	208V-1P	60A	1 SET(2)H#10G	3/4"	COPPER	HARDWIRE	2			6-30	
D90.00	COOK & HOLD OVEN	120V-1P	20A	1 SET(2)H#10G	1/2"	COPPER	RECEPTACLE	19A	1	6-30	69"	
D92.00	SIDE HOLDING BINS	208V-1P	15A	1 SET(2)H#12G	1/2"	COPPER	RECEPTACLE	15A	2	6-15	LOADCNTR	INCLUDED IN #H10
D92.00M	HOT HOLDING CABINET	208V-1P	30A	1 SET(2)H#12G	1/2"	COPPER	RECEPTACLE	30A	2	6-30		
D93.10	HOLDING BIN	208V-1P	35A	1 SET(2)H#10G	1/2"	COPPER	HARDWIRE	20A	1	5-20		
D94.00M	HOT HOLDING CABINET	120V-1P	20A	1 SET(2)H#12G	1/2"	COPPER	RECEPTACLE	20A	1	5-20		
D94.00PC	PROTEIN HOLDING BIN	208V-1P	30A	1 SET(2)H#10G	1/2"	COPPER	RECEPTACLE	30A	2	6-30		
D94.10PC	BISCUIT HOLDING UNIT	120V-1P	15A	1 SET(2)H#12G	1/2"	COPPER	RECEPTACLE	15A	1	5-15		
E10.00	WALK-IN COOLER/FREEZER	120V-1P	15A	1 SET(2)H#12G	1/2"	COPPER	HARDWIRE	1				SEE SPECS
F17.00	EVEN-THAW REFRIGERATOR	120V-1P	15A	1 SET(2)H#12G	1/2"	COPPER	RECEPTACLE	15A	1	5-15	84"	
F17.20	THAWING CABINET	120V-1P	20A	1 SET(2)H#12G	1/2"	COPPER	RECEPTACLE	20A	1	5-20		
F15.10	FAB ELECTRICAL	208V-1P	15A	1 SET(2)H#12G	1-1/4"	COPPER	HARDWIRE	1				SEE SPECS
GR10.00	CONTACT GRILL	120V-1P	20A	1 SET(2)H#12G	1/2"	COPPER	RECEPTACLE	20A	1	5-20		
H10.00	FAB ELECTRICAL	120/208V-3P	15A	1 SET(4)H#8G	1/2"	COPPER	HARDWIRE	3				LOAD CENTER
H90.00	HOLDING CABINET	120V-1P	20A	1 SET(2)H#12G	1/2"	COPPER	RECEPTACLE	20A	1	5-20		
J40.00	UNDERCOUNTER REFRIGERATOR	120V-1P	15A	1 SET(2)H#12G	1/2"	COPPER	RECEPTACLE	15A	1	5-15	12"	
K10.00	ICE MAKER, CUBE-STYLE	120V-1P	15A	1 SET(2)H#12G	1/2"	COPPER	RECEPTACLE	15A	1	5-15	68"	
K30.00	DRINK MACHINE	120V-1P	15A	1 SET(2)H#12G	1/2"	COPPER	HARDWIRE	1		5-15	50"	
K11.00	ICE MAKER, CUBE-STYLE	208V-1P	15A	1 SET(2)H#12G	1/2"	COPPER	HARDWIRE	2		5-15	66"	
K30.00	DRINK MACHINE	120V-1P	15A	1 SET(2)H#12G	1/2"	COPPER	RECEPTACLE	15A	1	5-15		
K42.00	BAG N BOX	120V-1P	20A	1 SET(2)H#12G	1/2"	COPPER	RECEPTACLE	20A	1	5-15		
K40.00	OIL MANAGEMENT SYSTEM	120V-1P	20A	1 SET(2)H#12G	1/2"	COPPER	RECEPTACLE	20A	1	5-20		
K71.00	TEA BREWER	120V-1P	20A	1 SET(2)H#12G	1/2"	COPPER	RECEPTACLE	20A	1	5-20		

NOTES 1. VERIFY ALL ELECTRICAL CONNECTIONS PRIOR TO ROUGH-IN.


**EQUIPMENT FEEDER SCHEDULE**

EQUIPMENT MARK	VOLTAGE-PHASE	MOCP	FEEDER			CONNECTION				REMARKS	
			CONDUCTOR & GROUND	PIPE	MATERIAL	TYPE	AMPERAGE	POLES	FUSE		NEMA
RTU-1	208V-3P	90A	1 SET(3)H#8G	1-1/4"	COPPER	INTEGRAL DISCONNECT		NF			
RTU-2	208V-3P	175A	1 SET(4)H#20G	2"	COPPER	INTEGRAL DISCONNECT		NF			1
EF-1	120V-1P	20A	1 SET(2)H#12G	1/2"	COPPER	PROVIDE DISCONNECT	20A	1	NF	3R	
EF-2	120V-1P	20A	1 SET(2)H#12G	1/2"	COPPER	PROVIDE DISCONNECT	20A	1	NF	3R	
EF-3	120V-1P	20A	1 SET(2)H#12G	1/2"	COPPER	PROVIDE DISCONNECT	20A	1	NF	3R	
ICE CONDENSER	208V-3P	20A	1 SET(3)H#12G	3/4"	COPPER	PROVIDE DISCONNECT	20A	3		3R	
ICE CONDENSER	208V-3P	20A	1 SET(3)H#12G	3/4"	COPPER	PROVIDE DISCONNECT	20A	3		3R	
ICE CONDENSER	208V-3P	20A	1 SET(2)H#12G	3/4"	COPPER	PROVIDE DISCONNECT	20A	3		3R	
COOLER CONDENSER	208V-3P	20A	1 SET(3)H#12G	3/4"	COPPER	PROVIDE DISCONNECT	20A	3		3R	
FREEZER CONDENSER	208V-3P	30A	1 SET(3)H#12G	3/4"	COPPER	PROVIDE DISCONNECT	30A	3		3R	

NOTES:  
1 CIRCUIT THROUGH RELAY PANEL FOR CONTROL. SEE SCHEDULE FOR ADDITIONAL INFORMATION

**FEEDER SCHEDULE**

EQUIPMENT MARK	VOLTAGE-PHASE	MOCP	FEEDER			FAULT CURRENT	VOLTAGE DROP
			CONDUCTOR & GROUND	PIPE	MATERIAL		
UTILITY	500KVA 120/208V-3P INFINITE					111935	
DP	120/208V-3P	1000A	4 SETS(4)H#250	3"	COPPER	36392	
A	120/208V-3P	225A	4 #4/0 & 1#4G	2-1/2"	COPPER	30819	0.10%
B	120/208V-3P	400A	2 SETS(4)H#3/0 & 1#3G	2-1/2"	COPPER	33616	0.10%
C	120/208V-3P	225A	4 #4/0 & 1#4G	2-1/2"	COPPER	29805	0.10%

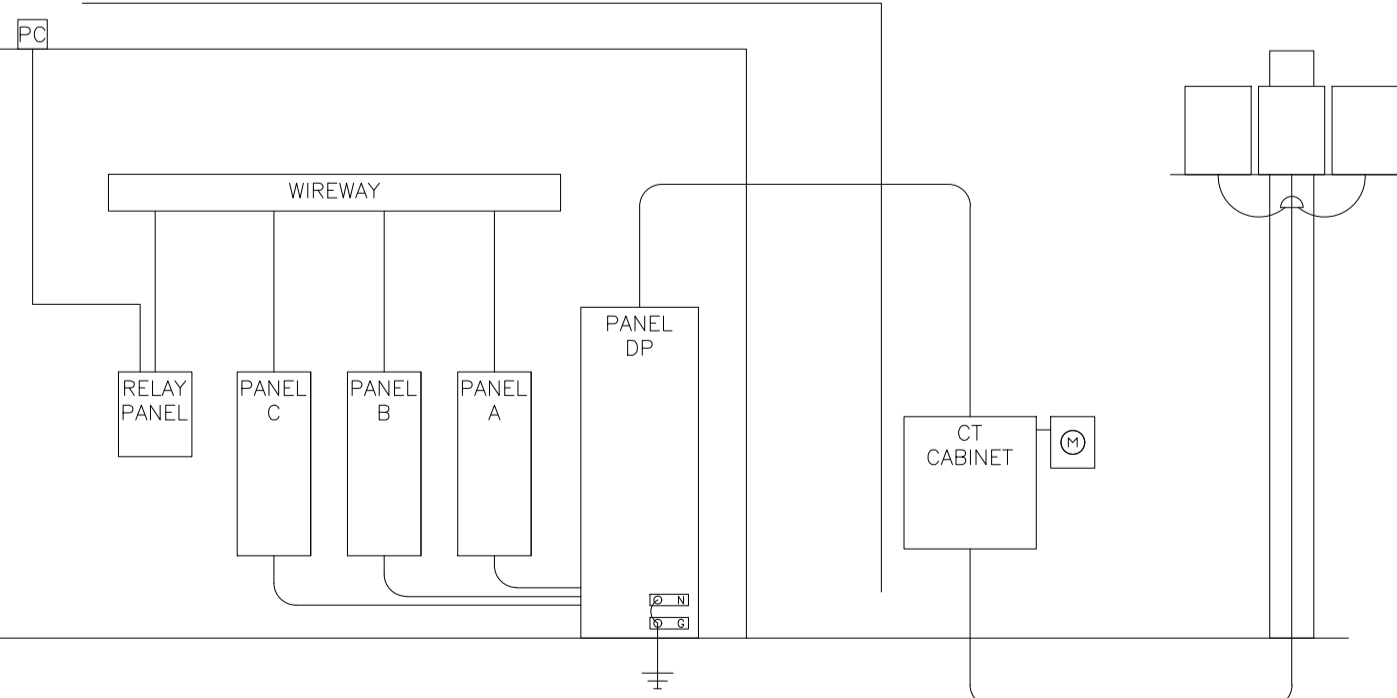

1 ELECTRICAL RISER DIAGRAM

PANELBOARD: DP  
PANEL TYPE: I-LINE  
LOCATION: B.O.H.

LOAD CTS	DESIGNATION	WIRE SIZE	LOAD VA	PL AMPS	PHASE	MAIN SIZE:			PL	LOAD VA	WIRE SIZE	DESIGNATION	LOAD CTS	
						PHASE A	PHASE B	PHASE C						
K 1	B10.00 - CONNECTION OVEN	3 #6,1#10S,3/4"	2880 3	40	3040	200	3	3	3	620	#12,1#12G,3/4"	4	O	
K 7	B10.00 - CONNECTION OVEN	3 #6,1#10S,3/4"	2880 3	40	3040	200	3	3	3	620	#12,1#12G,3/4"	8	O	
K 8	B81.00 - REHEAT/REHEAT	3 #6,1#10S,3/4"	4950 3	60	5600	300	3	3	3	650	#10,1#10S,3/4"	14	O	
K 11	B81.00 - REHEAT/REHEAT	3 #6,1#10S,3/4"	4950 3	60	5600	300	3	3	3	650	#10,1#10S,3/4"	14	O	
K 17	SPARE												18	O
K 18	SPARE												22	O
K 23	SPARE												24	O
K 25	SPARE												26	X
K 27	SPARE												28	X
A 31	RTU-1	3 #6,1#10S,3/4"	9967 3	90	45432 84	13501 2	400	3	3	15454	#12,1#12G,3/4"	32	X	
A 33	RTU-2	3 #6,1#10S,3/4"	21771 3	200	39202 92	42883 08	225	3	3	74743	#10,1#10S,3/4"	38	X	
A 39	RTU-2	3 #6,1#10S,3/4"	21771 3	200	39202 92	42883 08	225	3	3	74743	#10,1#10S,3/4"	38	X	
A 41	RTU-2	3 #6,1#10S,3/4"	21771 3	200	39202 92	42883 08	225	3	3	74743	#10,1#10S,3/4"	38	X	
A 43	RTU-2	3 #6,1#10S,3/4"	21771 3	200	39202 92	42883 08	225	3	3	74743	#10,1#10S,3/4"	38	X	

LOAD SUMMARY TABLE

NIC CODE REFERENCE	LOAD CATEGORY	CON LOAD	DEMAND	DEMAND (LOAD/VA) PER PHASE			BALANCED 3P LOAD	MARK	REMARKS
				PHASE A	PHASE B	PHASE C			
220.12/220.4/220.4/220.14/61	L LIGHTING	0.00	0.00	0.00	0.00	0.00	**	PROVIDE HACR BREAKER	
220.14/10/1.220.44	R RECEPTACLE	9.24	1.94	3.20	4.10	9.24	**	CONNECTED TO FIRE SUPPRESSION SYSTEM	
220.14C/430.24	M MOTORS	17.4	1.00	4.50	0.37	4.84	#	IS GROUND/FBI BREAKER	
220.96	K KITCHEN EQUIPMENT	222.40	0.65	49.13	49.74	45.68	***	VIA LIGHTING CONTROL PANEL	
220.96/40/40.40	A AIR CONDITION	95.21	1.00	31.74	31.74	95.21			
220.51/220.90	H HEAT ELECTRIC	0.00	1.00	0.00	0.00	0.00			
220.14/4A	O OTHER LOAD	37.81	1.00	13.89	14.20	37.81			
	SUB TOTAL	353.44	1.00	101.15	84.61	297.80			
	PHASE DEMAND LOAD						% UNBALANCE		
							KVA	AMPS	
							112.79	295.01	
							PH B	111.76	
							PH C	93.10	
							PH C	109.65	
							PH C	87.00	
							PH C	109.65	
							PH C	87.00	
							PH C	109.65	