



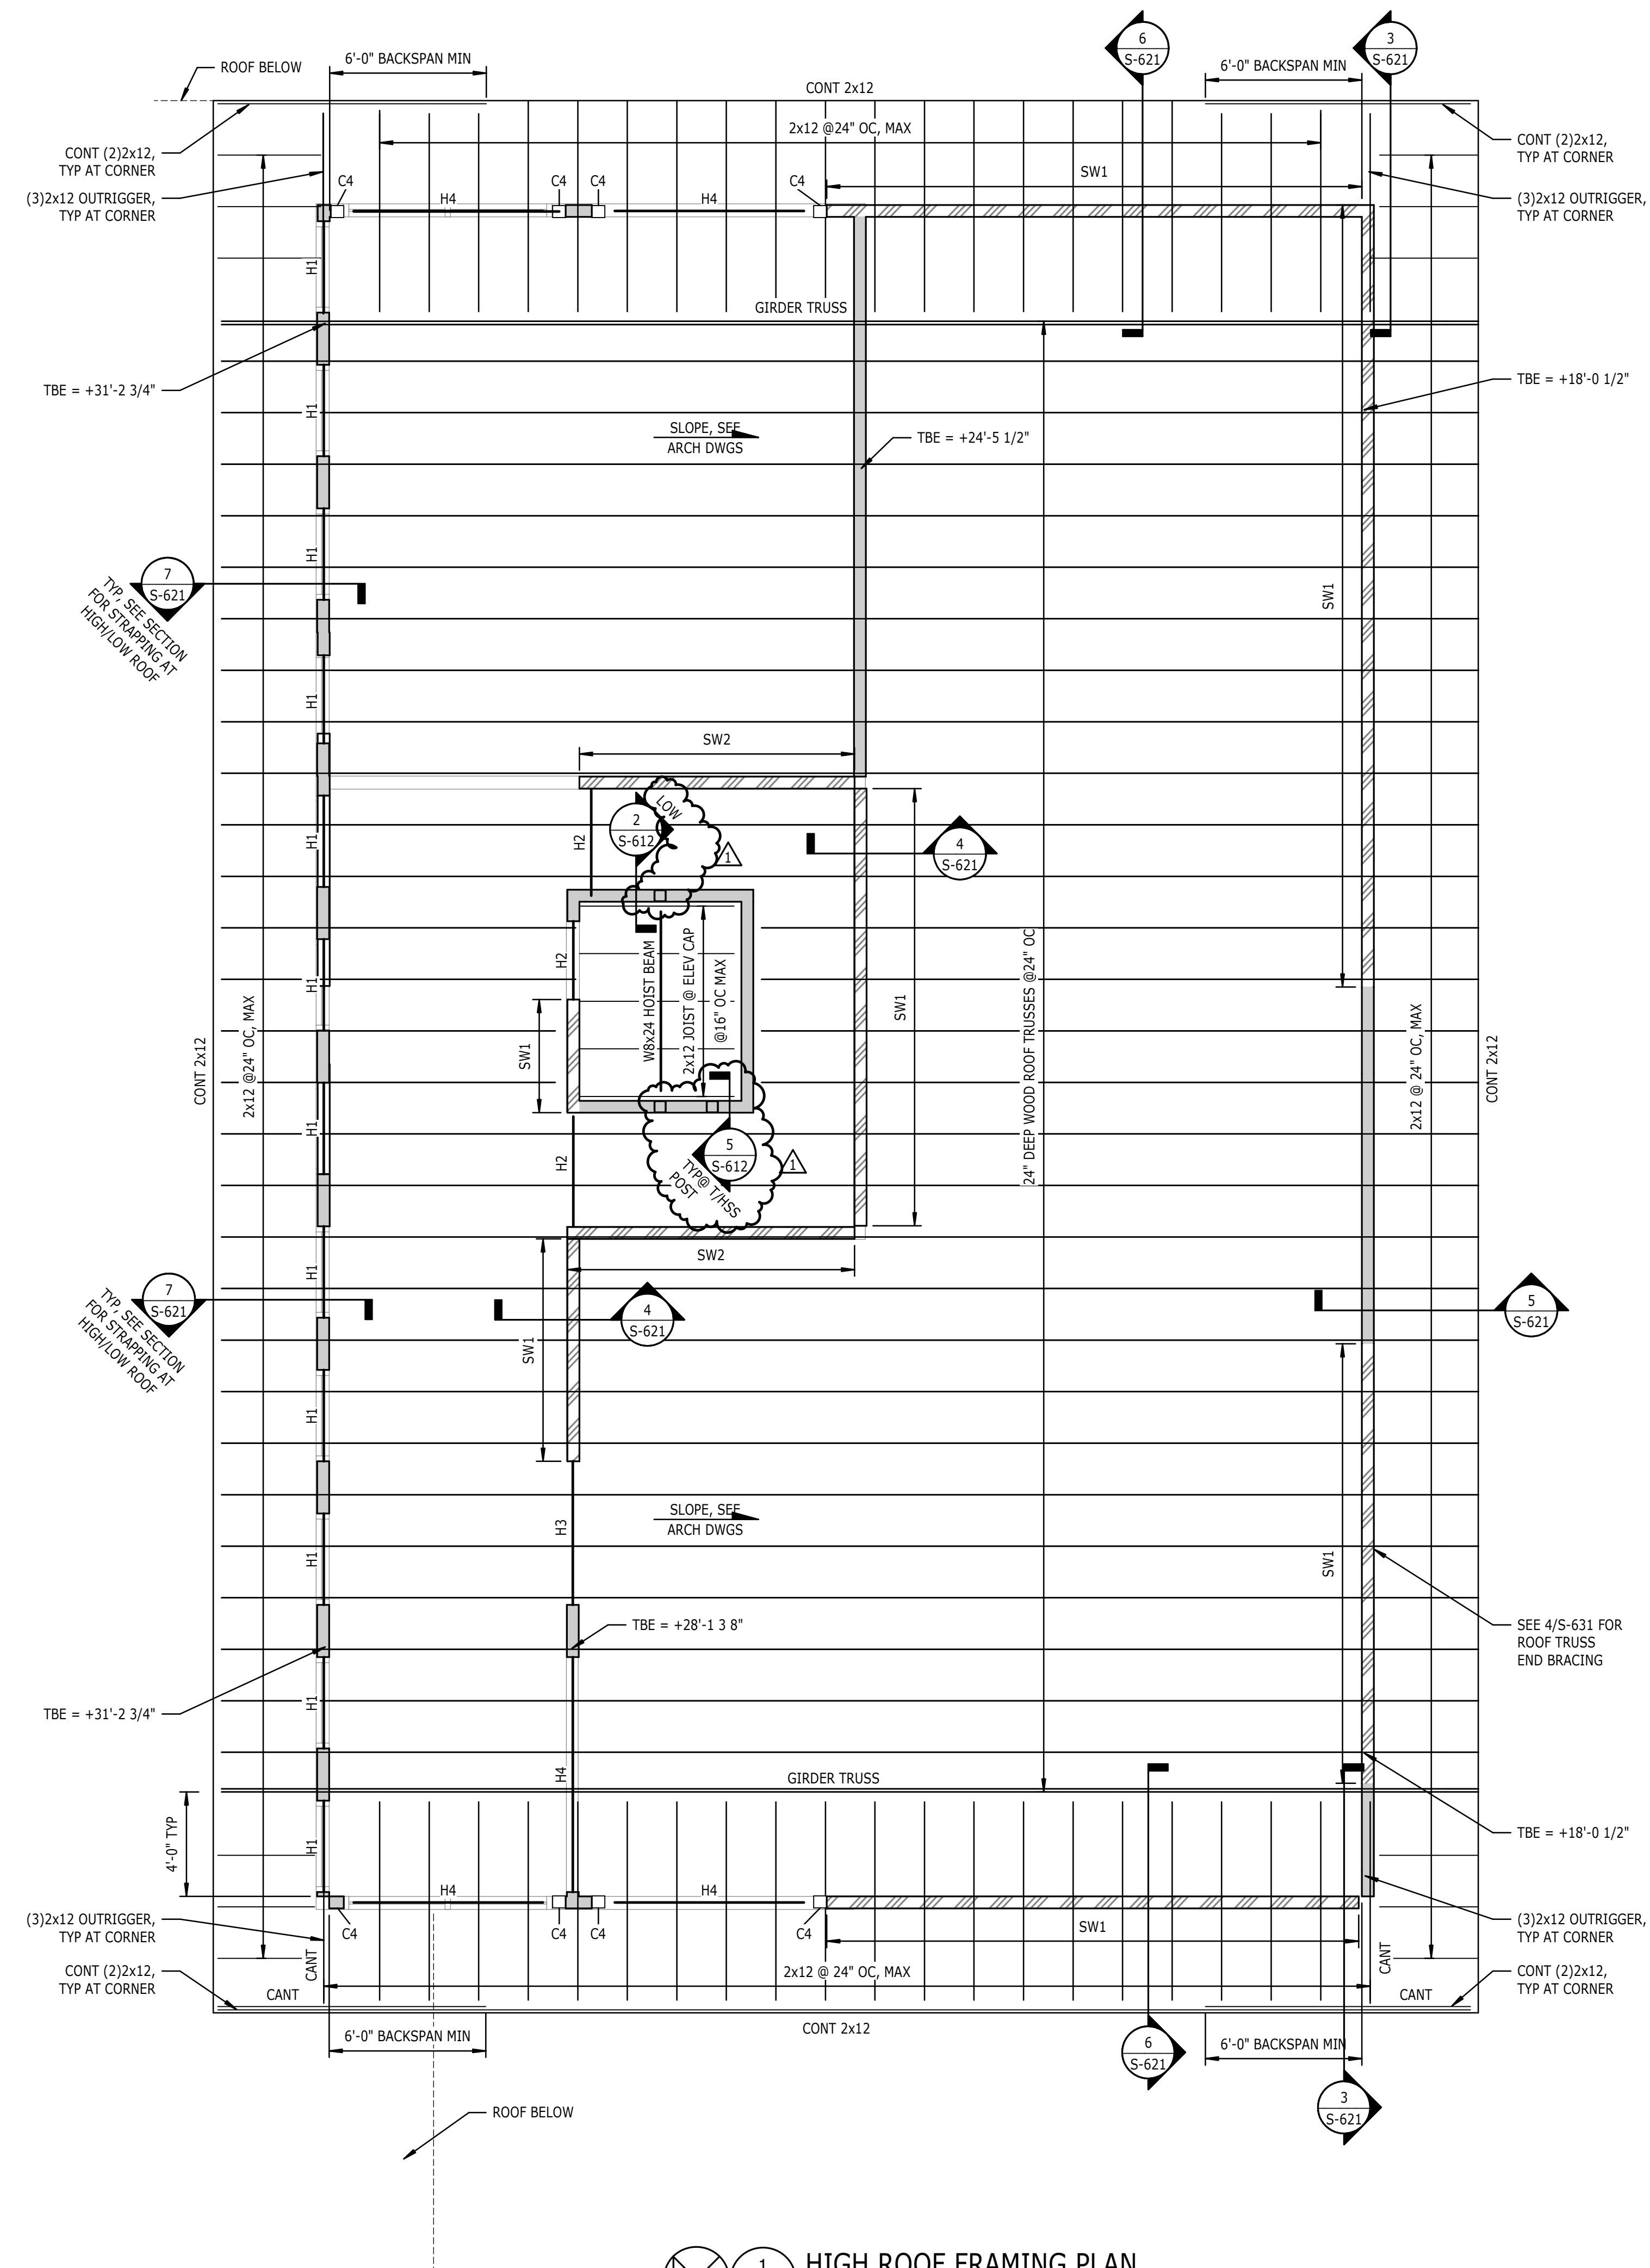
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1 HIGH ROOF FRAMING PLAN
1/4" = 1'-0"

- ROOF FRAMING PLAN NOTES:
- SEE S-600'S FOR TYPICAL WOOD ROOF FRAMING DETAILS.
 - INDICATES WOOD ROOF TRUSSES SPACED @ 24" OC, UNO.
 - "TBE = +#'-#"" INDICATES ROOF TRUSS BEARING ELEVATION ABOVE REFERENCE FINISHED FLOOR ELEVATION, UNO.
 - PROVIDE DOUBLE STUDS UNDER ALL WOOD HEADER, BEAM, HIP TRUSS, AND TRUSS GIRDER BEARING LOCATIONS, UNO.
 - PROVIDE FLOOR TRUSSES UNDER ALL INTERIOR NON-LOAD BEARING SHEAR WALLS WHERE SHEAR WALLS ARE PARALLEL TO FLOOR TRUSSES. SEE PLANS FOR LOCATIONS.
 - DIMENSIONS ARE TO OUTSIDE FACE OF FRAMING, UNO. REFER TO ARCHITECTURAL DRAWINGS FOR ALL WALL LOCATIONS AND DIMENSIONS.
 - SEE ARCHITECTURAL DRAWINGS FOR ALL ROOF SLOPES.

LOAD BEARING WALL LEGEND:
 INDICATES LOAD BEARING WALL.
 INDICATES LOAD BEARING WOOD SHEAR WALL.
 INDICATES LOAD BEARING WALL ABOVE
 SEE 1/S-601 FOR WOOD STUD WALL SCHEDULE.

REVISIONS

1 03/17/2023 BD-02

DATE SEPTEMBER 9, 2022

PROJECT NUMBER 9189-000

SHEET TITLE

**HIGH ROOF
FRAMING PLAN**

SHEET NUMBER

S-121