


# NEW TERMINAL BUILDING

WBS NO. 36237.25.15.1

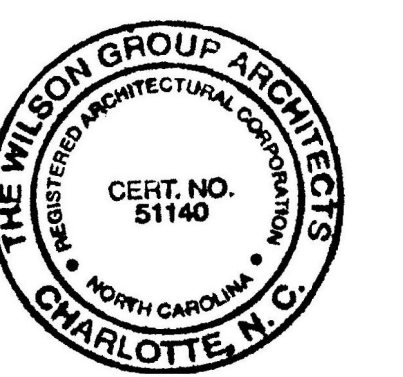

ARCHITECT  
**THE WILSON GROUP**  
 P O BOX 5510  
 CHARLOTTE, NC 28229  
 (704) 331-9747

PROJECT MANAGER / CIVIL ENGINEER  
**TALBERT & BRIGHT**  
 4810 SHELLEY DRIVE  
 WILMINGTON, NC 28405  
 (810) 783-5360  
 FIRM NO.: C-0713

STRUCTURAL ENGINEER  
**STEWART**  
 101 N. TRYON ST., SUITE 1400  
 CHARLOTTE, NC 28202  
 (704) 909-3523  
 FIRM NO.: C-1051

MECHANICAL, ELECTRICAL, PLUMBING & FIRE PROTECTION ENGINEER  
**SABER ENGINEERING**  
 2923 S. TRYON ST., SUITE 280  
 CHARLOTTE, NC 28203  
 (704) 373-0068  
 FIRM NO.: C-2130

IT / SECURITY  
**VERTEX TECHNOLOGY CONSULTANTS**  
 4700 LEBANON RD., SUITE A-1  
 CHARLOTTE, NC 28227  
 (860) 272-8500

REVISIONS  
 △ BD-05 - JUNE 19, 2023

DATE SEPTEMBER 9, 2022  
 PROJECT NUMBER 9189-000

## FIRST LEVEL REFLECTED CEILING PLAN



SHEET NUMBER

# A-121

SF SUMMARY	
	AREA SF
FIRST LEVEL HSF	5,087 HSF
FIRST LEVEL PORCHES SF	843 UHSF
SECOND LEVEL HSF	1,948 HSF
SECOND LEVEL DECK SF	416 UHSF
TOTAL HSF	7,035 HSF

WALL LEGEND	
1 HR RATED WALL	-----
STUD WALL	=====
BRICK VENEER	
SHEAR WALL	=====

- NOTES
1. CEILING HEIGHT TO BE 10'-0" A.F.F. U.N.O.
  2. LIGHT FIXTURES AND SPEAKERS TO BE CENTERED WITHIN ROOMS, TYP. UNLESS NOTED OR SHOWN OTHERWISE. COORDINATE GRID LAYOUT WITH DEVICE LOCATIONS TYP.
  3. SEE FINISH SCHEDULE FOR ACOUSTICAL CEILING BASIS OF DESIGN. SEE SECTION DETAIL DRAWINGS FOR ADDITIONAL INFORMATION.

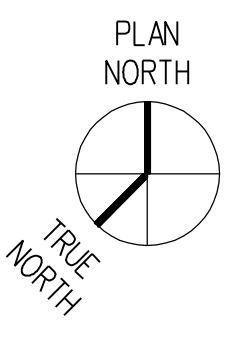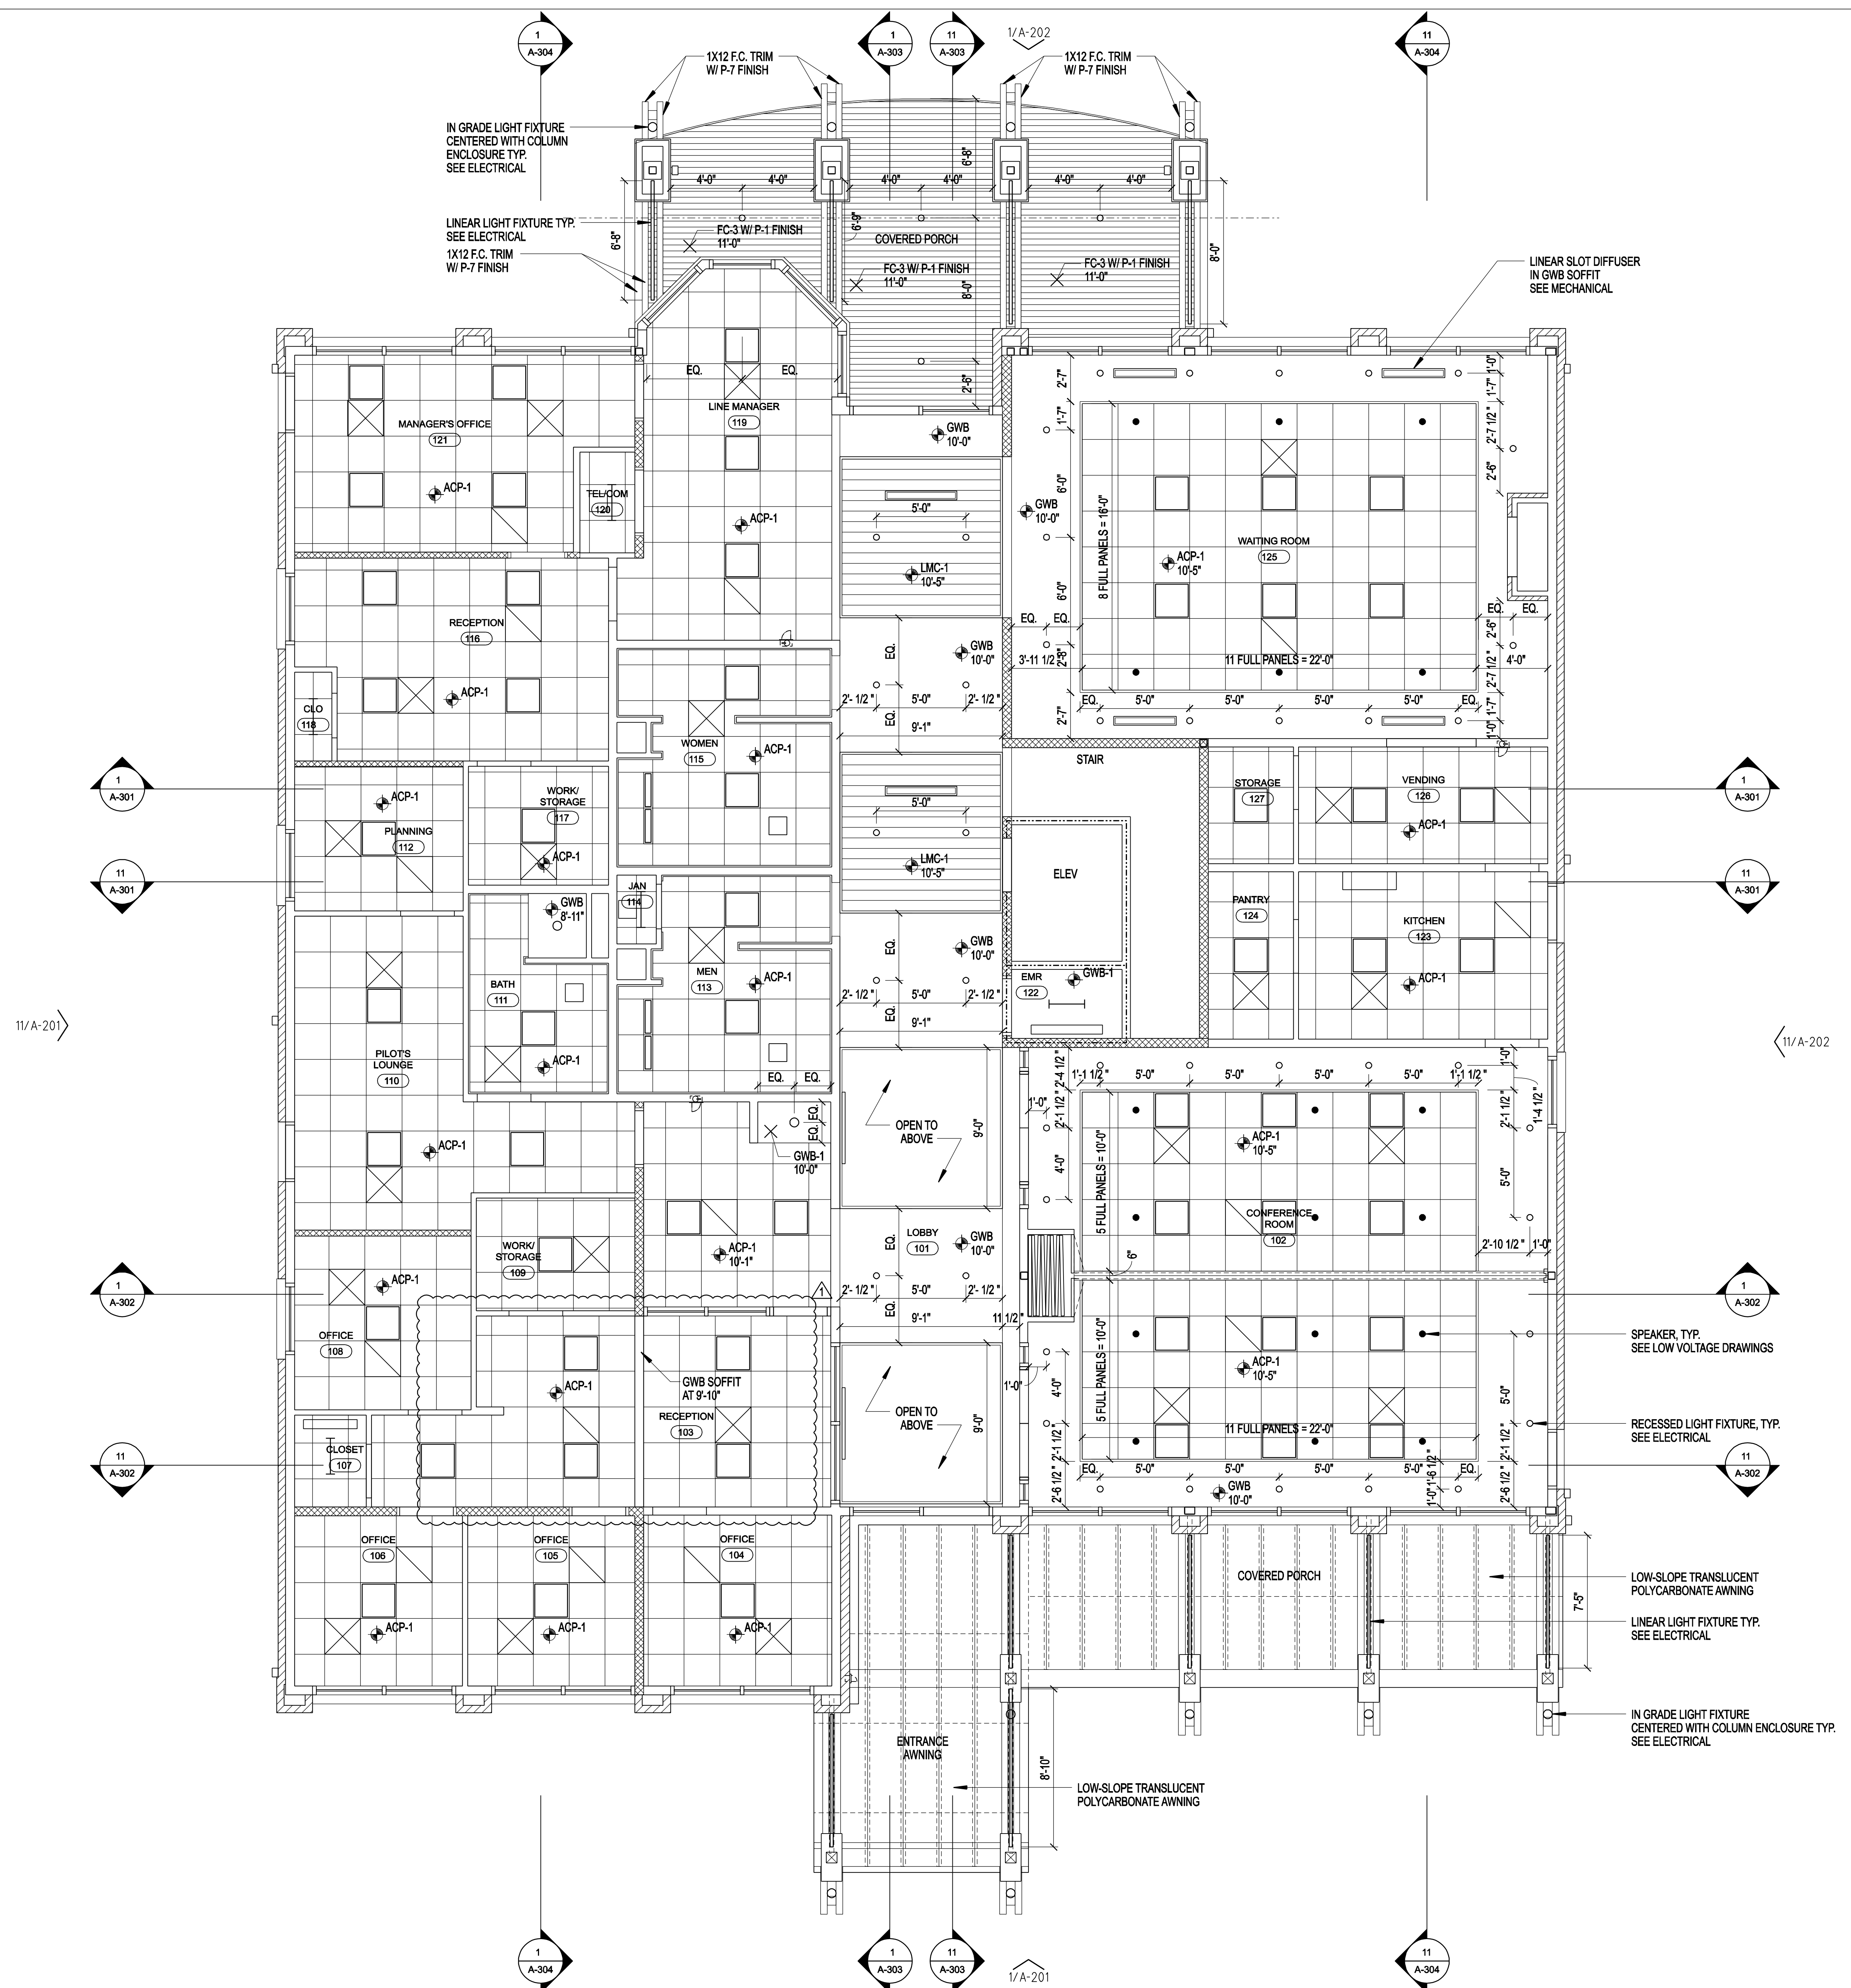

1/4"=1'-0"