


Kwik Bolt 3 Expansion Anchor Installation instructions

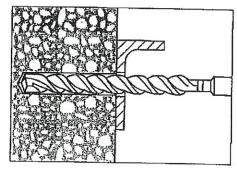

1. Hammer drill a hole to the same nominal diameter as the Kwik Bolt 3. The hole depth must exceed the anchor embedment by at least one diameter. The fixture may be used as a drilling template to ensure proper anchor location.

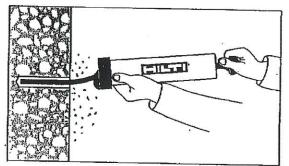


2. Clean hole.

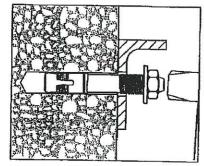

3. Drive the Kwik Bolt 3 into the hole using a hammer. The anchor must be driven until at least six threads are below the surface of the fixture.

DESIGN INFORMATION

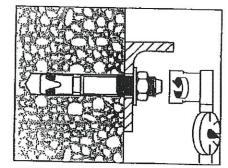


4. Tighten the nut to the recommended installation torque.


Nominal Anchor Diameter

Installation torque	(Nm)	(5)	(27)	40 (54)	60 (81)	110 (149)		
			3		A			
			The state of the s	EN				T
			X S	IGHES AS				
			(SE) N. 8				
	×		5-	26-16				
			1	00	REVISIONS	p-amort	DATE	BY


Kwik Bolt TZ Anchor Installation Instructions into normal-weight and lightweight concrete

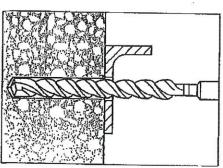


1. Hammer drill a hole to the same nominal diameter as the Kwik Bolt TZ. The hole depth must exceed the anchor embedment by at least 1/4 inch. The fixture may be used as a drilling template to ensure proper anchor location.

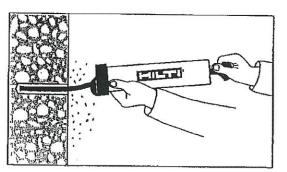

2. Clean hole.

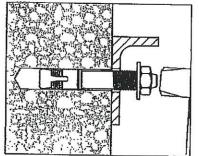

3. Drive the Kwik Bolt TZ Into the hole using a hammer. The anchor must be driven until at least 4 threads are below the surface of the fixture.

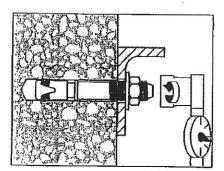

4. Tighten the nut to the recommended installation torque.

SETTING	Units	Nominal anchor diameter (m.)			
INFORMATION		3/8	1/2	5/8	3/4
Installation torque	(t-lb	25	40	60	110
	(Nm)	(34)	(54)	(81)	(149)


SHEET TITLE:





228 COMMERCE BLVD. STATESVILLE, NC 28625 (800)654-7813


Kwik Bo	It Anchor
Installation	Instructions


inocanación moci accións			
DRAWN BY:	BDL	APPROVED BY:	DRAWING NUMBER:
SCALE:	NTS	DATE: 11/8/2011	ERC016X

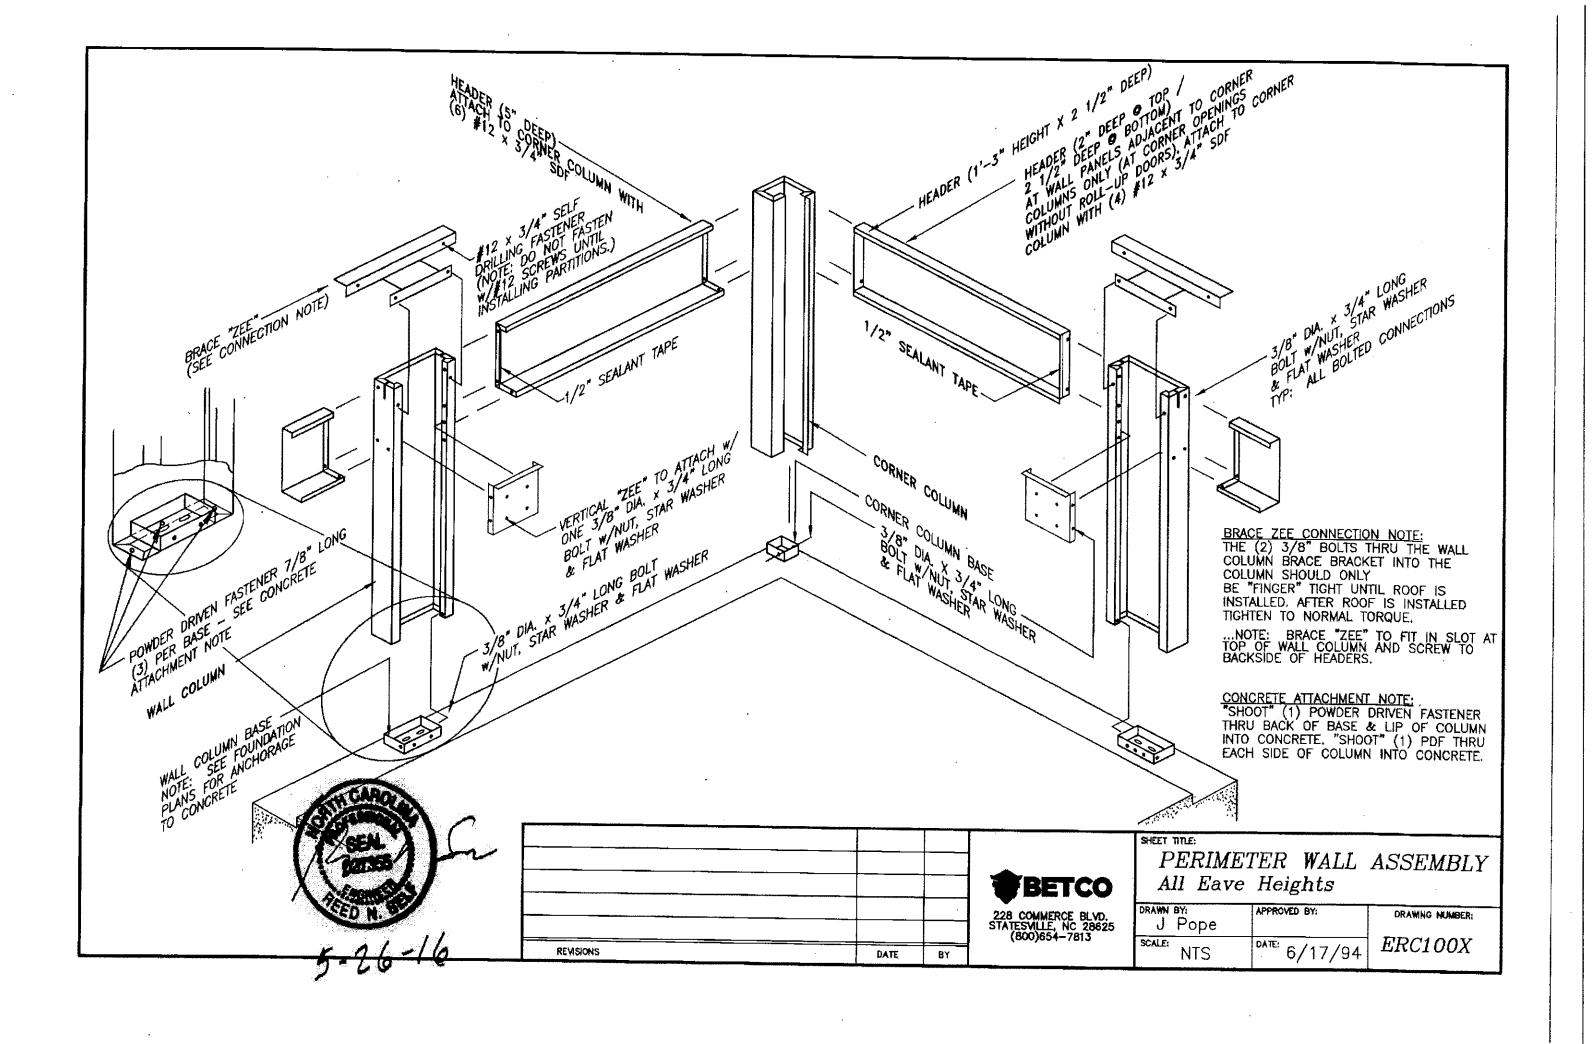


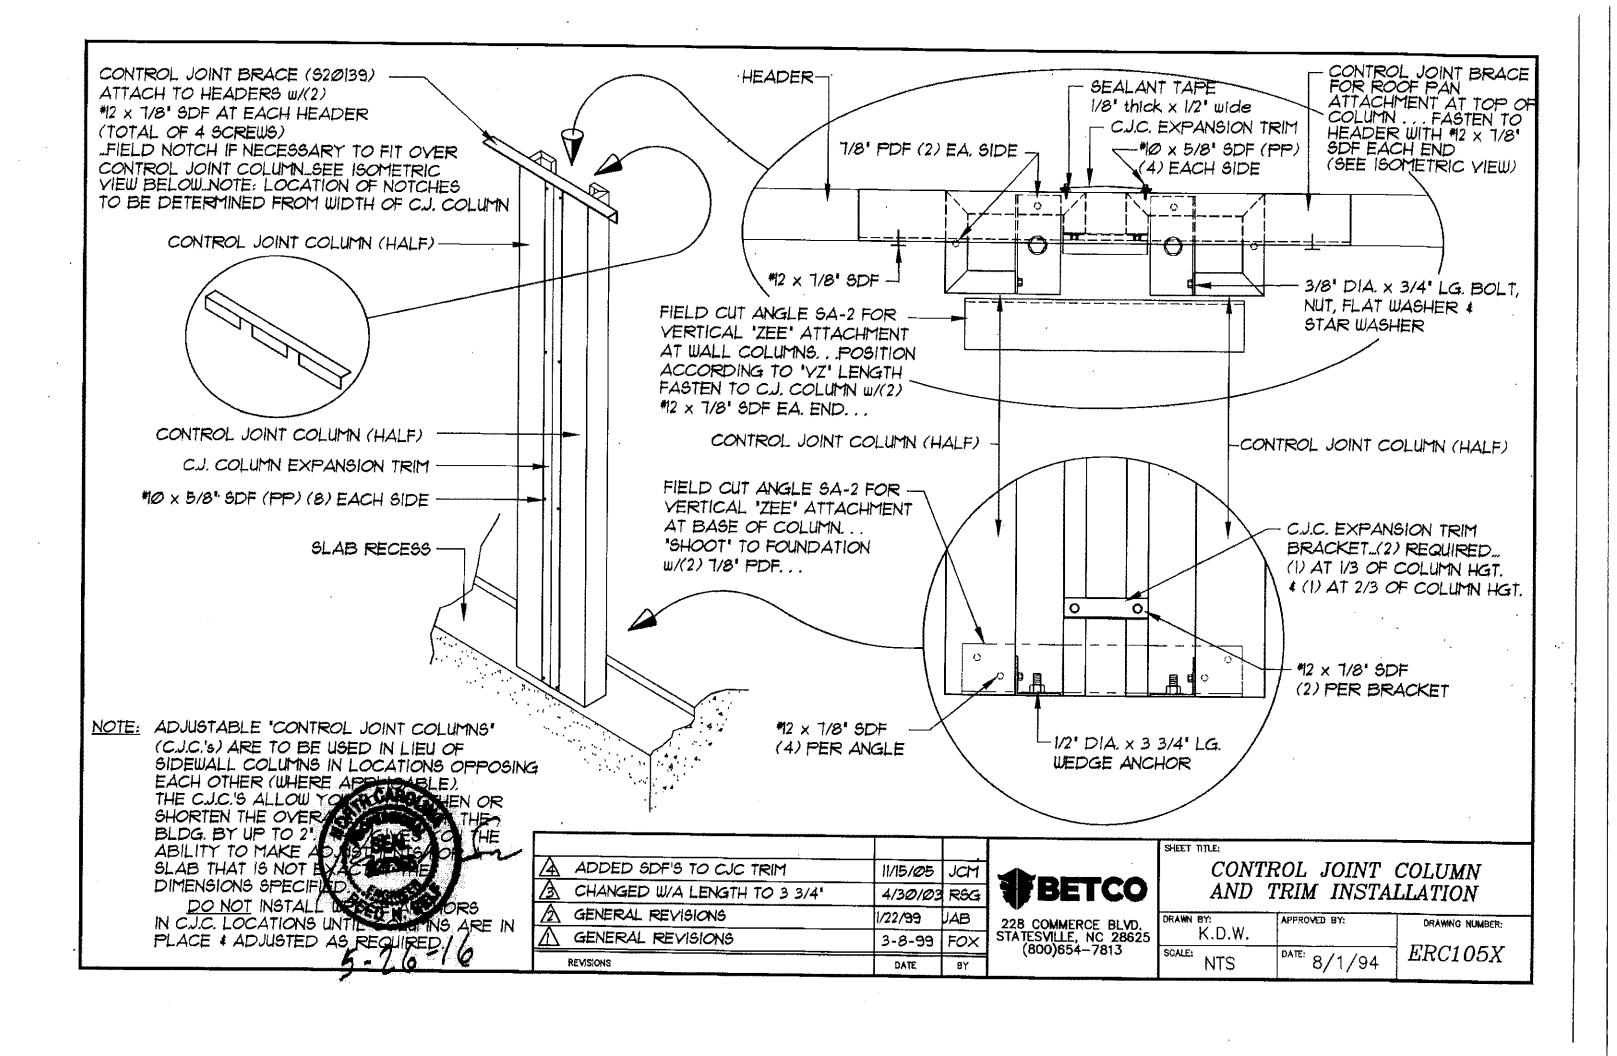


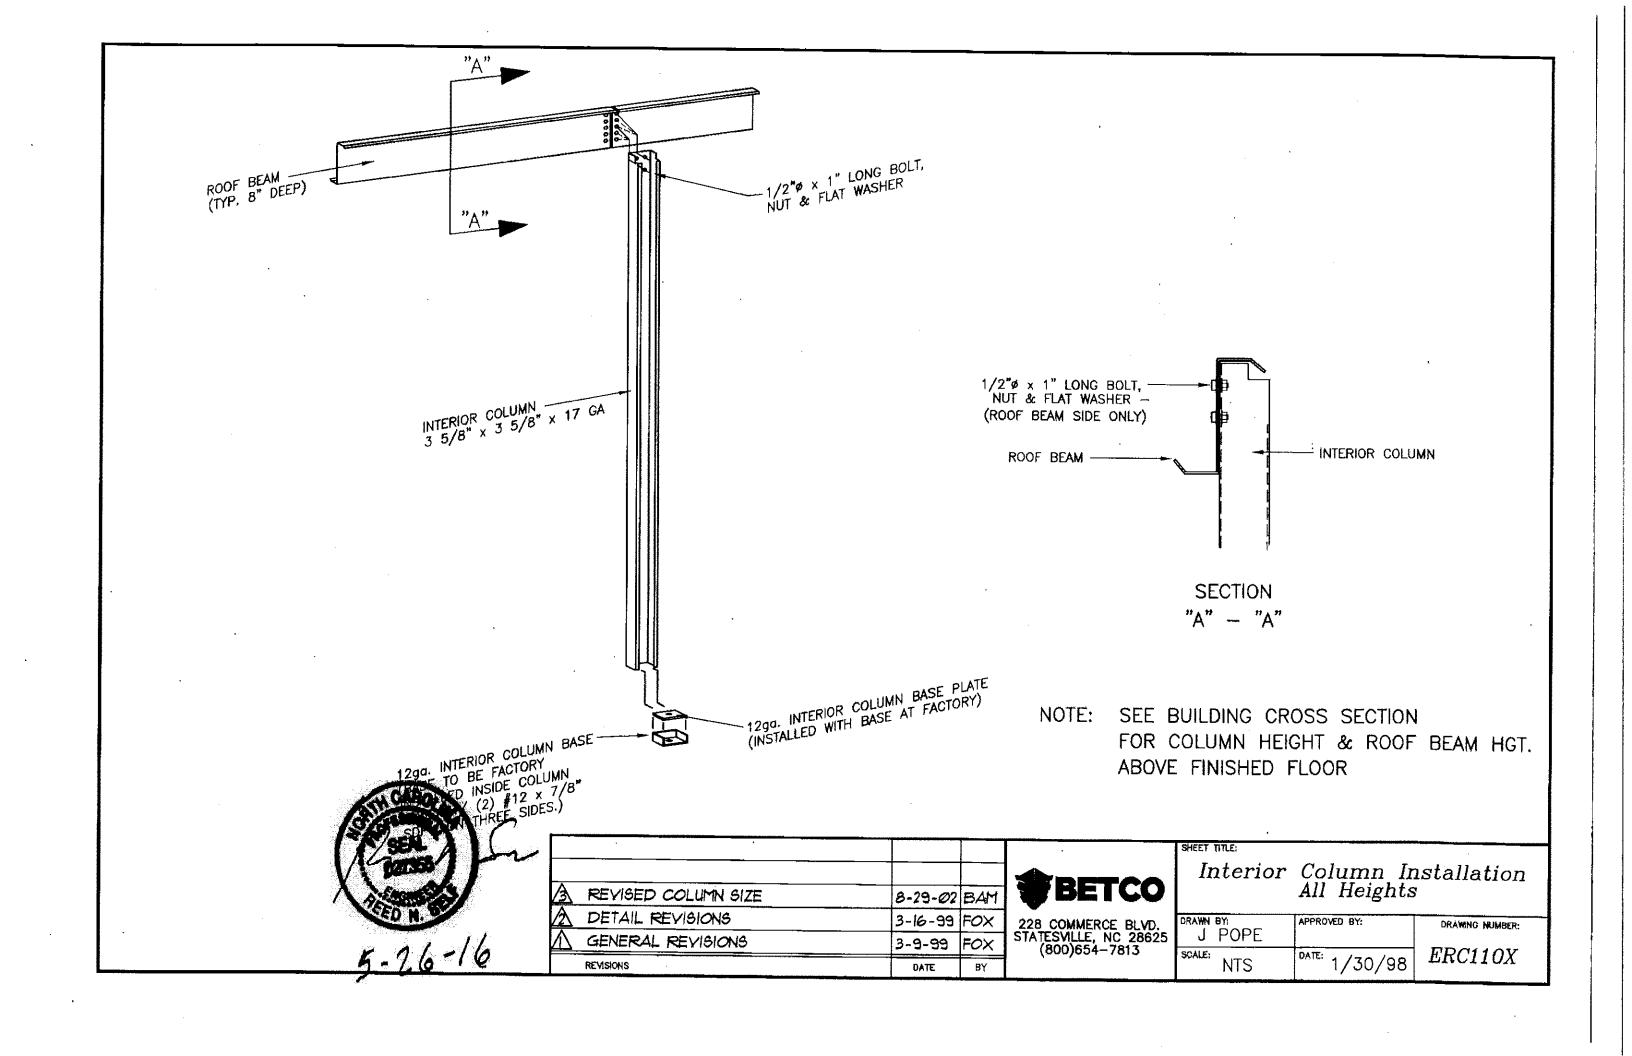


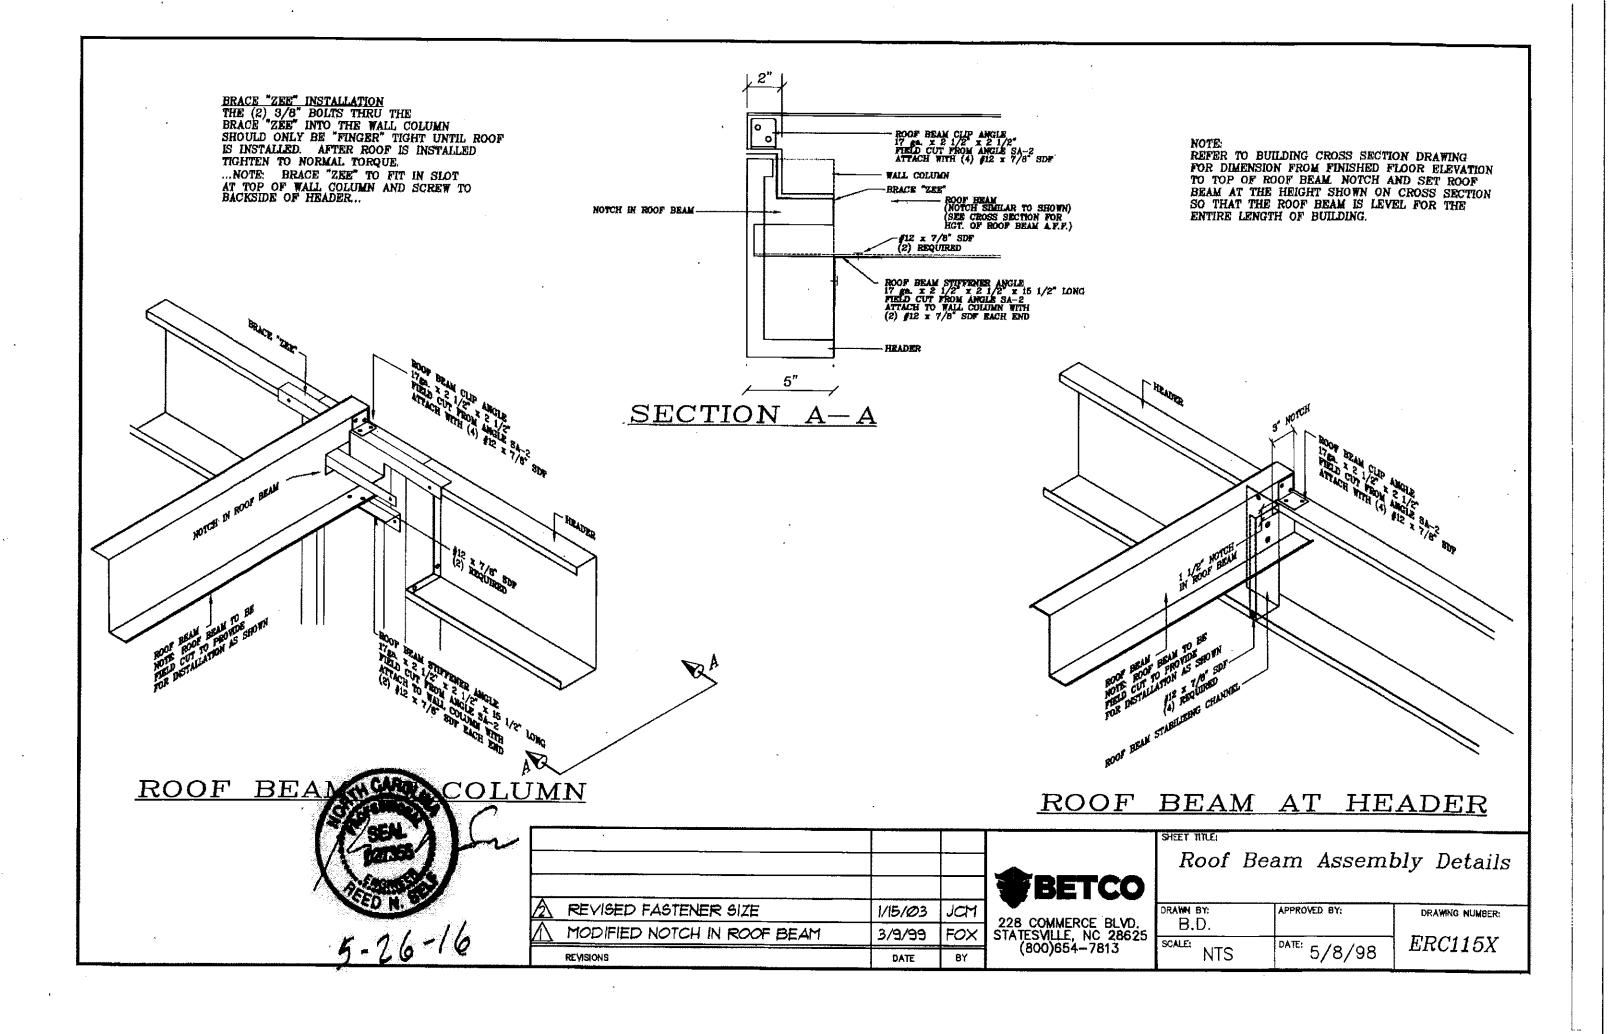


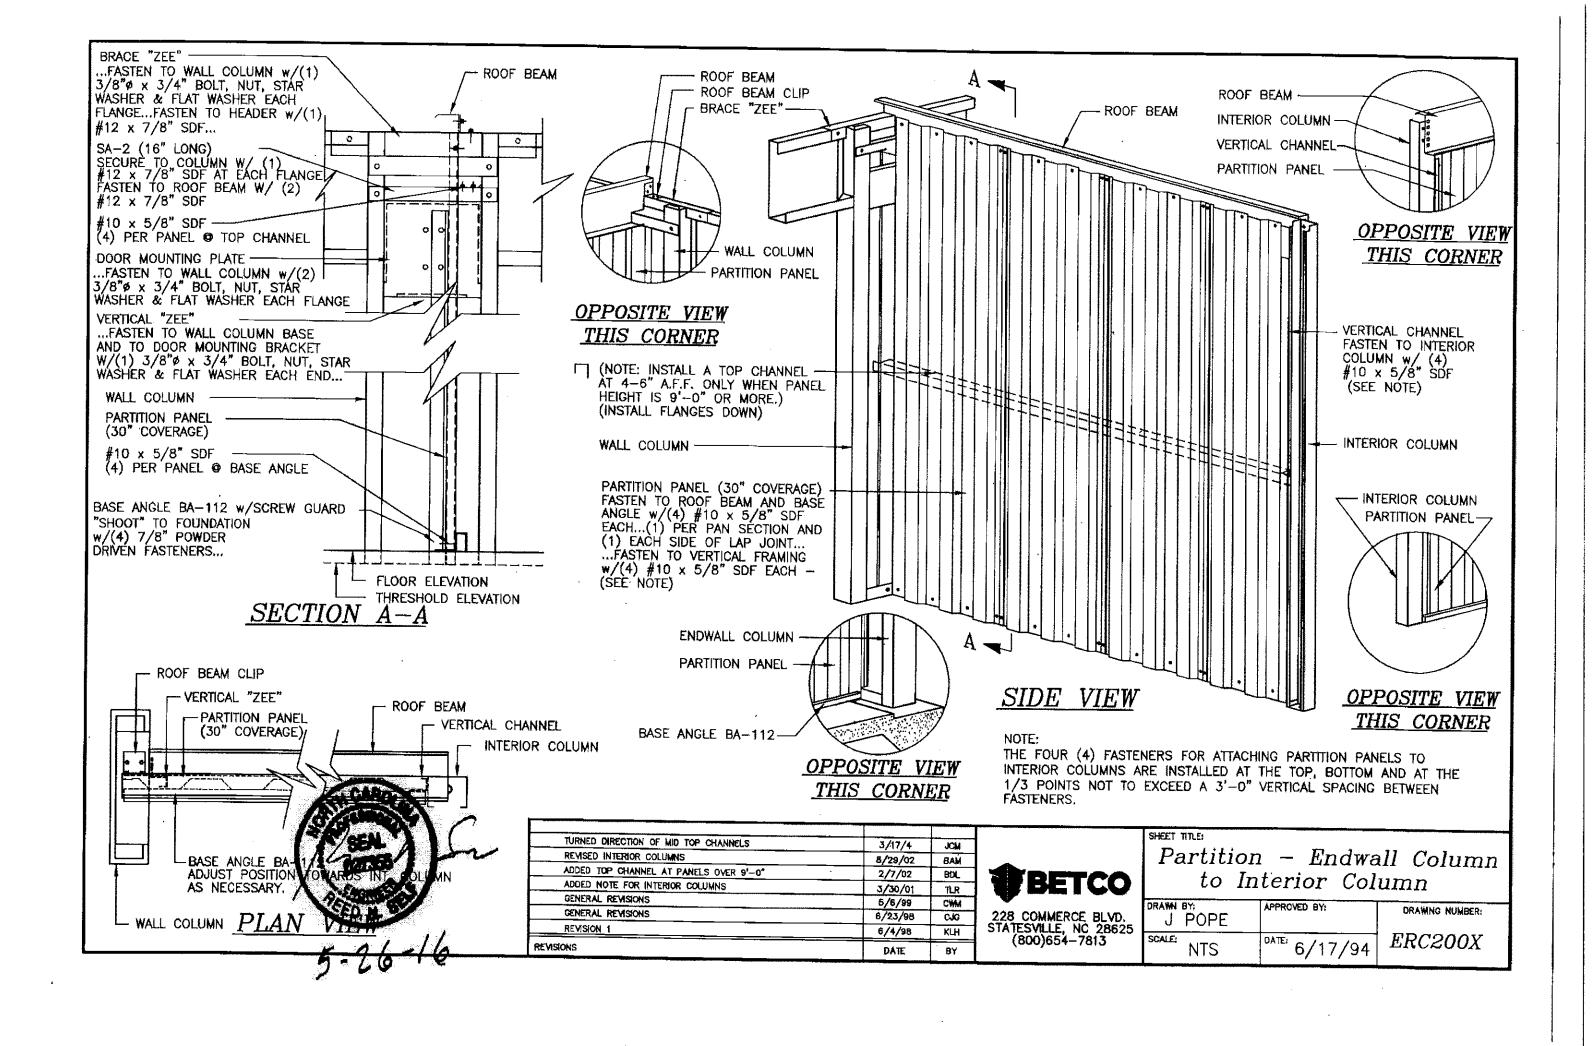


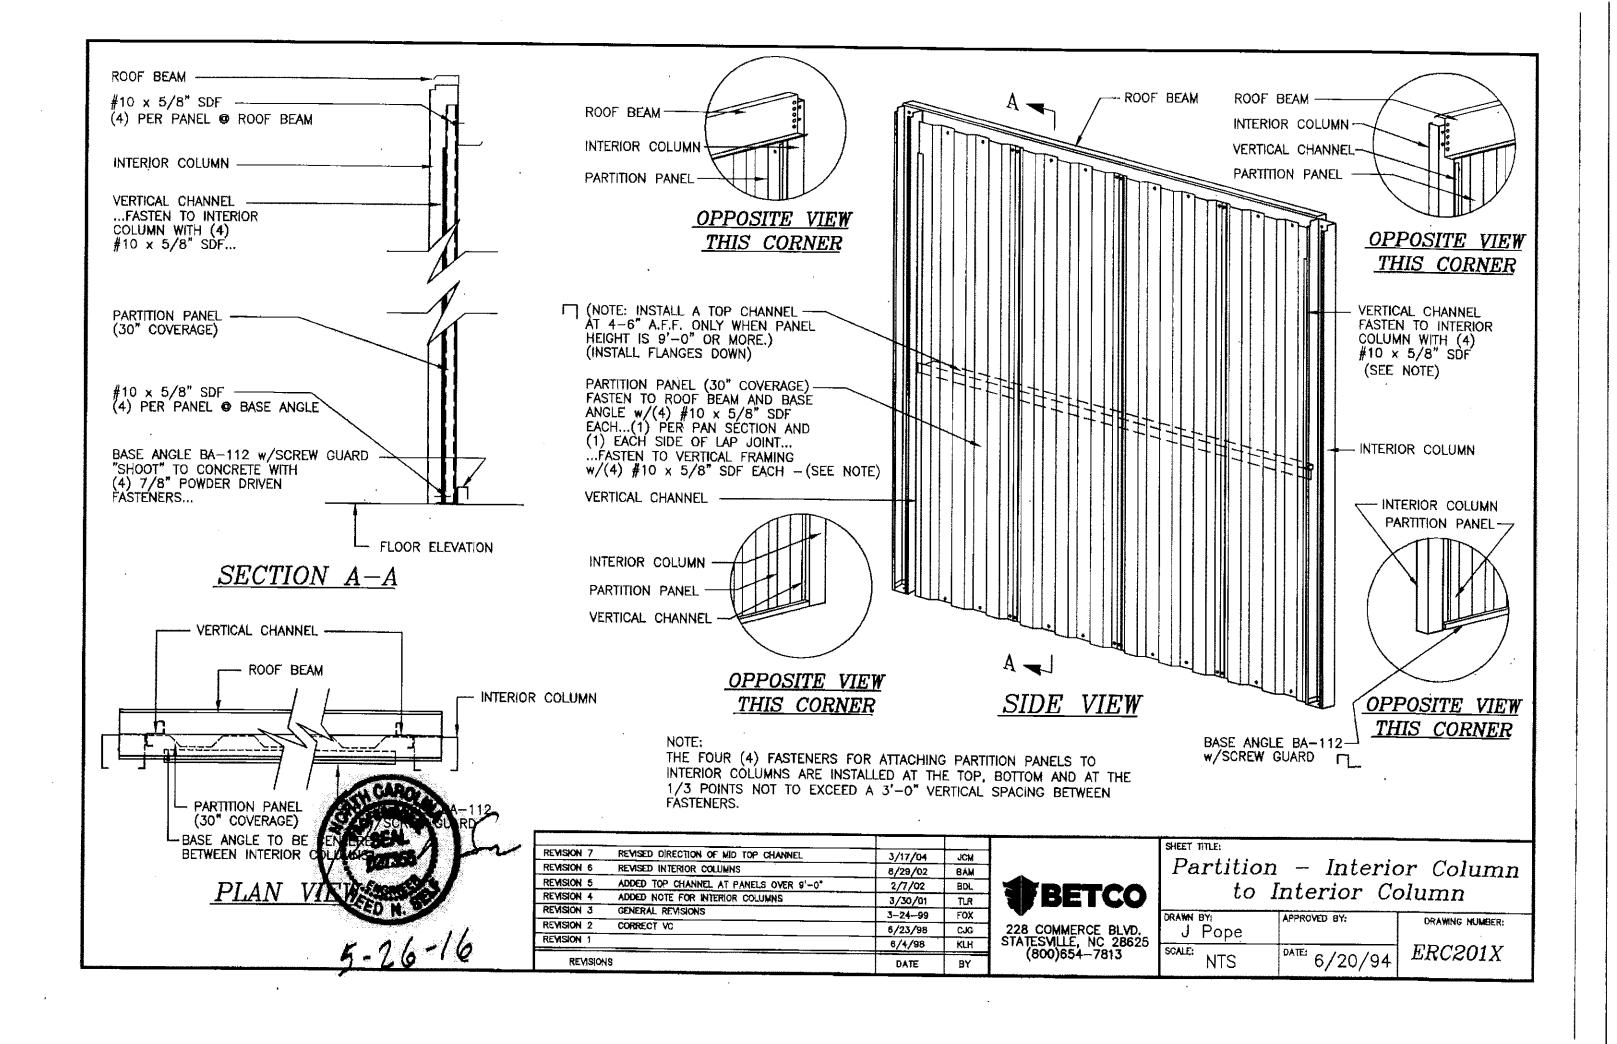


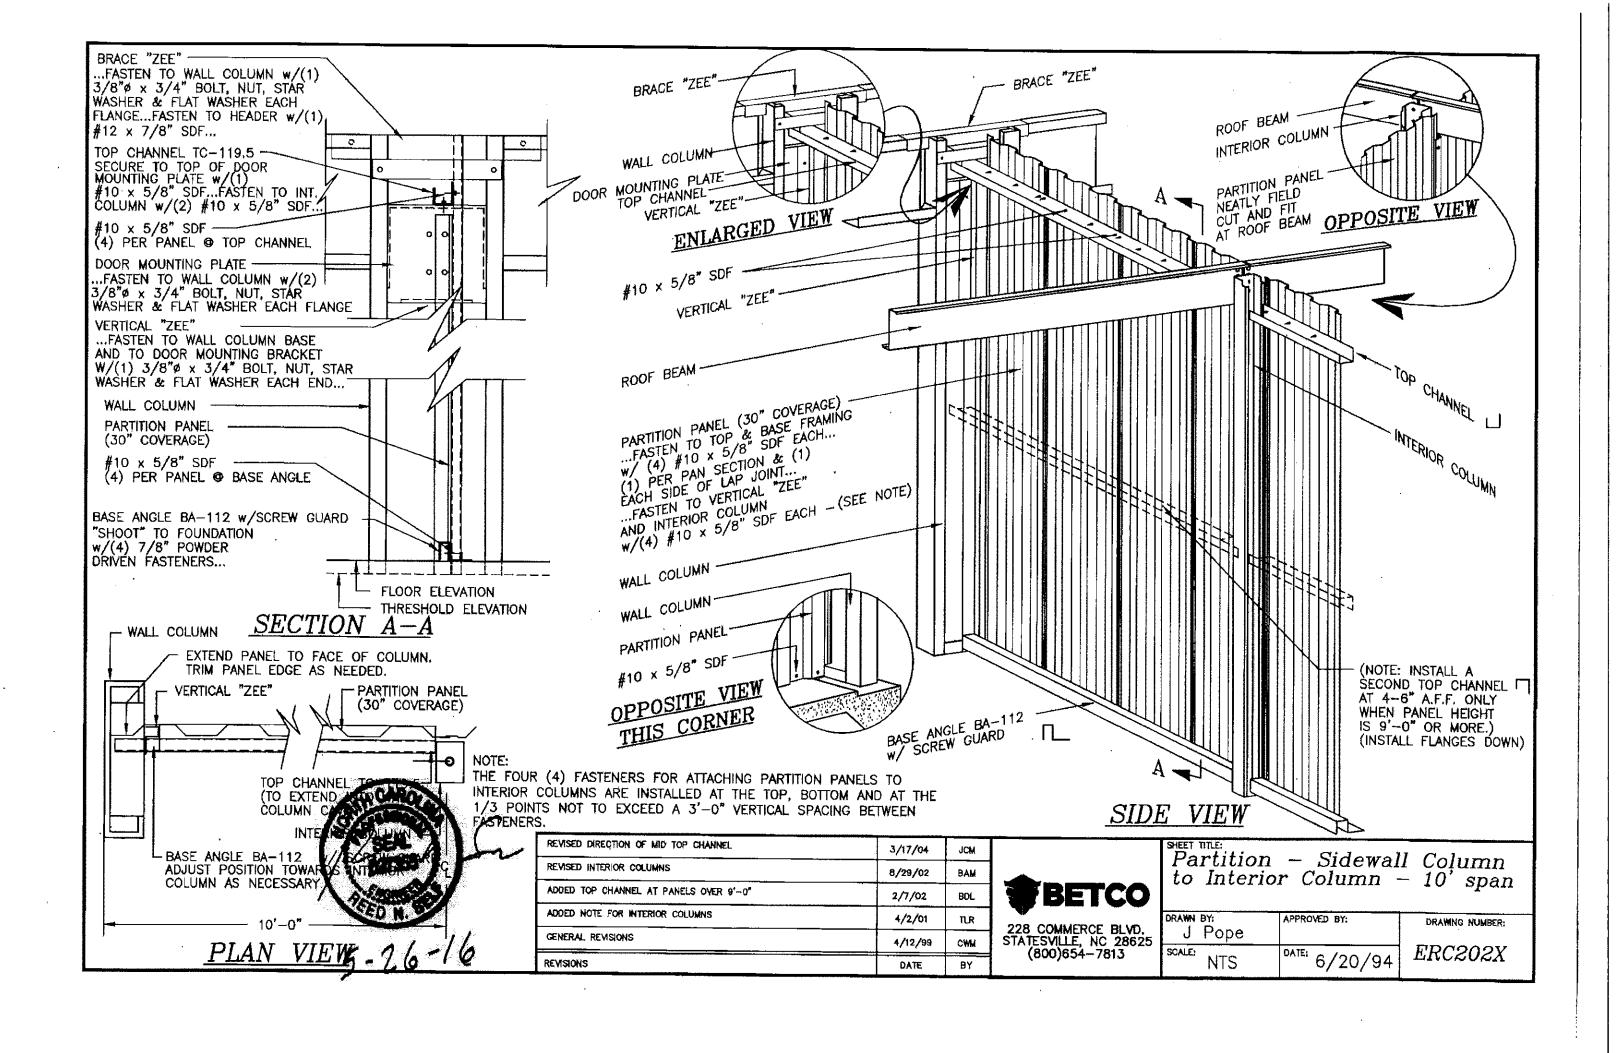


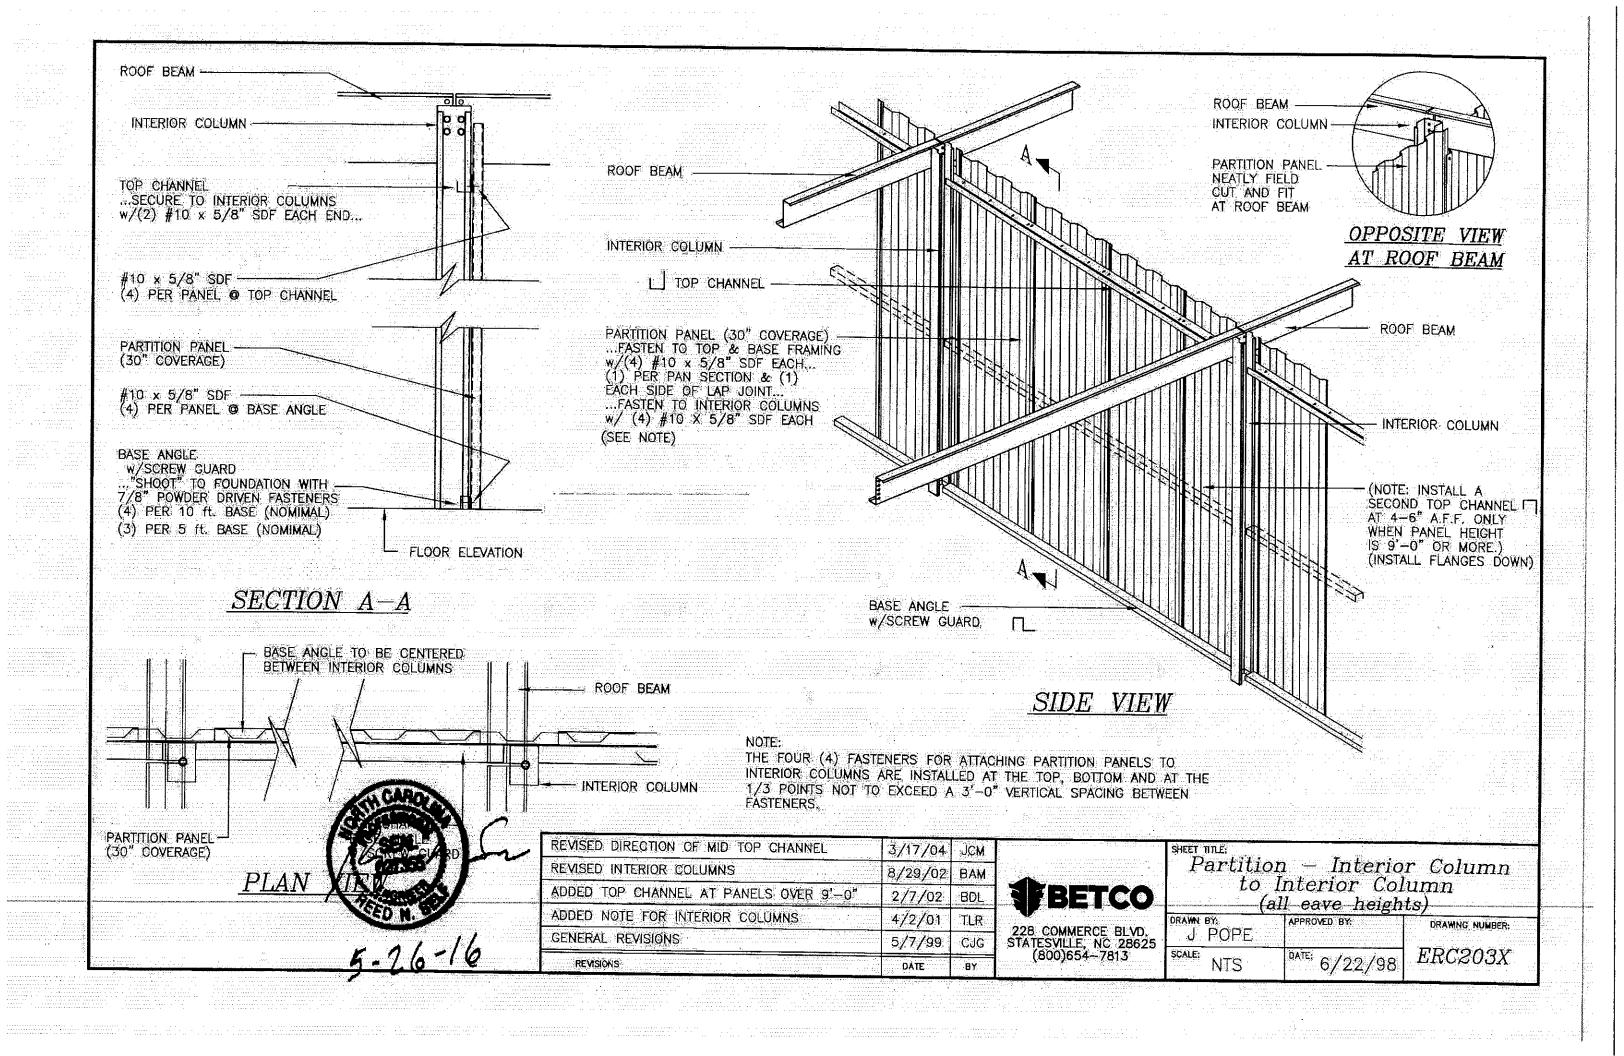


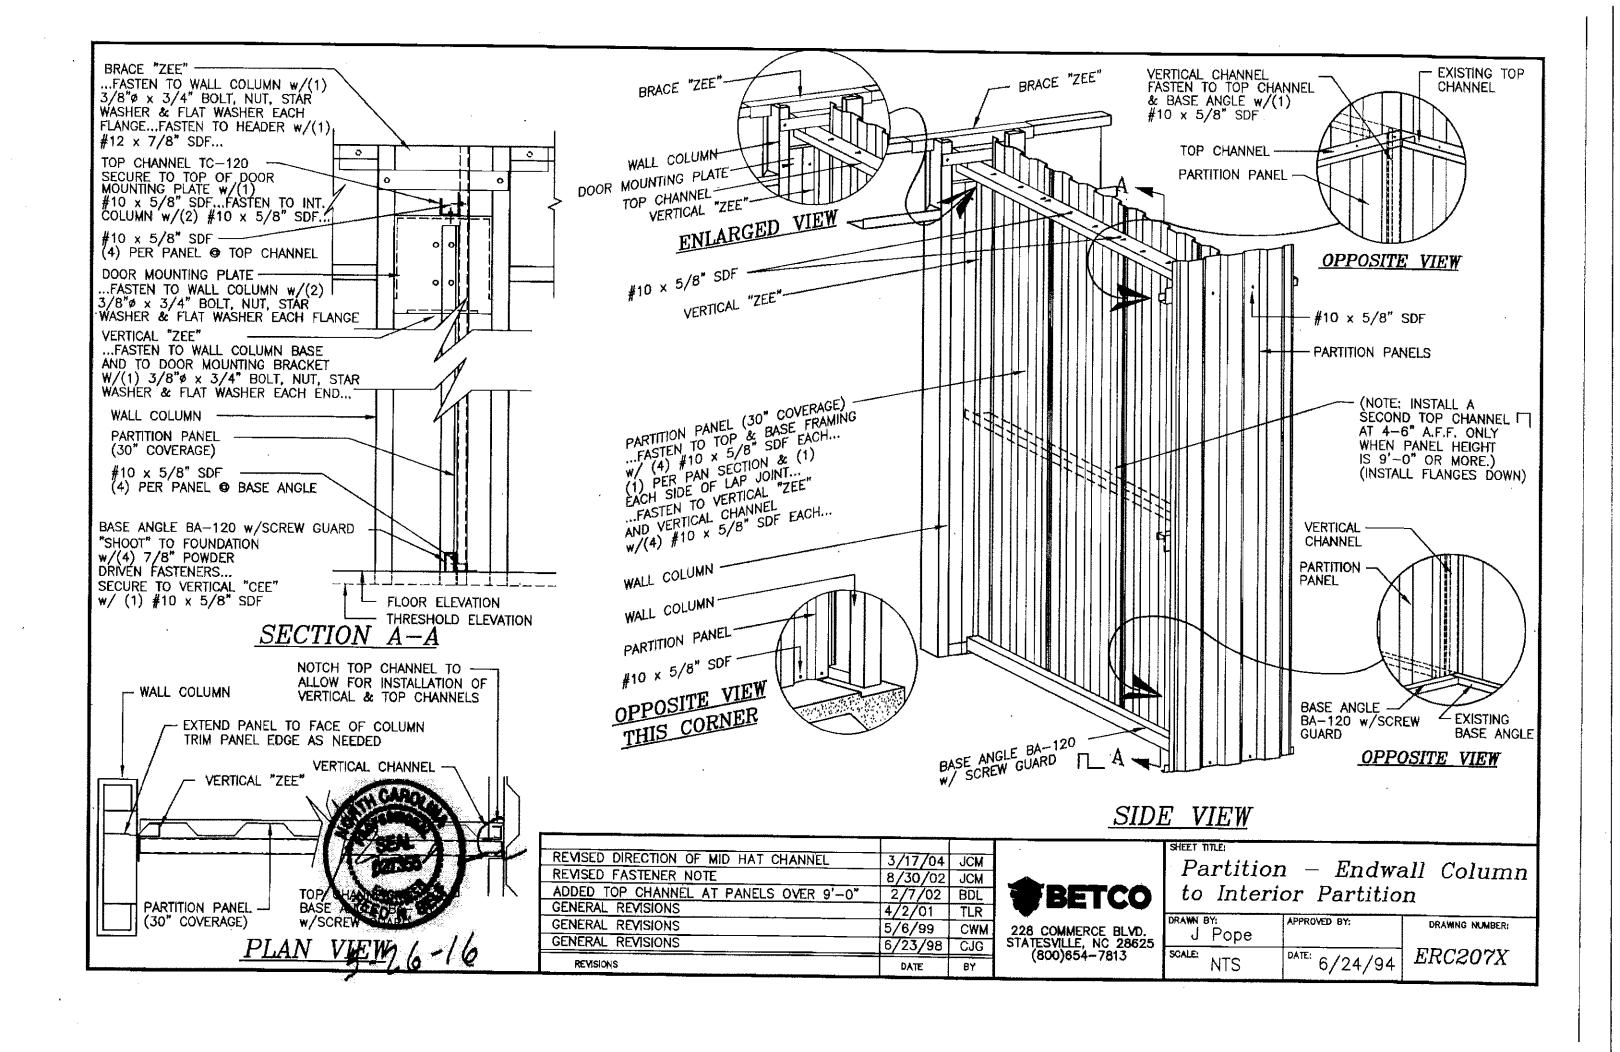


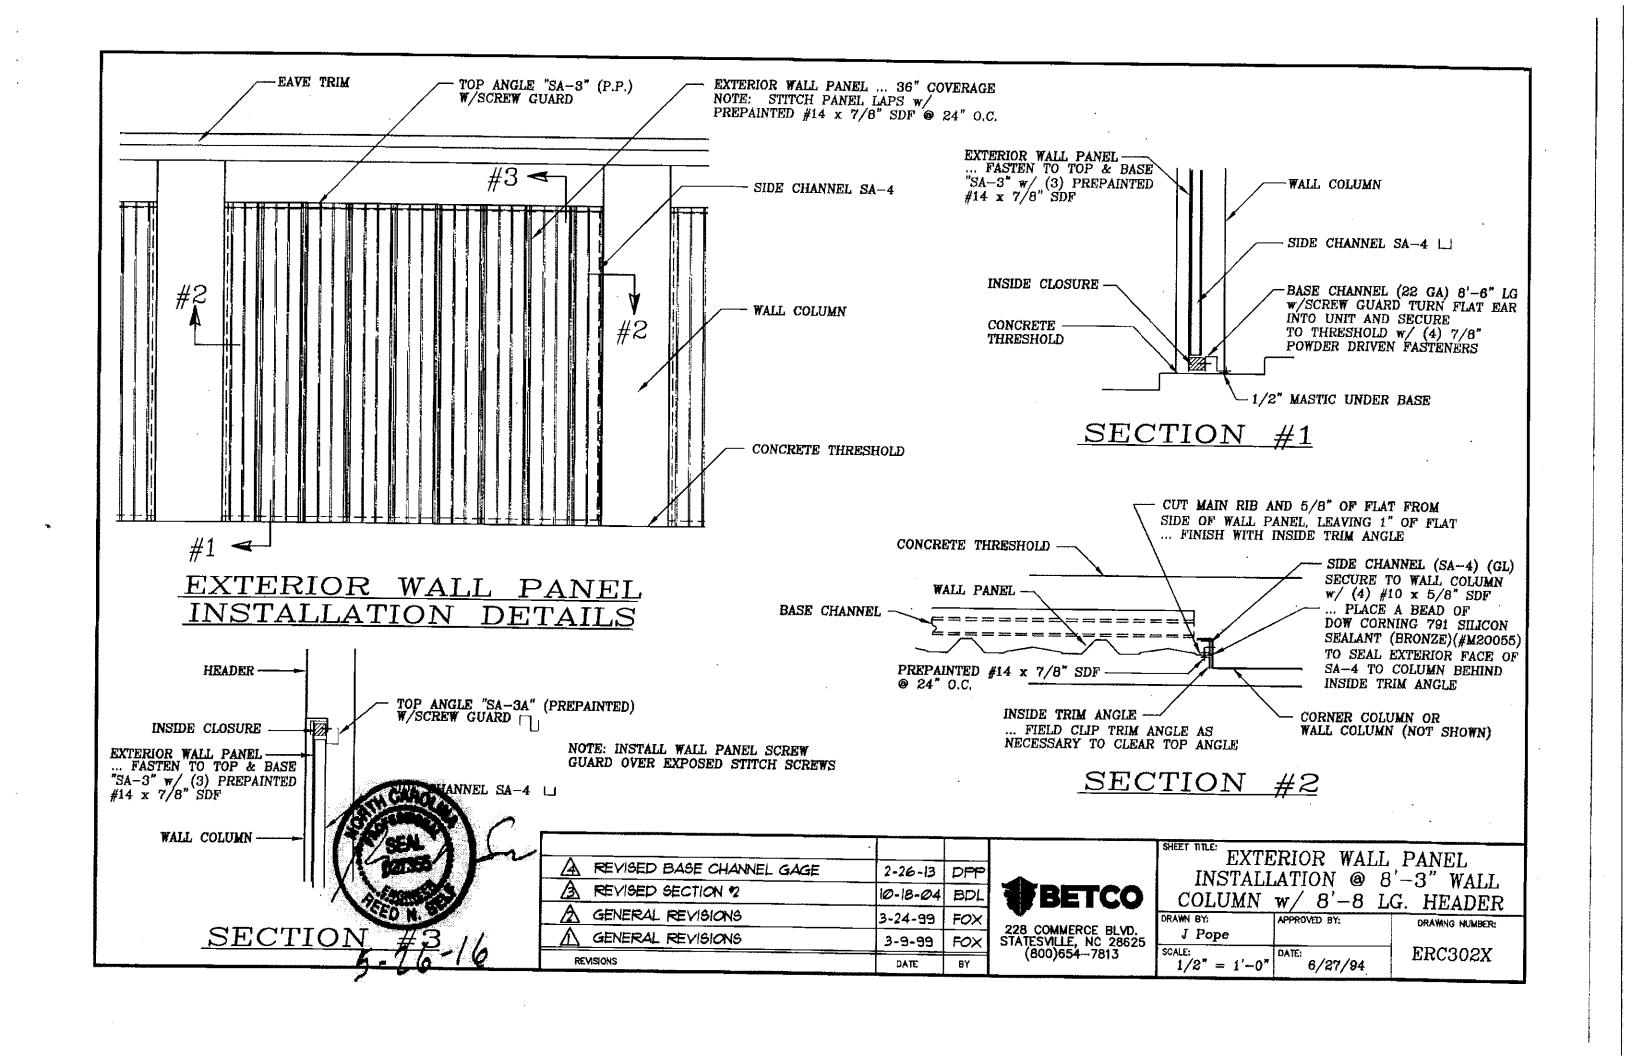


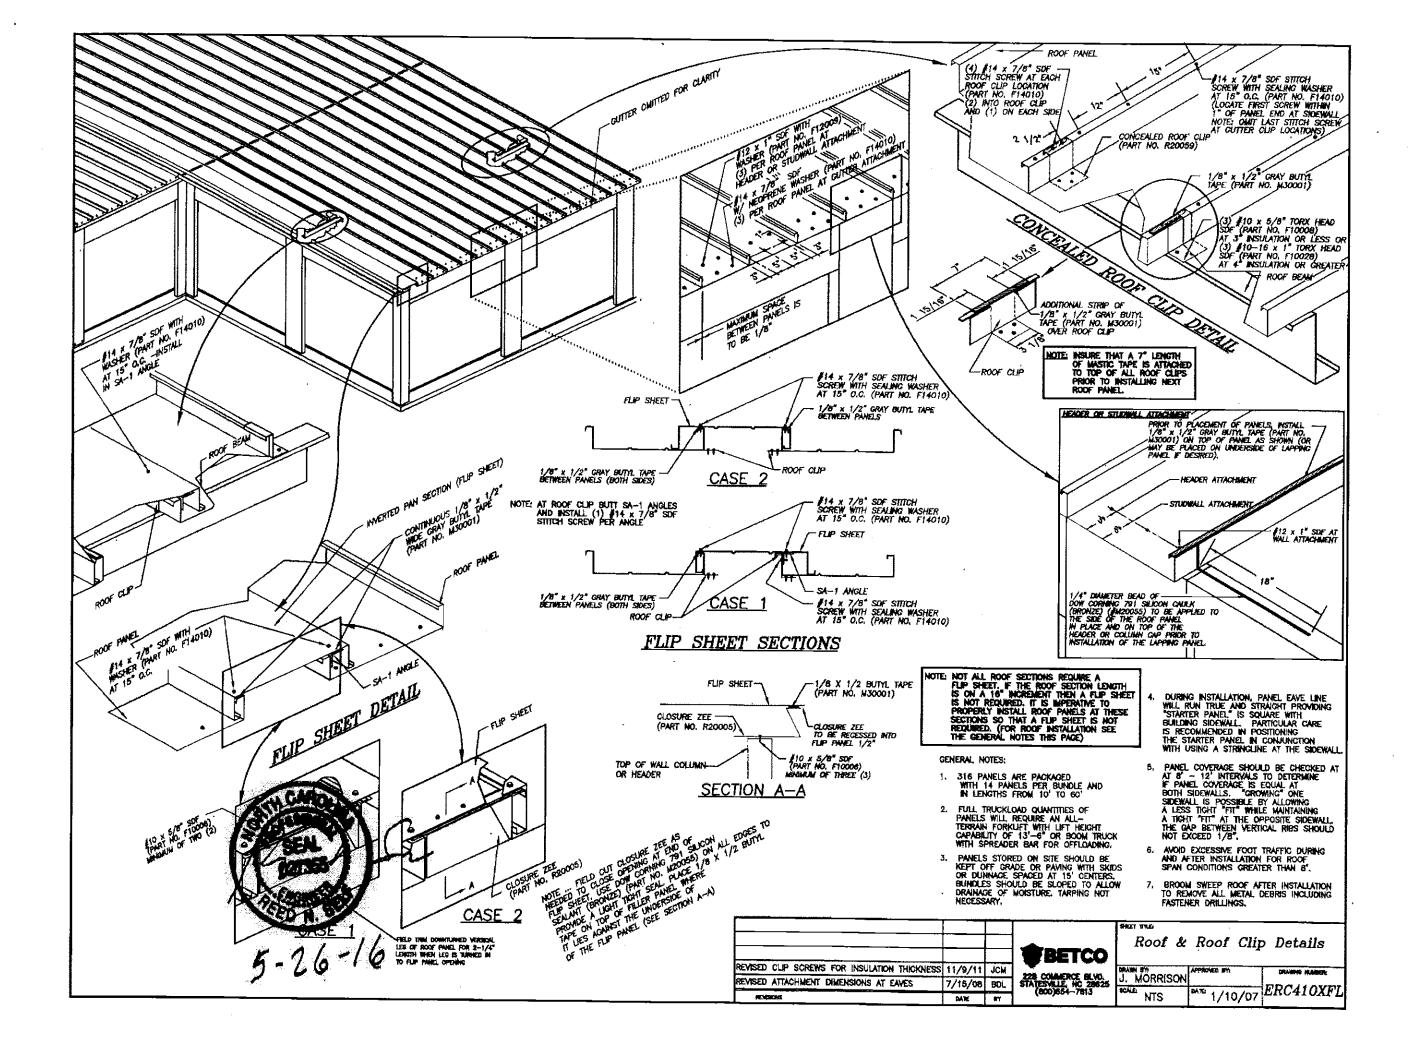

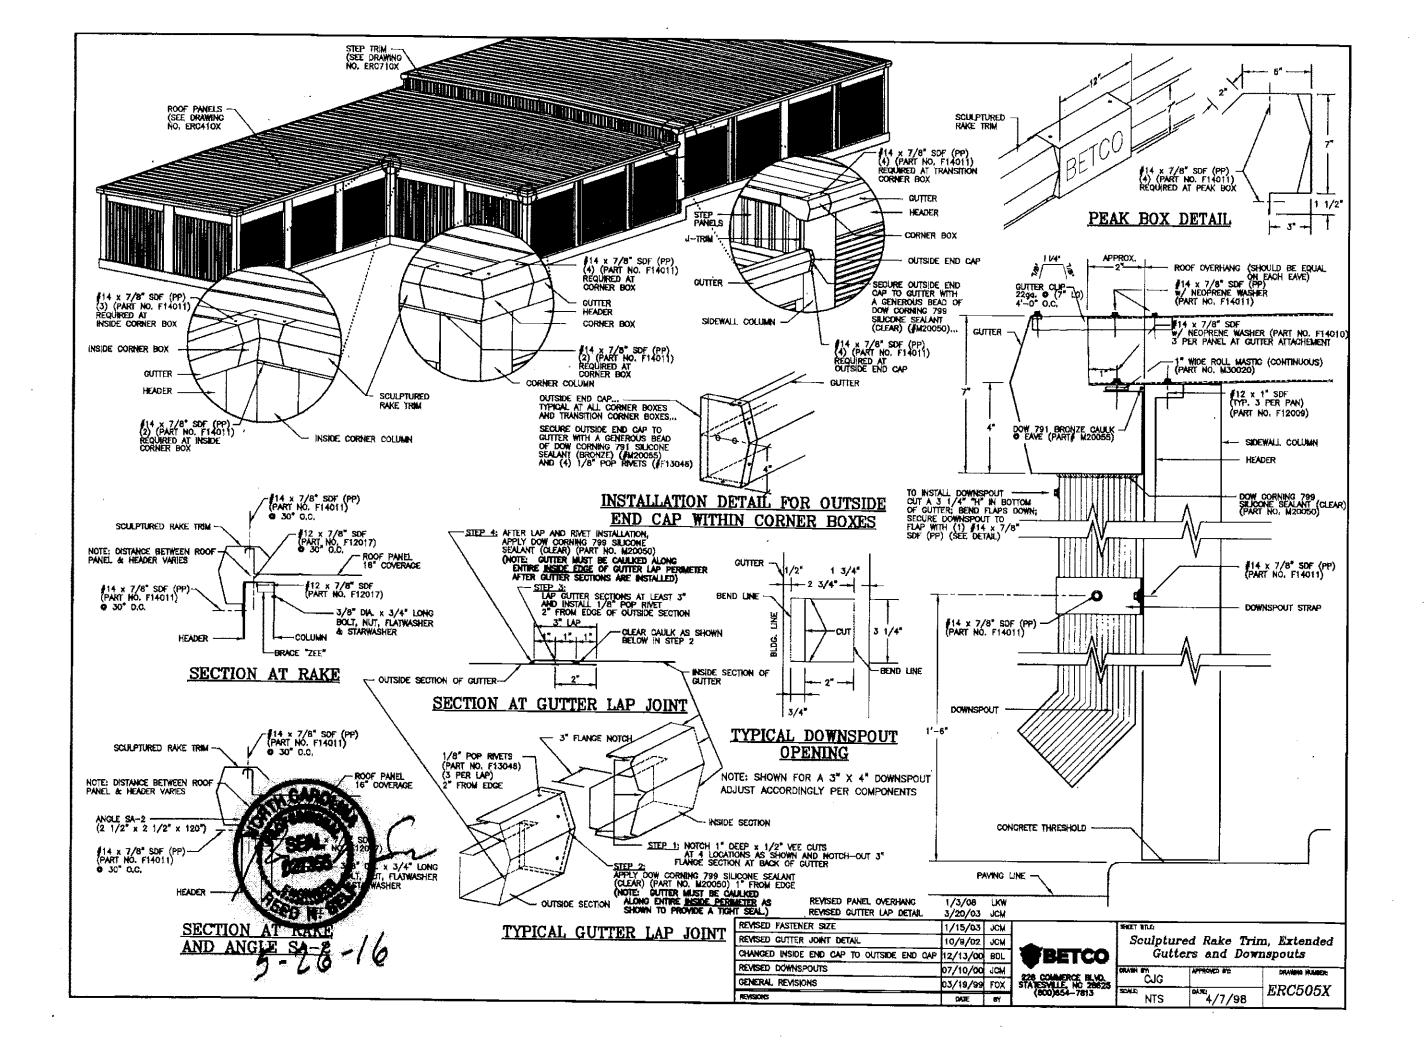


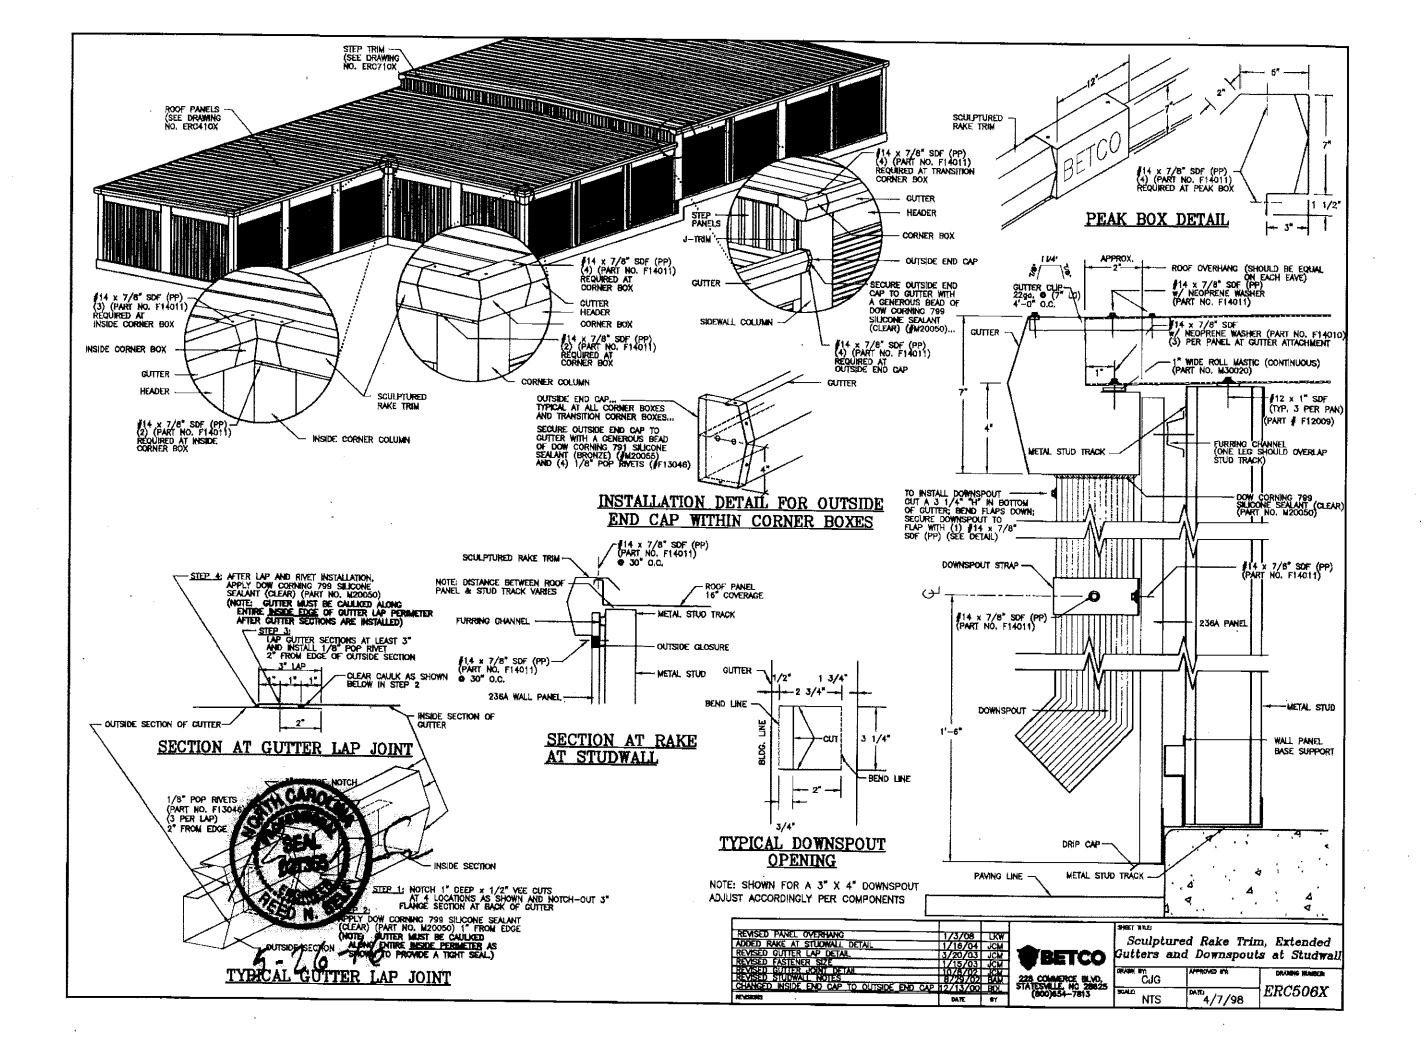


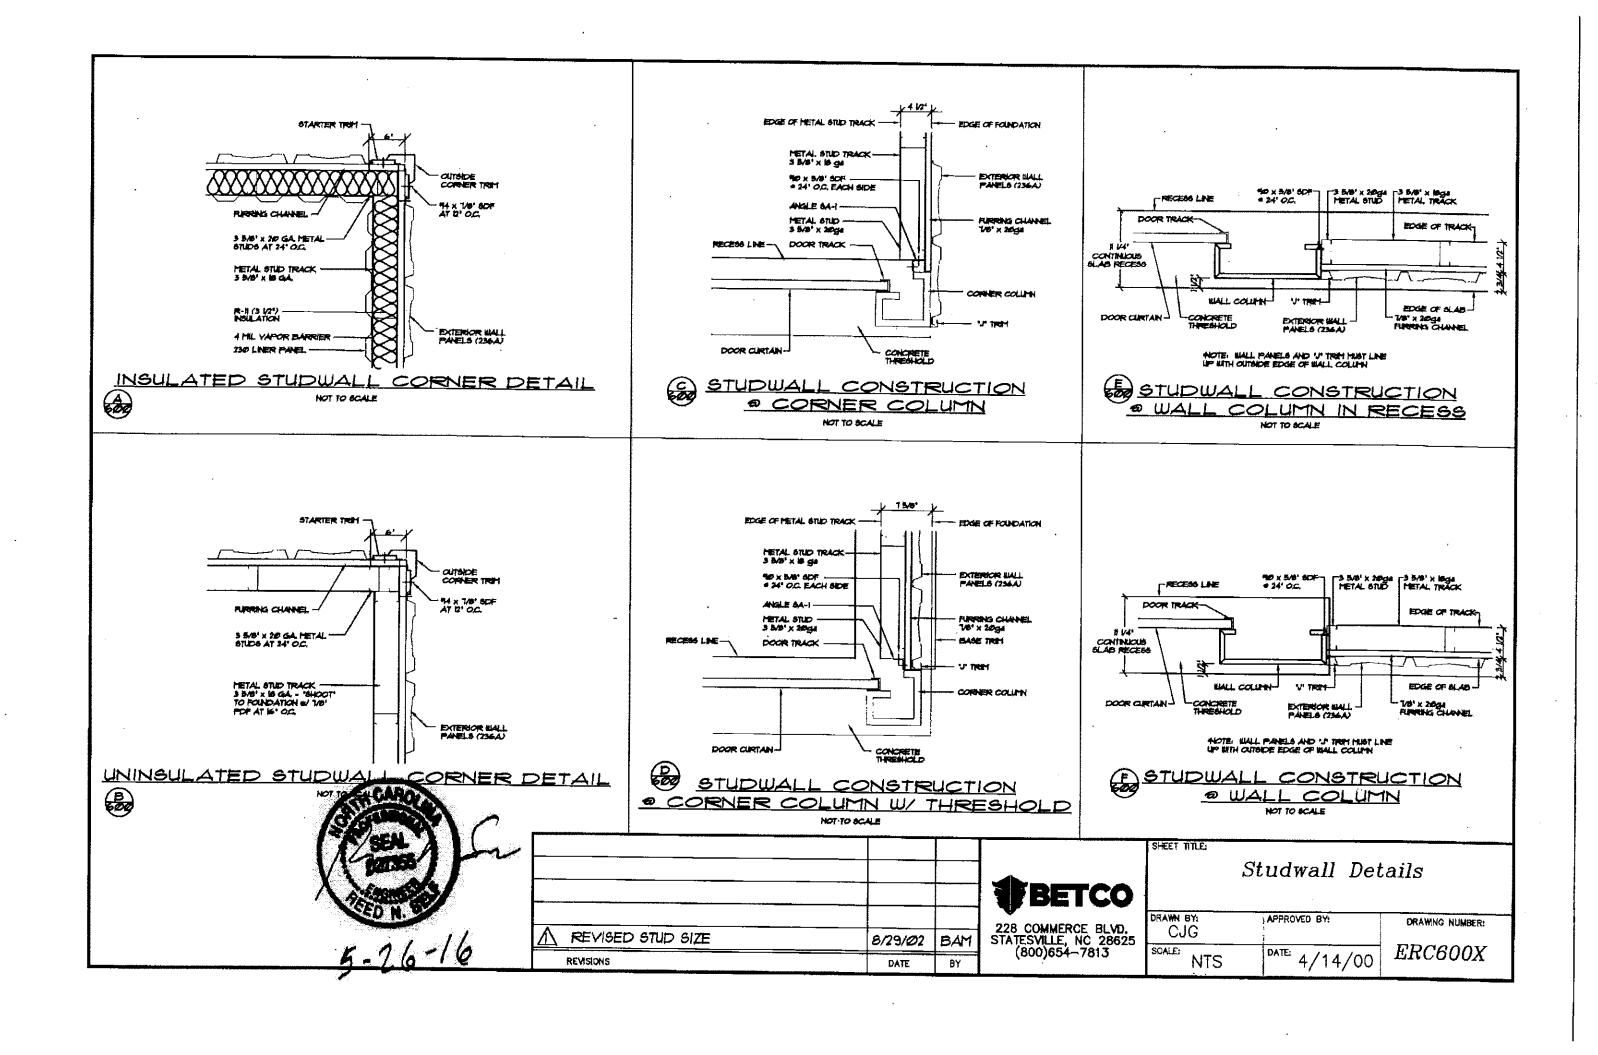

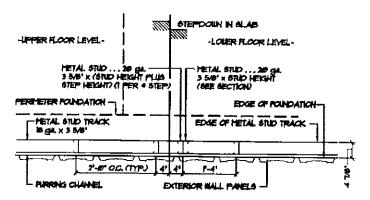





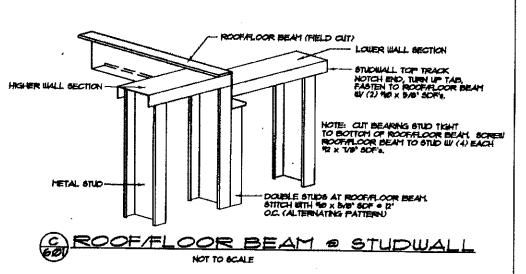


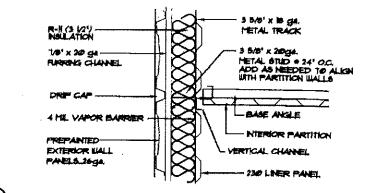

PARTITION INSTALLATION AT INSULATED EXTERIOR STUDWALL

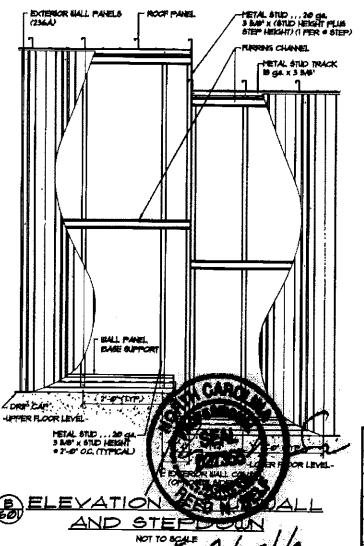

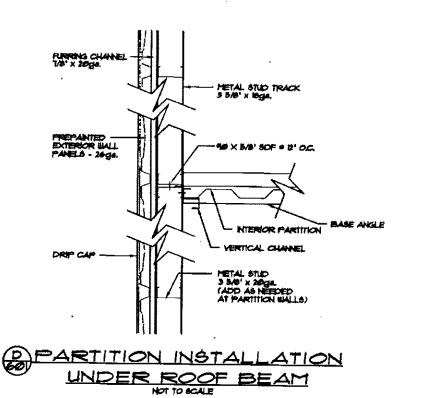

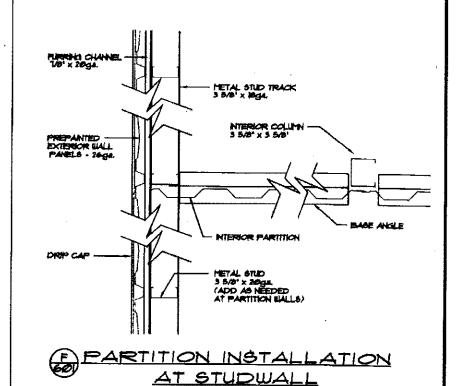

		ļ
A REVISED C/601 TO INCLUDE FLOOR BEAM	5/1/03	JCM
A REVISED C/601 TO INCLUDE FLOOR BEAN		JCM
⚠ REVISED STUD SIZE	8/29/02	BAM
REVISIONS	DATE	BY



228 COMMERCE BLVD. STATESVILLE, NC 28625 (800)654-7813

SHEET	TITLE:		
		Studwall	Details

NOT TO SCALE

DRAWN BY: CJG	APPROVED BY:	DRAWING NUMBER:
SCALE: NTS	DATE: 4/14/00	ERC601X

EXTERIOR STUDUALL CONSTRUCTION . FLAT SLAB: (SEE ERC63ØX)

-3 5/8" METAL STUDS • 24" O.C. — 20gd
-3 5/8" CONTINUOUS FLOOR AND CEILING TRACK — 18gg. — FASTEN W/
3/8" x 3" WEDGE ANCHOR (2" MIN. EMBEDDMENT) • 30" O.C. MAX
-2 OR 3 ROWS CONTINUOUS 20gg. FURRING CHANNELS (NOTE #2)
-PRE-PAINTED EXTERIOR 236A WALL PANELS
-WALL PANEL BASE SUPPORT
-DRIP CAP (#760120)
*3 1/2" THICK FIBERGLASS INSULATION
*4 MIL POLYETHYLENE VAPOR BARRIER
*230 LINER PANELS • INTERIOR (ATTACH EACH PANEL
TO BASE & TOP TRACK WITH 4 EACH #10 x 5/8" SDF's) TO BASE & TOP TRACK WITH 4 EACH #10 x 5/8" SDF's) *J-TRIM • TOP OF LINER PANELS
-SEE NOTE #4 FOR GENERAL STUDWALL CONSTRUCTION NOTES.

EXTERIOR STUDIUAL L. CONSTRUCTION . RECESS. (SEE ERC630X)

-3 5/8" METAL STUDS © 24" O.C. - 20gq
-3 5/8" CONTINUOUS FLOOR AND CEILING TRACK - 18gg. - FASTEN W/
3/8" x 3" WEDGE ANCHOR (2" MIN. EMBEDDMENT) © 30" O.C. MAX
-3 OR 4 ROWS CONTINUOUS 20gg. FURRING CHANNELS (NOTE #2)
-PRE-PAINTED EXTERIOR 236A WALL PANELS
-BASE TRIM (#160593)
*3 1/2" THICK FIBERCLASS INSULATION
*4 MIL POLYETHYLENE VAPOR BARRIER
*230 LINER PANELS © INTERIOR (ATTACH EACH PANEL
TO BASE & TOP TRACK WITH 4 FACH #30 x 5/8" SDE's) TO BASE & TOP TRACK WITH 4 EACH #10 x 5/8" SDF's) *J-TRIM • TOP OF LINER PANELS -SEE NOTE #4 FOR GENERAL STUDWALL CONSTRUCTION NOTES.

NSULATED LOAD BEARING STUDUALL:

-3 5/8" METAL STUDS • 24" O.C. - 20ga -3 5/8" CONTINUOUS FLOOR AND CEILING TRACK - 18gg. - FASTEN W/3/8" x 3" WEDGE ANCHOR (2" MIN. EMBEDDMENT) 9 30" O.C. MAX -3 1/2" THICK FIBERGLASS INSULATION -4 MIL POLYETHYLENE VAPOR BARRIER -230 LINER PANELS (EACH SIDE-ATTACH EACH PANEL TO TOP & BASE TRACK WITH 4 EACH #10 x 5/8" SDF's) -J-TRIM O TOP OF LINER PANELS -SEE NOTE #4 FOR GENERAL STUDWALL CONSTRUCTION NOTES.

INSULATED NON-LOAD BEARING STUDUALL:

-3 5/8" METAL STUDS @ 24" O.C. - 20go -3 5/8" CONTINUOUS FLOOR AND CEILING TRACK - 20gg.
(ATTACH BASE TRACK TO CONCRETE FLOOR SLAB WITH 7/8" PDF'S © 24" O.C) -3 1/2" THICK FIBERGLASS INSULATION -4 MIL POLYETHYLENE VAPOR BARRIER -230 LINER PANELS (EACH SIDE-ATTACH EACH PANEL TO TOP & BASE TRACK WITH 4 EACH #10 x 5/8" SDF's) -J-TRIM O TOP OF LINER PANELS -SEE NOTE #4 FOR GENERAL STUDWALL CONSTRUCTION NOTES.

EXTERIOR STUDIUALL CONSTRUCT

-3 5/8" METAL STUDS © 24" 0

-3 5/8" CONTINUOUS FLOOR A

3/8" x 3" WEDGE ANCHOR (2) MI

-3 OR 4 ROWS CONTINUOUS

-PRE-PAINTED FOR A 3/8" x 3" WEDGE ANCHOR (2 MI) 2

-3 OR 4 ROWS CONTINUOUS 2 go FIRE SEP

-PRE-PAINTED EXTERIOR 236A VALUE PA

-DRIP CAP (150032)

*3 1/2" THICK FIBERGLASS INSULATION

*4 MIL POLYETHYLENE VAPOR BAR JEE

*230 LINER PANELS © INTERIOR (A TO BASE & TOP TRACK WITH 4 EACH TO BASE & TOP INACA WHAT THE TOP OF LINER PANELS
-SEE NOTE #4 FOR GENERAL STUDWALL CONSTRUCTION NOTES

FIRE RESISTANT PARTITION ... I HOUR RATED UL • U465. ... (NON-LOAD BEARING)

ONE HOUR FIREWALL CONSTRUCTION:

-3 5/8" METAL STUDS © 24" O.C. - 20ga. -3 5/8" CONTINUOUS FLOOR and CEILING TRACK - 20ga (TOP TRACK MUST FOLLOW SLOPE OF ROOF DECK) (SECURE BOTTOM TRACK W/ 7/8" PDF'S AT 24" O.C.) -5/8" GYPSUM BOARD (X-RATED) EACH SIDE IT MUST

BE PLACED SUCH THAT ALL JOINTS ARE VERTICAL.

-GYPSUM BOARD SHALL BE ATTACHED TO STUDS, FLOOR
AND CEILING TRACK USING TYPE "S" SELF-TAPPING SCREWS
ALONG EDGES OF BOARD SPACED 8" O.C. AND 12" O.C. IN THE FIELD.

-VINYL OR CASE-IN, DRY OR PRE-MIXED JOINT COMPOUND APPLIED IN
TWO COATS TO JOINTS SCREW-HEADS, PERFORATED PAPER TAPE 2"
WIDE, EMBEDDED IN FIRST LAYER OF COMPOUND OVER ALL JOINTS.

43 1/2" THICK FIBERGLASS INSULATION *4 MIL POLYETHYLENE VAPOR BARRIER -SEE NOTE #4 FOR GENERAL STUDWALL CONSTRUCTION NOTES.

FIRE RESISTANT PARTITION ... I HOUR RATED LL + U425. . . (LOAD BEARING)

ONE HOUR FIREWALL CONSTRUCTION:

-3 5/8" METAL STUDS ● 24" O.C. - 20ag. -3 5/8" CONTINUOUS FLOOR & CEILING TRACK - 18ga - FASTEN W/
3/8" x 3" WEDGE ANCHOR (2" MIN. EMBEDDMENT) • 30" O.C. MAX
(TOP TRACK MUST FOLLOW SLOPE OF ROOF DECK) -5/8" GYPSUM BOARD (X-RATED) EACH SIDE IT MUST
BE PLACED SUCH THAT ALL JOINTS ARE VERTICAL.
-GYPSUM BOARD SHALL BE ATTACHED TO STUDS,
FLOOR AND CEILING TRACK USING TYPE "S"
SELF-TAPPING SCREWS ALONG EDGES OF BOARD
SPACED 8" O.C. AND 12" O.C. IN THE FIELD. -VINYL OR CASE-IN, DRY OR PRE-MIXED JOINT COMPOUND APPLIED IN TWO COATS TO JOINTS SCREW-HEADS. PERFORATED PAPER TAPE, 2" WIDE, EMBEDDED IN FIRST LAYER OF COMPOUND OVER ALL JOINTS. *3 1/2" THICK FIBERGLASS INSULATION

*4 MIL POLYETHYLENE VAPOR BARRIER

-SEE NOTE #4 FOR GENERAL STUDWALL CONSTRUCTION NOTES.

EXTERIOR FIRE RESISTANT PARTITION.... -UL * U423, (1 HOUR RATED) (LOAD BEARING)

ONE HOUR FIREWALL CONSTRUCTION:

-3 5/8" METAL STUDS © 24" O.C. - 20ga. -3 5/8" CONTINUOUS FLOOR AND CEILING TRACK - 18ga. - FASTEN W/ 3/8" x 3" WEDGE ANCHOR (2" MIN. EMBEDDMENT) © 30" O.C. MAX 3/8" x 3" WEDGE ANCHOR (2" MIN, EMBEDDMENT) 9 30" O.C. MAY
(TOP TRACK MUST FOLLOW SLOPE OF ROOF DECK)

-2 OR 3 ROWS CONTINUOUS 20gg, FURRING CHANNELS (NOTE #2)

-PRE-PAINTED EXTERIOR 236A WALL PANELS

-WALL PANEL BASE SUPPORT

-DRIP CAP (#T60120)

-1 LAYER 5/8" GYPSUM BOARD (X-RATED) EACH SIDE IT MUST

BE PLACED SUCH THAT ALL JOINTS ARE VERTICAL.

-GYPSUM BOARD SHALL BE ATTACHED TO STUDS,

FLOOR AND CEILING TRACK USING TYPE "S"

SELF-TAPPING SCREWS ALONG EDGES OF BOARD

SPACED 8" O.C. AND 12" O.C. IN THE FIELD.

-VINYL OR CASE-IN, DRY OR PRE-MIXED JOINT

COMPOUND APPLIED IN TWO COATS TO JOINTS

SCREW-HEADS, PERFORATED PAPER TAPE, 2" WIDE,

EMBEDDED IN FIRST LAYER OF COMPOUND OVER ALL

JOINTS.

JOINTS.
*3 1/2" THICK FIBERGLASS INSULATION
*4 MIL POLYETHYLENE VAPOR BARRIER -SEE NOTE #4 FOR GENERAL STUDWALL CONSTRUCTION NOTES.

EXTERIOR FIRE RESISTANT PARTITIONS • RECESS. UL • U423. (I HOUR RATED) (LOAD BEARING)

ONE HOUR FIREWALL CONSTRUCTION:

-3 5/8" METAL STUDS @ 24" O.C. - 20ga. -3 5/8" CONTINUOUS FLOOR AND CEILING TRACK - 18gg. - FASTEN W/ 3/8" x 3" WEDGE ANCHOR (2" MIN. EMBEDDMENT) • 30" O.C. MAX (TOP TRACK MUST FOLLOW SLOPE OF ROOF DECK)

-3 OR 4 ROWS CONTINUOUS 20gg, FURRING CHANNELS (NOTE #2)
--PRE--PAINTED EXTERIOR 236A WALL PANELS

-PRE-PAINTED EXTERIOR 236A WALL PANELS
-DRIP CAP (#T60593)
-1 LAYER 5/8" CYPSUM BOARD (X-RATED) EACH SIDE IT MUST
BE PLACED SUCH THAT ALL JOINTS ARE VERTICAL.
-GYPSUM BOARD SHALL BE ATTACHED TO STUDS, FLOOR
AND CEILING TRACK USING TYPE "S" SELF-TAPPING SCREWS
ALONG EDGES OF BOARD SPACED 8" O.C. AND 12" O.C. IN THE FIELD,
-VINYL OR CASE-IN, DRY OR PRE-MIXED JOINT COMPOUND APPLIED IN
TWO COATS TO JOINTS SCREW-HEADS. PERFORATED PAPER TAPE, 2"
WIDE, EMBEDDED IN FIRST LAYER OF COMPOUND OVER ALL JOINTS.
**3 1/2" THICK FIRERCLASS INSULATION

*3 1/2" THICK FIBERGLASS INSULATION *4 MIL POLYETHYLENE VAPOR BARRIER

-SEE NOTE #4 FOR GENERAL STUDWALL CONSTRUCTION NOTES.

EXTERIOR FIRE RESISTANT PARTITION . HYAC: NSET/ALCOVE ONE HOUR FIREWALL CONSTRUCTION:

-3 5/8" METAL STUDS © 24" O.C. -- 20gd.
-3 5/8" CONTINUOUS FLOOR AND CEILING TRACK -- 18gg. -- FASTEN W/
3/8" x 3" WEDGE ANCHOR (2" MIN. EMBEDDMENT) © 30" O.C. MAX
(TOP TRACK MUST FOLLOW SLOPE OF ROOF DECK)

-3 OR 4 ROWS CONTINUOUS 20gg. FURRING CHANNELS (NOTE #2)

-PRE-PAINTED EXTERIOR 236A WALL PANELS
-DRIP CAP (#T50032)
-1 LAYER 5/8" GYPSUM BOARD (X-RATED) EACH SIDE IT MUST

-1 LAYER 5/8" GYPSUM BOARD (X-RATED) EACH SIDE IT MUST
BE PLACED SUCH THAT ALL JOINTS ARE VERTICAL.
-GYPSUM BOARD SHALL BE ATTACHED TO STUDS, FLOOR
AND CEILING TRACK USING TYPE "S" SELF-TAPPING SCREWS
ALONG EDGES OF BOARD SPACED 8" O.C. AND 12" O.C. IN THE FIELD,
-VINYL OR CASE-IN, DRY OR PRE-MIXED JOINT COMPOUND APPLIED IN
TWO COATS TO JOINTS SCREW-HEADS. PERFORATED PAPER TAPE, 2"
WIDE, EMBEDDED IN FIRST LAYER OF COMPOUND OVER ALL JOINTS.
*3 1/2" THICK FIBERGLASS INSULATION
*4 MIL POLYETHYLENE VAPOR BARRIER
-SEE NOTE *4 FOR CENTERAL SCHIDMAN L. CONSTRUCTION ADDITION

-SEE NOTE #4 FOR GENERAL STUDWALL CONSTRUCTION NOTES.

NOTE #1: INTENTIONALLY BLANK.

NOTE #2: AS PER WALL CONSTRUCTION NOTES, EXTERIOR STUDWALLS ARE CONSTRUCTED WITH "X" OR "Y" ROWS OF FURRING CHANNELS IF WALL IS LESS THAN 9'-10 1/2" HGT. A.F.F., CONSTRUCT WITH "X" ROWS; OTHERWISE USE "Y".

NOTE #3: "*" ON THIS SHEET, REFERS TO THE ADDITIONAL MATERIALS REQUIRED FOR INSULATION OF WALL SYSTEM. NOT ALL WALLS ARE INSULATED, VERIFY WITH FLOOR PLANS, INSTALL INSULATION & RELATED MATERIALS ONLY IN WALLS DESIGNATED WITH AN "*" BESIDE THE DETAIL NUMBER ON THE FLOOR PLAN.

NOTE #4: GENERAL STUDWALL CONSTRUCTION:
A) - ATTACH STUDS WITH #10 X 5/8" SDF'S EACH SIDE

OF TRACK (4 PER STUD).

B) — WALLS MUST EXTEND FROM FLOOR TO ROOF DECK AND INTO WALL COLUMN CAVITY.

C) — TOP TRACK MUST FOLLOW SLOPE OF ROOF LINE.

•			
	REVISED STUD TRACK FASTENERS TO CONCRETE	9/24/10	JCM
	REVISED STUD TRACK FASTENERS	1/12/04	JCM
	REVISED STUD SIZE REVISE LAYERS, GYPSUM BOARD THICKNESS & UL ON NOTES \$8, 9, 10	8/29/02 11/16/01	BAM JRB
	ADDED ERC 620X & 621X TO NOTE #10	08/28/01	JCM
	CHANGED 5/8" TO (2 LAYERS 1/2")	02/21/01	DSF
	· REVISIONS	DATE	BY





228 COMMERCE BLVD. STATESVILLE, NC 28625 (800)654-7813


SHEET TITLE:


Studwall Notes

drawn by: RS	APPROVED BY:	DRAWING NUMBER:
SCALE: NTS	DATE: 11/02/00	ERC610X

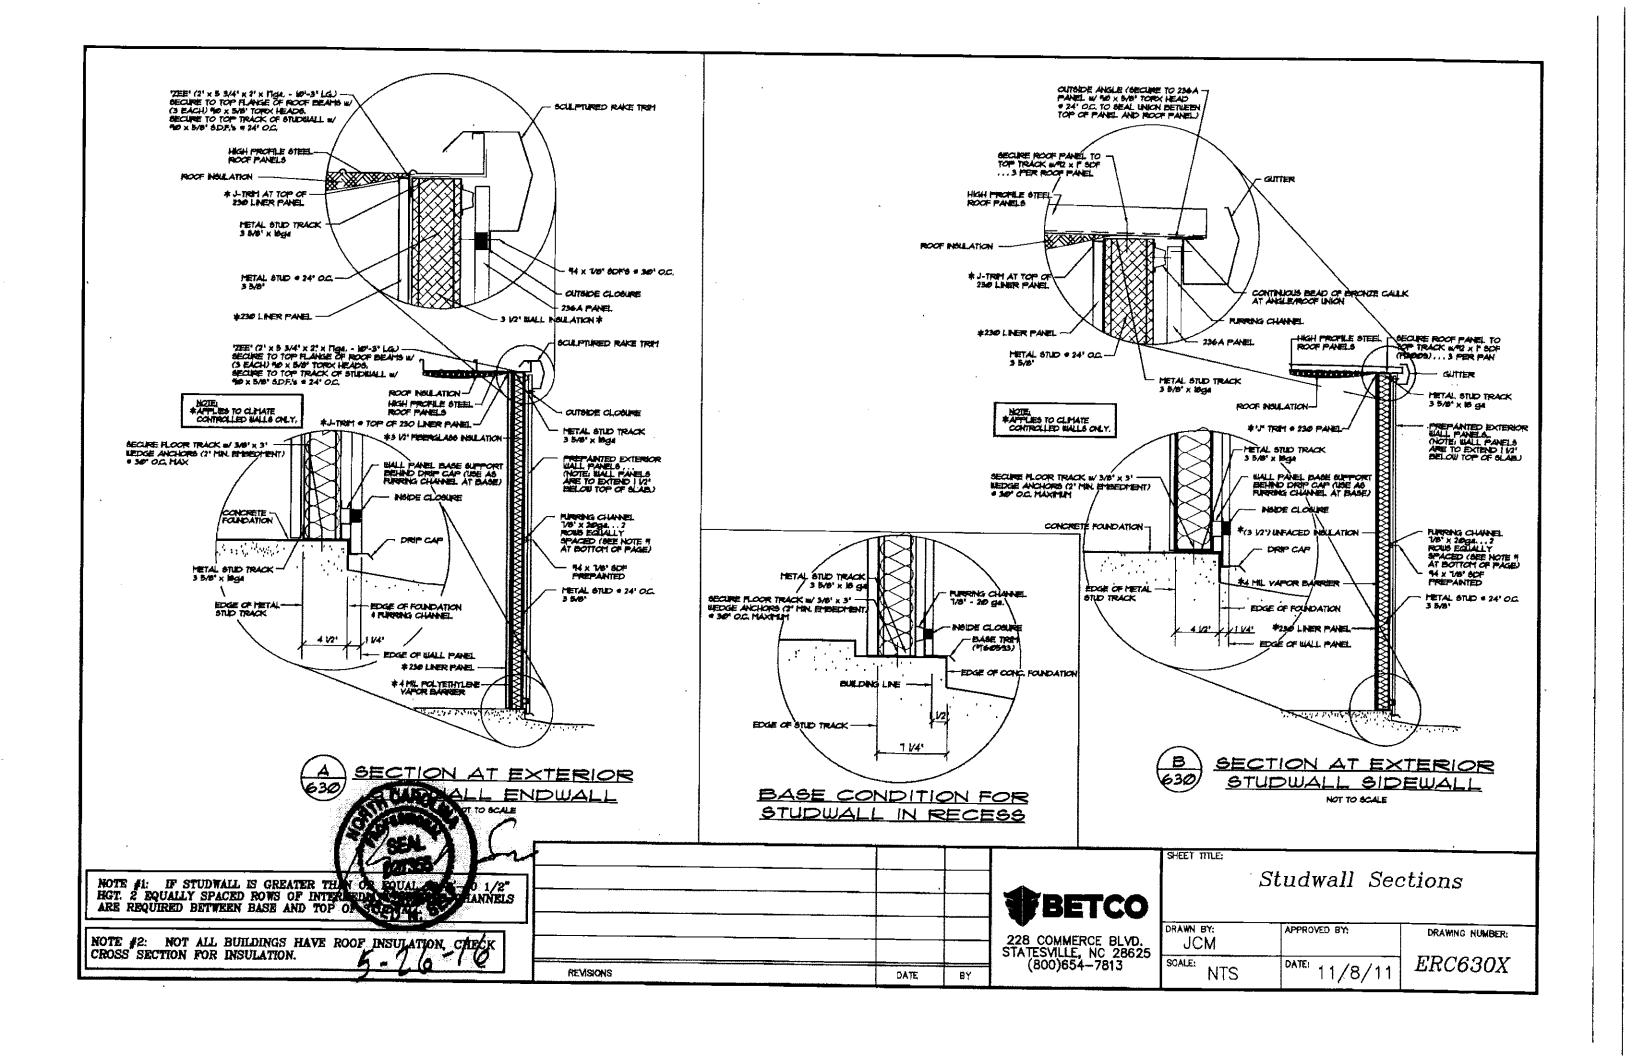

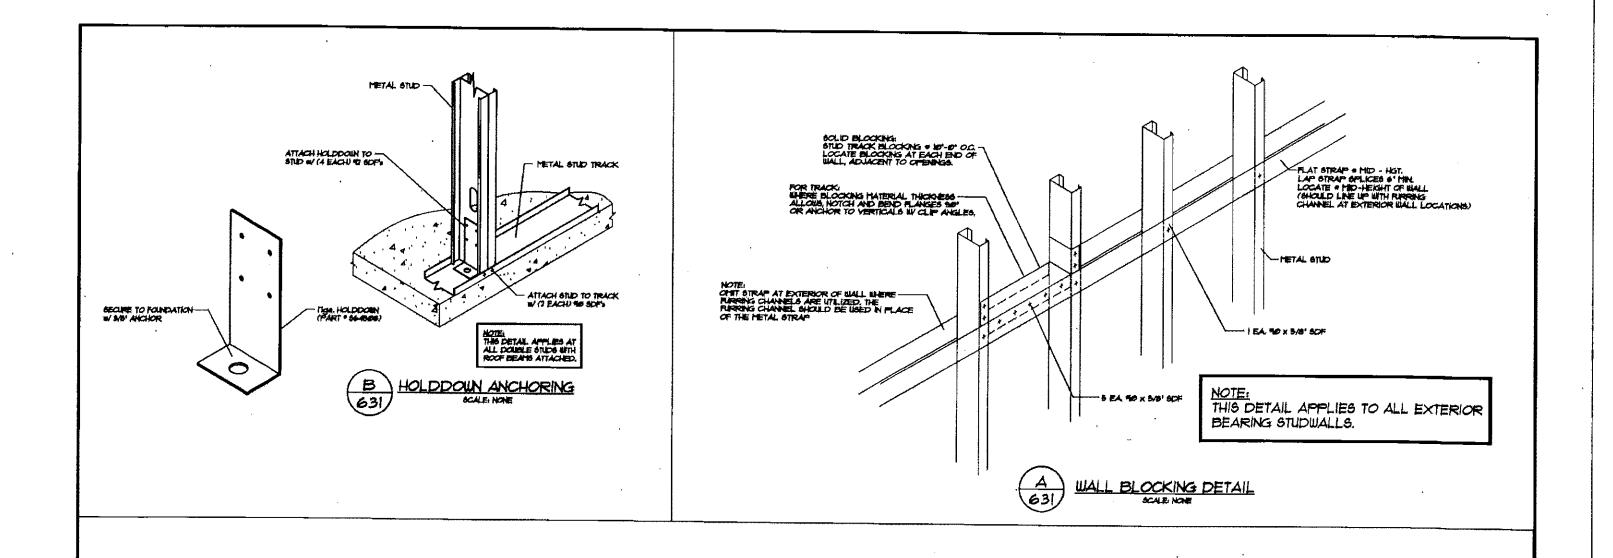

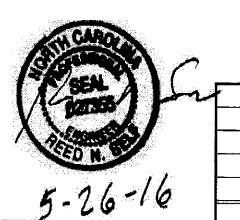

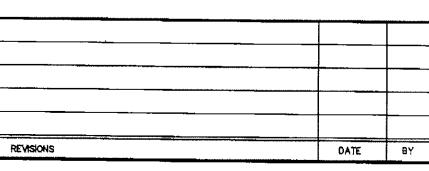



BETCO

228 COMMERCE BLVD. STATESVILLE, NC 28625 (800)654-7813 SHEET TITLE:

Studwall Details

ORAWN BY: JCM	APPROVED BY:	DRAWING NUMBER:
SCALE: NTS	DATE: 11/8/11	ERC631X

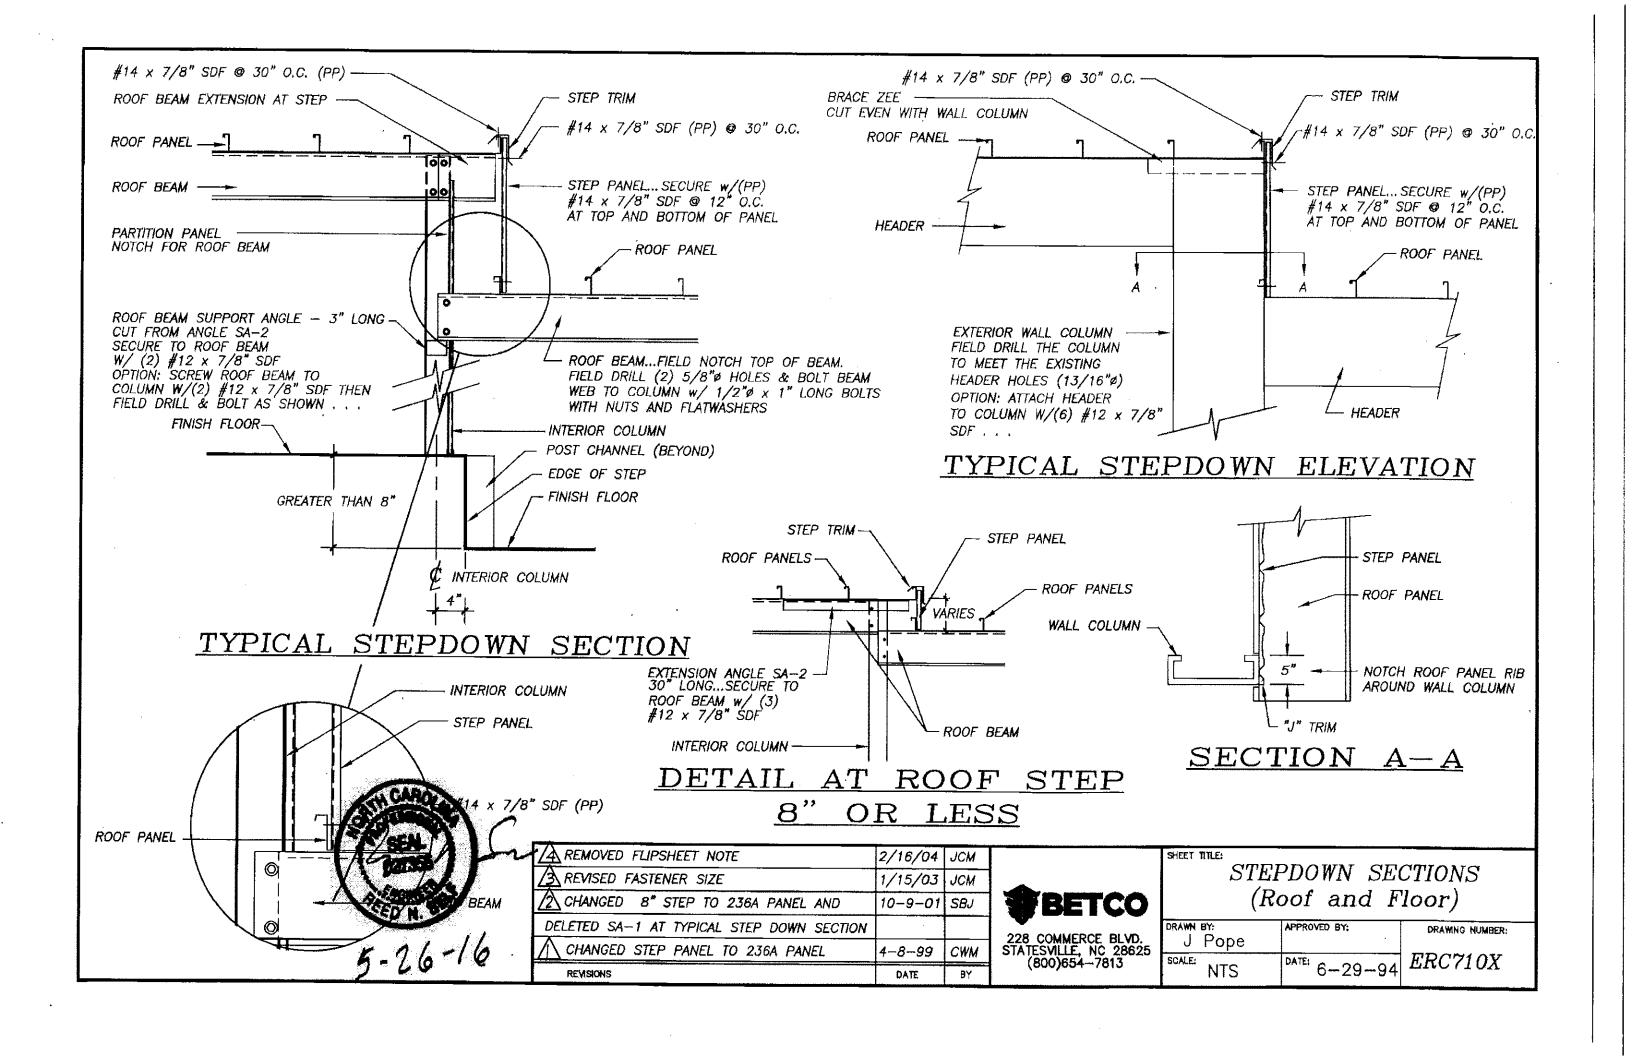

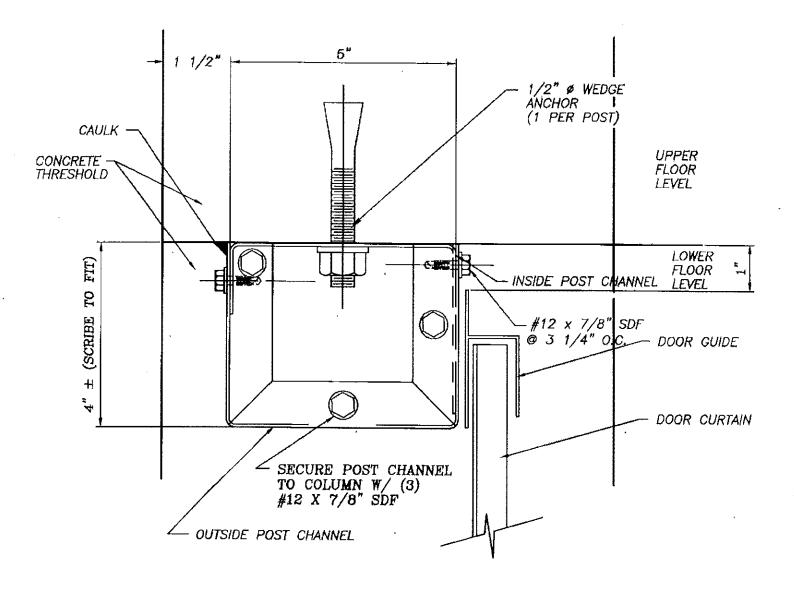

SCRIBE OUTSIDE POST CHANNEL (9" LEG) TO FIT AGAINST CONCRETE.
THEN APPLY CAULK OVER SEAM TO SEAL CUT EDGES. TRIM BOTTOM
AS NEEDED. CAULK AROUND BOTTOM TO SEAL CUT EDGE. FASTEN

W/(4) PREPAINTED #14 X 7/8" SDF SCREWS @ 3 1/4" O.C. ON OUTSIDE FACE OF OUTSIDE POST CHANNEL. FASTEN OUTSIDE POST CHANNEL TO WALL COLUMN W/ (3) #12 X 7/8" S.D.F.

WALL COLUMN

BASE BRACKET

THRESHOLD

FLOOR LEVEL — UPPER

INSIDE POST CHANNEL

#12 x 7/8" SDF @ 3 1/4" O.C.
OUTSIDE POST CHANNEL

FLOOR LEVEL — LOWER

POST CHANNEL DETAIL

AT FLOOR STEP

PLAN VIEW @ POST CHANNEL

NOTE: POST CHANNEL CAN BE ATTACHED TO EXTERIOR WALL OF USE OF FITTING POST CHANNEL TO BEFORE WALL COLUMN IS LESSEN THE DISCOURT OF THE ALLING \$12 SCREWS.

REVISED FASTENER SIZE

1/15/03 JCM

GENERAL REVISIONS

3-8-99 FOX

REVISIONS

DATE BY

BETCO

228 COMMERCE BLVD. STATESVILLE, NC 28625 (800)654-7813

Post Channel Details

DRAWN BY: J Pope	APPROVED BY:	DRAWING NUMBER:
SOALE: NTS	DATE: 6-28-94	ERC712X

