PROJECT NARRATIVE:

THIS PROJECT IS A 11,400 SF, FIRE DEPARTMENT BUILDING AND ASSOCIATED ACCESS, PARKING, AND UTILITIES. THE PROJECT IS LOCATED ON HYW-401, HARNETT COUNTY, NORTH CAROLINA. THE CURRENT PARCEL IS 4.67 ACRES.

THE MAJORITY OF THE PROPERTY IS AGRICULTURAL FIELD. THERE IS NO 100 YEAR FLOODPLAIN. NO JURISDICTIONAL STREAM OR BUFFER IS SHOWN ON CURRENT HARNETT COUNTY GIS WITHIN THE PROPERTY. THERE IS NO SIGN OF ANY WETLAND WITHIN THE PROPOSED LIMIT OF DISTURBANCE. THE PROPERTY LIES IN CAPE FEAR RIVER BASIN.

PROPOSED AREAS WILL BE DELINEATED WITH SILT FENCES. TOTAL PROPOSED % IMPERVIOUS WILL BE 20.4% WHICH IS UNDER 24% (MAX. ALLOWED ON WATER SUPPLY WATERSHED DISTRICT WS-IV-PA). THE PROJECT WILL BE CONSTRUCTED AS PER LOW DENSITY STANDARDS. RUNOFF FROM THE AREA WILL BE DIRECTED TO ITS NATURAL PATH AS ALLOWED BY SITE CONDITION.

ONSITE SANITATION FACILITY IS PROPOSED AS PART OF THE PROJECT.

THERE ARE NO SPECIAL OR EXPERIMENTAL EROSION CONTROL DEVICES AND THE CONSTRUCTION SEQUENCE IS HARNETT COUNTY STANDARD.

NOTES

- 1. BASE INFORMATION BY MAULDIN WATKINS SURVEYING, P.A. OF P.O. BOX 444 / 139 N. MAIN ST.. (919) 552-9326. OFF-SITE INFORMATION FROM HARNETT
- 2. PLAN IS SUBJECT TO REVISIONS DURING CONSTRUCTION DRAWING APPROVAL
- 3. CONSTRUCTION DRAWING APPROVAL IS REQUIRED BEFORE CONSTRUCTION ON THIS PROJECT MAY BEGIN. DEVELOPMENT FEES ARE DUE BEFORE CONSTRUCTION
- . CERTIFICATION OF WONERSHIP, DEDICATION, AND JURISDICTION IS REQUIRED AS PART OF THE SITE PLAN SUBMITTAL
- 6. THE PROJECT REQUIRES SITE PLAN CERTIFICATION FROM PROFESSIONAL NORTH CAROLINA LAND SURVEYOR OR ENGINEER.
- 7. THERE IS NO GREASE TRAP USED FOR THIS PROJECT
- 8. ALL CONSTRUCTION SHALL CONFORM TO HARNETT COUNTY STANDARD SPECS.

CERTIFICATION OF OWNERSHIP, DEDICATION, & JURISDICTION

I (WE) HEREBY CERTIFY THAT I AM (WE ARE) THE OWNER(S) OR AGENT OF THE PROPERTY SHOWN AND DESCRIBED HEREON AND THAT I (WE) HEREBY ADOPT THIS PLAN OF SUBDIVISION WITH MY (OUR) FREE CONSENT, ESTABLISH MINIMUM BUILDING SETBACK LINES, AND DEDICATE ALL STREETS, ÀLLEÝS, WALKS, PARKS, AND OTHER SITES AND EASEMENTS TO PUBLIC OR PRIVATE USE AS NOTED, AND ALL OF THE LAND SHOWN HEREON IS WITHIN THE SUBDIVISION REGULATION JURISDICTION OF HARNETT COUNTY EXCEPT:

8 FEBRUARY 2022

VICINITY MAP

NW HARNETT VOLUNTEER FIRE DEPARTMENT (OWNER)

ENGINEER CERTIFICATION

I HEREBY CERTIFY THAT THIS PLAN, SPECIFICATION, AND DRAWING WERE PREPARED BY ME OR UNDER MY DIRECT SUPERVISION AND THAT I AM A DULY LICENSED PROFESSIONAL ENGINEER UNDER THE LAWS OF THE STATE OF NORTH CAROLINA.

NC STATE PE LICENCE NUMBER:24438

SIGNATURE:

NAME: BLAIR PITTMAN

DATE: 02/08/2022



1"=500

PROJECT LOCATION:

THIS PROJECT IS LOCATED IN THE HECTOR CREEK TOWNSHIP, HARNETT COUNTY, NORTH CAROLINA ON HWY-401 APPROX. ONE THIRD MILES FROM RAILROAD CROSSING NEAR LAFAYETTE ELEMENTARY

SITE DATA	
OWNER/DEVELOPER ADDRESS CITY	NORTHWEST HARNETT VOLUNTEER FIRE DEPT 6015 CHRISTIAN LIGHT RD FUQUAY—VARINA, NC 27526
DESIGNER	BOBBITT DESIGN-BUILD, INC.
STREET	ATTN: BLAIR PITTMAN, PE (24438) (ENGINEE 600 GERMANTOWN ROAD
CITY	RALEIGH, NC 27607
PHONE EMAIL ADDRESS	919.851.1980 BPITTMAN@BOBBITT.COM
ARCHITECT	BRIAN GRIFFITH
STREET CITY	600 GERMANTOWN ROAD RALEIGH, NC 27607
PHONE	919.851.1980
LANDSCAPE ARCHITECT	TALMAGE "MARK" HALL
STREET CITY, STATE	100 DOVE CT CLAYTON, NC 27520
PHONE	919.810.8408
SITE ADDRESS	US-401, FUQUAY-VARINA
TOWNSHIP	HECTORS CREEK
COUNTY	HARNETT
STATE	NORTH CAROLINA
TAX MAP OR PIN NUMBER	0643-68-0029
DEED BOOK & PAGE	4046 & 0223
ZONED	RA-30
JURISDICTION	HARNETT COUNTY
WATERSHED DISTRICT	WS-IV-P
WATERSHED	CAPE FEAR RIVER
LAND USE CLASSIFICATION	EMPLOYMENT MIXED USE
TOTAL ACREAGE	±4.67AC
WATERSHED	CAPE FEAR RIVER
DRAINAGE AREA TO SCM	NA
BUILDING SIZE:	±11,400 SF
BUILDING SETBACKS:	
FRONT	35'
SIDE	10'
REAR	25'
LANDSCAPE BUFFERS:	10' TYPE A
STREET	10 TYPE A 15' TYPE C
SIDE REAR	15 TYPE C 15' TYPE C
IMPERVIOUS BUILDING AREA:	AREA 11,400 SF
VEHICLE PVMT AREA:	27,600 SF
NON-VEHICLE PVMT. AREA:	2,400 SF
	
TOTAL IMPERVIOUS	41,400 SF / 20.4%
DISTURBED/DENUDED AREA	1.95 ACRES
PARKING REQUIREMENTS	
EMERGENCY SERVICES- ±6,800 SF (1 SPACE PER 350 SF)	20 TBD
BAYS AREA - ±4,600 SF	0
(BAYS AREA EXCLUDED)	
TOTAL REQUIRED:	20 TBD
PROPOSED PARKING:	20 (100% OF REQUIRED)

INDEX OF SHEETS SHEET NUMBER **DESCRIPTION** COVER SHEET CO.1 **EXISTING CONDITIONS** C1.0 STAKING PLAN C2.0 SEDIMENT AND EROSION CONTROL PLAN (PHASE I) SEDIMENT AND EROSION CONTROL PLAN (PHASE II) C2.1 C2.2 C3.0 NPDES STABILIZATION PLAN GRADING PLAN C4.0 UTILITY PLAN C5.0 C6.0 LANDSCAPE PLAN LIGHTING PLAN C7.0 DETAILS **DETAILS** C7.1 C7.2 DETAILS

FLOODPLAIN INFORMATION THIS SITE IS IN ZONE X, AREA OF MINIMAL FLOOD HAZARD (NOT IN ANY SPECIAL FLOOD HAZARD AREAS OR FUTURE CONDITIONS FLOOD HAZARD AREAS), AS SHOWN ON FIRM PANEL 3720064200J DATED <u>OCTOBER 3, 2006</u>.

WETLAND INFORMATION NEITHER THE FIELD CONDITION NOR HARNETT COUNTY GIS SUGGEST THE EXISTENCE OF

WETLAND WITHIN THE PROPOSED DEVELOPMENT.

think, design, build

COORDINATOR: Blair Pittman

DRAWN BY: Narayan Nyaupane

CHK BY:BPP

24 X 36

8 FEBRUARY 2022

21-0337

COVER

CALL BEFORE YOU DIG! NORTH CAROLINA LAW REQUIRES NOTIFICATION OF THE UNDERGROUND FACILITY OWNER NOT LESS THAN TWO (2) BUT NO MORE THAN TEN (10) WORKING DAYS PRIOR TO EXCAVATION OR MÕRTH CAROLINA www.nc811.org 1-800-632-4949


North Carolina One-Call Center, Inc

REVISIONS DESCRIPTION REV. BY

NW HARNETT FIRE STATION 3

SITE DEVELOPMENT PLANS

APPROVED FOR PERMITTING **NOT FOR CONSTRUCTION**

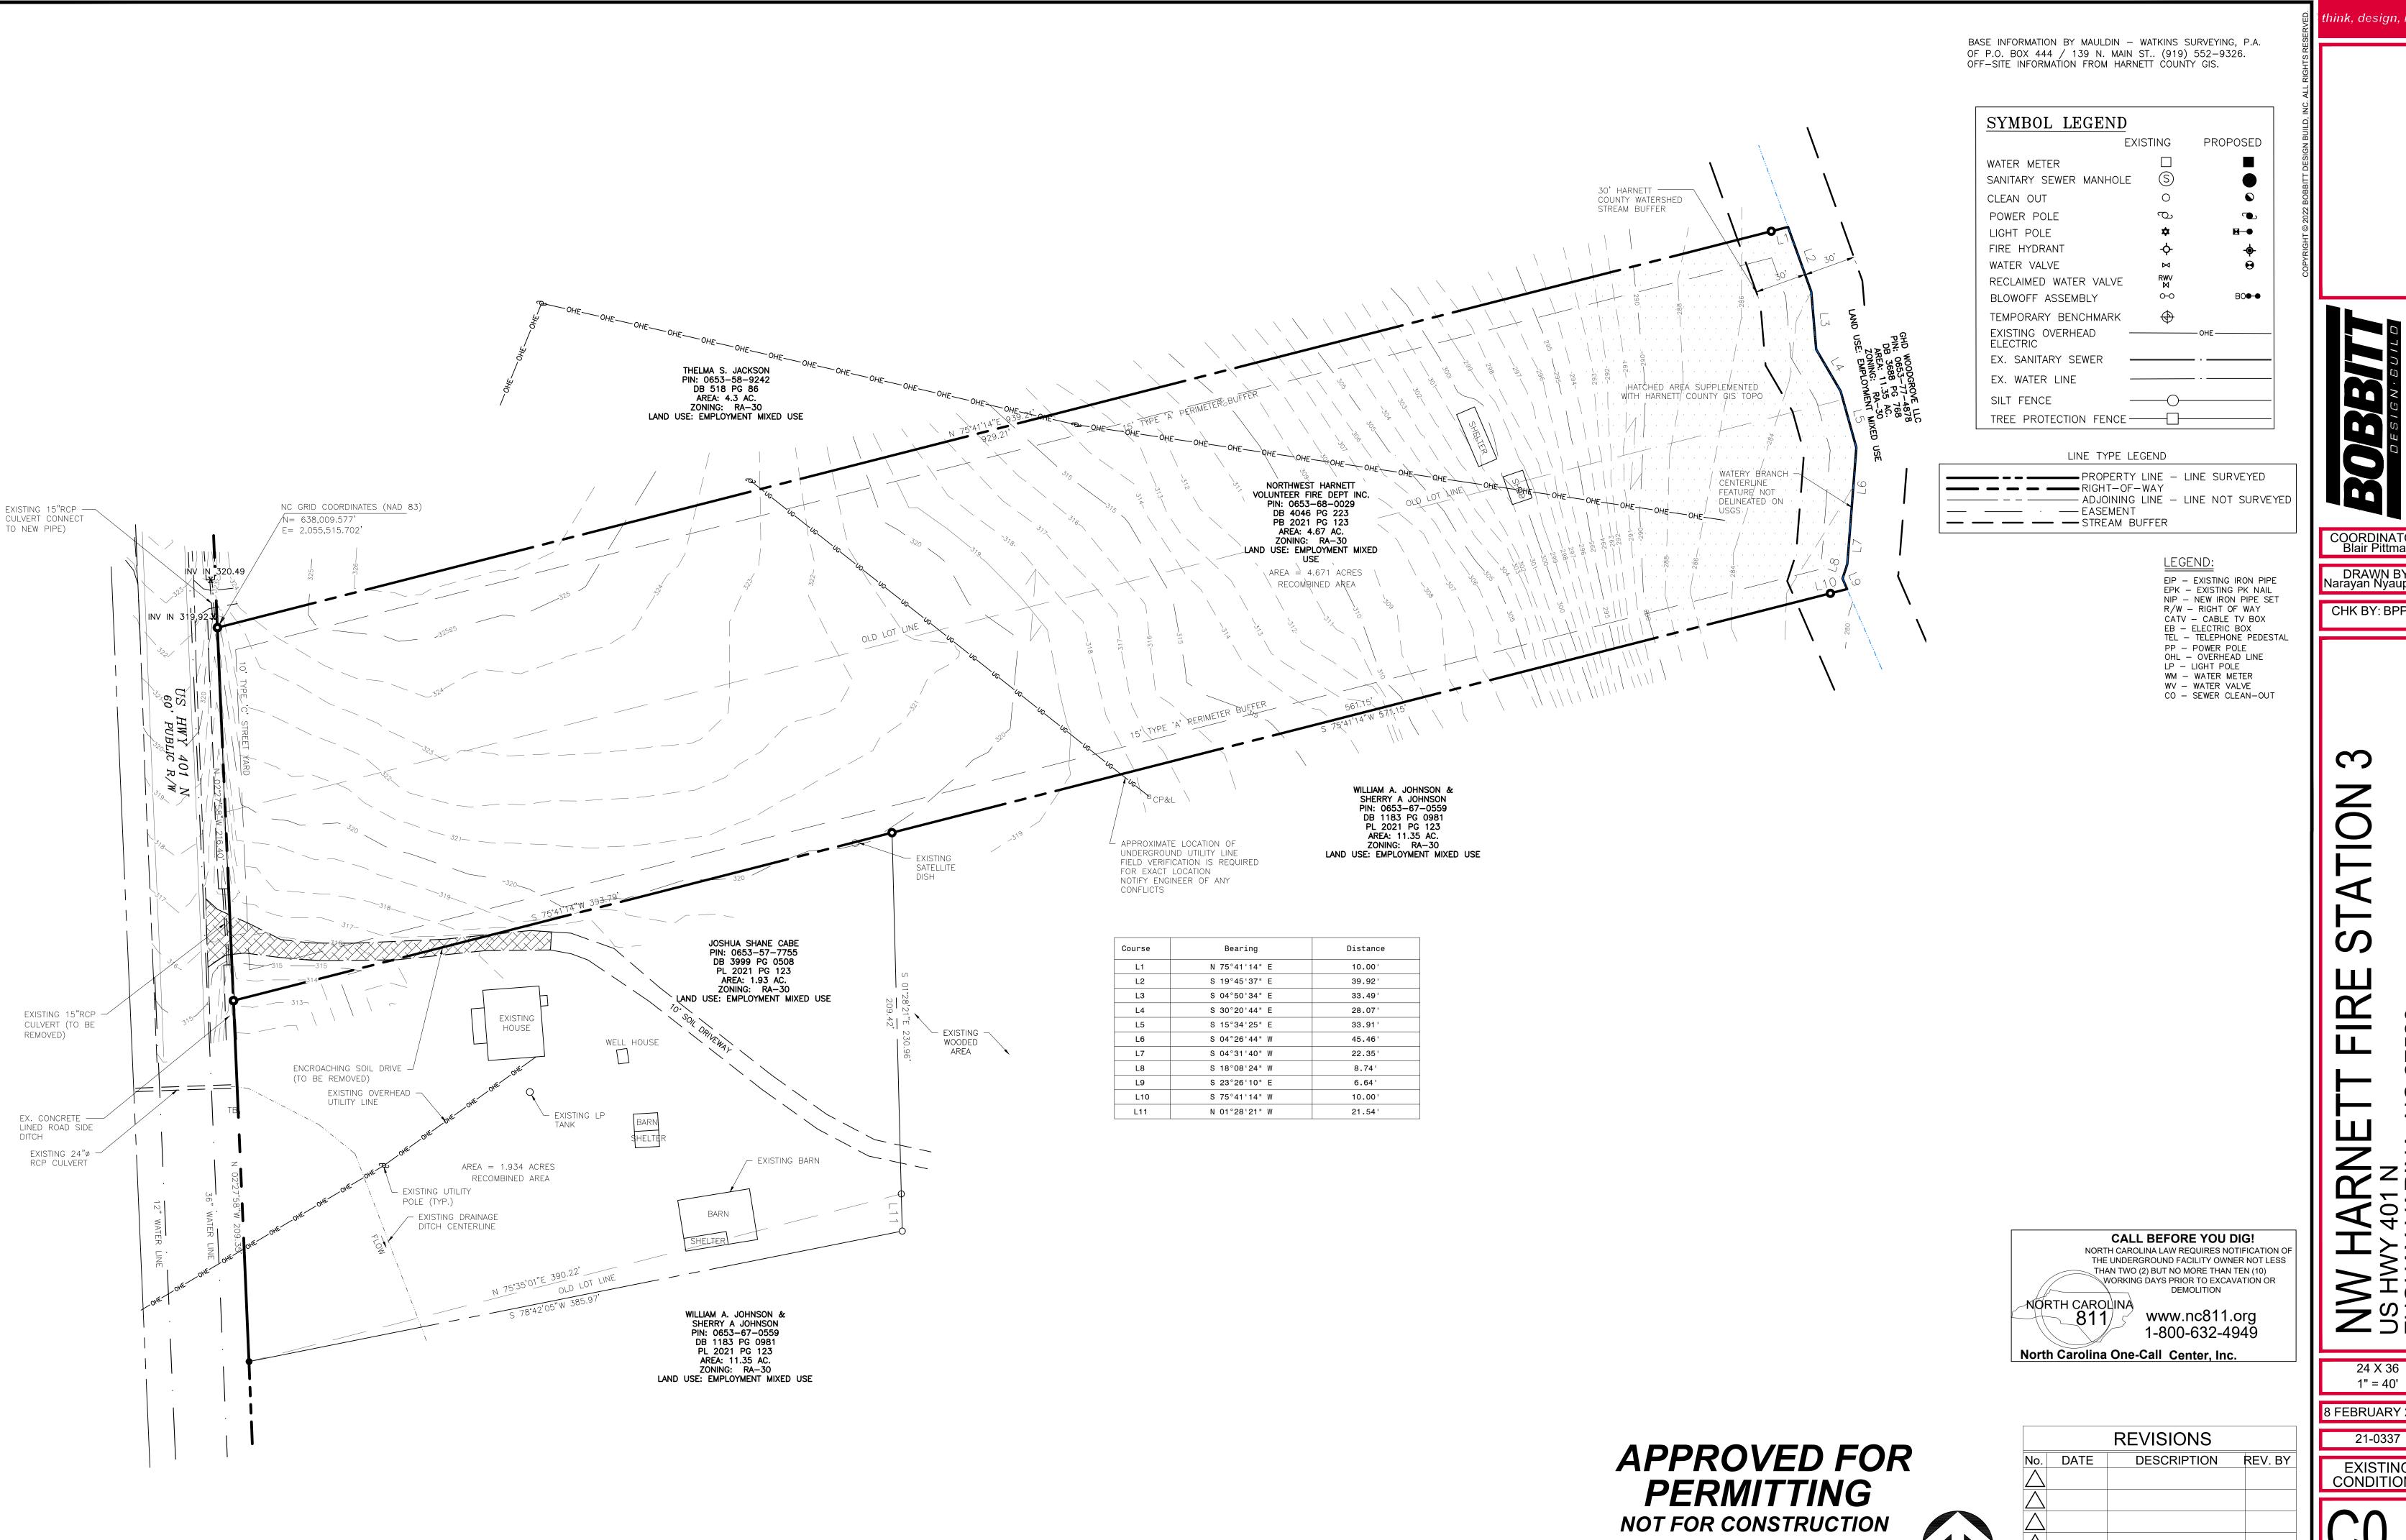

COORDINATOR: Blair Pittman

DRAWN BY: Narayan Nyaupane


CHK BY: BPP

24 X 36

1" = 40'

8 FEBRUARY 2022

EXISTING CONDITIONS

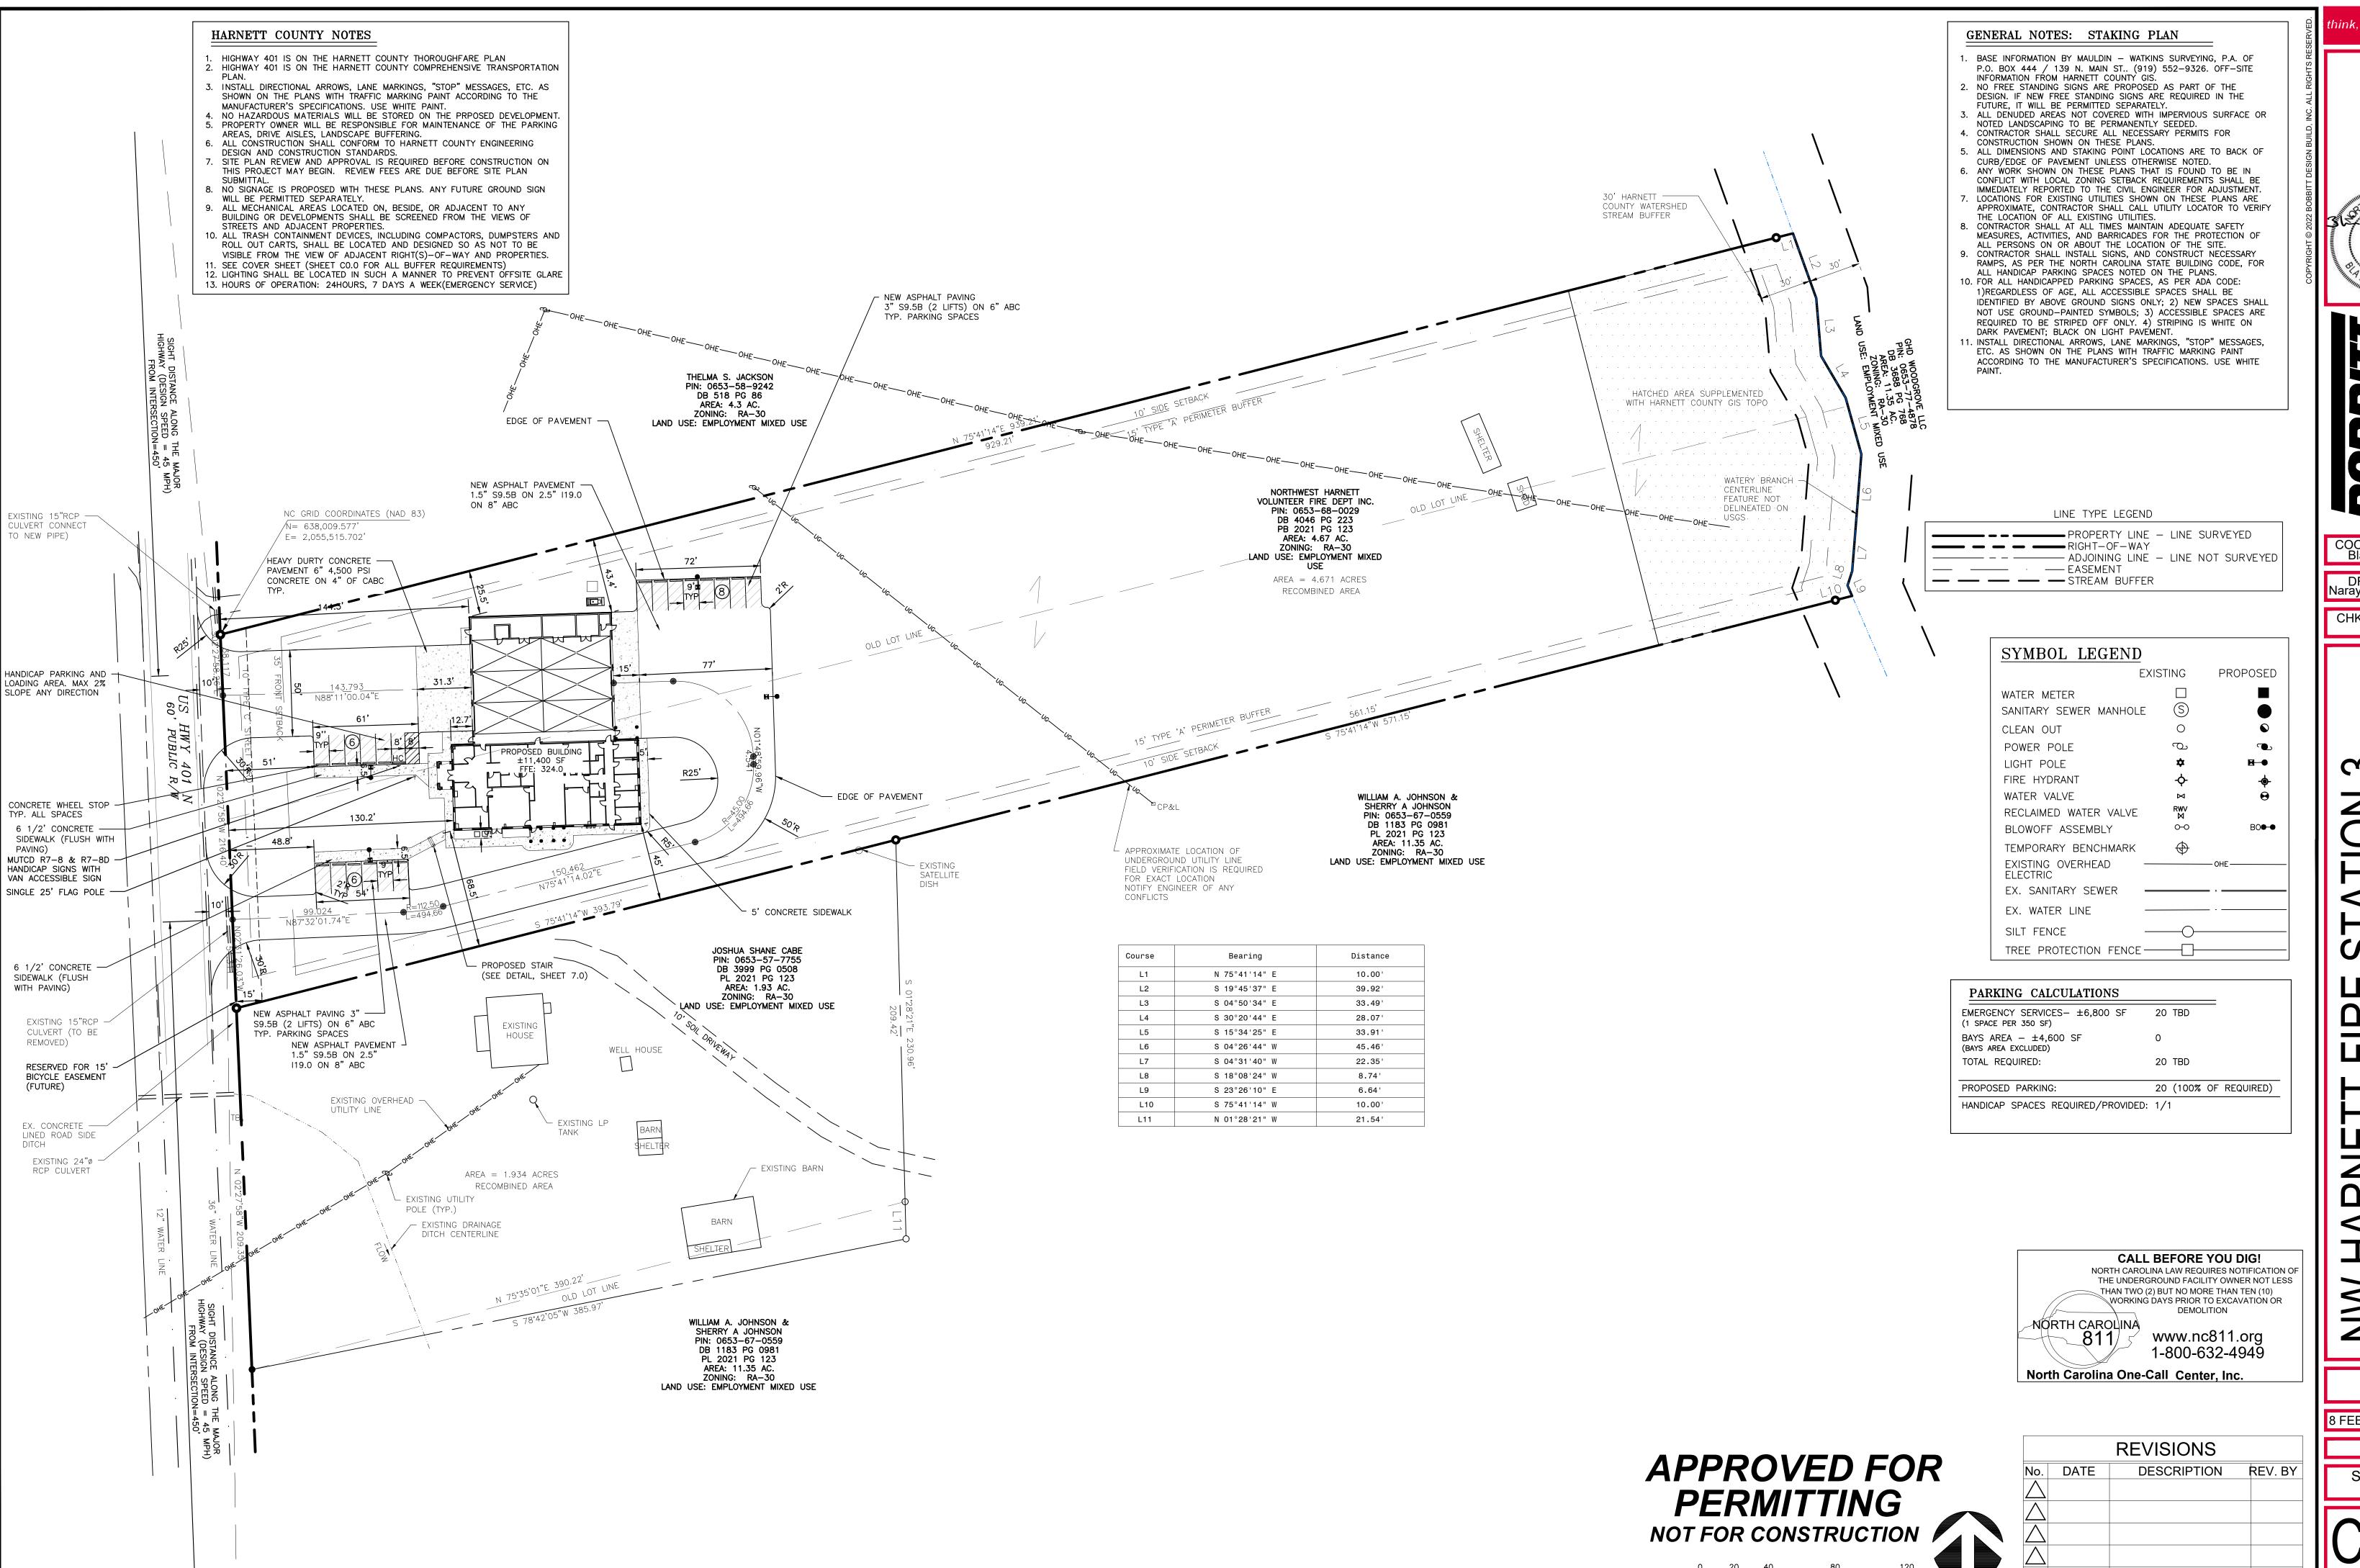

SEAL 24438

COORDINATOR: Blair Pittman

DRAWN BY: Narayan Nyaupane

CHK BY: BPP

REVISIONS			
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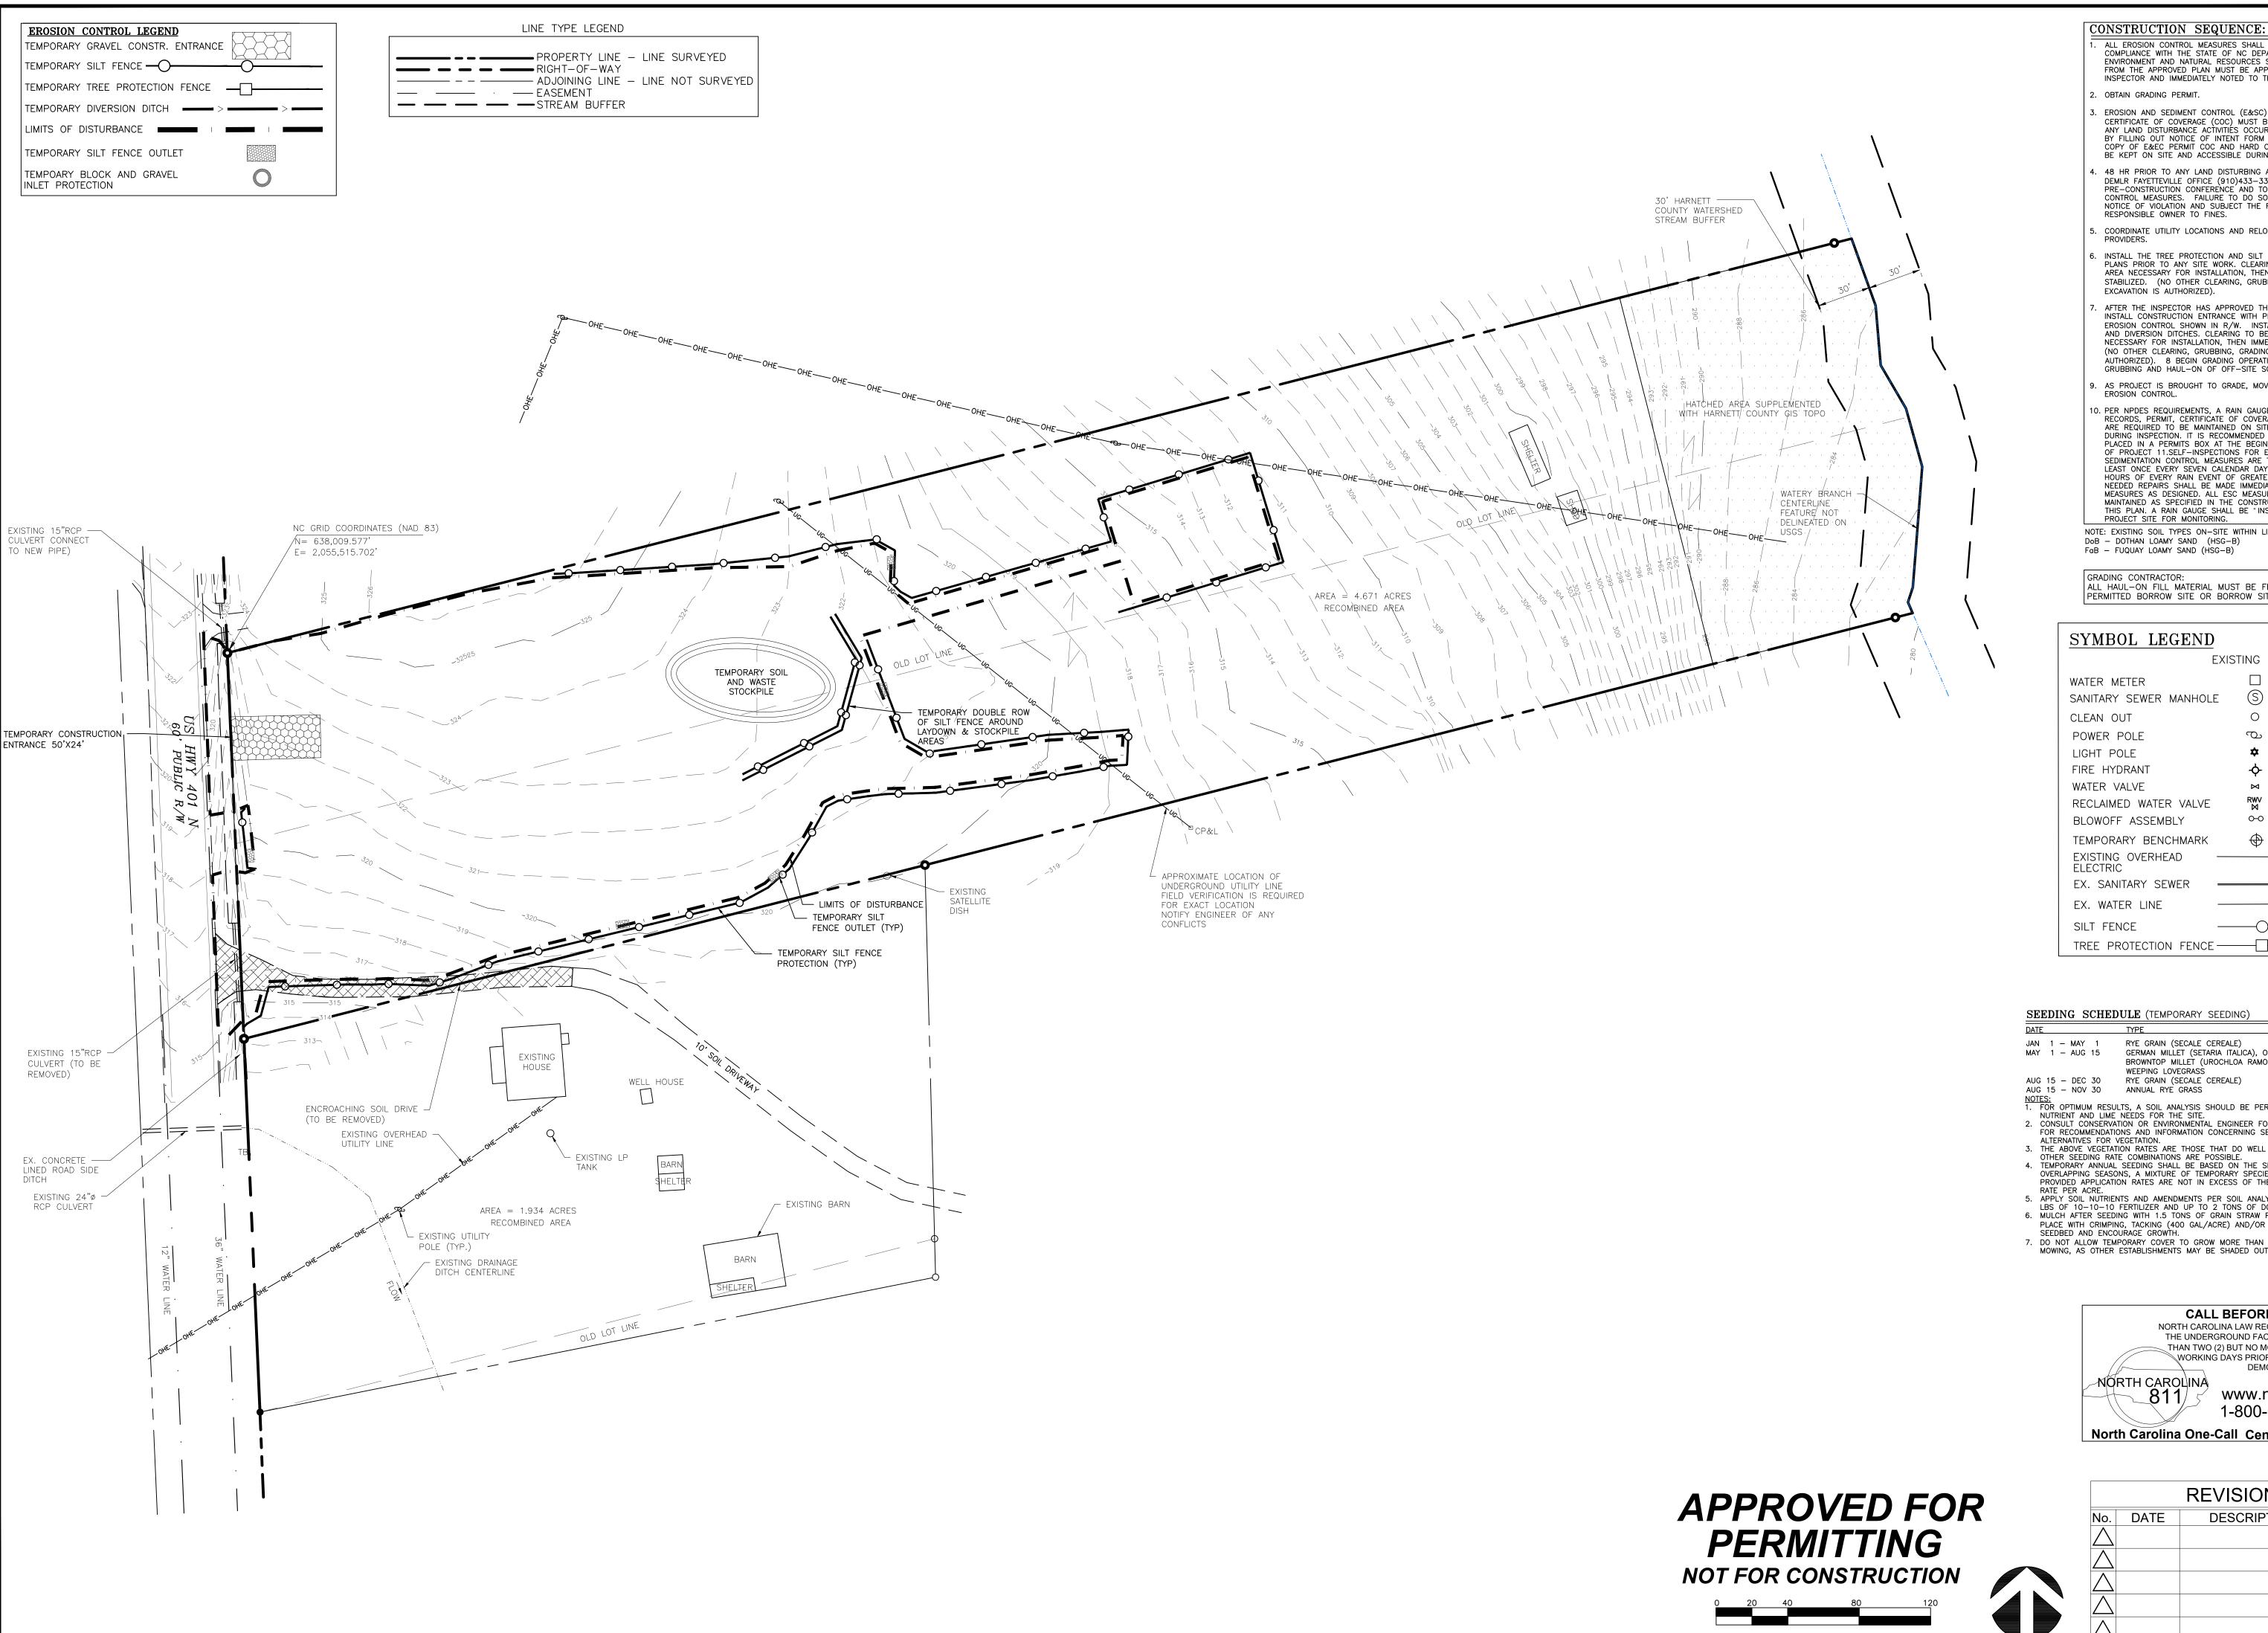
24 X 36

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1" = 40'

8 FEBRUARY 2022

21-0337 STAKING PLAN



ALL EROSION CONTROL MEASURES SHALL BE IN STRICT COMPLIANCE WITH THE STATE OF NC DEPARTMENT OF ENVIRONMENT AND NATURAL RESOURCES STANDARDS. DEVIATIONS
FROM THE APPROVED PLAN MUST BE APPROVED BY THE INSPECTOR AND IMMEDIATELY NOTED TO THE ENGINEER.

OBTAIN GRADING PERMIT.

EROSION AND SEDIMENT CONTROL (E&SC) PERMIT AND A CERTIFICATE OF COVERAGE (COC) MUST BE OBTAINED BEFORE ANY LAND DISTURBANCE ACTIVITIÉS OCCUR. COC IS OBTAINED BY FILLING OUT NOTICE OF INTENT FORM FOR NCGO1 PERMIT. COPY OF E&EC PERMIT COC AND HARD COPY OF PLANS MUST BE KEPT ON SITE AND ACCESSIBLE DURING INSPECTION

48 HR PRIOR TO ANY LAND DISTURBING ACTIVITIES, CONTACT DEMLR FAYETTEVILLE OFFICE (910)433-3300 TO COORDINATE A PRE-CONSTRUCTION CONFERENCE AND TO DISCUSS EROSION CONTROL MEASURES. FAILURE TO DO SO WILL RESULT IN A NOTICE OF VIOLATION AND SUBJECT THE FINANCIALLY RESPONSIBLE OWNER TO FINES.

COORDINATE UTILITY LOCATIONS AND RELOCATIONS WITH SERVICE PROVIDERS.

INSTALL THE TREE PROTECTION AND SILT FENCE AS SHOWN ON PLANS PRIOR TO ANY SITE WORK. CLEARING TO BE LIMITED TO AREA NECESSARY FOR INSTALLATION, THEN IMMEDIATELY STABILIZED. (NO OTHER CLEARING, GRUBBING, GRADING, OR EXCAVATION IS AUTHORIZED).

. AFTER THE INSPECTOR HAS APPROVED THE FENCE INSTALLATION, INSTALL CONSTRUCTION ENTRANCE WITH PERMANENT ROAD PIPE, EROSION CONTROL SHOWN IN R/W. INSTALL SEDIMENT TRAP AND DIVERSION DITCHES. CLEARING TO BE LIMITED TO AREA NECESSARY FOR INSTALLATION, THEN IMMEDIATELY STABILIZED (NO OTHER CLEARING, GRUBBING, GRADING, OR EXCAVATION IS AUTHORIZED). 8 BEGIN GRADING OPERATIONS, CLEARING AND GRUBBING AND HAUL-ON OF OFF-SITE SOILS

. AS PROJECT IS BROUGHT TO GRADE, MOVE TO PHASE TWO EROSION CONTROL.

10. PER NPDES REQUIREMENTS, A RAIN GAUGE, SELF-INSPECTIONS RECORDS, PERMIT, CERTIFICATE OF COVERAGE, AND S&E PLAN ARE REQUIRED TO BE MAINTAINED ON SITE AND ACCESSIBLE DURING INSPECTION. IT IS RECOMMENDED THAT THESE ITEMS BE PLACED IN A PERMITS BOX AT THE BEGINNING OR ENTRANCE OF PROJECT 11.SELF-INSPECTIONS FOR EROSION AND SEDIMENTATION CONTROL MEASURES ARE TO BE PERFORMED AT LEAST ONCE EVERY SEVEN CALENDAR DAYS AND WITHIN 24 HOURS OF EVERY RAIN EVENT OF GREATER THAN 1 INCH. ANY NEEDED REPAIRS SHALL BE MADE IMMEDIATELY TO MAINTAIN MEASURES AS DESIGNED. ALL ESC MEASURES SHALL BE MAINTAINED AS SPECIFIED IN THE CONSTRUCTION DETAILS ON THIS PLAN. A RAIN GAUGE SHALL BE "INSTALLED AT THE

NOTE: EXISTING SOIL TYPES ON-SITE WITHIN LIMIT OF DISTURBANCE DoB - DOTHAN LOAMY SAND (HSG-B) FaB - FUQUAY LOAMY SAND (HSG-B)

GRADING CONTRACTOR: ALL HAUL-ON FILL MATERIAL MUST BE FROM AN EXISTING PERMITTED BORROW SITE OR BORROW SITE MUST BE PERMITTED

SYMBOL LEGEND **EXISTING** PROPOSED SANITARY SEWER MANHOLE RECLAIMED WATER VALVE B0**●**● BLOWOFF ASSEMBLY TEMPORARY BENCHMARK EXISTING OVERHEAD EX. SANITARY SEWER

SEEDING SCHEDULE (TEMPORARY SEEDING)

PLANTING RATE 120 LBS/ACRE RYE GRAIN (SECALE CEREALE) GERMAN MILLET (SETARIA ITALICA), OR 45 LBS/ACRE BROWNTOP MILLET (UROCHLOA RAMOSA), OR 45 LBS/ACRE WEEPING LOVEGRASS 5 LBS/ACRE AUG 15 - DEC 30 RYE GRAIN (SECALE CEREALE) 120 LBS/ACRE AUG 15 - NOV 30 ANNUAL RYE GRASS 40 LBS/ACRE NOTES:
1. FOR OPTIMUM RESULTS, A SOIL ANALYSIS SHOULD BE PERFORMED TO DETERMINE

NUTRIENT AND LIME NEEDS FOR THE SITE.

2. CONSULT CONSERVATION OR ENVIRONMENTAL ENGINEER FOR A SOIL ANALYSIS AND FOR RECOMMENDATIONS AND INFORMATION CONCERNING SEEDING, FERTILIZING, AND 3. THE ABOVE VEGETATION RATES ARE THOSE THAT DO WELL UNDER LOCAL CONDITIONS;

OTHER SEEDING RATE COMBINATIONS ARE POSSIBLE. 4. TEMPORARY ANNUAL SEEDING SHALL BE BASED ON THE SEASON. DURING OVERLAPPING SEASONS, A MIXTURE OF TEMPORARY SPECIES IS ACCEPTABLE PROVIDED APPLICATION RATES ARE NOT IN EXCESS OF THE TOTAL RECOMMENDED

5. APPLY SOIL NUTRIENTS AND AMENDMENTS PER SOIL ANALYSIS, OTHERWISE 750-1000 LBS OF 10-10-10 FERTILIZER AND UP TO 2 TONS OF DOLOMITIC LIME PER ACRE.
6. MULCH AFTER SEEDING WITH 1.5 TONS OF GRAIN STRAW PER ACRE AND SECURE IN PLACE WITH CRIMPING, TACKING (400 GAL/ACRE) AND/OR NETTING TO PROTECT SEEDBED AND ENCOURAGE GROWTH.

7. DO NOT ALLOW TEMPORARY COVER TO GROW MORE THAN 12" IN HEIGHT BEFORE MOWING, AS OTHER ESTABLISHMENTS MAY BE SHADED OUT.

CALL BEFORE YOU DIG! NORTH CAROLINA LAW REQUIRES NOTIFICATION OF THE UNDERGROUND FACILITY OWNER NOT LESS THAN TWO (2) BUT NO MORE THAN TEN (10) WORKING DAYS PRIOR TO EXCAVATION OR

-NORTH CAROLINA 811

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DEMOLITION

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think, design, build

COORDINATOR: Blair Pittman

DRAWN BY: Narayan Nyaupane

CHK BY: BPP


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24 X 36 1" = 40'

8 FEBRUARY 2022

21-0337 PHASE I EROSION CONTROL



CONSTRUCTION SEQUENCE:

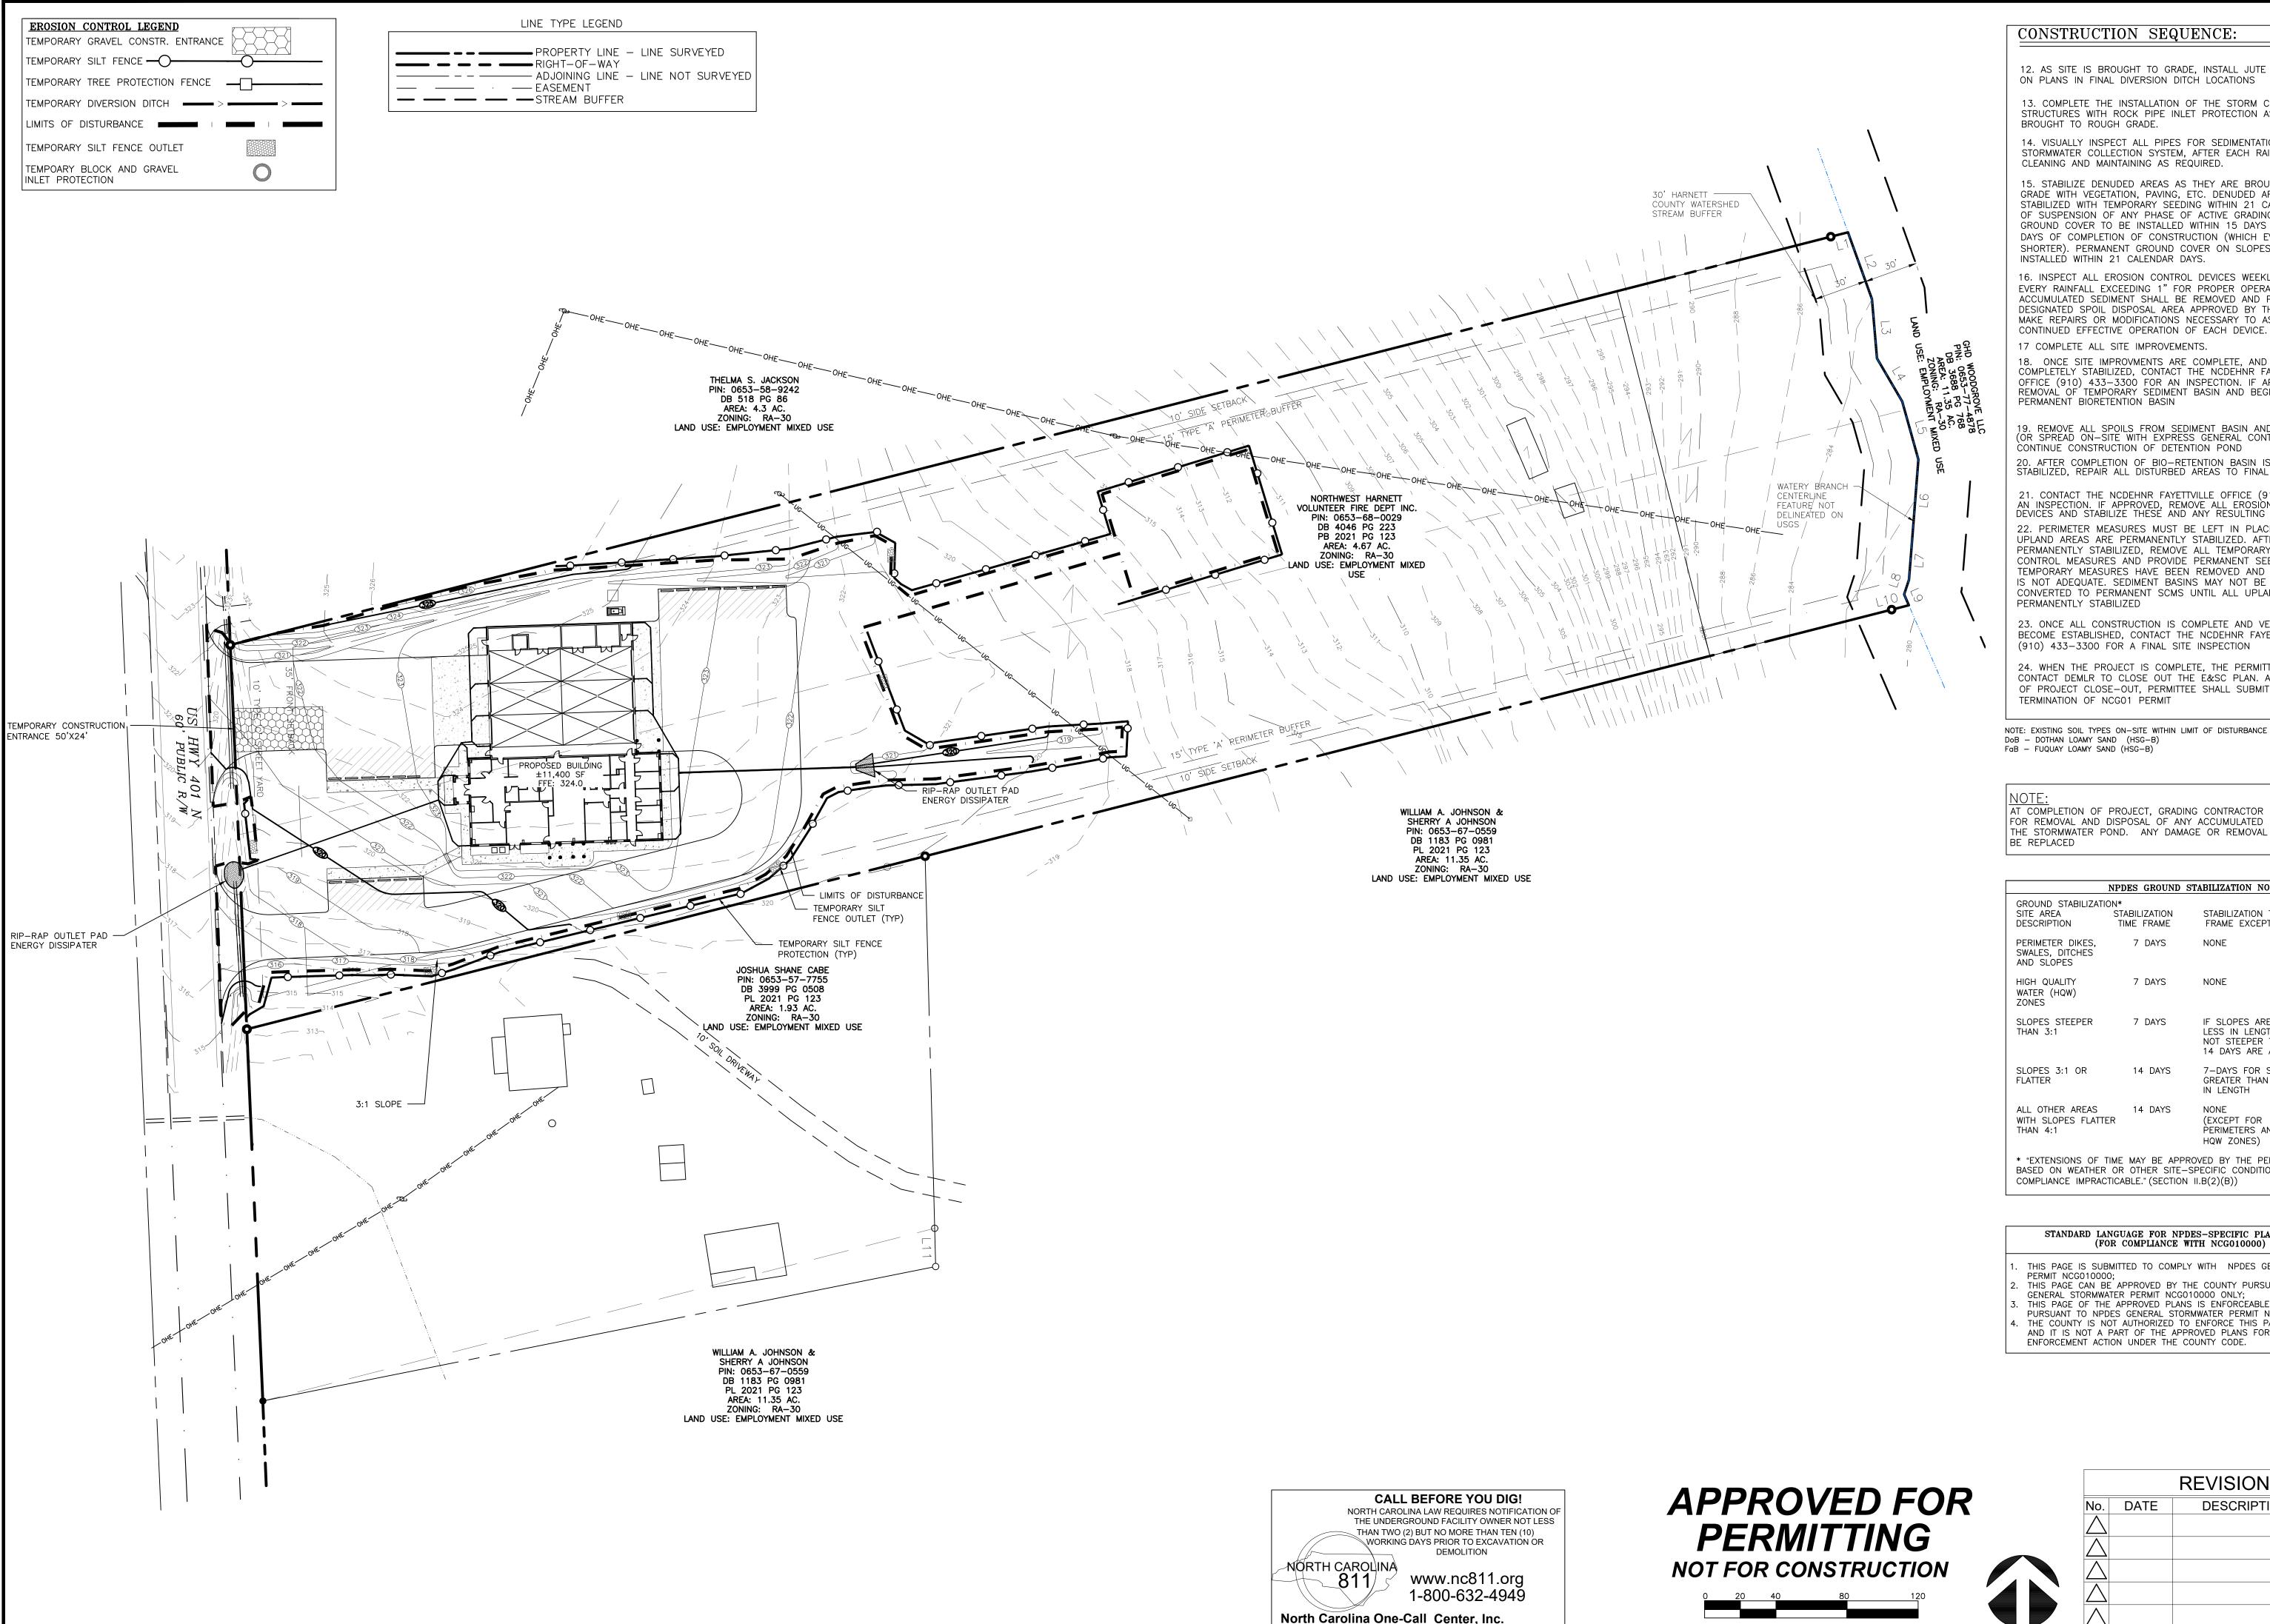12. AS SITE IS BROUGHT TO GRADE, INSTALL JUTE MATTING AS SHOWN ON PLANS IN FINAL DIVERSION DITCH LOCATIONS

13. COMPLETE THE INSTALLATION OF THE STORM CONVEYANCE STRUCTURES WITH ROCK PIPE INLET PROTECTION AS AREAS ARE

14. VISUALLY INSPECT ALL PIPES FOR SEDIMENTATION IN STORMWATER COLLECTION SYSTEM, AFTER EACH RAINFALL EVENT,

15. STABILIZE DENUDED AREAS AS THEY ARE BROUGHT UP TO FINISH GRADE WITH VEGETATION, PAVING, ETC. DENUDED AREAS TO BE STABILIZED WITH TEMPORARY SEEDING WITHIN 21 CALENDAR DAYS OF SUSPENSION OF ANY PHASE OF ACTIVE GRADING. PERMANENT GROUND COVER TO BE INSTALLED WITHIN 15 DAYS OR 30 CALANDAR DAYS OF COMPLETION OF CONSTRUCTION (WHICH EVER IS SHORTER). PERMANENT GROUND COVER ON SLOPES TO BE

16. INSPECT ALL EROSION CONTROL DEVICES WEEKLY AND AFTER EVERY RAINFALL EXCEEDING 1" FOR PROPER OPERATION. ANY ACCUMULATED SEDIMENT SHALL BE REMOVED AND PLACED IN A DESIGNATED SPOIL DISPOSAL AREA APPROVED BY THE INSPECTOR. MAKE REPAIRS OR MODIFICATIONS NECESSARY TO ASSURE

18. ONCE SITE IMPROVMENTS ARE COMPLETE, AND SITE IS COMPLETELY STABILIZED, CONTACT THE NCDEHNR FAYETTEVILLE OFFICE (910) 433-3300 FOR AN INSPECTION. IF APPROVED, BEGIN REMOVAL OF TEMPORARY SEDIMENT BASIN AND BEGIN CONSTRUCTION PERMANENT BIORETENTION BASIN

19. REMOVE ALL SPOILS FROM SEDIMENT BASIN AND WASTE OFF-SITE (OR SPREAD ON-SITE WITH EXPRESS GENERAL CONTRACTOR APPROVAL) CONTINUE CONSTRUCTION OF DETENTION POND

20. AFTER COMPLETION OF BIO-RETENTION BASIN IS COMPLETE AND STABILIZED, REPAIR ALL DISTURBED AREAS TO FINAL GRADES

21. CONTACT THE NCDEHNR FAYETTVILLE OFFICE (910) 433—3300 FOR AN INSPECTION. IF APPROVED, REMOVE ALL EROSION CONTROL DEVICES AND STABILIZE THESE AND ANY RESULTING BARE AREAS. 22. PERIMETER MEASURES MUST BE LEFT IN PLACE UNTIL ALL UPLAND AREAS ARE PERMANENTLY STABILIZED. AFTER SITE IS PERMANENTLY STABILIZED, REMOVE ALL TEMPORARY EROSION CONTROL MEASURES AND PROVIDE PERMANENT SEEDING WHERE TEMPORARY MEASURES HAVE BEEN REMOVED AND GROUND COVER IS NOT ADEQUATE. SEDIMENT BASINS MAY NOT BE REMOVED OR CONVERTED TO PERMANENT SCMS UNTIL ALL UPLAND AREAS ARE

23. ONCE ALL CONSTRUCTION IS COMPLETE AND VEGETATION HAS BECOME ESTABLISHED, CONTACT THE NCDEHNR FAYETTVILLE OFFICE (910) 433-3300 FOR A FINAL SITE INSPECTION

24. WHEN THE PROJECT IS COMPLETE, THE PERMITTEE SHALL CONTACT DEMLR TO CLOSE OUT THE E&SC PLAN. AFTER NOTIFICATION OF PROJECT CLOSE-OUT, PERMITTEE SHALL SUBMIT NOTICE OF TERMINATION OF NCG01 PERMIT

NOTE: EXISTING SOIL TYPES ON-SITE WITHIN LIMIT OF DISTURBANCE DoB - DOTHAN LOAMY SAND (HSG-B)

AT COMPLETION OF PROJECT, GRADING CONTRACTOR IS RESPONSIBLE FOR REMOVAL AND DISPOSAL OF ANY ACCUMULATED SEDIMENT IN THE STORMWATER POND. ANY DAMAGE OR REMOVAL OF TURF IS TO

	NPDES GROUND	STABILIZATION NOTES:
GROUND STABILIZAT SITE AREA DESCRIPTION	STABILIZATION	STABILIZATION TIME FRAME EXCEPTIONS
PERIMETER DIKES, SWALES, DITCHES AND SLOPES	7 DAYS	NONE
HIGH QUALITY WATER (HQW) ZONES	7 DAYS	NONE
SLOPES STEEPER THAN 3:1	7 DAYS	IF SLOPES ARE 10'OR LESS IN LENGTH AND ARE NOT STEEPER THAN 2:1, 14 DAYS ARE ALLOWED.
SLOPES 3:1 OR FLATTER	14 DAYS	7-DAYS FOR SLOPES GREATER THAN 50 FEET IN LENGTH
ALL OTHER AREAS WITH SLOPES FLATT THAN 4:1		NONE (EXCEPT FOR PERIMETERS AND HQW ZONES)


* "EXTENSIONS OF TIME MAY BE APPROVED BY THE PERMITTING AUTHORITY BASED ON WEATHER OR OTHER SITE-SPECIFIC CONDITIONS THAT MAKE COMPLIANCE IMPRACTICABLE." (SECTION II.B(2)(B))

STANDARD LANGUAGE FOR NPDES-SPECIFIC PLAN SHEETS (FOR COMPLIANCE WITH NCG010000)

THIS PAGE IS SUBMITTED TO COMPLY WITH NPDES GENERAL STORMWATER

- THIS PAGE CAN BE APPROVED BY THE COUNTY PURSUANT TO NPDES GENERAL STORMWATER PERMIT NCG010000 ONLY:
- THIS PAGE OF THE APPROVED PLANS IS ENFORCEABLE EXCLUSIVELY

PURSUANT TO NPDES GENERAL STORMWATER PERMIT NCG010000; THE COUNTY IS NOT AUTHORIZED TO ENFORCE THIS PAGE OF THE PLANS AND IT IS NOT A PART OF THE APPROVED PLANS FOR PURPOSES OF ENFORCEMENT ACTION UNDER THE COUNTY CODE.

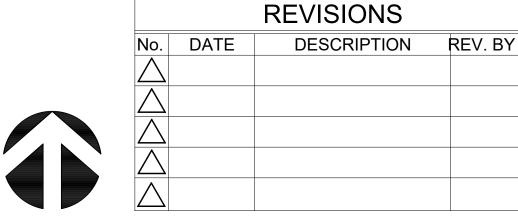

think, design, build

COORDINATOR: Blair Pittman

DRAWN BY: Narayan Nyaupane


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24 X 36 1" = 40'

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21-0337

PHASE II EROSION CONTRO



COORDINATOR: Blair Pittman

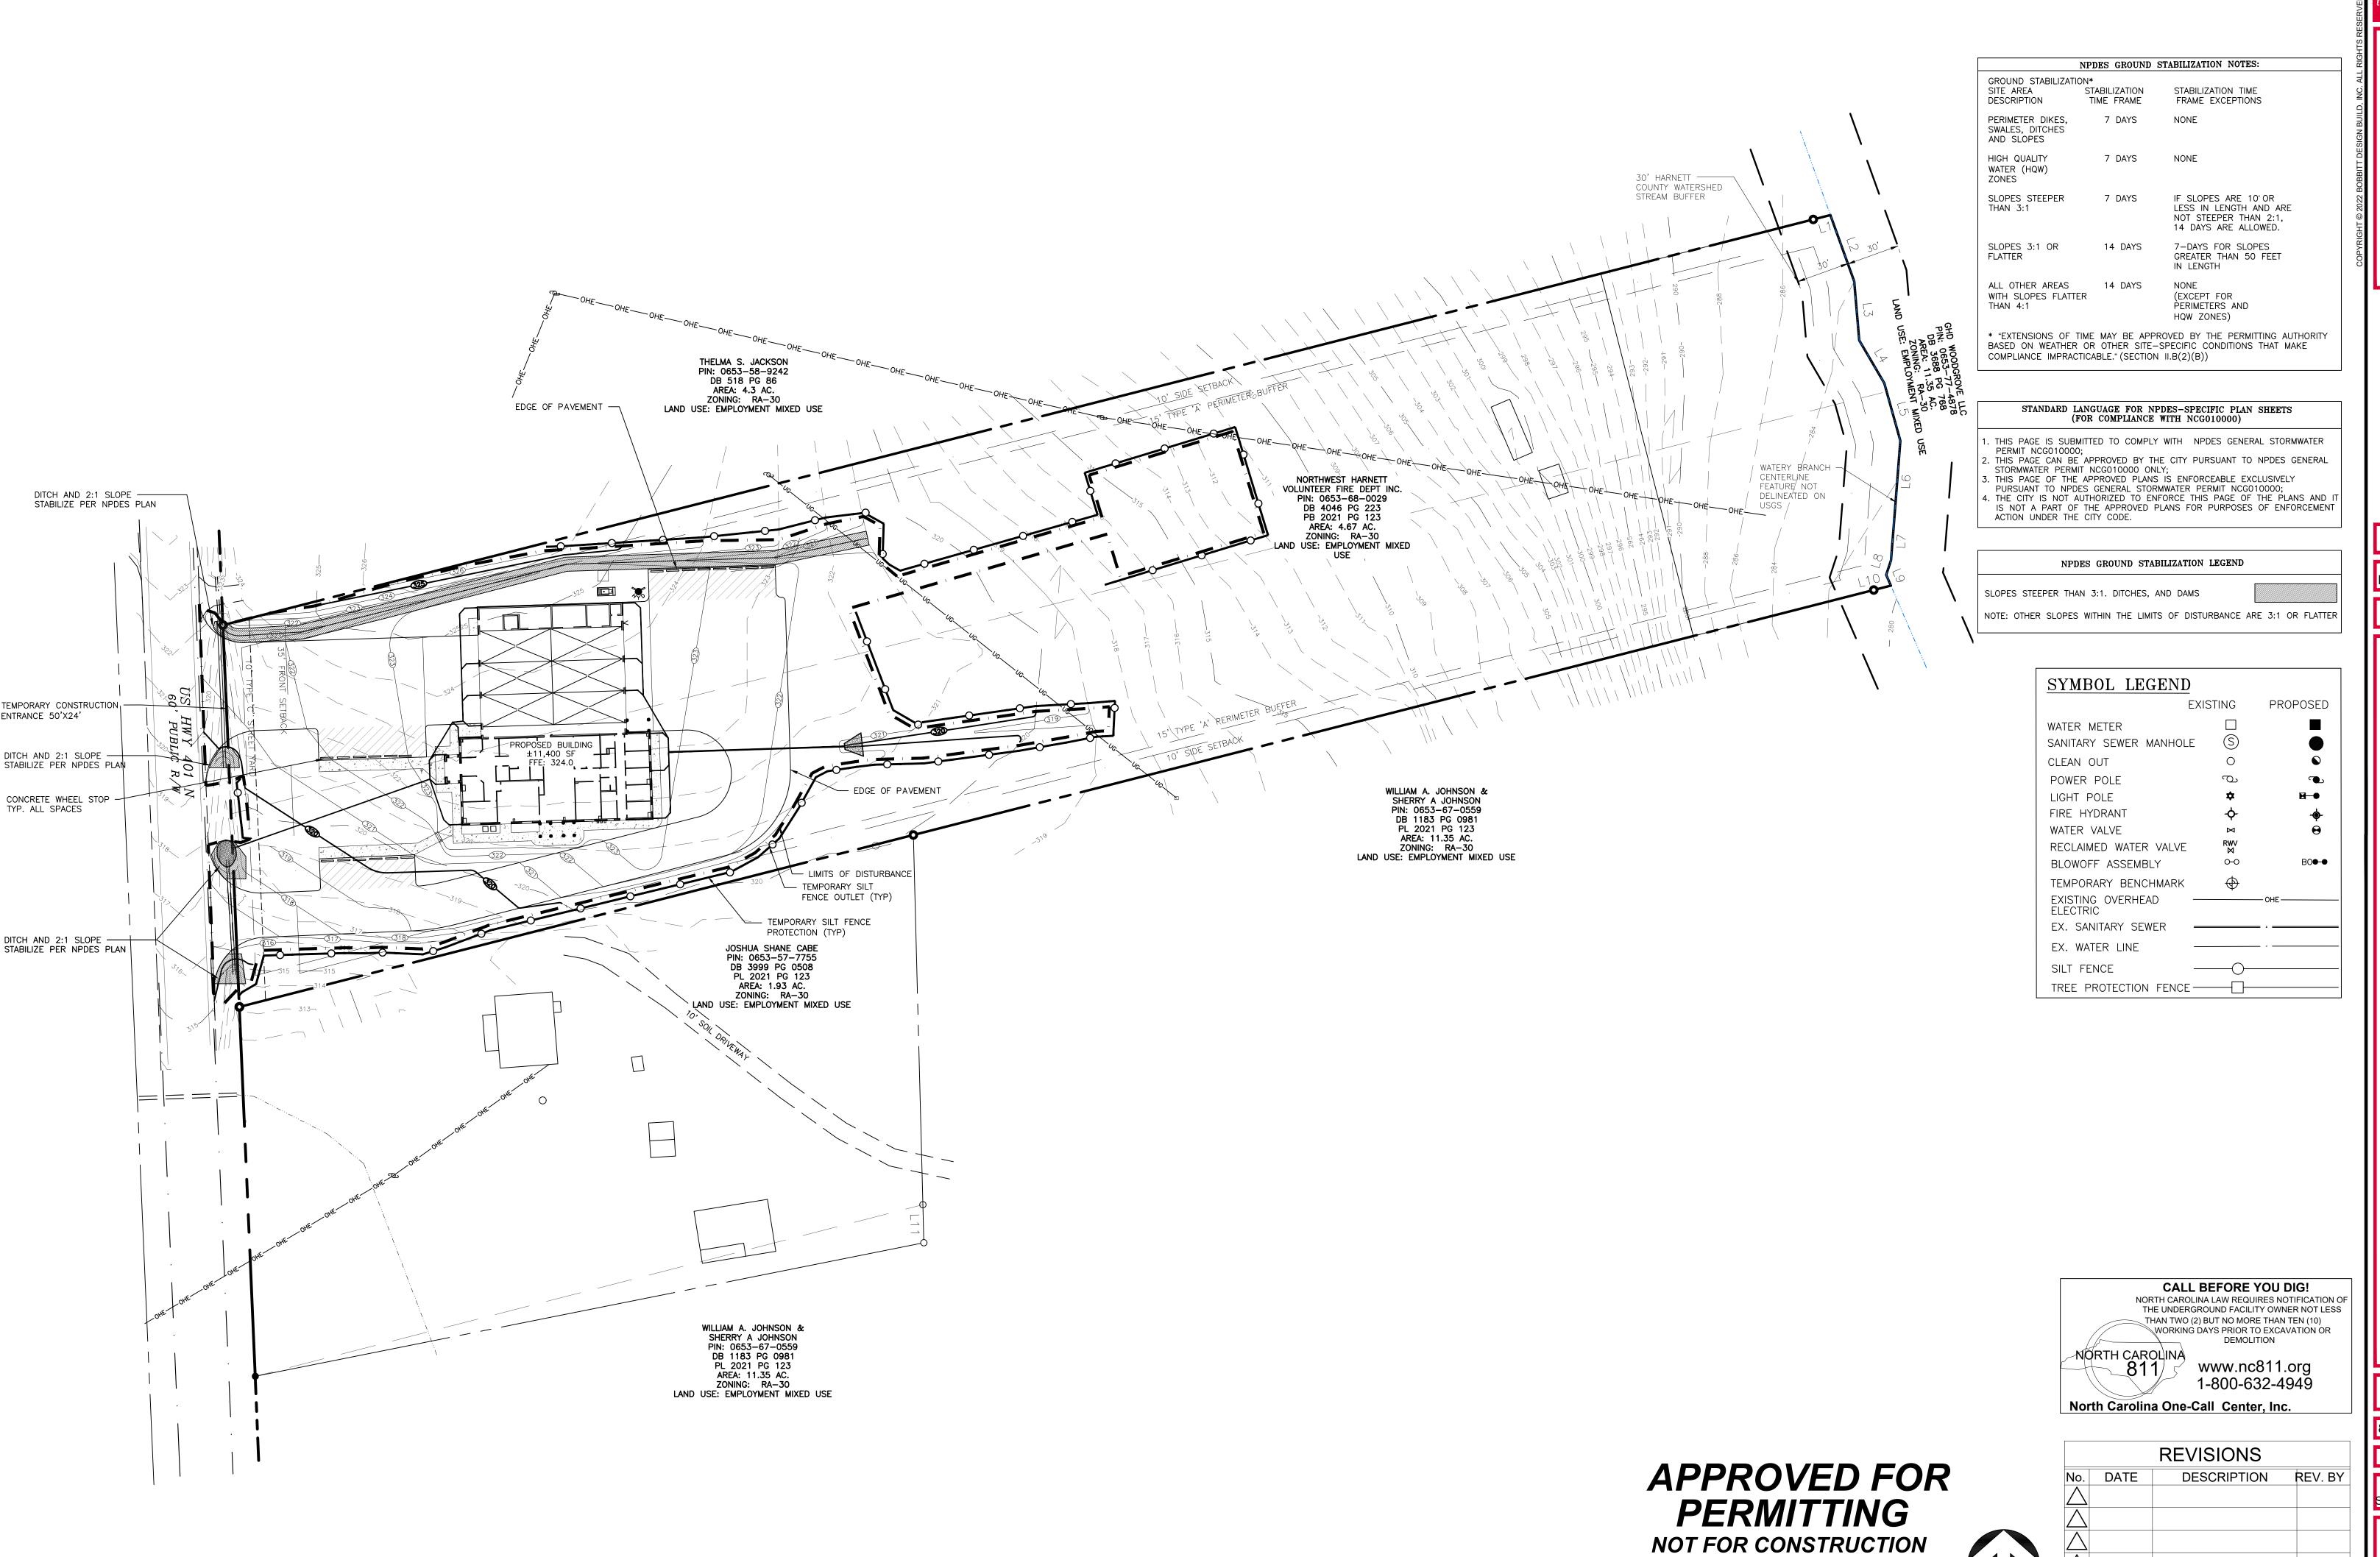DRAWN BY: Narayan Nyaupane

CHK BY:BPP


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1" = 40'

8 FEBRUARY 2022

21-0337

NPDES STABILIZATION PLAN

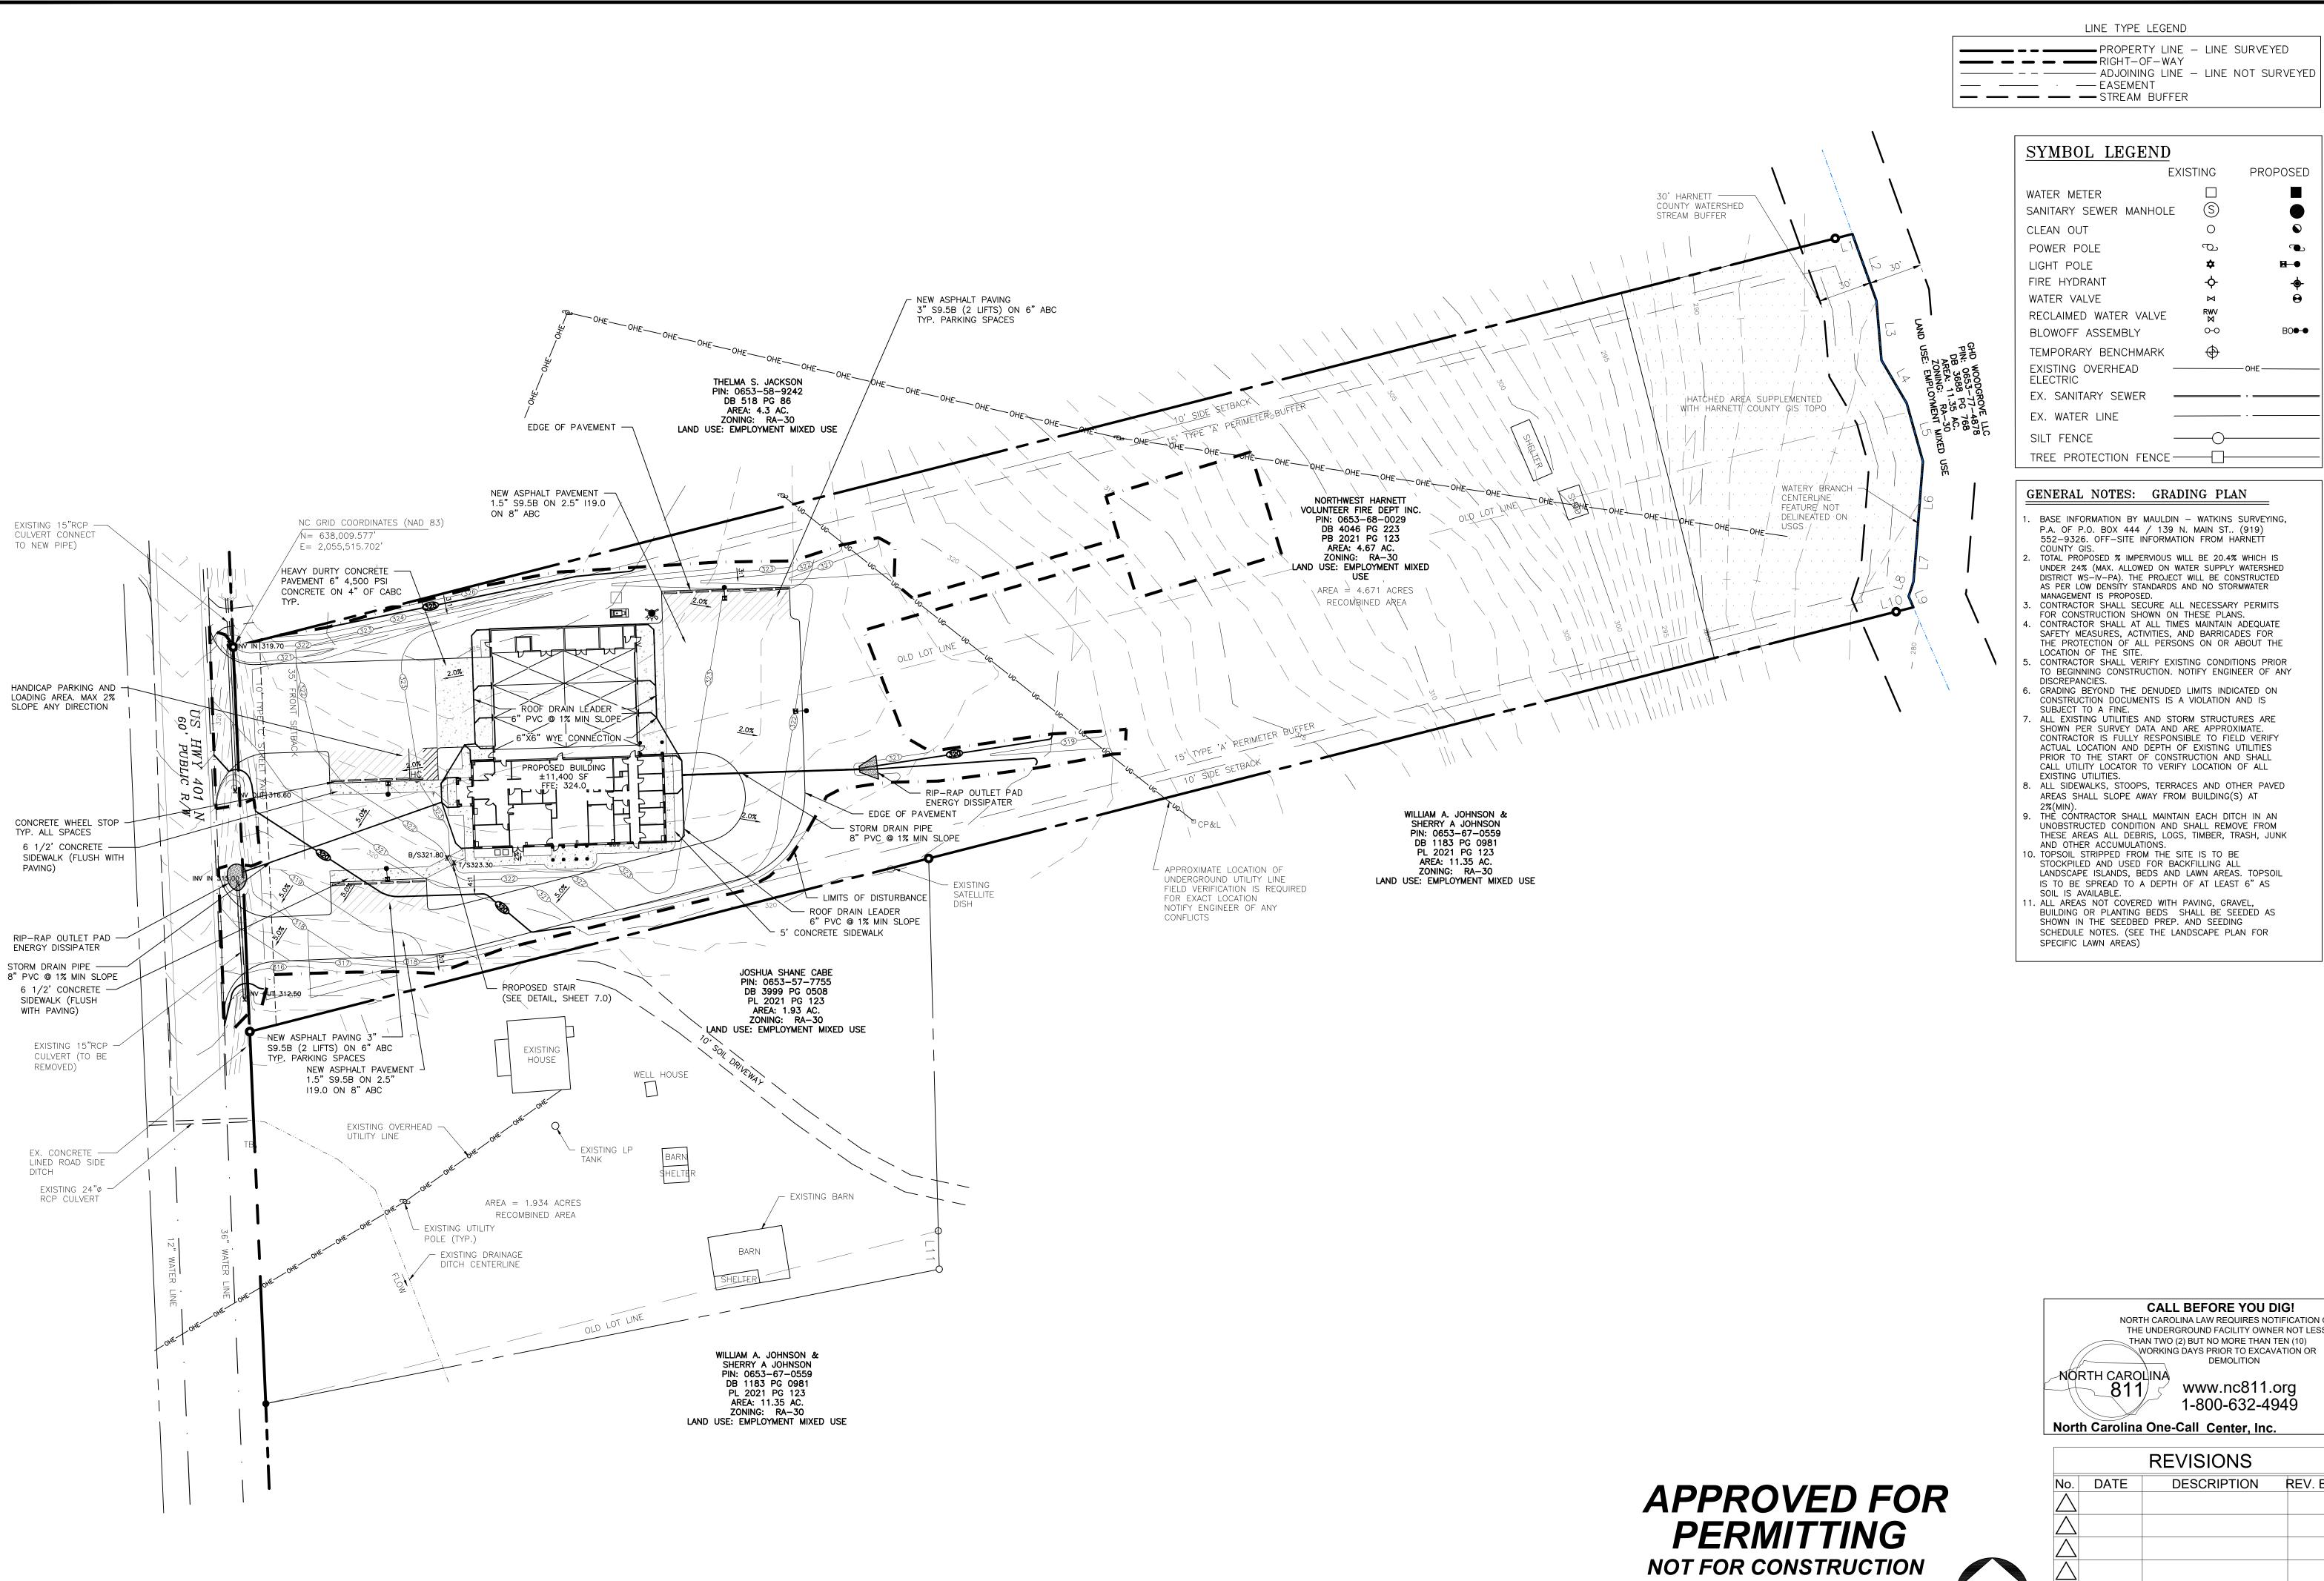

80●-●



COORDINATOR: Blair Pittman

A

DRAWN BY:

Narayan Nyaupane

CHK BY:BPP

THE PROTECTION OF ALL PERSONS ON OR ABOUT THE CONTRACTOR SHALL VERIFY EXISTING CONDITIONS PRIOR TO BEGINNING CONSTRUCTION. NOTIFY ENGINEER OF ANY

GRADING BEYOND THE DENUDED LIMITS INDICATED ON

CONSTRUCTION DOCUMENTS IS A VIOLATION AND IS

SHOWN PER SURVEY DATA AND ARE APPROXIMATE. CONTRACTOR IS FULLY RESPONSIBLE TO FIELD VERIFY ACTUAL LOCATION AND DEPTH OF EXISTING UTILITIES PRIOR TO THE START OF CONSTRUCTION AND SHALL CALL UTILITY LOCATOR TO VERIFY LOCATION OF ALL

AREAS SHALL SLOPE AWAY FROM BUILDING(S) AT

THÈ CÓNTRACTOR SHALL MAINTAIN EACH DITCH IN AN UNOBSTRUCTED CONDITION AND SHALL REMOVE FROM THESE AREAS ALL DEBRIS, LOGS, TIMBER, TRASH, JUNK

LANDSCAPE ISLANDS, BEDS AND LAWN AREAS. TOPSOIL IS TO BE SPREAD TO A DEPTH OF AT LEAST 6" AS

BUILDING OR PLANTING BEDS SHALL BE SEEDED AS SCHEDULE NOTES. (SEE THE LANDSCAPE PLAN FOR

> CALL BEFORE YOU DIG! NORTH CAROLINA LAW REQUIRES NOTIFICATION OF THE UNDERGROUND FACILITY OWNER NOT LESS THAN TWO (2) BUT NO MORE THAN TEN (10) WORKING DAYS PRIOR TO EXCAVATION OR DEMOLITION

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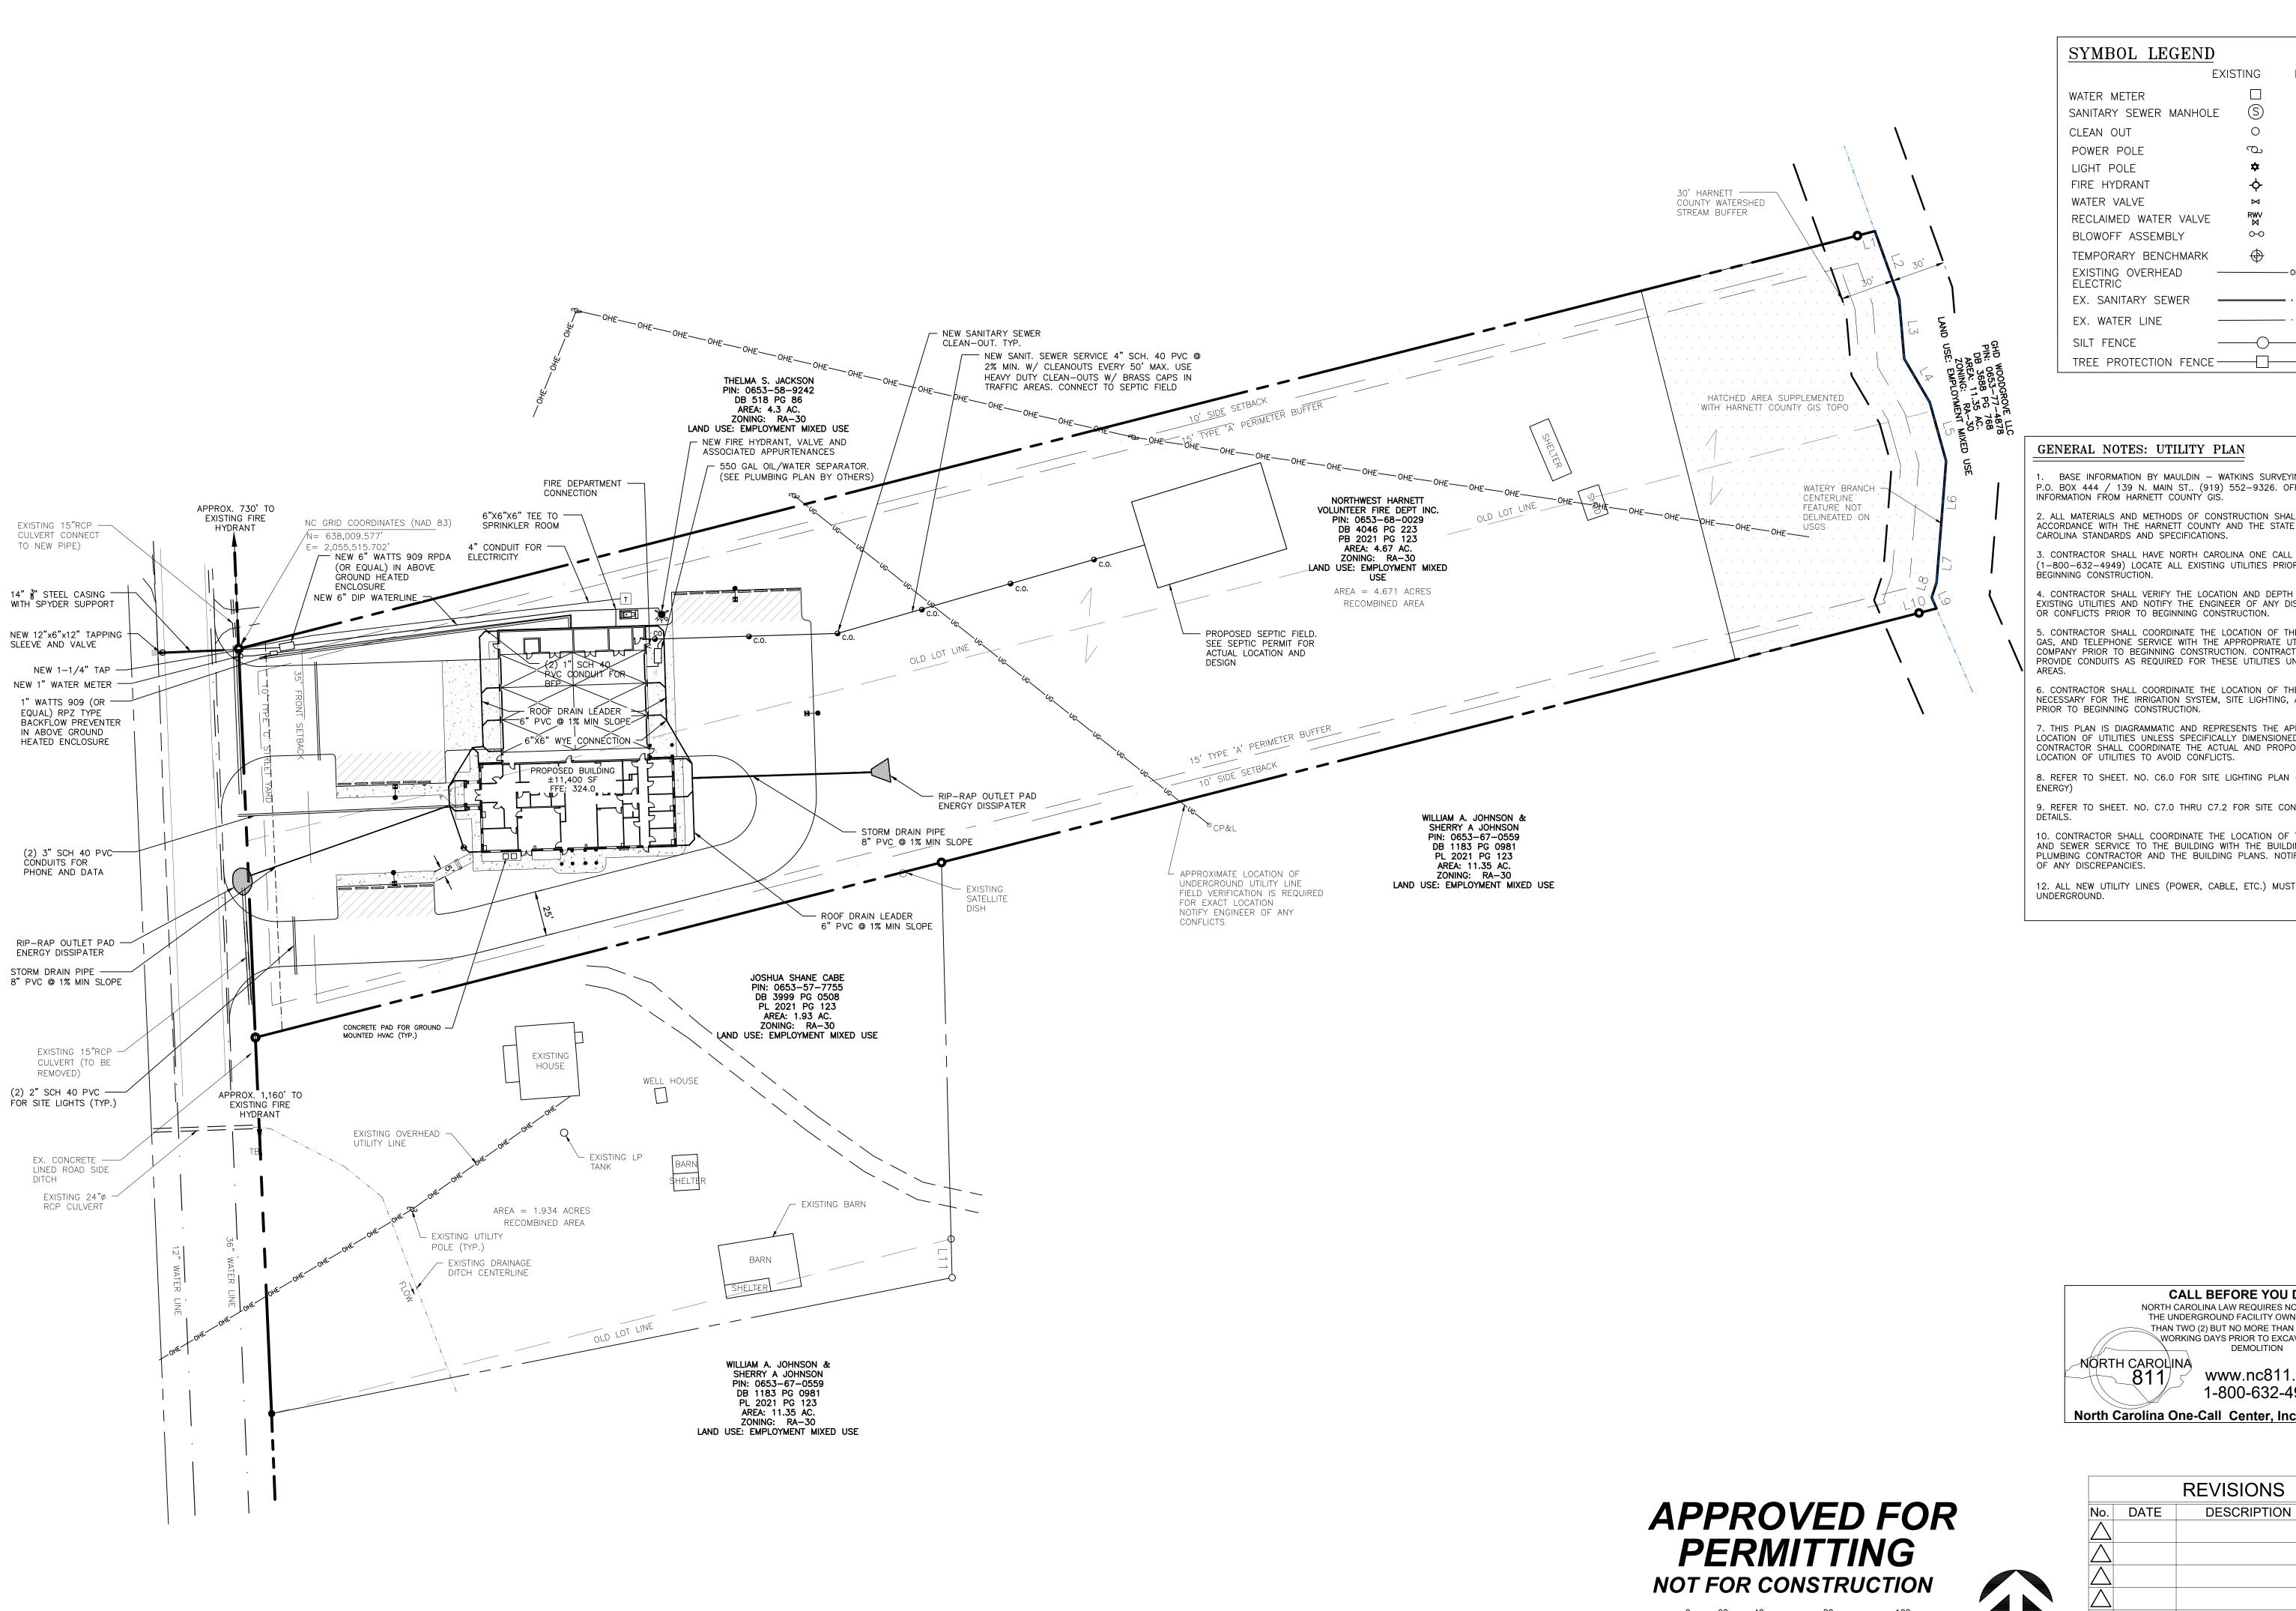
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8 FEBRUARY 2022

21-0337 GRADING

PLAN



SYMBOL LEGEND PROPOSED **EXISTING** SANITARY SEWER MANHOLE RECLAIMED WATER VALVE 80●-● TEMPORARY BENCHMARK

GENERAL NOTES: UTILITY PLAN

BASE INFORMATION BY MAULDIN - WATKINS SURVEYING, P.A. OF P.O. BOX 444 / 139 N. MAIN ST.. (919) 552-9326. OFF-SITE INFORMATION FROM HARNETT COUNTY GIS.

2. ALL MATERIALS AND METHODS OF CONSTRUCTION SHALL BE IN ACCORDANCE WITH THE HARNETT COUNTY AND THE STATE OF NORTH CAROLINA STANDARDS AND SPECIFICATIONS.

3. CONTRACTOR SHALL HAVE NORTH CAROLINA ONE CALL (1-800-632-4949) LOCATE ALL EXISTING UTILITIES PRIOR TO

4. CONTRACTOR SHALL VERIFY THE LOCATION AND DEPTH OF ALL EXISTING UTILITIES AND NOTIFY THE ENGINEER OF ANY DISCREPANCIES OR CONFLICTS PRIOR TO BEGINNING CONSTRUCTION.

5. CONTRACTOR SHALL COORDINATE THE LOCATION OF THE ELECTRIC, GAS, AND TELEPHONE SERVICE WITH THE APPROPRIATE UTILITY COMPANY PRIOR TO BEGINNING CONSTRUCTION. CONTRACTOR SHALL PROVIDE CONDUITS AS REQUIRED FOR THESE UTILITIES UNDER PAVED

6. CONTRACTOR SHALL COORDINATE THE LOCATION OF THE CONDUITS NECESSARY FOR THE IRRIGATION SYSTEM, SITE LIGHTING, AND SIGNAGE

7. THIS PLAN IS DIAGRAMMATIC AND REPRESENTS THE APPROXIMATE LOCATION OF UTILITIES UNLESS SPECIFICALLY DIMENSIONED. THE CONTRACTOR SHALL COORDINATE THE ACTUAL AND PROPOSED LOCATION OF UTILITIES TO AVOID CONFLICTS.


8. REFER TO SHEET. NO. C6.0 FOR SITE LIGHTING PLAN (BY DUKE

9. REFER TO SHEET. NO. C7.0 THRU C7.2 FOR SITE CONSTRUCTION

AND SEWER SERVICE TO THE BUILDING WITH THE BUILDING PLUMBING CONTRACTOR AND THE BUILDING PLANS. NOTIFY ENGINEER

CALL BEFORE YOU DIG! THAN TWO (2) BUT NO MORE THAN TEN (10) WORKING DAYS PRIOR TO EXCAVATION OR DEMOLITION www.nc811.org 1-800-632-4949



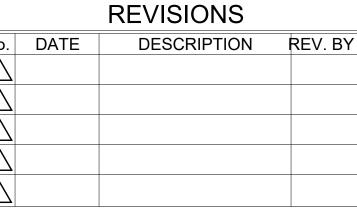

think, design, build



COORDINATOR: Blair Pittman

DRAWN BY: Narayan Nyaupane

CHK BY: BPP

10. CONTRACTOR SHALL COORDINATE THE LOCATION OF THE WATER

12. ALL NEW UTILITY LINES (POWER, CABLE, ETC.) MUST BE

NORTH CAROLINA LAW REQUIRES NOTIFICATION OF THE UNDERGROUND FACILITY OWNER NOT LESS

24 X 36


1" = 40'

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8 FEBRUARY 2022 21-0337

UTILITY PLAN



INTERIOR LANDSCAPE ISLANDS REQUIRED =20/10 = 2 INTERIOR LANDSCAPE ISLANDS PROVIDED = 4 (WITH 4 TREES)

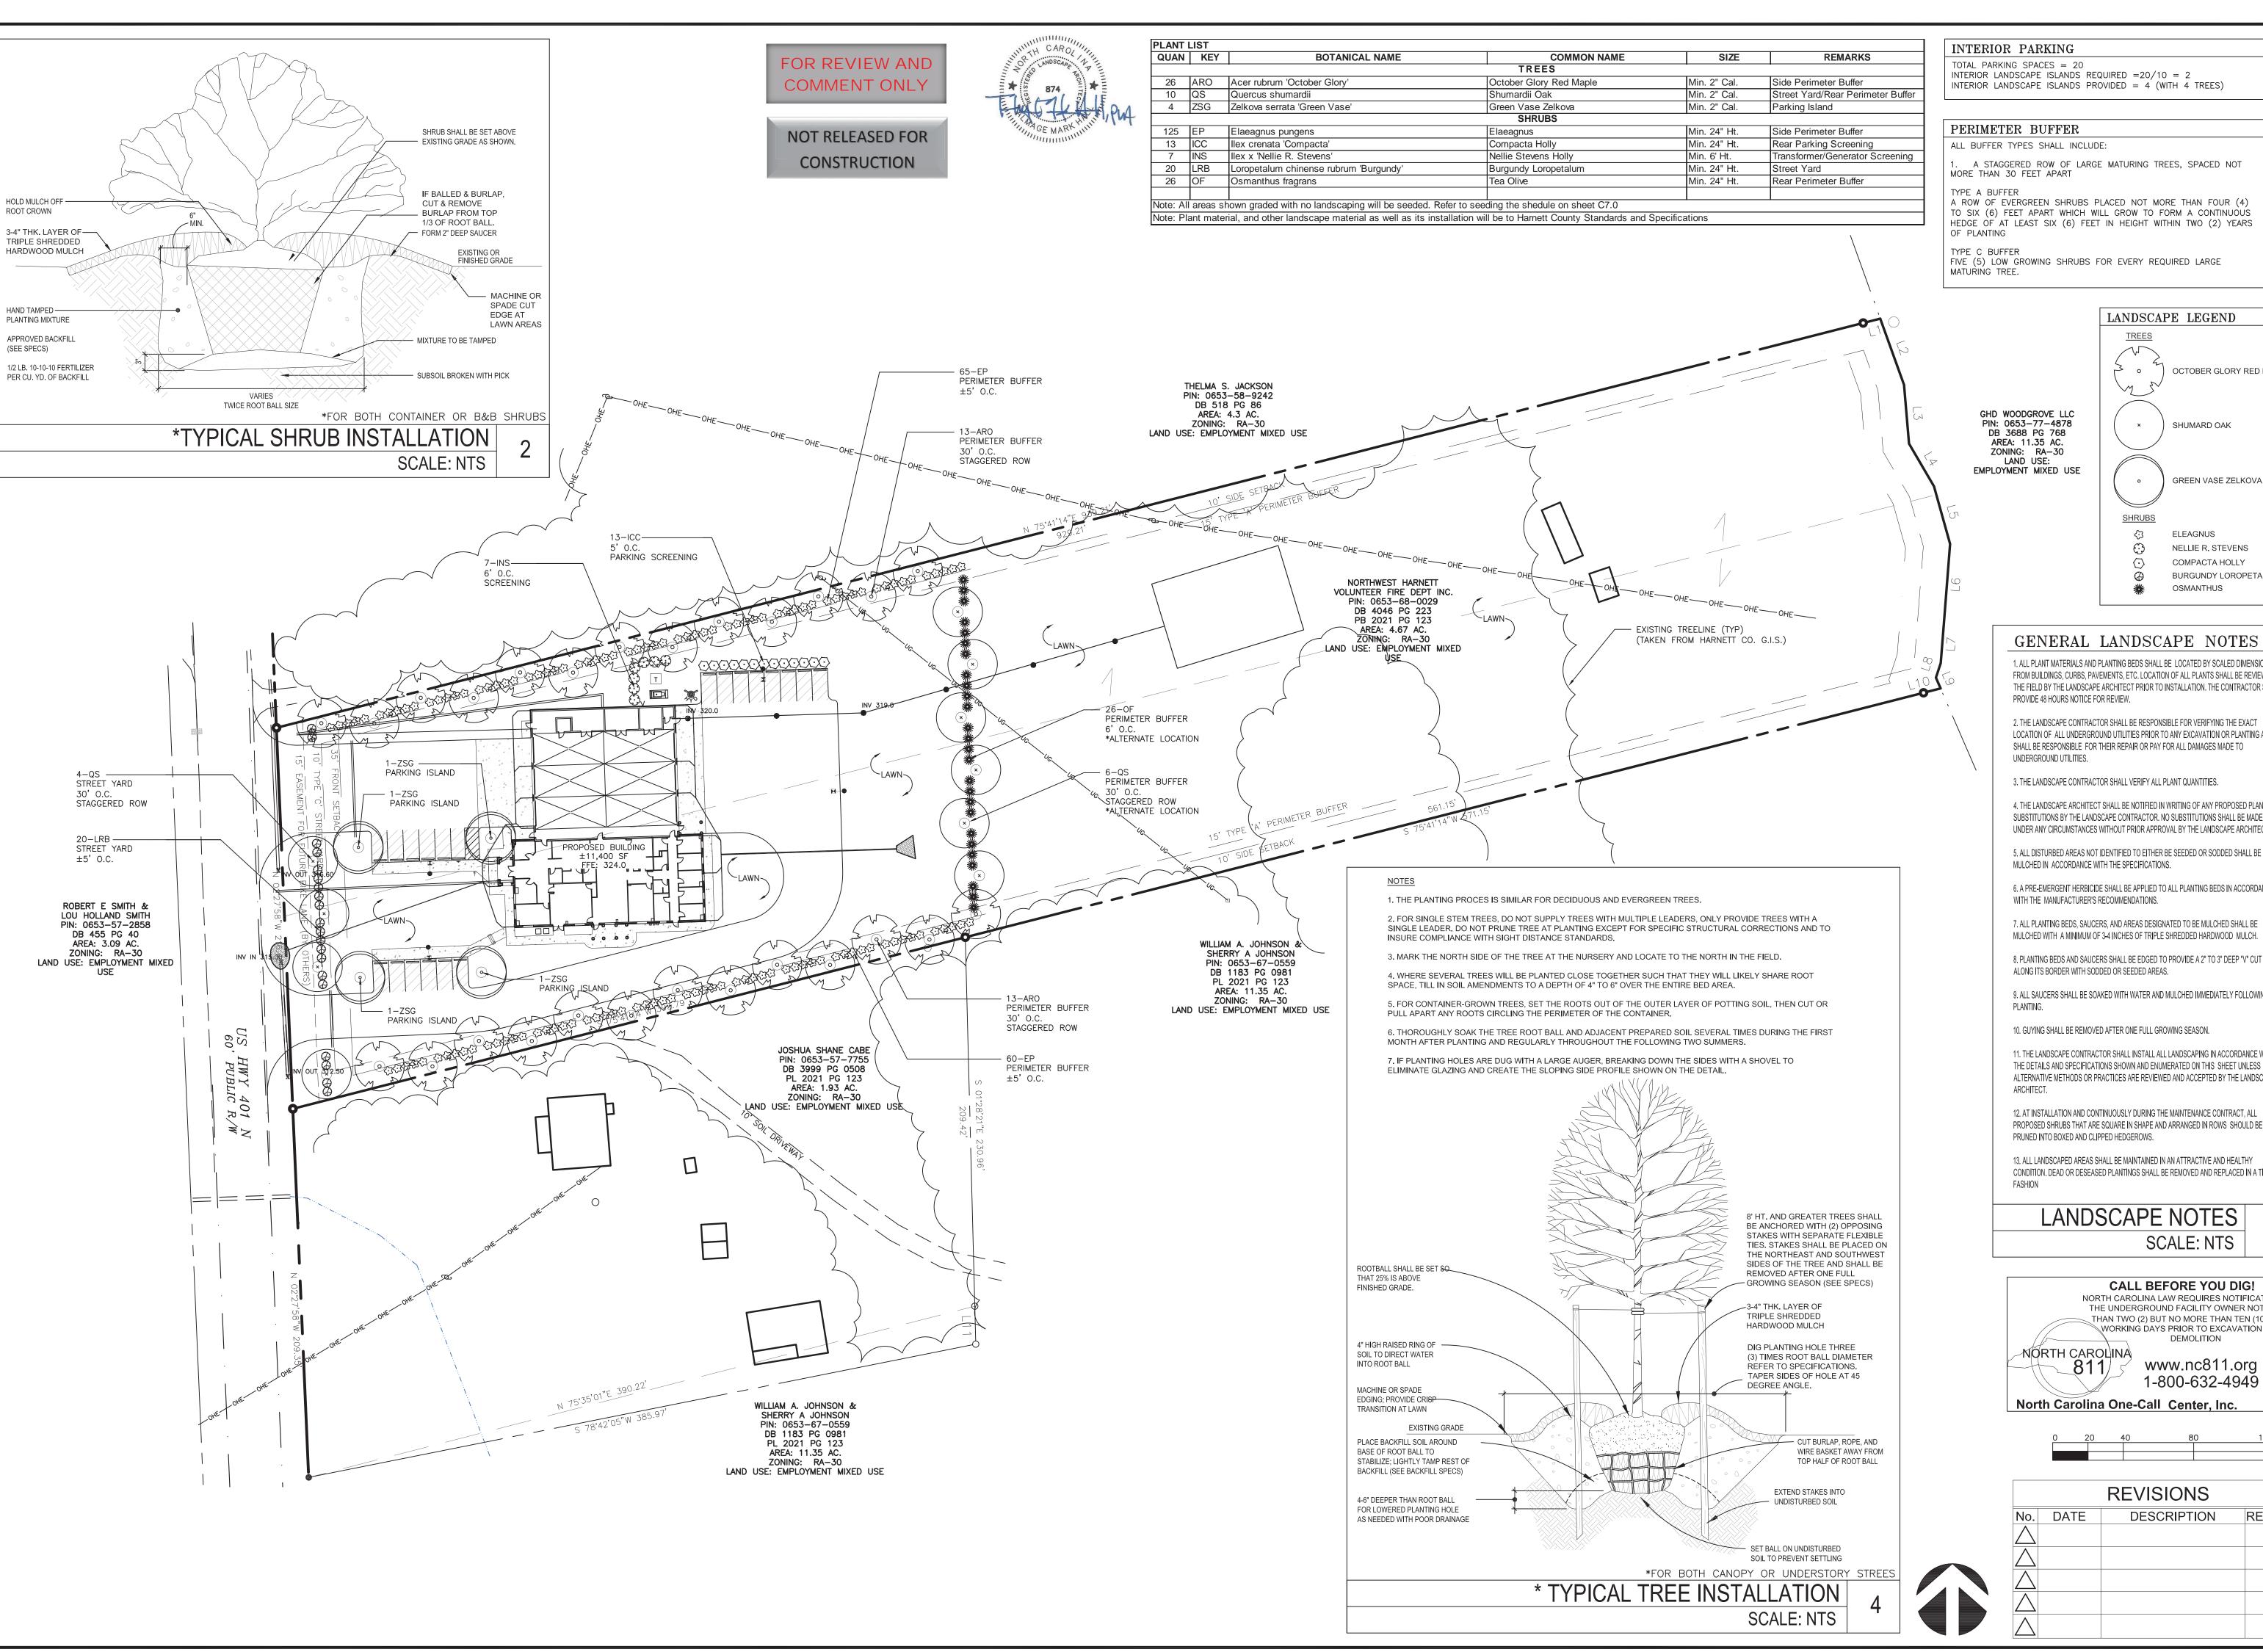
PERIMETER BUFFER

1. A STAGGERED ROW OF LARGE MATURING TREES, SPACED NOT MORE THAN 30 FEET APART

A ROW OF EVERGREEN SHRUBS PLACED NOT MORE THAN FOUR (4) TO SIX (6) FEET APART WHICH WILL GROW TO FORM A CONTINUOUS HEDGE OF AT LEAST SIX (6) FEET IN HEIGHT WITHIN TWO (2) YEARS

FIVE (5) LOW GROWING SHRUBS FOR EVERY REQUIRED LARGE

GHD WOODGROVE LLC PIN: 0653-77-4878 DB 3688 PG 768 AREA: 11.35 AC. ZONING: RA-30 EMPLOYMENT MIXED USE

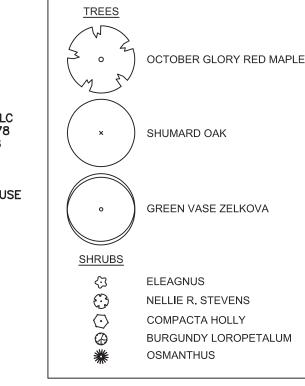

LANDSCAPE LEGEND

GENERAL LANDSCAPE NOTES

1. ALL PLANT MATERIALS AND PLANTING BEDS SHALL BE LOCATED BY SCALED DIMENSIONS FROM BUILDINGS, CURBS, PAVEMENTS, ETC. LOCATION OF ALL PLANTS SHALL BE REVIEWED IN THE FIELD BY THE LANDSCAPE ARCHITECT PRIOR TO INSTALLATION. THE CONTRACTOR SHALL PROVIDE 48 HOURS NOTICE FOR REVIEW.

2. THE LANDSCAPE CONTRACTOR SHALL BE RESPONSIBLE FOR VERIFYING THE EXACT LOCATION OF ALL UNDERGROUND UTILITIES PRIOR TO ANY EXCAVATION OR PLANTING AND SHALL BE RESPONSIBLE FOR THEIR REPAIR OR PAY FOR ALL DAMAGES MADE TO UNDERGROUND UTILITIES.

3. THE LANDSCAPE CONTRACTOR SHALL VERIFY ALL PLANT QUANTITIES.

4. THE LANDSCAPE ARCHITECT SHALL BE NOTIFIED IN WRITING OF ANY PROPOSED PLANT SUBSTITUTIONS BY THE LANDSCAPE CONTRACTOR. NO SUBSTITUTIONS SHALL BE MADE UNDER ANY CIRCUMSTANCES WITHOUT PRIOR APPROVAL BY THE LANDSCAPE ARCHITECT

5. ALL DISTURBED AREAS NOT IDENTIFIED TO EITHER BE SEEDED OR SODDED SHALL BE

6. A PRE-EMERGENT HERBICIDE SHALL BE APPLIED TO ALL PLANTING BEDS IN ACCORDANCE WITH THE MANUFACTURER'S RECOMMENDATIONS.

7. ALL PLANTING BEDS. SAUCERS. AND AREAS DESIGNATED TO BE MULCHED SHALL BE MULCHED WITH A MINIMUM OF 3-4 INCHES OF TRIPLE SHREDDED HARDWOOD MULCH.

ALONG ITS BORDER WITH SODDED OR SEEDED AREAS.

9. ALL SAUCERS SHALL BE SOAKED WITH WATER AND MULCHED IMMEDIATELY FOLLOWING

10. GUYING SHALL BE REMOVED AFTER ONE FULL GROWING SEASON.

11. THE LANDSCAPE CONTRACTOR SHALL INSTALL ALL LANDSCAPING IN ACCORDANCE WITH THE DETAILS AND SPECIFICATIONS SHOWN AND ENUMERATED ON THIS SHEET UNLESS ALTERNATIVE METHODS OR PRACTICES ARE REVIEWED AND ACCEPTED BY THE LANDSCAPE

12. AT INSTALLATION AND CONTINUOUSLY DURING THE MAINTENANCE CONTRACT, ALL PROPOSED SHRUBS THAT ARE SQUARE IN SHAPE AND ARRANGED IN ROWS SHOULD BE PRUNED INTO BOXED AND CLIPPED HEDGEROWS.

13. ALL LANDSCAPED AREAS SHALL BE MAINTAINED IN AN ATTRACTIVE AND HEALTHY CONDITION. DEAD OR DESEASED PLANTINGS SHALL BE REMOVED AND REPLACED IN A TIMELY


LANDSCAPE NOTES SCALE: NTS

CALL BEFORE YOU DIG! NORTH CAROLINA LAW REQUIRES NOTIFICATION OF THE UNDERGROUND FACILITY OWNER NOT LESS THAN TWO (2) BUT NO MORE THAN TEN (10) WORKING DAYS PRIOR TO EXCAVATION OR DEMOLITION

-MÖRTH CAROLINA

www.nc811.org 1-800-632-4949

North Carolina One-Call Center, Inc

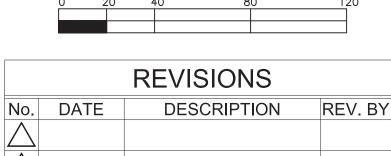

INO.	DAIL	DESCRIPTION	INL V. DI

TALMAGE "MARK" HALL, PLA PROFESSIONAL LANDSCAPE ARCHITEC

COORDINATOR: Blair Pittman DRAWN BY


Talmage Mark Hal

CHK BY:BPP

24 X 36 1" = 40'

9 FEBRUARY 2022

21-0337 LANDSCAPE PLAN

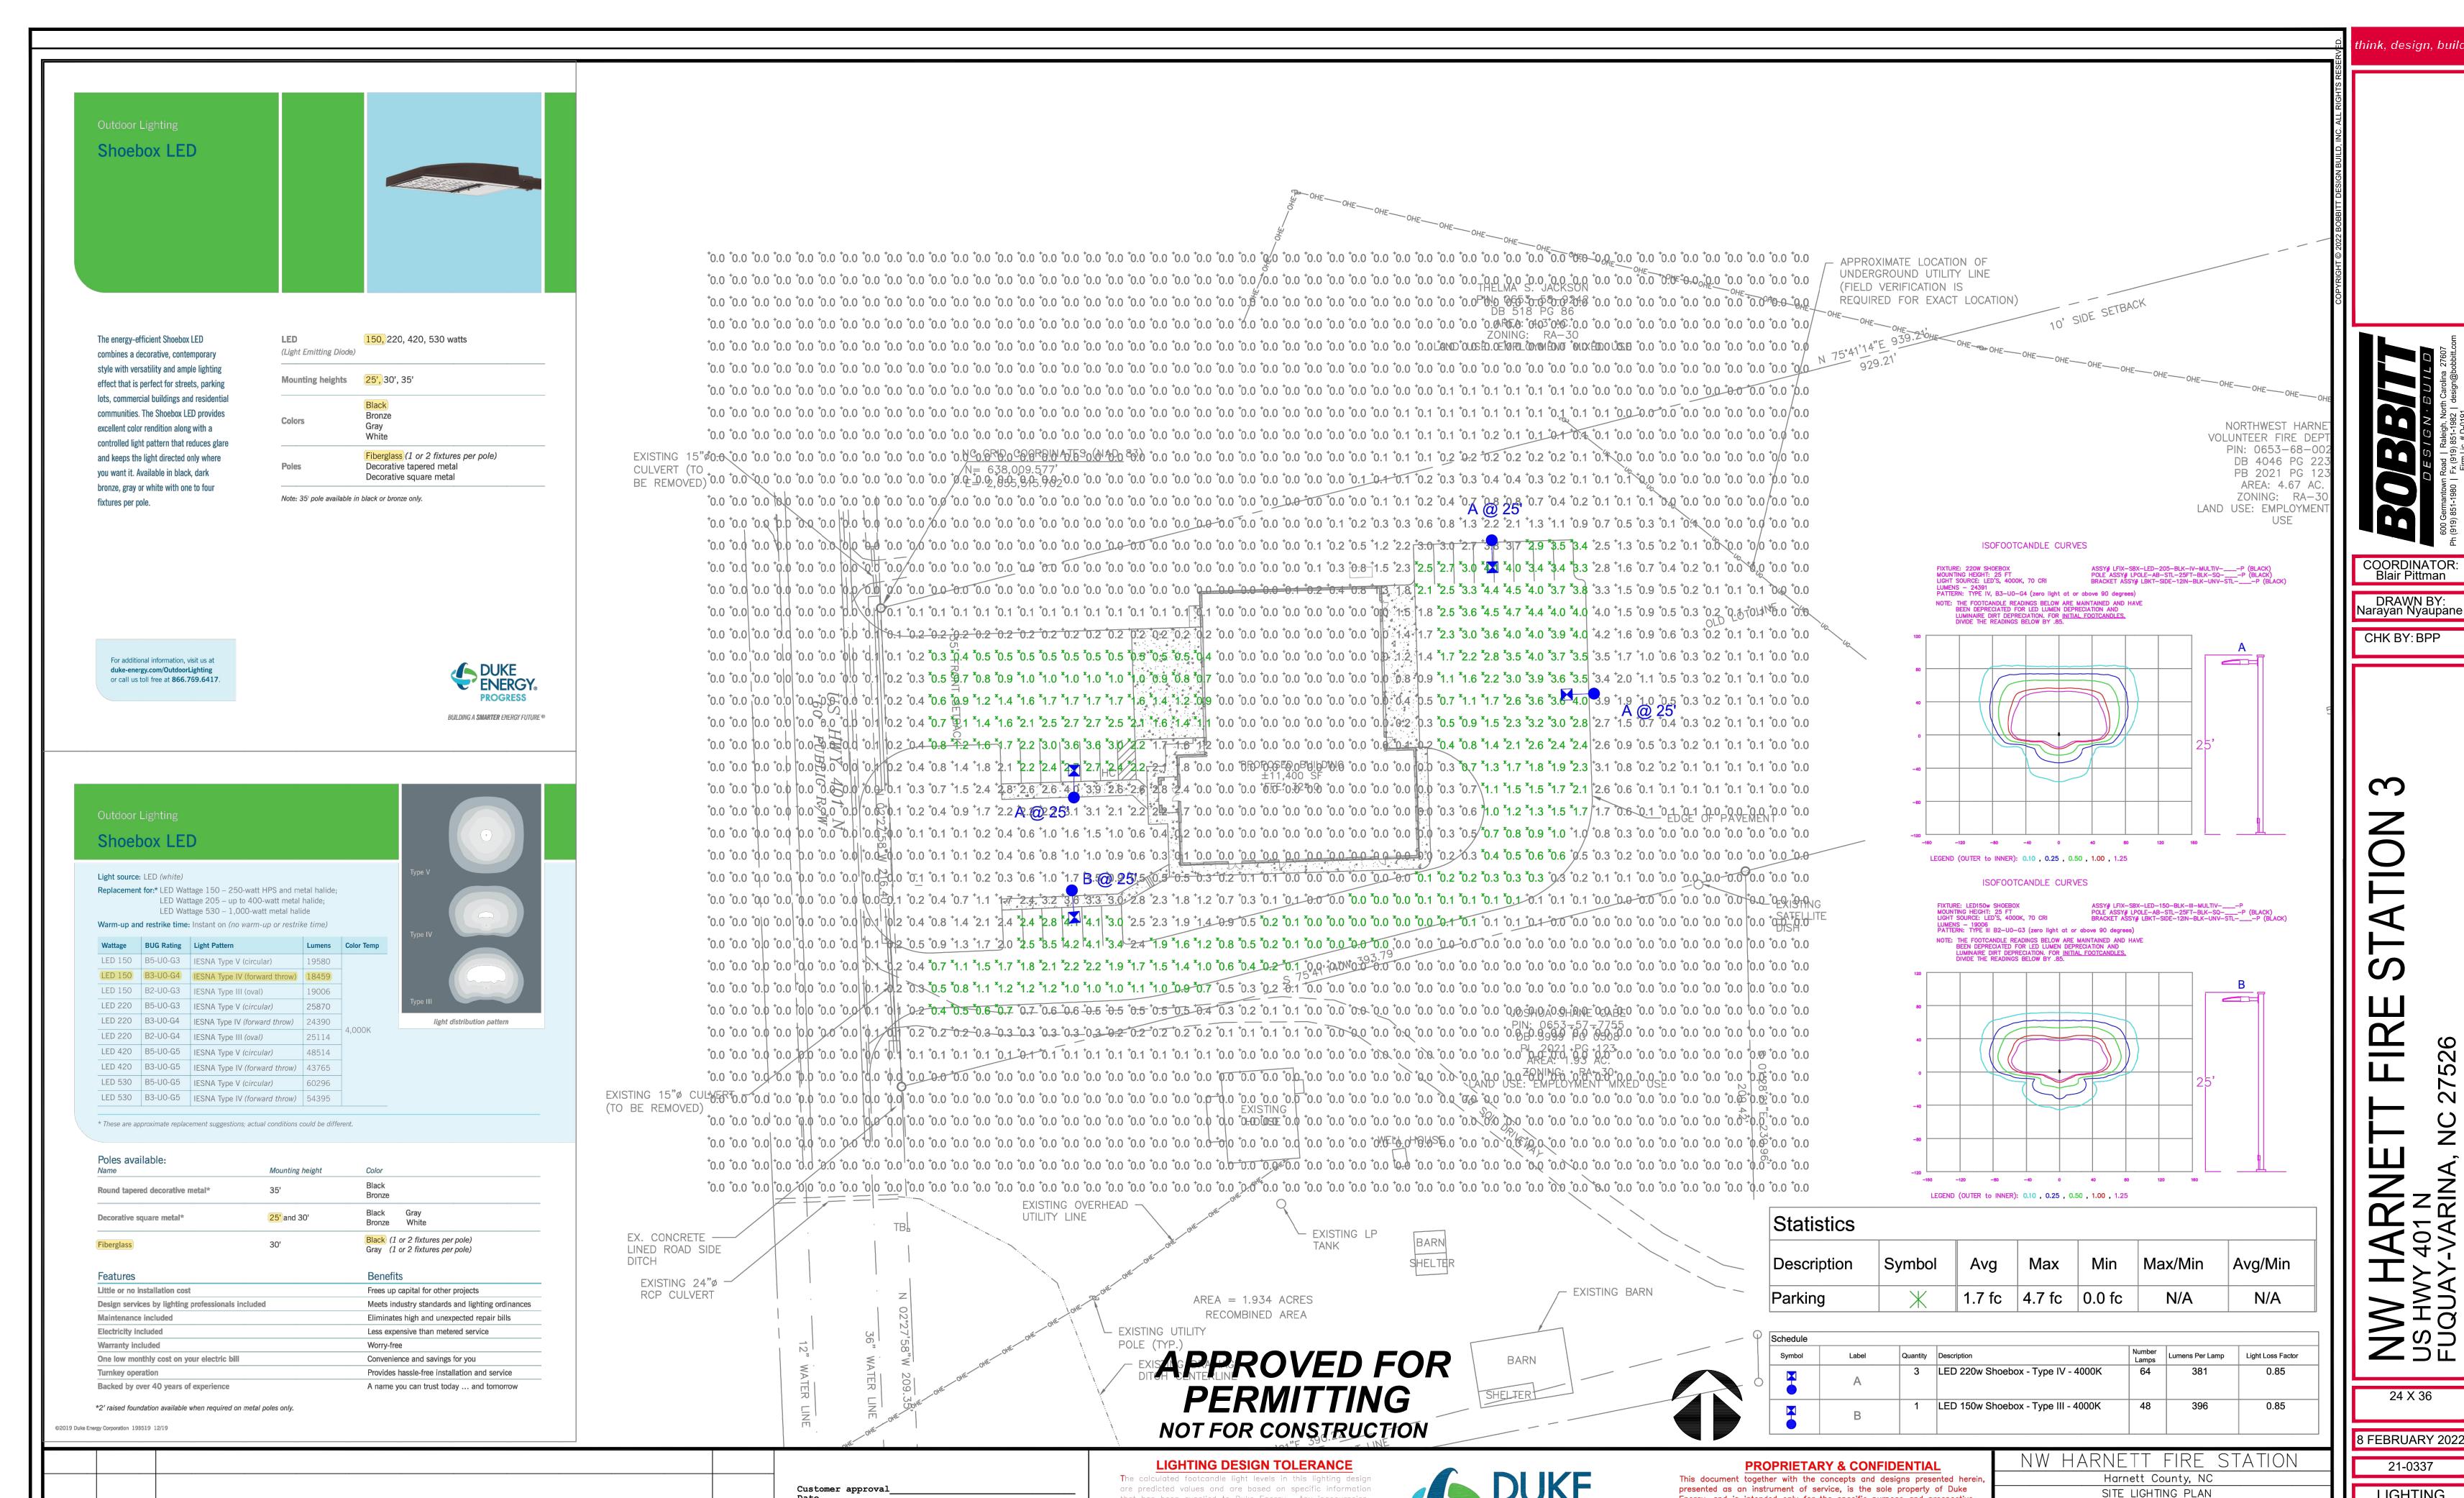

that has been supplied to Duke Energy. Any inaccuracies

DISTANCE CALIBRATION (INCHES)

NJ

BY

01/06/22 | LED Shoebox - Black

REV# DATE

REVISION

in the supplied information, differences in luminaire installation

otherwise) in the lighted area, or lighting from sources other

than listed in this design may produce different results from

output, and ballast and luminaire manufacture will also affect

the predicted values. Normal tolerances of voltage, lamp

lighted area geometry including elevation differences, reflective

2

nink, design, build

24 X 36

8 FEBRUARY 2022 21-0337

LIGHTING PLAN

Energy, and is intended only for the specific purpose and prospective

contained herein by the prospective customer or other entities, includi

without limitation, architects, engineers, or equipment manufacturers is

hereby expressly prohibited and shall not be permitted absent prior

written consent from, and payment of compensation to Duke Energy.

Duke Energy disclaims any liability or responsibility for any

unauthorized use of or reliance on this document.

PROGRESS

client as stated in the title block of this drawing. Any use, copying, reproduction or disclosure of the drawing, design or any information

Designed by DEP LIGHTING SOLUTIONS

Description LED 150w & 220w Shoebox

22-0004A

Reviewed by

Date <u>01/06/2022</u>

T. Ferguson Scale 1" = 30'

_Size <u>"Arch D"</u>

___ Sht. <u>1 OF</u>

SECTION 'A-A'

PIPE OUTLET TO WELL-DEFINED CHANNEL

N.T.S.

SILT FENCE OUTLET

MAINTENANCE

MAINTENANCE

MAINTENANCE

MAINTENANCE

COORDINATOR: Blair Pittman

hink, design, build

DRAWN BY: Narayan Nyaupane

CHK BY: BPP

2 2 2

24 X 36

8 FEBRUARY 2022 21-0337

REVISIONS

DESCRIPTION

REV. BY


No. DATE

APPROVED FOR

PERMITTING

NOT FOR CONSTRUCTION

DETAILS

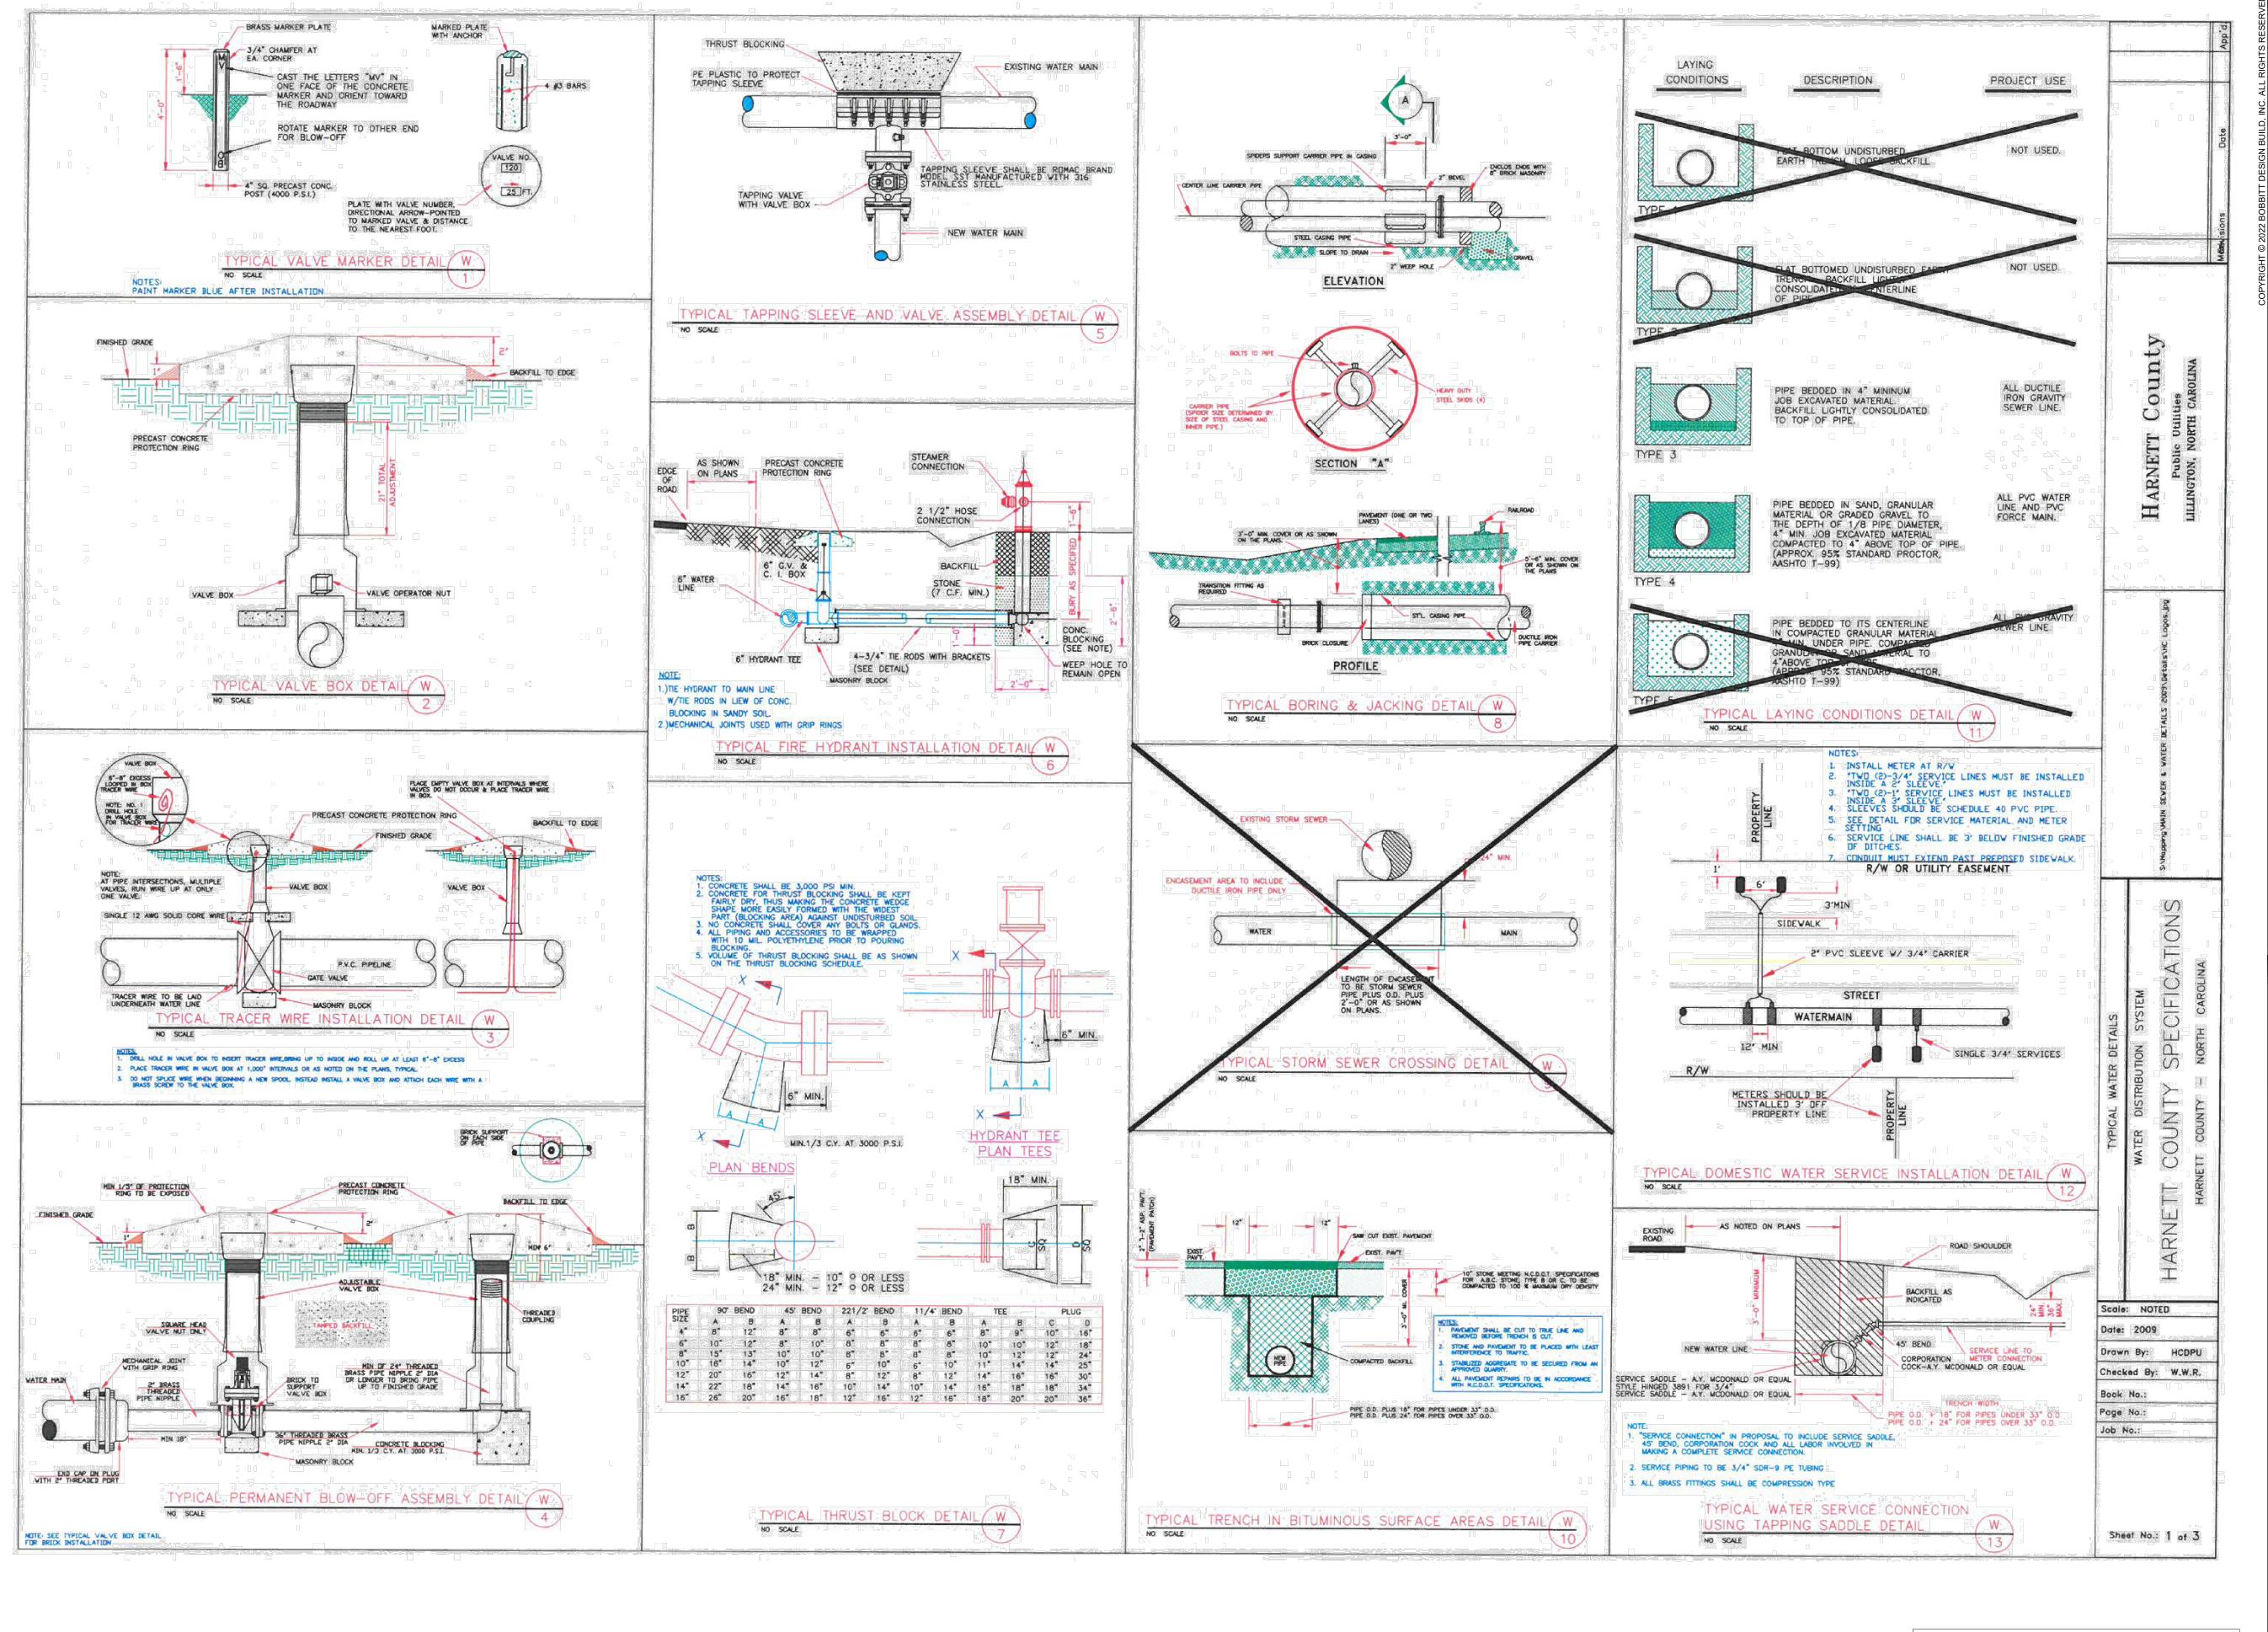





REVISIONS				
No.	DATE	DESCRIPTION	REV. BY	
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COORDINATOR: Blair Pittman DRAWN BY: Narayan Nyaupane


CHK BY: BPP


27526

24 X 36

8 FEBRUARY 2022 21-0337

DETAILS

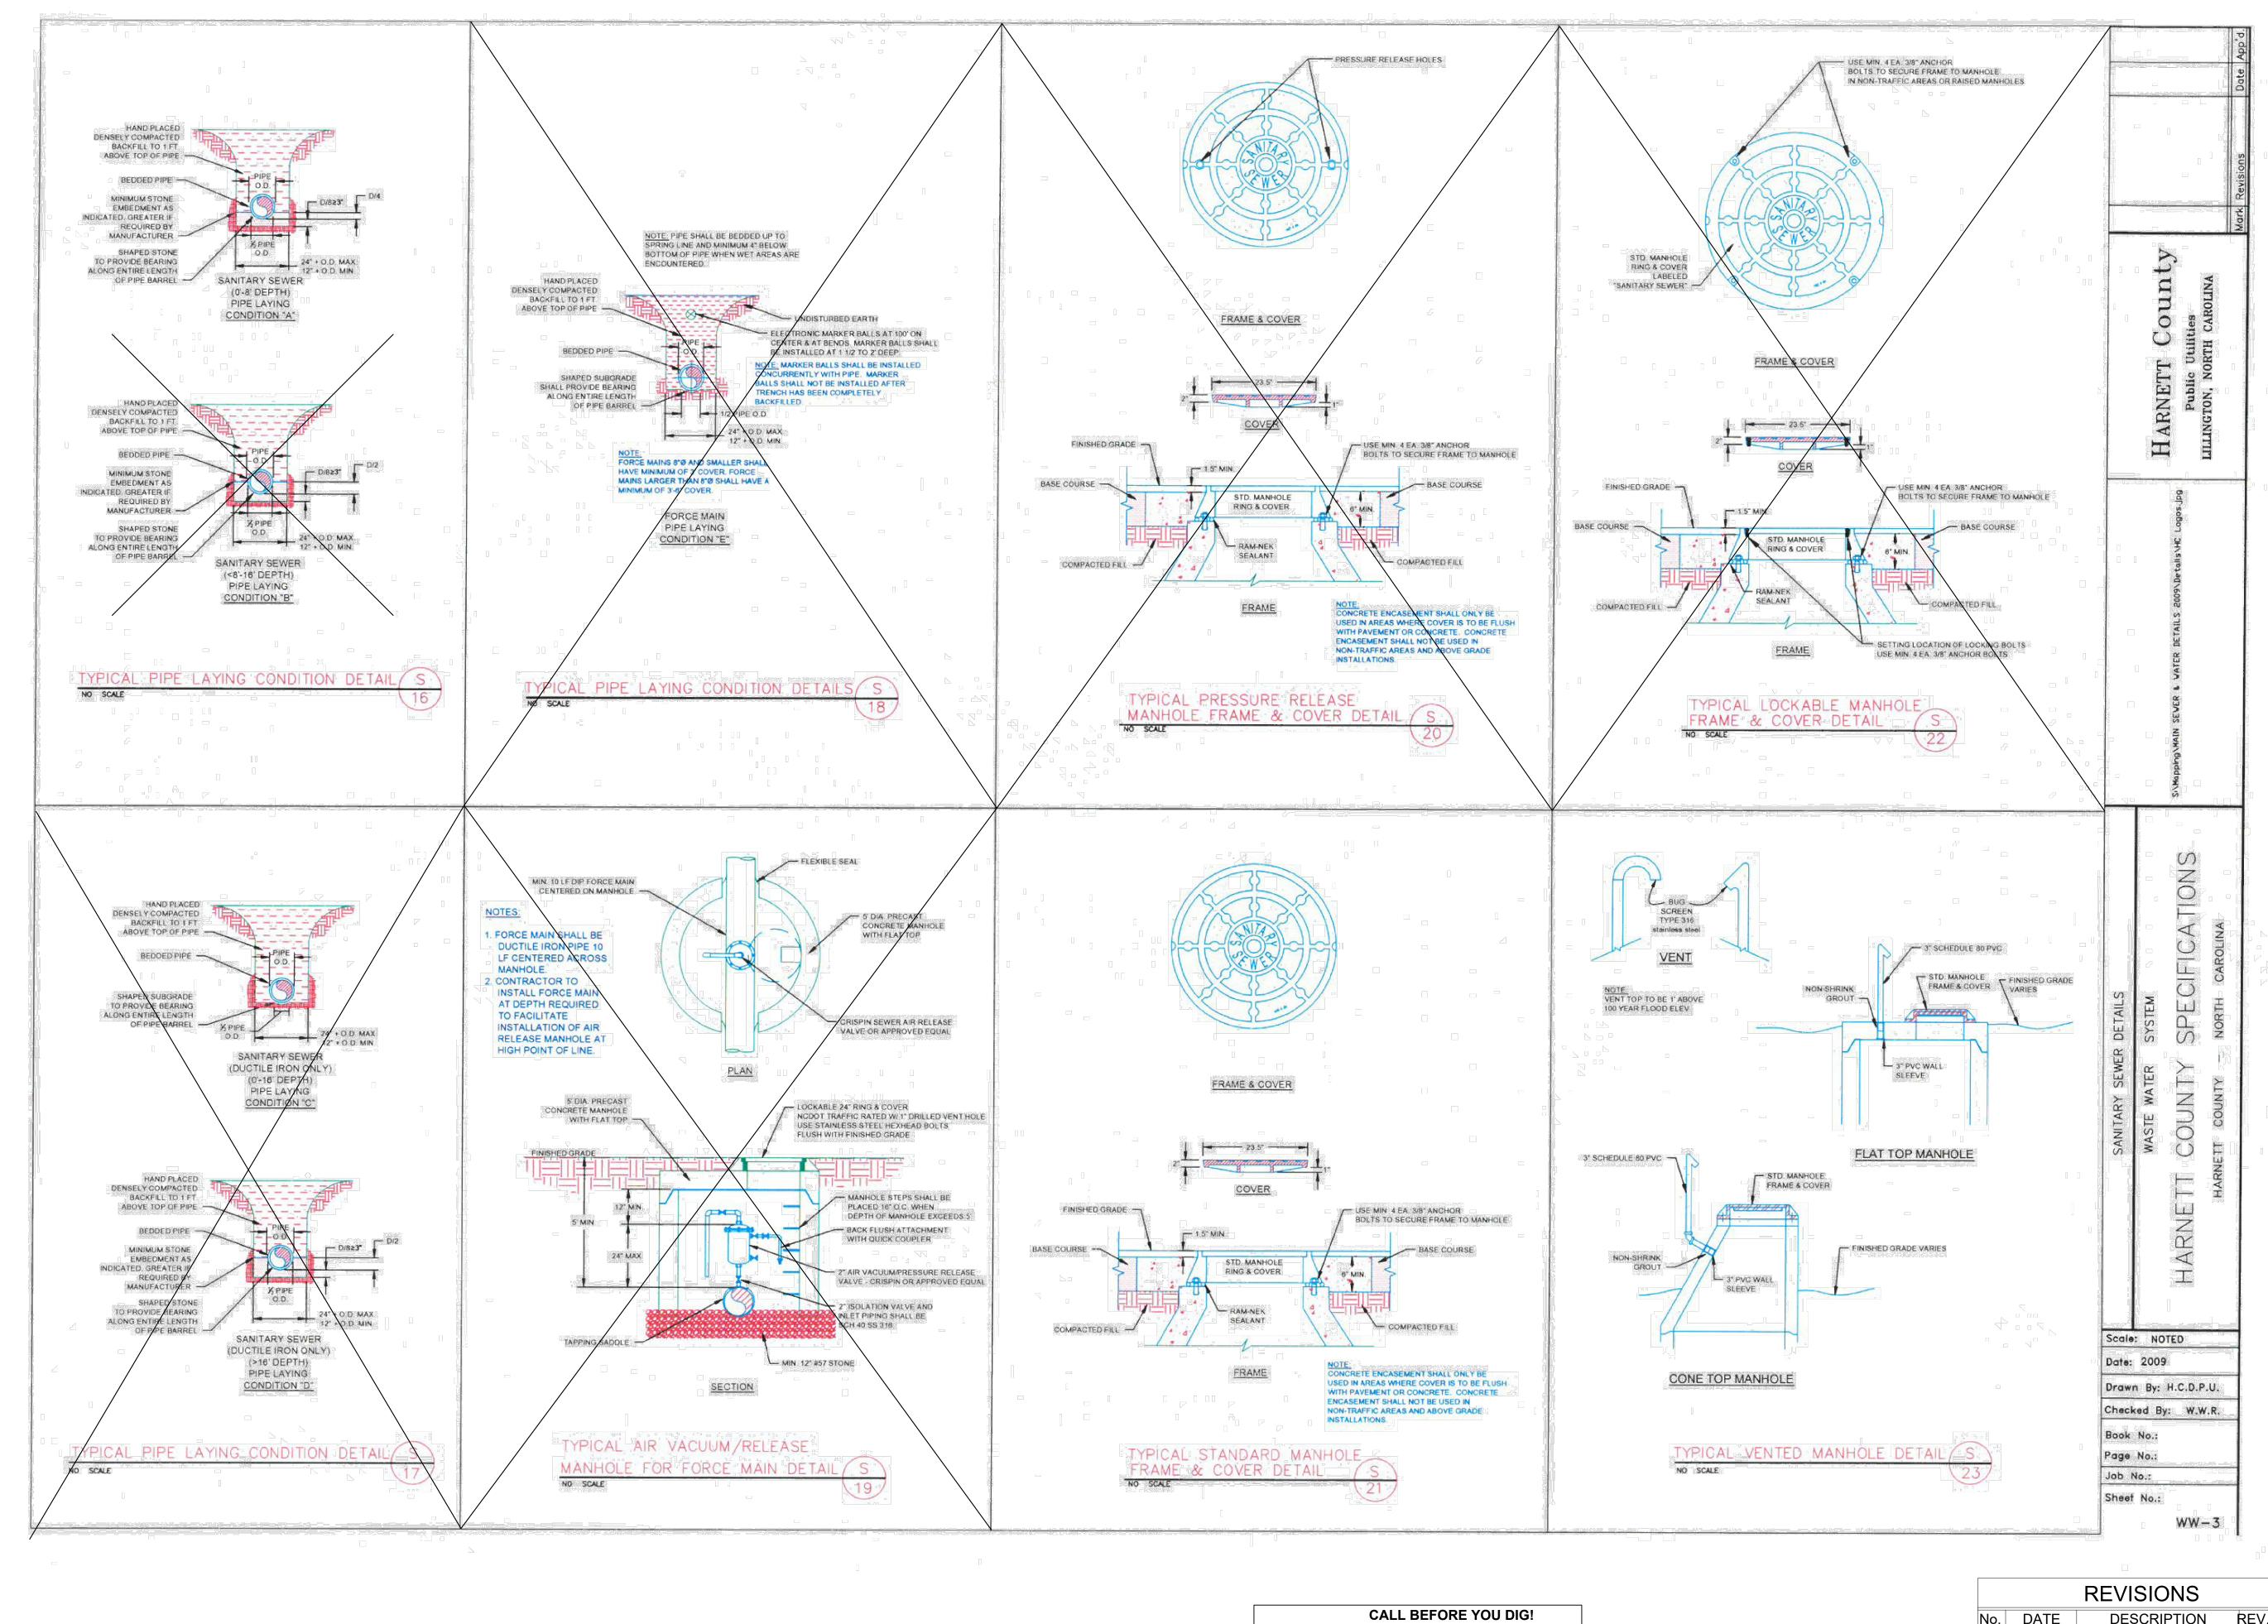

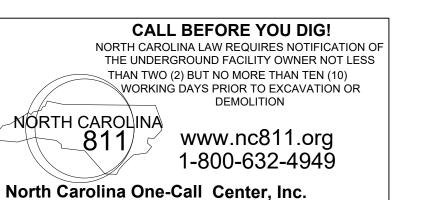

APPROVED FOR **PERMITTING NOT FOR CONSTRUCTION**

REVISIONS				
DATE	DESCRIPTION	REV. BY		
	DATE			

think, design, build

COORDINATOR: Blair Pittman DRAWN BY: Narayan Nyaupane

CHK BY: BPP

27526

24 X 36

8 FEBRUARY 2022 21-0337 DETAILS