

2018 APPENDIX B BUILDING CODE SUMMARY

Name of Project: Word Afire Ministries
 Address: 1503 Denim Road Erwin, NC Zip Code: 28339
 Proposed Use: Church
 Owner or Authorized Agent: Vivian Cogdell Phone # E-Mail:
 Owned By: City/County Private State
 Code Enforcement Jurisdiction: City County Harnett State

LEAD DESIGNER PROFESSIONAL: Joe T. Smith, Jr.

| DESIGNER FIRM | NAME | LICENSE # | TELEPHONE # | E-MAIL |
|--------------------------|----------------------------|-------------------|----------------------|--------------------------------|
| Building | Smith Engineering & Design | Joe T. Smith, Jr. | 24916 (919)-736-2141 | smithengineeringnc@hotmail.com |
| Civil | | | | |
| Electrical | | | | |
| Fire Alarm | | | | |
| Plumbing | | | | |
| Mechanical | | | | |
| Sprinkler-Standpipe | | | | |
| Structural | | | | |
| Retaining Walls >5' High | | | | |
| Other | | | | |

2018 NC BUILDING CODE: New Construction Shell/Core 1st Time Interior Completion
 Addition Phased Construction-Shell Core
2018 NC EXISTING CODE: Prescriptive Alteration Level I Historic Property
 Repair Alteration Level II Change of Use
 Chapter 14 Alteration Level III

CONSTRUCTED: (date) _____ **CURRENT USE(s)** (Ch. 3) _____ **R**
RENOVATED: (date) _____ **PROPOSED USE(s)** (Ch. 3) _____ **A-3**

BUILDING DATA

Construction Type: I-A II-A III-A IV V-A
 I-B II-B III-B V-B

Sprinklers: NO Partial NFPA 13 NFPA 13R NFPA 13D

Standpipes: NO Class: I II III Wet Dry

Primary Fire District: NO YES (Primary) **Flood Hazard Area:** No YES

Special Inspections Required: NO YES

GROSS BUILDING AREA TABLE

| FLOOR | EXISTING (SQ. FT.) | NEW (SQ. FT.) | SUB-TOTAL |
|-------------------------|--------------------|---------------|--------------|
| 3rd Floor | | | |
| 2nd Floor | | | |
| Mezzanine | | | |
| 1st Floor (Upper Level) | 6,500 | 0 | 6,500 |
| Basement (Lower Level) | | | |
| TOTAL: | 6,500 | 0 | 6,500 |

ALLOWABLE AREA THIS TENANT SPACE = 3,381 SQ.FT.

Primary Occupancy: A-1 A-2 A-3 A-4 A-5
 Business Educational Factory F-1 Moderate F-2 Low Hazardous H-1 Detonate H-2 Deflagrate H-3 Combust H-4 Health H-5 HMP Institutional I-1 I-2 I-3 I-4 I-3 Condition 1 2 I-2 Condition 1 2 I-1 Condition 1 2 3 4 5

Mercantile Residential R-1 R-2 R-3 R-4 Storage S-1 Moderate S-2 Low High-Piled Parking Garage Open Enclosed Repair Garage Utility and Misc.

Accessory Occupancy Classification(s): _____
Incidental Uses: (Table 509) _____
 This separation is not exempt as a Nonseparated Use (see exceptions).
Special Uses: (Chapter 4 - List Code Sections): _____
Special Provisions: (Chapter 5 - List Code Sections): _____

Mixed Occupancy: NO YES Secondary occupancy type(s): **B** Separation: **0** Hour Exception: **508.3**
 Non-Separated Use (508.3)
 The required type of construction for the building shall be determined by applying the height and area limitations for each of the applicable occupancies to the entire building. The most restrictive type of construction, so determined, shall apply to the entire building.
 Separated Use (508.4) See below for area calculations for each story, the area of the occupancy shall be such that the sum of the ratios of the actual floor area of each use divided by the allowable floor area for each use shall not exceed 1.

$$\frac{\text{Actual Area of Occupancy A}}{\text{Allowable Area of Occupancy A}} + \frac{\text{Actual Area of Occupancy B}}{\text{Allowable Area of Occupancy B}} \leq 1.0$$

$$\frac{N/A}{N/A} + \frac{N/A}{N/A} = N/A \leq 1.0$$

| STORY NO. | DESCRIPTION AND USE | (A) BLDG AREA PER STORY (ACTUAL) | (B) TABLE 506.2 AREA | (C) AREA FOR FRONTAGE INCREASE ^{1,5} | (D) ALLOWABLE AREA PER STORY OR UNLIMITED ^{2,3} |
|-----------|---------------------|----------------------------------|----------------------|---|--|
| 1 | Church | 6,500 | 6,000 | 4,500 | 10,500 |

¹Frontage area increases from Section 506.2 are computed thus:
 a. Perimeter which fronts a public way or open space having 20 feet minimum width = 360' (P)
 b. Total Building Perimeter = 360' (P)
 c. Ratio (P/P) = 1 (P/P)
 d. W = Minimum width of public way = 30' (W)
 e. Percent of frontage increase $\frac{1}{4} = 100 [(P/P - 0.25) \times W/30] = 75\%$ (%)

²Unlimited area applicable under conditions of Section 507.
³Maximum Building Area = total number of stories in the building x D (maximum 3 stories) (506.2).
⁴The maximum area of parking garages must comply with 406.5.4. The maximum area of air traffic control towers must comply with Table 412.3.1.
⁵Frontage increase is based on the un-sprinklered area value in Table 506.2.

ALLOWABLE HEIGHT

| | ALLOWABLE | SHOWN ON PLANS | CODE REFERENCE |
|--|-----------|----------------|----------------|
| Building Height in Feet (Table 504.3) | 40'-0" | 16'-0" | |
| Building Height in Stories (Table 504.4) | 1 | 1 | |

1. Provide code reference if the "Shown on Plans" quantity is not based on Table 504.3 or 504.4.

FIRE PROTECTION REQUIREMENTS

| BUILDING ELEMENT | FIRE SEPARATION DISTANCE (FEET) | RATING | | DETAIL # AND SHEET # | DESIGN # FOR RATED ASSEMBLY | DESIGN # FOR RATED PENETRATION | DESIGN # FOR RATED JOINTS |
|--|---------------------------------|----------|-------------------------------|----------------------|-----------------------------|--------------------------------|---------------------------|
| | | REQUIRED | PROVIDED (W/ N/A * REDUCTION) | | | | |
| Structural frame, including columns, girders, trusses | 0 HOUR | 0 HOUR | 0 HOUR | | | | |
| Bearing walls | | | | | | | |
| Exterior | | | | | | | |
| North | N/A | 0 HOUR | N/A | | | | |
| East | N/A | 0 HOUR | N/A | | | | |
| West | N/A | 0 HOUR | N/A | | | | |
| South | N/A | 0 HOUR | N/A | | | | |
| Interior | 0 HOUR | 0 HOUR | 0 HOUR | | | | |
| Nonbearing walls and partitions | | | | | | | |
| Exterior | | | | | | | |
| North | >30' | 0 HOUR | 0 HOUR | | | | |
| East | >30' | 0 HOUR | 0 HOUR | | | | |
| West | >30' | 0 HOUR | 0 HOUR | | | | |
| South | >30' | 0 HOUR | 0 HOUR | | | | |
| Interior walls and partitions | 0 HOUR | 0 HOUR | 0 HOUR | | | | |
| Floor Construction including supporting beams and joists | 0 HOUR | 0 HOUR | 0 HOUR | | | | |
| Roof Construction including supporting beams and joists | 0 HOUR | 0 HOUR | 0 HOUR | | | | |
| Roof Ceiling Assembly | N/A | N/A | N/A | | | | |
| Columns Supporting Roof | 0 HOUR | 0 HOUR | 0 HOUR | | | | |
| Shafts Enclosures - Exit | N/A | N/A | N/A | | | | |
| Shafts Enclosures - Other | N/A | N/A | N/A | | | | |
| Corridor Separation | 0 HOUR | 0 HOUR | 0 HOUR | | | | |
| Occupancy/Fire Barrier Separation | 0 HOUR | 0 HOUR | 0 HOUR | | | | |
| Party/Fire Wall Separation | N/A | N/A | N/A | | | | |
| Smoke Barrier Separation | N/A | N/A | N/A | | | | |
| Smoke Partition | N/A | N/A | N/A | | | | |
| Tenant/Dwelling Unit/ Sleeping Unit Separation | N/A | N/A | N/A | | | | |
| Incidental Use Separation | N/A | N/A | N/A | | | | |

PERCENTAGE OF WALL OPENING CALCULATIONS

| FIRE SEPARATION DISTANCE (feet) FROM PROPERTY LINES | DEGREE OF OPENINGS PROTECTION (TABLE 705.8) | ALLOWABLE AREA (%) | ACTUAL SHOWN ON PLANS (%) |
|---|---|--------------------|---------------------------|
| >30' | Unprotected, Non-sprinklered | No Limit | <50% |

LIFE SAFETY SYSTEM REQUIREMENTS

Emergency Lighting: No Yes
 Exit Signs: No Yes
 Fire Alarm: No Yes
 Smoke Detection Systems: No Yes
 Carbon Monoxide Detection: No Yes

LIFE SAFETY PLAN REQUIREMENTS

Life Safety Plan Sheet #: LF-1

- Fire and/or smoke rated wall locations (Chapter 7)
- Assumed and real property line locations
- Exterior wall opening area with respect to distance to assumed property lines (705.8)
- Occupancy Use for each area as it relates to occupant load calculation (Table 1004.1.2)
- Occupant loads for each area
- Exit access travel distances (1017)
- Common path of travel distances [Tables 1006.2.1 & 1006.3.2(1)]
- Dead end lengths (1020.4)
- Clear exit widths for each exit door
- Maximum calculated occupant load capacity each exit door can accommodate based on egress width (1005.3)
- Actual occupant load for each exit door
- A separate schematic plan indicating where fire rated floor/ceiling and/or roof structure is provided for purposes of occupancy separation
- Location of doors with panic hardware (1010.1.10)
- Location of doors with delayed egress locks and the amount of delay (1010.1.9.7)
- Location of doors with electromagnetic egress locks (1010.1.9.9)
- Location of doors equipped with hold-open devices
- Location of emergency escape windows (1030)
- The square footage of each fire area (202)
- The square footage of each smoke compartment for Occupancy Classification I-2 (407.5)
- Note any code exceptions or table notes that may have been utilized regarding the items above

ACCESSIBLE DWELLING UNITS (SECTION 1107)

| TOTAL UNITS | ACCESSIBLE UNITS REQUIRED | ACCESSIBLE UNITS PROVIDED | TYPE A UNITS REQUIRED | TYPE A UNITS PROVIDED | TYPE B UNITS REQUIRED | TYPE B UNITS PROVIDED | TOTAL ACCESSIBLE UNITS PROVIDED |
|-------------|---------------------------|---------------------------|-----------------------|-----------------------|-----------------------|-----------------------|---------------------------------|
| N/A | | | | | | | |

ACCESSIBLE PARKING (SECTION 1106)

| LOT OR PARKING AREA | TOTAL # PARKING SPACES | | # ACCESSIBLE SPACES PROVIDED | | | TOTAL # ACCESSIBLE SPACES PROVIDED |
|---------------------|------------------------|----------|------------------------------|-------------------|----------------|------------------------------------|
| | REQUIRED | PROVIDED | REGULAR WITH 5' ACCESS AISLE | 132" ACCESS AISLE | # ACCESS AISLE | |
| Existing | | | | | | |
| TOTAL | | | | | | |

PLUMBING FIXTURE REQUIREMENTS (TABLE 2902.1)

| USE | WATER CLOSETS | | | URINALS | LAVATORIES | | | UTILITY SINK | DRINKING FOUNTAINS | |
|-----------------|---------------|----------|----------|----------|------------|----------|----------|--------------|--------------------|------------|
| | MALE | FEMALE | UNISEX | | MALE | FEMALE | UNISEX | | REGULAR | ACCESSIBLE |
| EXISTING | 0 | 0 | 0 | 0 | 0 | 0 | 0 | 0 | 0 | 0 |
| NEW | 1 | 4 | 0 | 1 | 2 | 2 | 0 | 0 | 1 | 1 |
| REQUIRED | 1 | 2 | 0 | 0 | 1 | 1 | 0 | 0 | 1 | 1 |

SPECIAL APPROVALS

Special approval: (Local Jurisdiction, Department of Insurance, OSC, DPI, DHHS, ICC, etc., describe below)

STRUCTURAL DESIGN

DESIGN LOADS: Existing Building

Importance Factor: Snow (I_s) _____
 Seismic (I_e) _____

Live Loads: Roof _____
 Mezzanine _____
 Floor _____

Ground Snow Load: _____
 Wind Loads: Basic Wind Speed _____
 Exposure Category _____

SEISMIC CATEGORY A B C D

Provide the following Seismic Design Parameters:
 Occupancy Category (Table 1604.5) I II III IV
 Spectral Response Acceleration S_s _____ %g S₁ _____ %g
 Site Classification (ASCE-7) A B C D E F
 Data source: Field Test Presumptive Historical Data

Basic Structural System: (check one)
 Bearing Wall Dual W/ Special Moment Frame
 Building Frame Dual W/ Intermediate R/C or Special Steel
 Moment Frame Inverted Pendulum

Analysis Procedure: Simplified Equivalent Lateral Force Dynamic
 Architectural, Mechanical, Components Anchored? Yes No

LATERAL DESIGN CONTROL: Earthquake Wind

SOIL BEARING CAPACITIES:
 Field Test (provide copy of test report) _____ psf
 Presumptive Bearing Capacity _____ psf
 Pile Size, Type, and Capacity _____

SPECIAL INSPECTIONS REQUIRED: Yes No

ENERGY SUMMARY

ENERGY REQUIREMENTS:
 The following data shall be considered minimum and any special attribute required to meet the energy code shall also be provided. Each Designer shall furnish the required portions of the project information for the plan data sheet. If performance method, state the annual energy cost for the standard reference design vs annual energy cost for the proposed design.

Existing building envelope complies with code: (If checked, the remainder of this section is not applicable.)
Exempt Building: Provide code or statutory reference: _____
Climate Zone: 3 4 5
Method of Compliance:
 Energy Code: Performance Prescriptive Trade-Off
 ASHRAE 90.1: Performance Prescriptive Trade-Off
 Other: Performance (specify source) _____

THERMAL ENVELOPE:

Roof/Ceiling Assembly (each assembly)
 Description of Assembly _____
 U-value of Total Assembly _____
 R-value of Insulation _____
 Skylights in each assembly _____
 U-Value of skylight _____
 Total square footage of skylights in each assembly _____

Exterior Walls (each assembly)
 Description of Assembly _____
 U-value of Total Assembly _____
 R-value of Insulation _____
 Openings (windows or doors with glazing) _____
 U-Value of assembly _____
 Solar heat gain coefficient: _____
 Projection factor: _____
 Door R-Value: _____

Walls below grade (each assembly)
 Description of Assembly _____
 U-value of Total Assembly _____
 R-value of Insulation _____


Floors over unconditioned space (each assembly)
 Description of Assembly _____
 U-value of Total Assembly _____
 R-value of Insulation _____

Floors slab on grade
 Description of Assembly _____
 U-value of Total Assembly _____
 R-value of Insulation _____
 Horizontal/vertical requirement _____
 Slab heated _____



Rev1. See notes on life safety plan


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REVISIONS
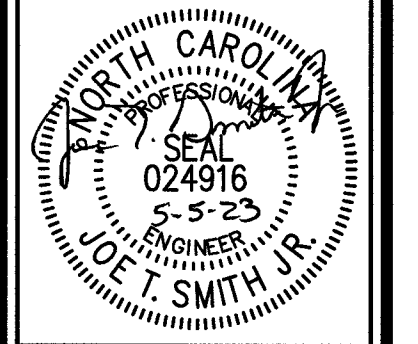
| REV# | DATE | DESCRIPTION |
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 1503 Denim Road
 Erwin, NC 28339




1
G-2
FLOOR PLAN
SCALE: 1/4"=1'-0"

WALL LEGEND:
 NEW 2" X 4" WALLS WITH 5/8" PAINTED GWB BOTH SIDES
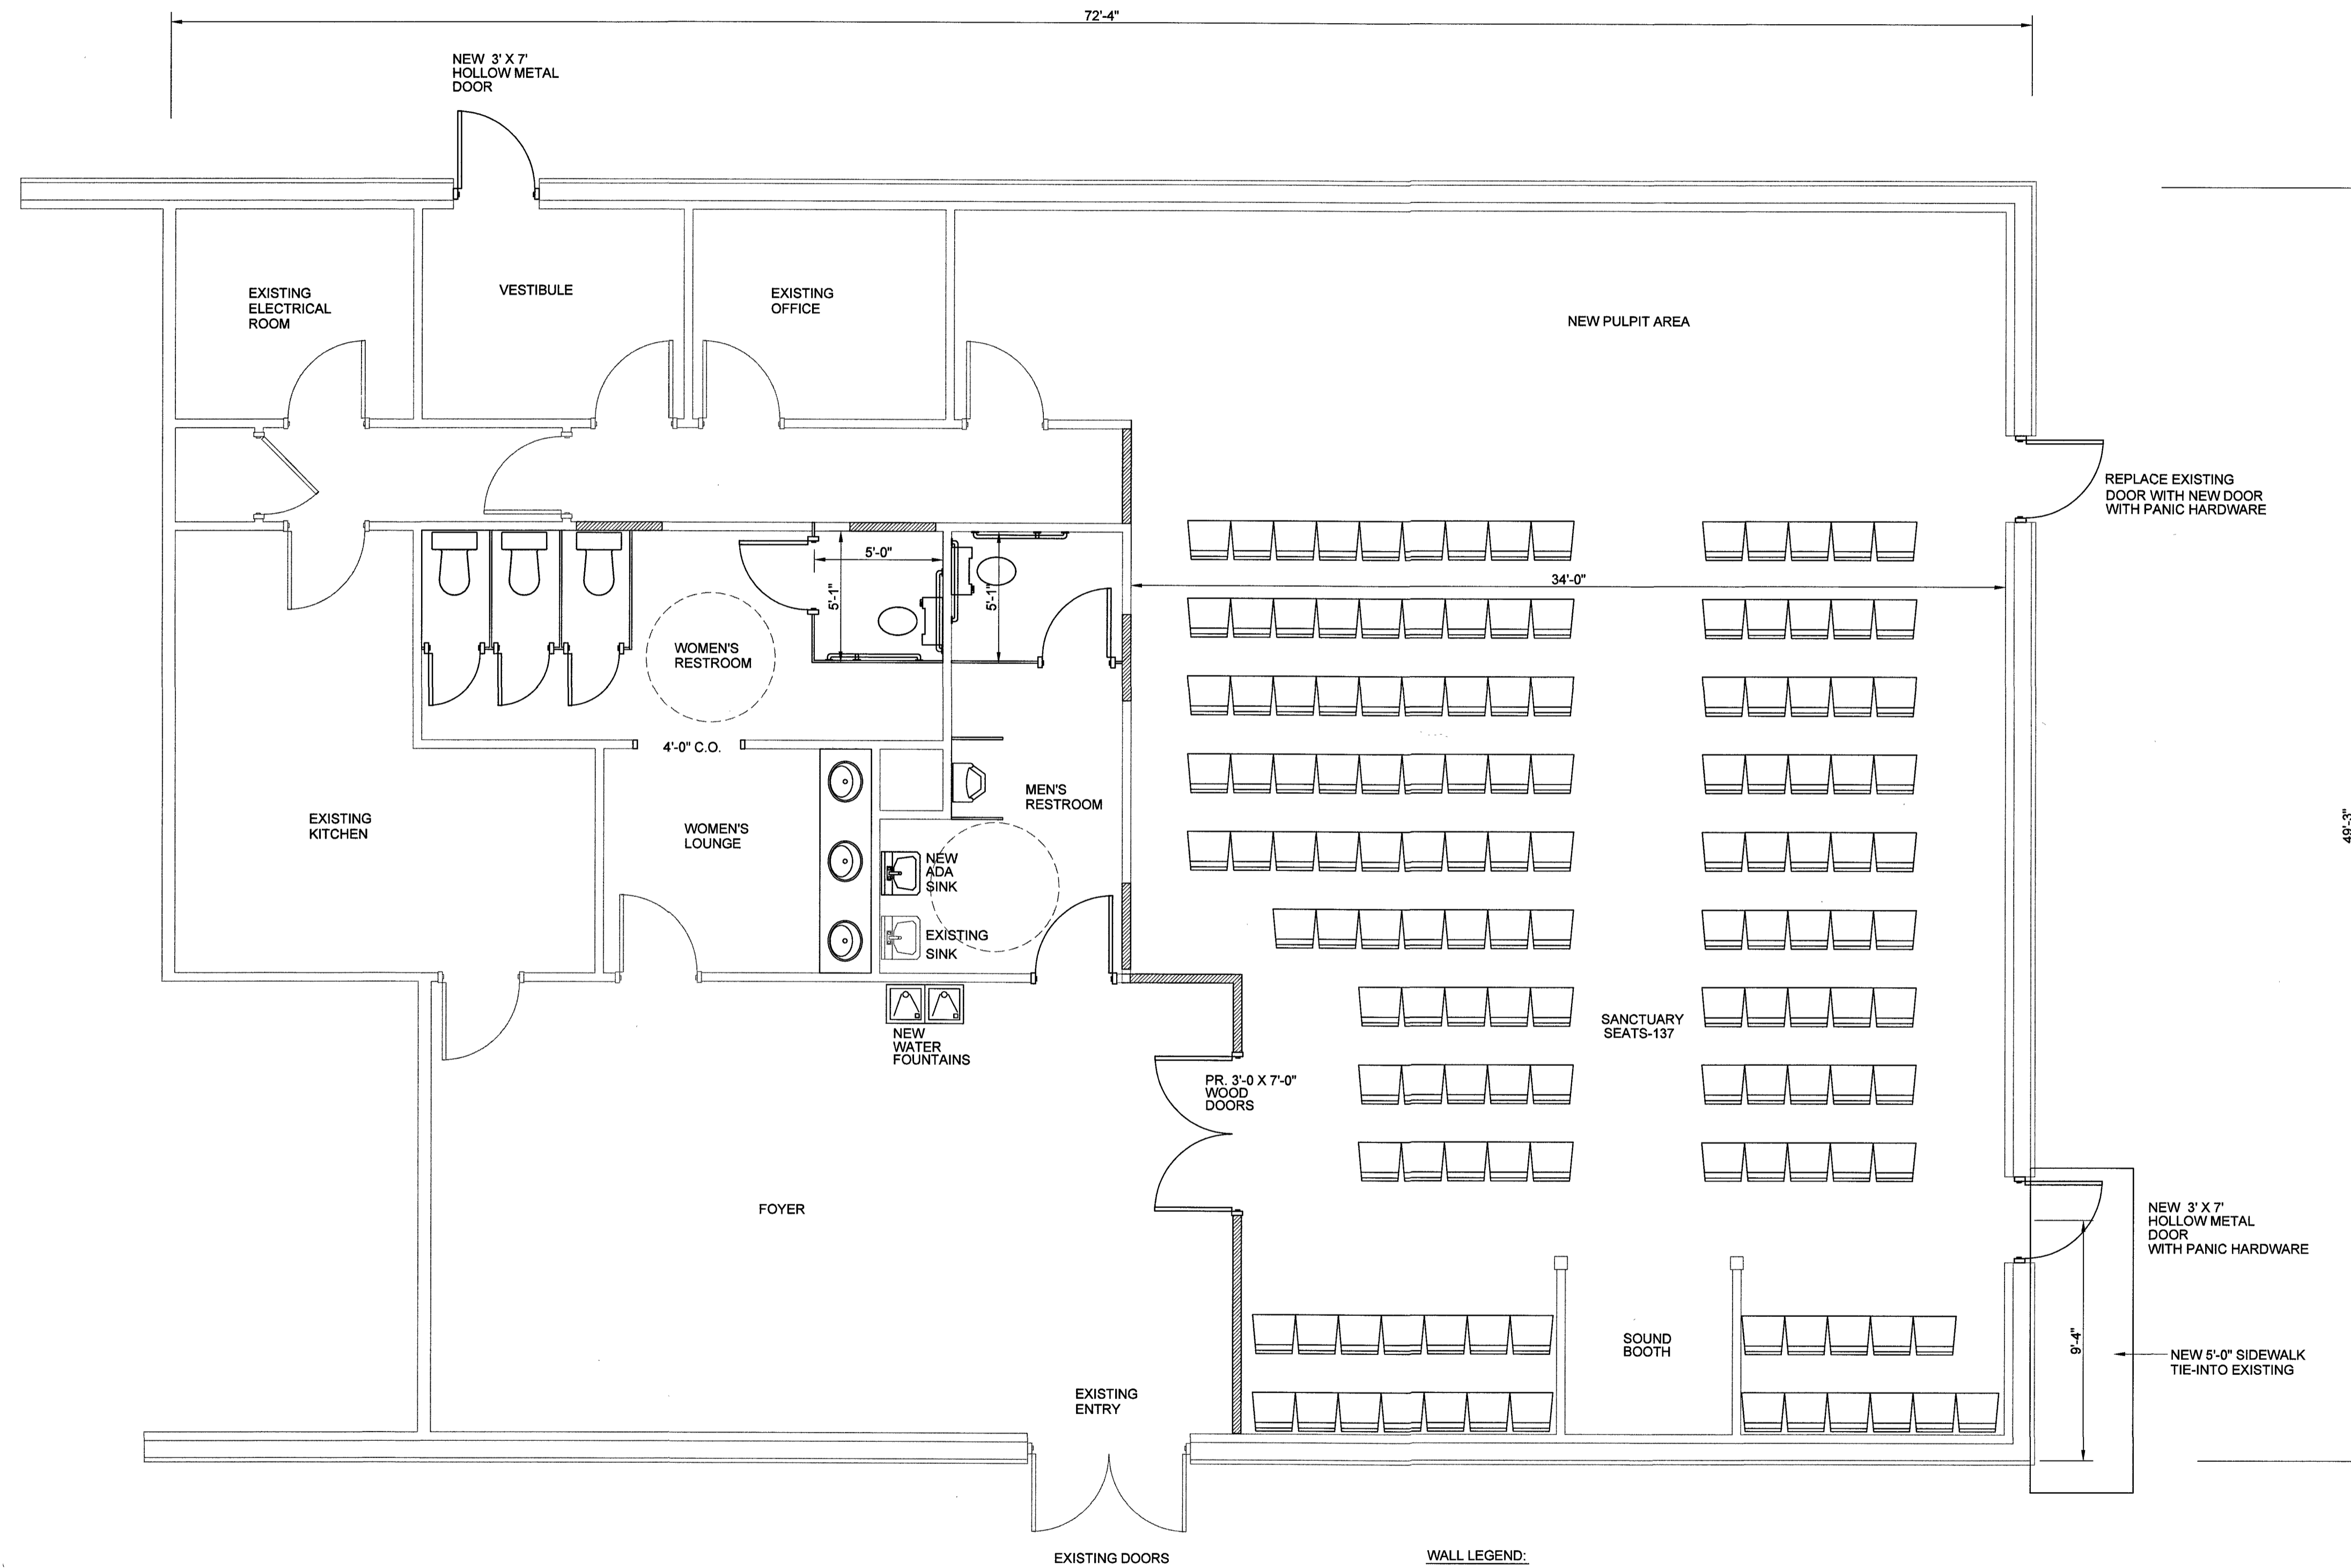
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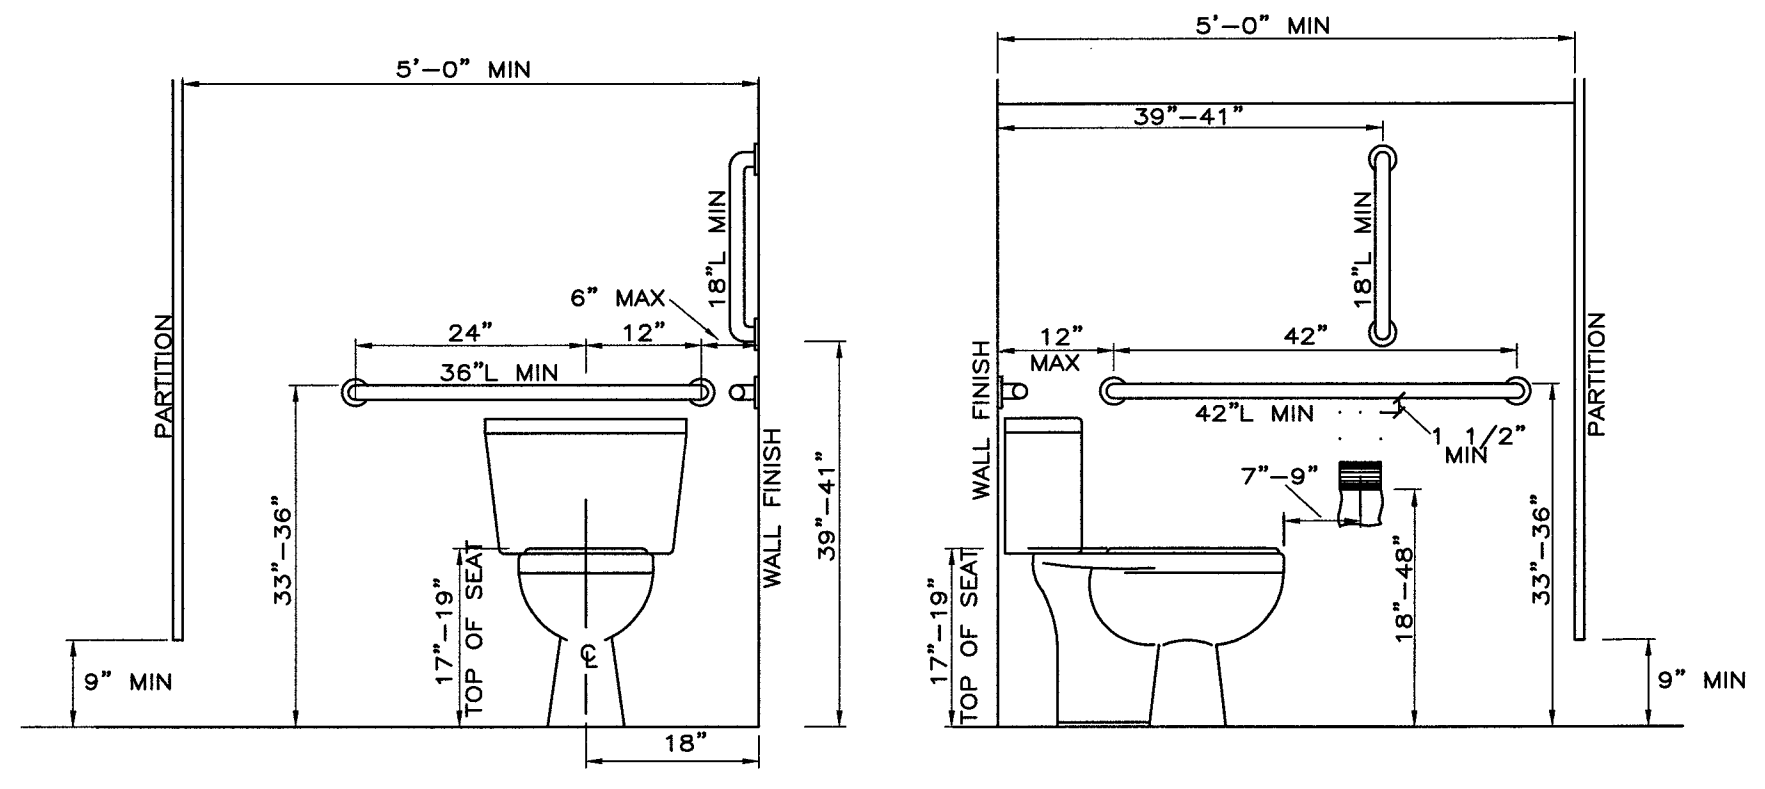


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Word Afire Ministries
 1503 Denim Road
 Erwin, NC

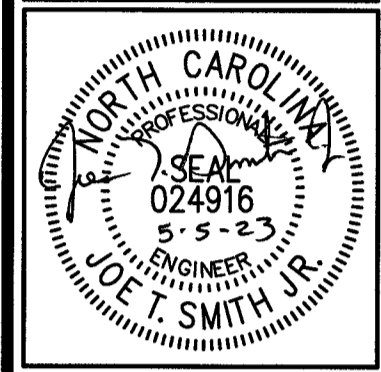
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 DRAWN BY: J.S.
 SCALE: 1/4" = 1'-0"

G-2




FRONT ELEVATION SIDE ELEVATION

TOILET ELEVATIONS FOR MULTIPLE STALL RESTROOMS
(ADA REQUIREMENTS)

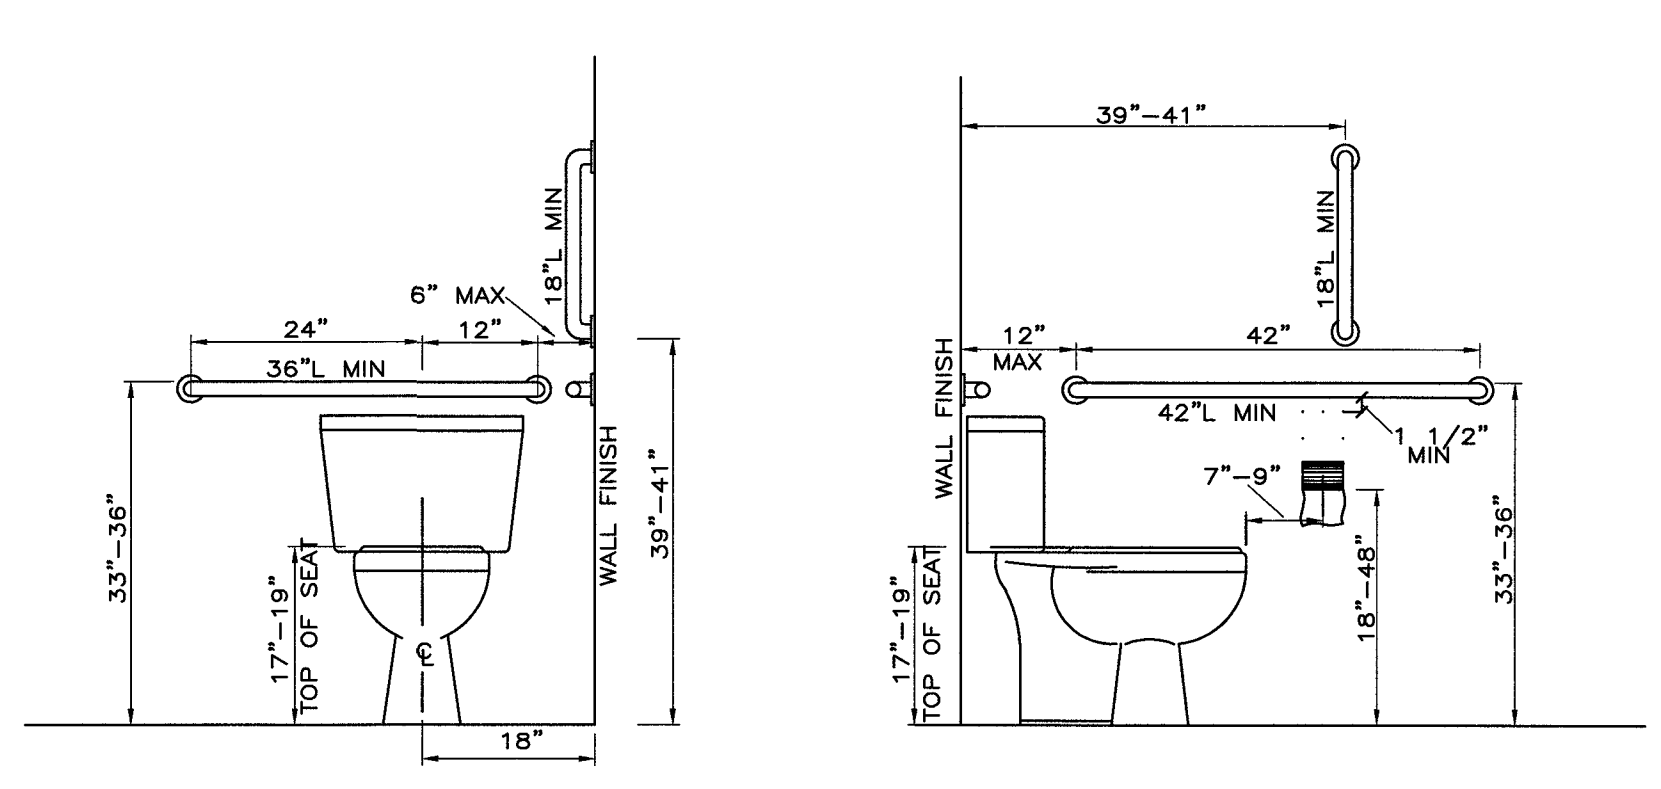


FRONT ELEVATION SIDE ELEVATION


TOILET ELEVATIONS FOR SINGLE RESTROOMS
(ADA REQUIREMENTS)

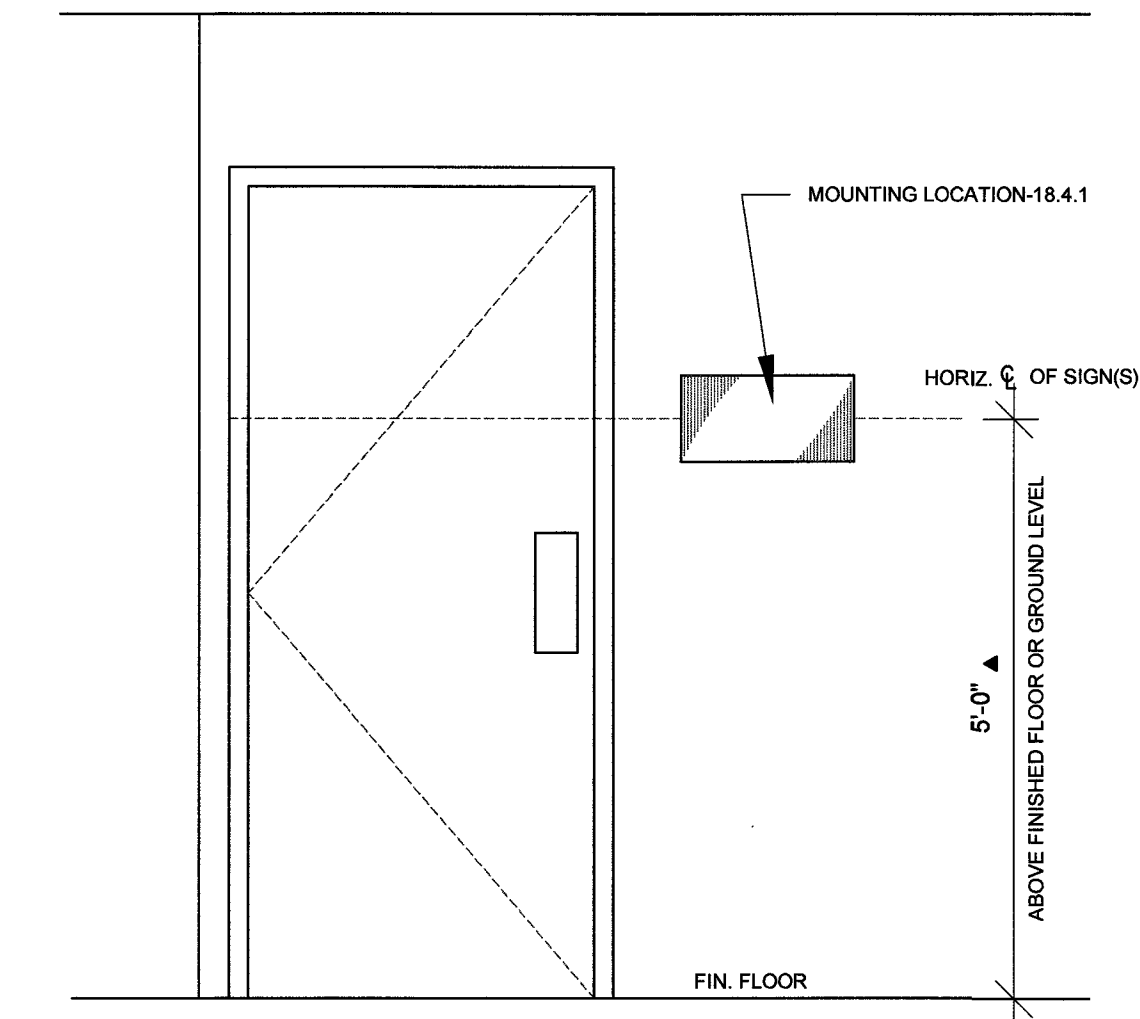


SIGNAGE MOUNTING LOCATION & HEIGHT
(ADA REQUIREMENTS)

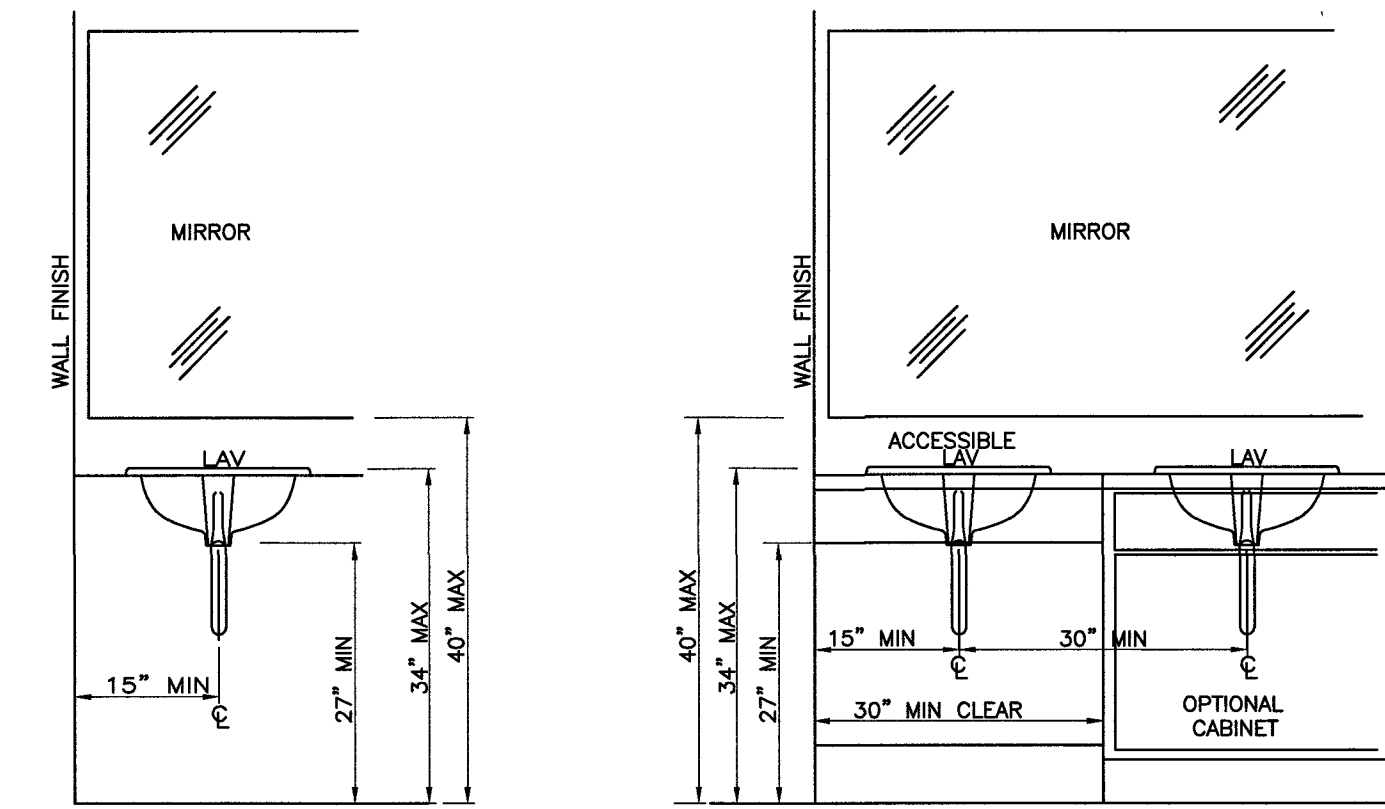

SINGLE VANITY

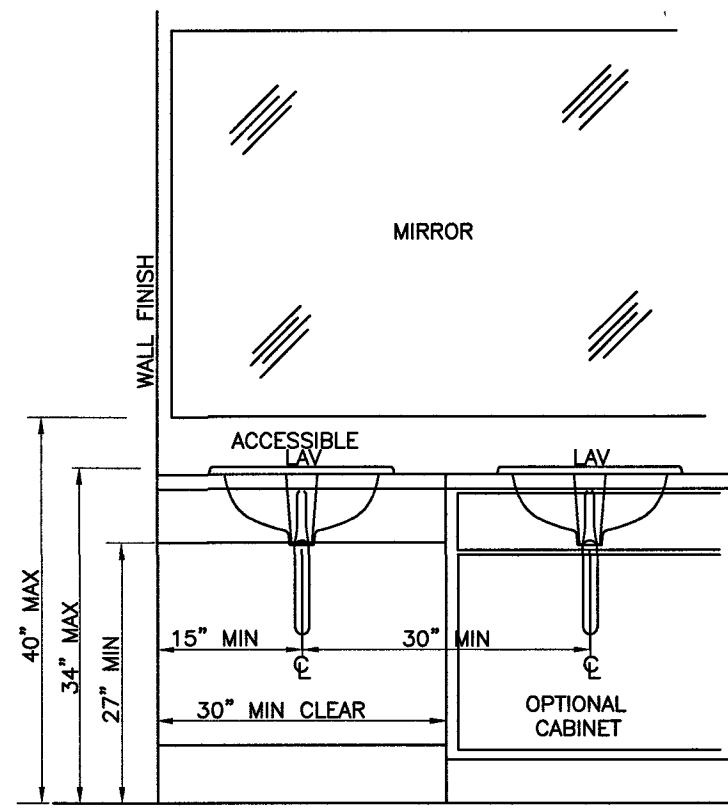


MULTIPLE VANTIES

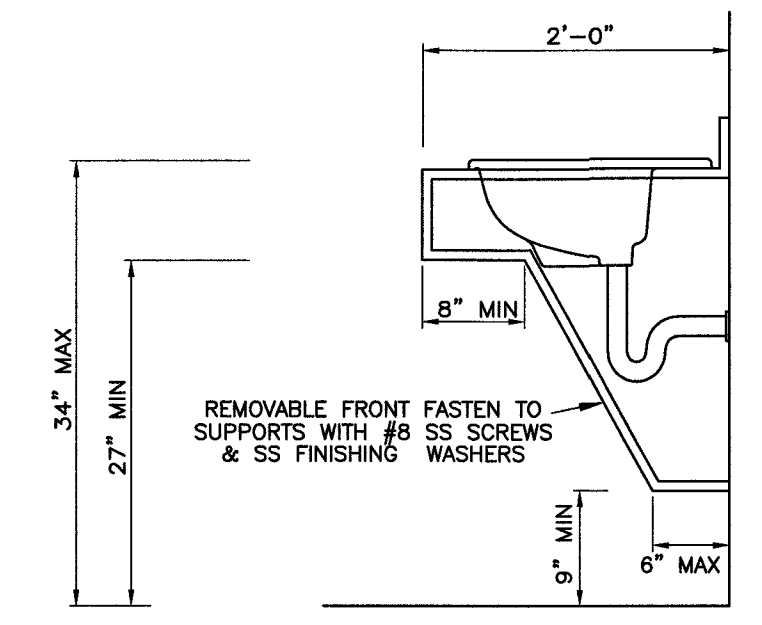


SECTION

CABINET MOUNTED VANITY DETAILS
(ADA REQUIREMENTS)

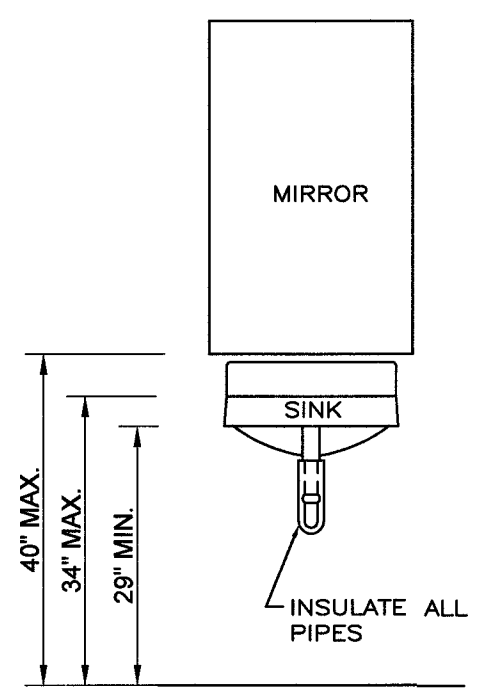


LAVATORY AND MIRROR

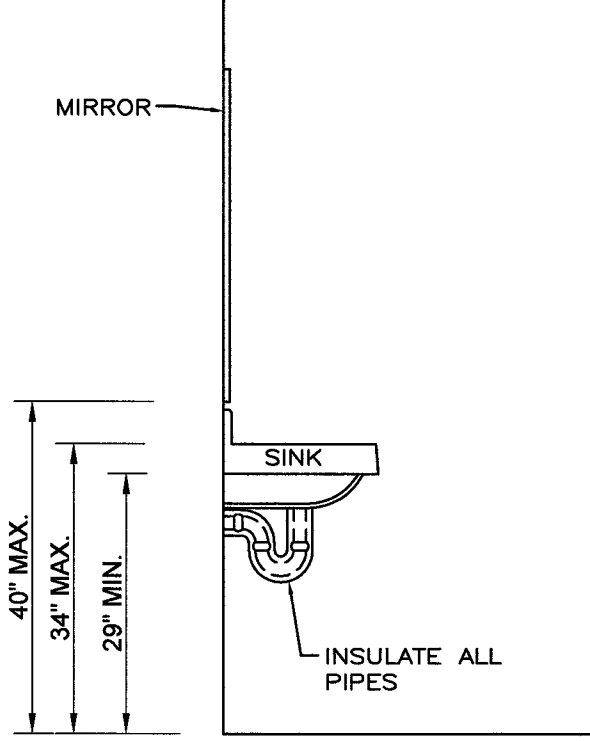


LAVATORY AND MIRROR


WALL HUNG LAVATORY DETAILS

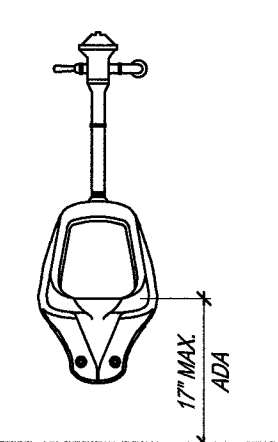


HC URINAL

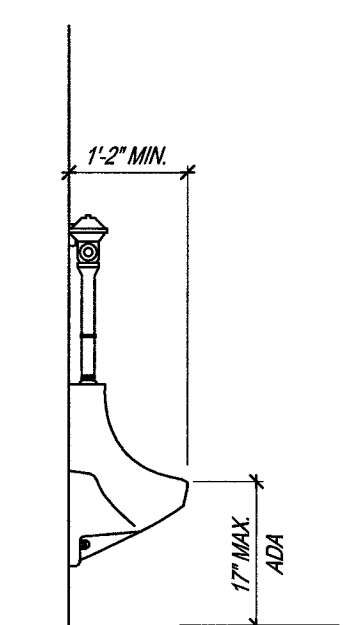

HC URINAL

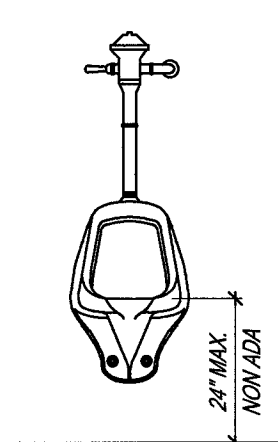


STANDARD URINAL

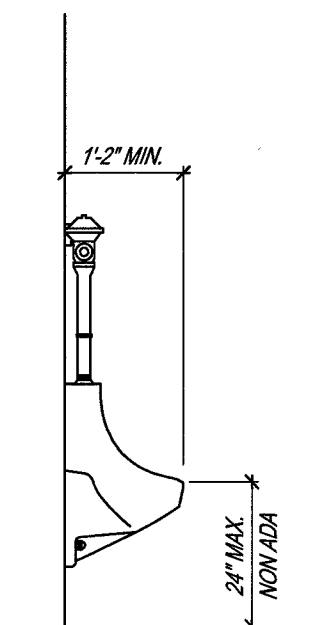


STANDARD URINAL

URINAL DETAILS

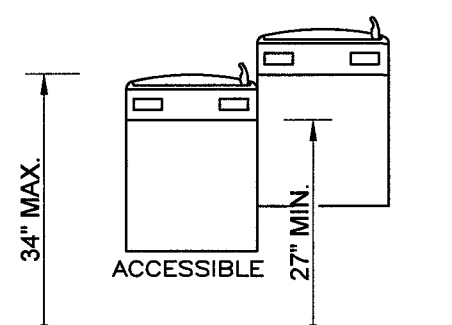


WATER COOLERS

WATER COOLER DETAILS
(ADA REQUIREMENTS)

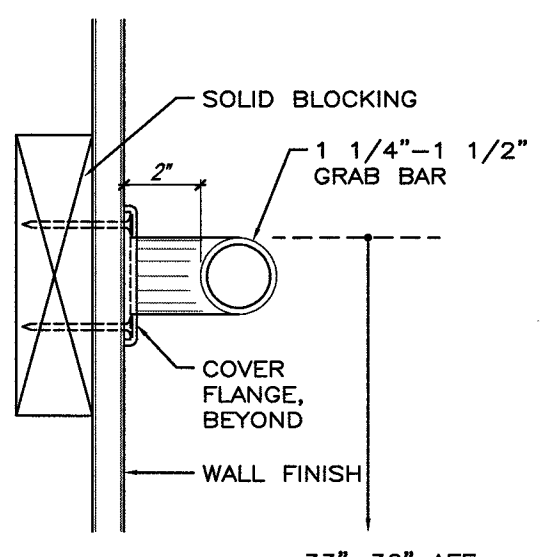


GRAB BAR DETAIL
(ADA REQUIREMENTS)

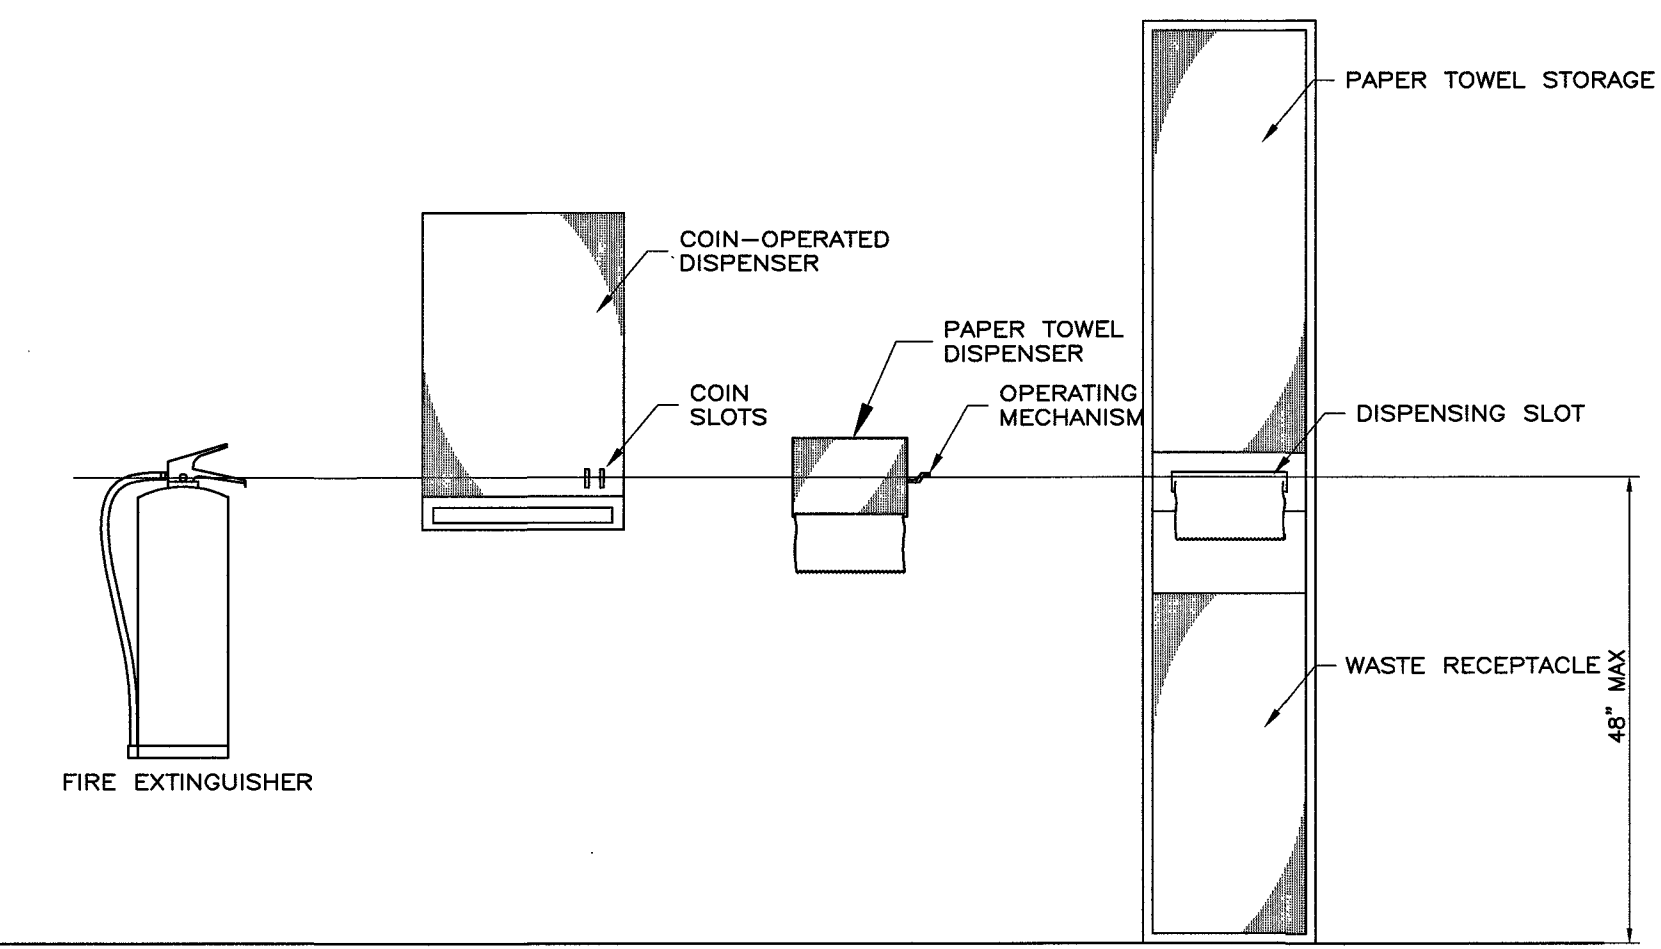

DISPENSERS
(ADA REQUIREMENTS)

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Word Afire Ministries
1503 Denim Road
Erwin, NC 28339

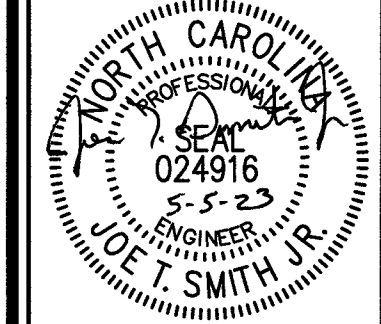DATE: 5 May 2023
DRAWN BY: J.S.
SCALE: N.T.S.

