ABBREVIATIONS

ACT ACOUSTICAL CEILING TILE

AFF ABOVE FINISHED FLOOR

A/C AIR CONDITIONING

ADJ ADJUSTABLE

BOH BACK OF HOUSE


AMP AMPERE ARCH ARCHITECT

CAB CABINET


CLG CEILING

CL CENTER LINE

|--|

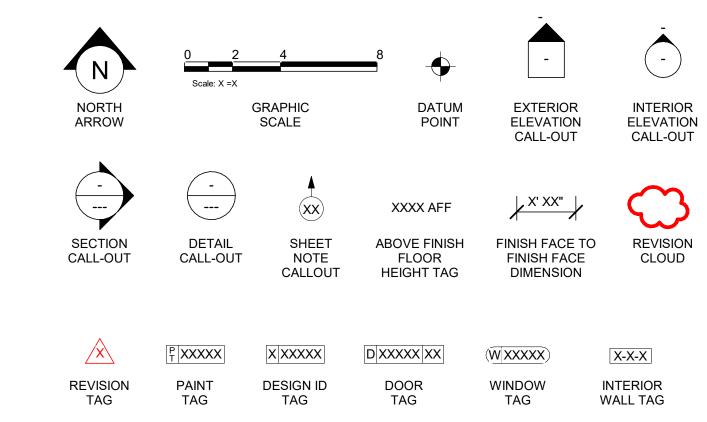

AERIAL MAP

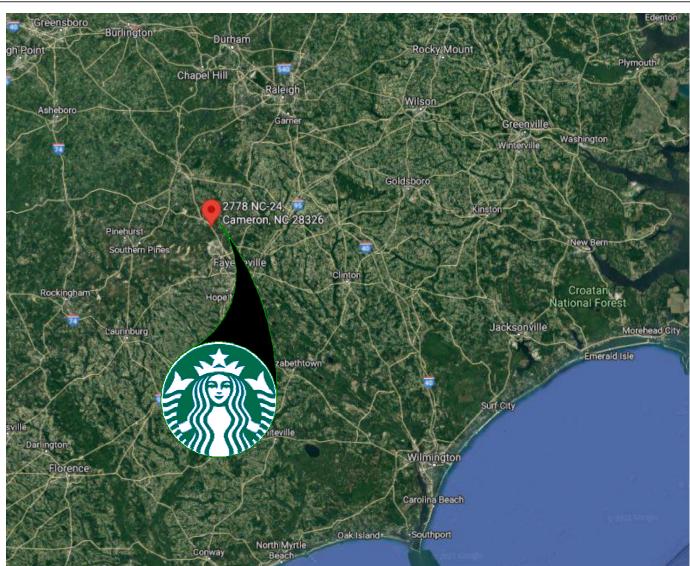

SOURCE : GOOGLE MAP

VICINITY PLAN



SOURCE : GOOGLE MAP

CLG CM	CEILING STARBUCKS CONSTRUCTION MANAGER
CTR CX CXA	CENTER COMMISSIONING COMMISSIONING AGENT
DEG DET DIA DIM DM	DEGREE DETAIL DIAMETER DIMENSION STARBUCKS DESIGN MANAGER DOWN
FO	EACH ELEVATION EQUAL EXISTING EXTERIOR
FF&E FLR FOH FOIC FOIO FT	FURNITURE, FIXTURE, AND EQUIPMENT FLOOR FRONT OF HOUSE FURNISHED BY OWNER, INSTALLED BY CONTRACTOR FURNISHED BY OWNER INSTALLED BY OWNER FOOT/FEET
GC	GROUND GENERAL CONTRACTOR GYPSUM WALLBOARD
HM HORIZ HR HT	HARDWARE HOLLOW METAL HORIZONTAL HOLIR
I.D.	INSIDE DIAMETER
LEED LL LV	LEADERSHIP IN ENERGY AND ENVIRONMENTAL DESIGN LANDLORD LOW VOLTAGE
MEP	MAXIMUM "MECHANICAL, ELECTRICAL AND PLUMBING" MANUFACTURER MINIMUM
	NOT IN CONTRACT NIGHT LIGHT NOT TO SCALE
	ON CENTER OUTSIDE DIAMETER
PIR PLC	PASSIVE INFRARED SENSOR PLACE
REF REQ'D REV	RADIUS REFERENCE REQUIRED REVISION ROUND
SC SF SHT SIM SPEC	STARBUCKS SOLID CORE SQUARE FEET SHEET SIMILAR SPECIFICATION SQUARE
TEMP TYP	TEMPORARY TYPICAL
UC UNO	UNDER COUNTER UNLESS NOTED OTHERWISE
VERT VIF	VERTICAL VERIFY IN FIELD

RESPONSIBILITY LEGEND

GC GENERAL CONTRACTOR LL LANDLORD SB STARBUCKS

PROJECT CONTACTS

MAILING ADDRESS:	STARBUCKS COFFEE COMPANY 2401 UTAH AVENUE SOUTH MS STOP: S-SD10 SEATTLE, WASHINGTON 98134 (206) 318-1575
DESIGN MANAGER:	GIDA AVILA STARBUCKS COFFEE COMPANY 95 MERRICK WAY SUITE 650 CORAL GABLES, FL 33134 (305) 529-5375
STORE DESIGNER:	ASHLEY SUEIRAS STARBUCKS COFFEE COMPANY 95 MERRICK WAY SUITE 650 CORAL GABLES, FL 33134 (786) 946-2505
CONSTRUCTION MANAGER:	RICK JOHNSON STARBUCKS COFFEE COMPANY (404) 991 - 9837 rjohnson@Starbucks.com
LANDLORD:	PRIMAX PROPERTIES, LLC MIKE ERICKSON 1100 MOREHEAD STREET CHARLOTTE, NC 28204 PHONE: 980-938-5471
ARCHITECT OF RECORD:	GPD ENGINEERING AND ARCHITECTURE PROFESSIONAL CORPORATION - 52715 520 SOUTH MAIN STREET SUITE 2531 AKRON, OH 44311 330-572-2100
MEP CONSULTANT OF RECORD:	GPD ENGINEERING AND ARCHITECTURE PROFESSIONAL CORPORATION - C3879 520 SOUTH MAIN STREET SUITE 2531 AKRON, OH 44311 330-572-2100
STRUCTURAL CONSULTANT:	GPD ENGINEERING AND ARCHITECTURE PROFESSIONAL CORPORATION - C3879 520 SOUTH MAIN STREET SUITE 2531 AKRON, OH 44311 330-572-2100

SCOPE OF WORK

NEW PROPOSED TENANT IMPROVEMENT FOR NEW STARBUCKS STORE. CODE AUTHORITIES: INTERIOR SCOPE OF WORK INCLUDES INTERIOR WALLS, WALL FINISHES, FIXTURES, EQUIPMENT, CASEWORK, AND ACCESSIBLE EMPLOYEE RESTROOM.

NO EXTERIOR SCOPE OF WORK EXCEPT FOR BUILDING SIGNAGE PERMITTED SEPARATELY.

SHELL BUILDING SIGNAGE PERMITTED SEPARATELY BY OTHERS.

GENERAL NOTES

- 1. THE DRAWINGS AND PROJECT MANUAL TOGETHER CONSTITUTE THE CONTRACT DOCUMENTS FOR CONSTRUCTION. ALL GENERAL REQUIREMENTS ARE TO BE MET AND ALL MATERIALS, FINISHES AND SYSTEMS ARE TO BE INSTALLED AND PERFORM PER SPECIFICATIONS UNLESS OTHERWISE NOTED.
- 2. GENERAL CONTRACTOR SHALL VISIT THE SITE, REVIEW THE BUILDING SHELL DRAWINGS AS SUBMITTED BY THE LANDLORD OR STARBUCKS AND BECOME THOROUGHLY FAMILIAR WITH THE SITE CONDITIONS PRIOR TO CONSTRUCTION.
- 3. GENERAL CONTRACTOR SHALL CONSULT WITH STARBUCKS CONSTRUCTION MANAGER TO RESOLVE ANY CHANGES, OMISSIONS OR PLAN DISCREPANCIES PRIOR TO CONSTRUCTION.
- 4. ALL WORK SHALL BE PERFORMED IN STRICT COMPLIANCE WITH LOCAL, COUNTY, STATE AND FEDERAL CODES AND ORDINANCES.
- 5. GENERAL CONTRACTOR SHALL VERIFY THE LOCATION OF ALL UTILITIES.
- 6. GENERAL CONTRACTOR TO VERIFY ALL DIMENSIONS, INCLUDING CLEARANCES REQUIRED BY OTHER TRADES AND NOTIFY STARBUCKS CONSTRUCTION MANAGER OF ANY DISCREPANCIES PRIOR TO PROCEEDING WITH THE WORK. ALL DIMENSIONS ARE TO THE FACE OF THE FINISHED SURFACE UNLESS NOTED OTHERWISE. ALL DIMENSIONS TO BE TAKEN FROM DESIGNATED DATUM POINT. DO NOT SCALE DRAWINGS.
- 7. GENERAL CONTRACTOR SHALL PATCH AND REPAIR ALL EXISTING WALLS, FLOORS, CEILINGS, OR OTHER SURFACES IDENTIFIED TO REMAIN THAT MAY BECOME DAMAGED DURING THE COURSE OF THE WORK.
- 8. THE GENERAL CONTRACTOR IS RESPONSIBLE FOR OBTAINING PERMITS FOR FIRE PROTECTION, PLUMBING, MECHANICAL, AND ELECTRICAL SYSTEMS PRIOR TO INSTALLATION OF SUCH SYSTEMS.
- 9. GENERAL CONTRACTOR SHALL RETAIN ONE SET OF PERMIT PLANS ON-SITE TO DOCUMENT ALL CHANGES MADE DURING CONSTRUCTION. THE RECORD DRAWINGS SHALL BE ISSUED TO THE OWNER AT PROJECT CLOSE-OUT AS DESCRIBED IN THE GENERAL REQUIREMENTS OF THE PROJECT MANUAL.
- 10. GENERAL CONTRACTOR IS RESPONSIBLE FOR COORDINATING DELIVERY OF MATERIALS FROM STARBUCKS CONTRACTED THIRD PARTY LOGISTICS DISTRIBUTION SERVICES AND VENDOR DIRECT SHIPMENTS. SEE THE PROJECT MANUAL FOR ADDITIONAL INFORMATION.
- 11. RESPONSIBILITY FOR SUPPLY AND DELIVERY OF MATERIALS AND EQUIPMENT IS IDENTIFIED IN THE DRAWING SCHEDULE SHEETS UNDER THE COLUMN LABELED "RESPONSIBILITY".
- 12. FOR THE PURPOSE OF THE DOCUMENTS, TO "INSTALL", SHALL MEAN TO PROVIDE ALL FASTENERS, MISCELLANEOUS HARDWARE, BLOCKING, ELECTRICAL CONNECTIONS, PLUMBING CONNECTIONS AND OTHER ITEMS REQUIRED FOR A COMPLETE AND OPERATIONAL INSTALLATION, UNLESS OTHERWISE NOTED.
- 13. ALL ITEM SUBSTITUTIONS MUST BE APPROVED BY THE STARBUCKS CONSTRUCTION MANAGER.

SITE INFORMATION

- BUILDING CODE: PLUMBING CODE: MECHANICAL CODE: ELECTRICAL CODE: ENERGY CODE:
- FIRE CODE: HEALTH CODE:
- ACCESSIBILITY CODE:

ZONING:

- PARCEL NUMBER: LEASABLE AREA:
- CONSTRUCTION TYPE: OCCUPANCY TYPE: FIRE SPRINKLER:
- 2018 NC PLUMBING CODE 2018 NC MECHANICAL CODE 2017 NATIONAL ELECTRICAL CODE (NFPA 70) 2018 NC ENERGY CONSERVATION CODE 2018 NC FIRE PREVENTION CODE 2009 NC FOOD CODE 2009 ICC ANSI A117.1

2018 NC BUILDING CODE

019594010706 2,480 GROSS SF 2,324 NET SF

V-B

NO

B - BUSINESS

LEGEND:	X - SHEET ISSU R - SHEET ISSU SEE TITLEBLO

GENERAL	
G001	GENERAL INFOR
G002	LIFE SAFETY ANI
G003	APPENDIX B
G004	3D VIEWS

		ET	AIT SET	SION 1	SION 2	SION 3	SION 4	SION 5	SION 6	SION 7
SHEET	SHEET TITLE	BID SET	PERMIT	REVISION						
GENERAL			•				•		•	
G001	GENERAL INFORMATION		X						X	
G002 G003	LIFE SAFETY AND ACCESSIBILITY PLAN APPENDIX B	_	X X			x	X		X X	
G004	3D VIEWS		X						X	
RCHITEC	CTURAL									_
A001 A003	ARCHITECTURAL SITE PLAN ARCHITECTURAL SITE DETAILS		X X						X X	
A003	ARCHITECTURAL SITE DETAILS		X						X	
A005 A101	RAILING DETAILS BUILDING FLOOR PLAN		X X						X X	X
A102	BUILDING FLOOR PENETRATION PLAN		X				X	X	X	X
A103			X						X	
A201 A202	BUILDING EXTERIOR ELEVATIONS BUILDING EXTERIOR ELEVATIONS		X X						X X	
A601	SCHEDULES		Х						X	
A602	WINDOW AND DOOR SCHEDULES & DETAILS		Х						X	
NTERIOR					1	1				
101 102	FF & E PLAN CASEWORK PLAN	_	X X				X X	X	X X	X
I102B	CASEWORK DETAILS		Х						Х	
I103 I103B	REFLECTED CEILING PLAN	_	X X						X X	
I104	FLOOR FINISH PLAN		Х						X	
I201 I202	INTERIOR FINISH ELEVATIONS INTERIOR FINISH ELEVATIONS		X X				X		X X	
1202	INTERIOR FINISH ELEVATIONS		X				X	X	X	X
I401	RESTROOM PLAN & ELEVATIONS		X X						X	
1501 1502	INTERIOR DETAILS INTERIOR DETAILS		X						X X	
1503	DESIGN DETAILS		X						Х	
I504 I601	DESIGN DETAILS CASEWORK AND FF&E SCHEDULES	_	X X						X X	
1602	INTERIOR FINISHES SCHEDULES		Х						Х	
STRUCTU	RAL									
S001	STRUCTURAL GENERAL NOTES		Х						Х	
S101 S501	STRUCTURAL SLAB PLAN SITE FOUNDATIONS	_	X X						X X	
S502	SITE FOUNDATIONS		Х						Х	
ELECTRIC	CAL									
E001	ELECTRICAL NOTES		Х						Х	
E003 E101	ELECTRICAL SITE PLAN POWER PLAN		X X						X X	X
E101	LIGHTING PLAN		X						X	
E103 E104	ENLARGED ELECTRICAL PLACEMENT PLAN		X X						X	
E501	DATA DEVICE PLAN ELECTRICAL DETAILS		X						X X	
E502 E513			X X						X	
E601	GENERAL ELECTRICAL - EMS, NO LIGHTING ELECTRICAL PANEL SCHEDULES		X						X X	
		•								
MECHANI M001	MECHANICAL NOTES		X						X	
M101	MECHANICAL DESIGN PLAN		X			X			X	
M102 M501	MECHANICAL ROOF PLAN MECHANICAL DETAILS		X X			X			X X	
M601	MECHANICAL SCHEDULES		Х						Х	
PLUMBING	3									
P001	PLUMBING NOTES		X						X	
P101 P102	PLUMBING SUPPLY PLAN PLUMBING WASTE & VENT PLAN		X X				X X	X X	X X	X X
P103	PLUMBING WASTE & SANITARY ISOMETRIC		Х				X	X	X	
P501 P502	PLUMBING DETAILS PLUMBING DETAILS		X X						X X	
P502	PLUMBING SCHEDULES									


		SET	AIT SET	REVISION 1	REVISION 2	REVISION 3	REVISION 4	REVISION 5	REVISION 6	REVISION 7
SHEET	SHEET TITLE	BID (PERMIT	REVI	REVI	REVI	REVI	REVI	REV	REV
SENERAL										
G001	GENERAL INFORMATION		X						X	
G002 G003	LIFE SAFETY AND ACCESSIBILITY PLAN APPENDIX B	_	X X			x	X		X X	
G004	3D VIEWS		X						X	
RCHITE	CTURAL									
A001	ARCHITECTURAL SITE PLAN		X						X	
A003 A004	ARCHITECTURAL SITE DETAILS ARCHITECTURAL SITE DETAILS		X X						X X	
A005	RAILING DETAILS		X						X	
A101 A102	BUILDING FLOOR PLAN BUILDING FLOOR PENETRATION PLAN		X X				X	X	X X	X X
A103	BUILDING ROOF PLAN		Х						X	
A201 A202	BUILDING EXTERIOR ELEVATIONS BUILDING EXTERIOR ELEVATIONS		X X						X X	
A601	SCHEDULES		Х						Х	
A602	WINDOW AND DOOR SCHEDULES & DETAILS		X						X	
NTERIOR							1			
I101 I102	FF & E PLAN CASEWORK PLAN		X X				X X	Х	X X	Х
I102B	CASEWORK DETAILS		Х						Х	
I103 I103B	REFLECTED CEILING PLAN LIGHTING PLAN		X X						X X	
I103B	FLOOR FINISH PLAN		Х						X	
1201	INTERIOR FINISH ELEVATIONS INTERIOR FINISH ELEVATIONS		X X						X	
I202 I203	INTERIOR FINISH ELEVATIONS		X X				X X	X	X X	X
I401	RESTROOM PLAN & ELEVATIONS		X						X	
I501 I502	INTERIOR DETAILS INTERIOR DETAILS		X X						X X	
1503	DESIGN DETAILS		Х						Х	
I504 I601	DESIGN DETAILS CASEWORK AND FF&E SCHEDULES	_	X X						X X	
1602	INTERIOR FINISHES SCHEDULES		Х						Х	
STRUCTU	RAL									
S001	STRUCTURAL GENERAL NOTES		X						X	
S101 S501	STRUCTURAL SLAB PLAN SITE FOUNDATIONS		X X						X X	
S502	SITE FOUNDATIONS		Х						Х	
ELECTRIC	CAL									
E001	ELECTRICAL NOTES		X						Х	
E003 E101	ELECTRICAL SITE PLAN POWER PLAN		X X						X X	X
E102	LIGHTING PLAN		Х						Х	
E103 E104	ENLARGED ELECTRICAL PLACEMENT PLAN DATA DEVICE PLAN		X X						X X	
E501	ELECTRICAL DETAILS		Х						X	
E502 E513	ELECTRICAL DETAILS GENERAL ELECTRICAL - EMS, NO LIGHTING		X X						X X	
E601	ELECTRICAL PANEL SCHEDULES		X						X	
/IECHANI	CAL									
M001			X						Х	
M101 M102	MECHANICAL DESIGN PLAN MECHANICAL ROOF PLAN		X X			X X			X X	
M501	MECHANICAL DETAILS		X			~			X	
M601	MECHANICAL SCHEDULES		X						Х	
PLUMBIN	3			_						
P001 P101	PLUMBING NOTES PLUMBING SUPPLY PLAN		X X				X	X	X X	X
P102	PLUMBING WASTE & VENT PLAN		Х				Х	Х	X	X
P103 P501	PLUMBING WASTE & SANITARY ISOMETRIC PLUMBING DETAILS		X X				Х	Х	X X	
	PLUMBING DETAILS		X						X	
P502	PLUMBING SCHEDULES		Х						X	Х


STRUCTURAL									
S001	STRUCTURAL GE								
	STRUCTURAL SL								
S501	SITE FOUNDATIC								
S502	SITE FOUNDATIC								

		ET	AIT SET	SION 1	SION 2	SION 3	SION 4	SION 5	SION 6	SION 7
SHEET	SHEET TITLE	BID SET	PERMIT	REVISION						
GENERAL			•				•		•	
G001	GENERAL INFORMATION		X						X	
G002 G003	LIFE SAFETY AND ACCESSIBILITY PLAN APPENDIX B	_	X X			x	X		X X	
G004	3D VIEWS		X						X	
RCHITEC	CTURAL									_
A001 A003	ARCHITECTURAL SITE PLAN ARCHITECTURAL SITE DETAILS		X X						X X	
A003	ARCHITECTURAL SITE DETAILS		X						X	
A005 A101	RAILING DETAILS BUILDING FLOOR PLAN		X X						X X	X
A102	BUILDING FLOOR PENETRATION PLAN		X				X	X	X	X
A103			X						X	
A201 A202	BUILDING EXTERIOR ELEVATIONS BUILDING EXTERIOR ELEVATIONS		X X						X X	
A601	SCHEDULES		Х						X	
A602	WINDOW AND DOOR SCHEDULES & DETAILS		Х						X	
NTERIOR					1	1				
101 102	FF & E PLAN CASEWORK PLAN	_	X X				X X	X	X X	X
I102B	CASEWORK DETAILS		Х						Х	
I103 I103B	REFLECTED CEILING PLAN	_	X X						X X	
I104	FLOOR FINISH PLAN		Х						X	
I201 I202	INTERIOR FINISH ELEVATIONS INTERIOR FINISH ELEVATIONS		X X				X		X X	
1202	INTERIOR FINISH ELEVATIONS		X				X	X	X	X
I401	RESTROOM PLAN & ELEVATIONS		X X						X	
1501 1502	INTERIOR DETAILS INTERIOR DETAILS		X						X X	
1503	DESIGN DETAILS		X						Х	
I504 I601	DESIGN DETAILS CASEWORK AND FF&E SCHEDULES	_	X X						X X	
1602	INTERIOR FINISHES SCHEDULES		Х						Х	
STRUCTU	RAL									
S001	STRUCTURAL GENERAL NOTES		Х						Х	
S101 S501	STRUCTURAL SLAB PLAN SITE FOUNDATIONS	_	X X						X X	
S502	SITE FOUNDATIONS		Х						Х	
ELECTRIC	CAL									
E001	ELECTRICAL NOTES		Х						Х	
E003 E101	ELECTRICAL SITE PLAN POWER PLAN		X X						X X	X
E101	LIGHTING PLAN		X						X	
E103 E104	ENLARGED ELECTRICAL PLACEMENT PLAN		X X						X	
E501	DATA DEVICE PLAN ELECTRICAL DETAILS		X						X X	
E502 E513			X X						X	
E601	GENERAL ELECTRICAL - EMS, NO LIGHTING ELECTRICAL PANEL SCHEDULES		X						X X	
		•								
MECHANI M001	MECHANICAL NOTES		X						X	
M101	MECHANICAL DESIGN PLAN		X			X			X	
M102 M501	MECHANICAL ROOF PLAN MECHANICAL DETAILS		X X			X			X X	
M601	MECHANICAL SCHEDULES		Х						Х	
PLUMBING	3									
P001	PLUMBING NOTES		X						X	
P101 P102	PLUMBING SUPPLY PLAN PLUMBING WASTE & VENT PLAN		X X				X X	X X	X X	X X
P103	PLUMBING WASTE & SANITARY ISOMETRIC		Х				X	X	X	
P501 P502	PLUMBING DETAILS PLUMBING DETAILS		X X						X X	
P502	PLUMBING SCHEDULES									

MECHANICAL									
M001	MECHANICAL NO								
M101	MECHANICAL DE								
M102	MECHANICAL RO								
M501	MECHANICAL DE								
M601	MECHANICAL SC								

		BID SET	PERMIT SET	REVISION 1	REVISION 2	REVISION 3	REVISION 4	REVISION 5	REVISION 6	REVISION 7
SHEET	SHEET TITLE	B	ä	R	R	R	R	2	2	2
G001	GENERAL INFORMATION		X						X	
G002	LIFE SAFETY AND ACCESSIBILITY PLAN		Х				X		Х	
G003 G004	APPENDIX B 3D VIEWS		X X			X			X X	
RCHITEC										
	ARCHITECTURAL SITE PLAN ARCHITECTURAL SITE DETAILS		X X						X X	
	ARCHITECTURAL SITE DETAILS		Х						X	
			X						X X	
A101 A102	BUILDING FLOOR PLAN BUILDING FLOOR PENETRATION PLAN		X X				X	X	X	X X
	BUILDING ROOF PLAN		X						X	
A201			X						X	
A202 A601	BUILDING EXTERIOR ELEVATIONS SCHEDULES		X X						X X	
A602	WINDOW AND DOOR SCHEDULES & DETAILS		X						X	
NTERIORS										
I101 I102	FF & E PLAN CASEWORK PLAN	_	X X				X X	Х	X X	X
I102 I102B	CASEWORK PLAN CASEWORK DETAILS		X X				^		X X	
I103	REFLECTED CEILING PLAN		Х						X	
I103B I104	LIGHTING PLAN FLOOR FINISH PLAN	_	X X						X X	
	INTERIOR FINISH ELEVATIONS		X						X	
I202	INTERIOR FINISH ELEVATIONS		Х				X		X	
I203 I401	INTERIOR FINISH ELEVATIONS RESTROOM PLAN & ELEVATIONS		X X				Х	Х	X X	Х
	INTERIOR DETAILS		X						X	
1502	INTERIOR DETAILS		Х						X	
1503 1504	DESIGN DETAILS DESIGN DETAILS		X X						X X	
1504 1601	CASEWORK AND FF&E SCHEDULES		X						X	
1602	INTERIOR FINISHES SCHEDULES		Х						Х	
STRUCTUF	RAL STRUCTURAL GENERAL NOTES		X			1		1	X	
	STRUCTURAL GENERAL NOTES		X						X	
S501	SITE FOUNDATIONS		X						X	
S502	SITE FOUNDATIONS		Х						X	
ELECTRICA	AL .									_
E001		_	X						X	
E003 E101	ELECTRICAL SITE PLAN POWER PLAN		X X						X X	X
	LIGHTING PLAN		X						X	
E103	ENLARGED ELECTRICAL PLACEMENT PLAN		X						Х	
E104 E501	DATA DEVICE PLAN ELECTRICAL DETAILS		X X						X X	
E502	ELECTRICAL DETAILS		X						X	
E513 E601	GENERAL ELECTRICAL - EMS, NO LIGHTING ELECTRICAL PANEL SCHEDULES		X X						X X	
									^_	
/IECHANIC M001	AL MECHANICAL NOTES		X						X	
M101	MECHANICAL DESIGN PLAN		Х			Х			X	
		_	X			X			X	
	MECHANICAL DETAILS MECHANICAL SCHEDULES		X X						X X	
LUMBING										•
	PLUMBING NOTES		X						X	
	PLUMBING SUPPLY PLAN		X				X	X	X	X
P102 P103	PLUMBING WASTE & VENT PLAN PLUMBING WASTE & SANITARY ISOMETRIC		X X				X X	X X	X X	X
	PLUMBING DETAILS		X						X	
P501										
	PLUMBING DETAILS PLUMBING SCHEDULES	_	X X						X X	X

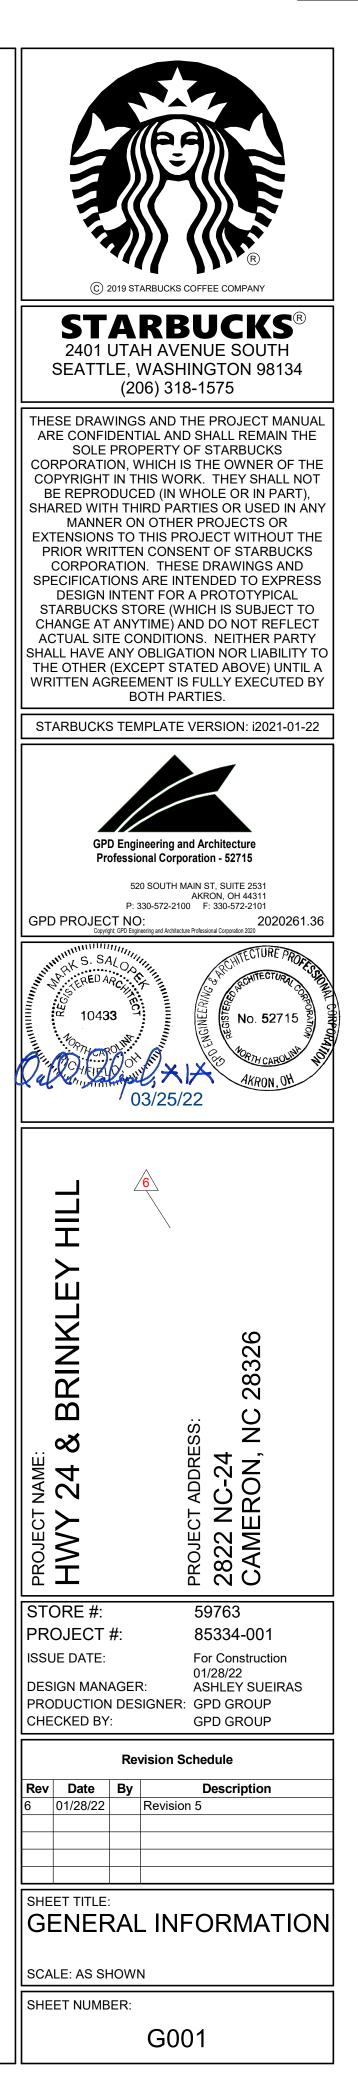

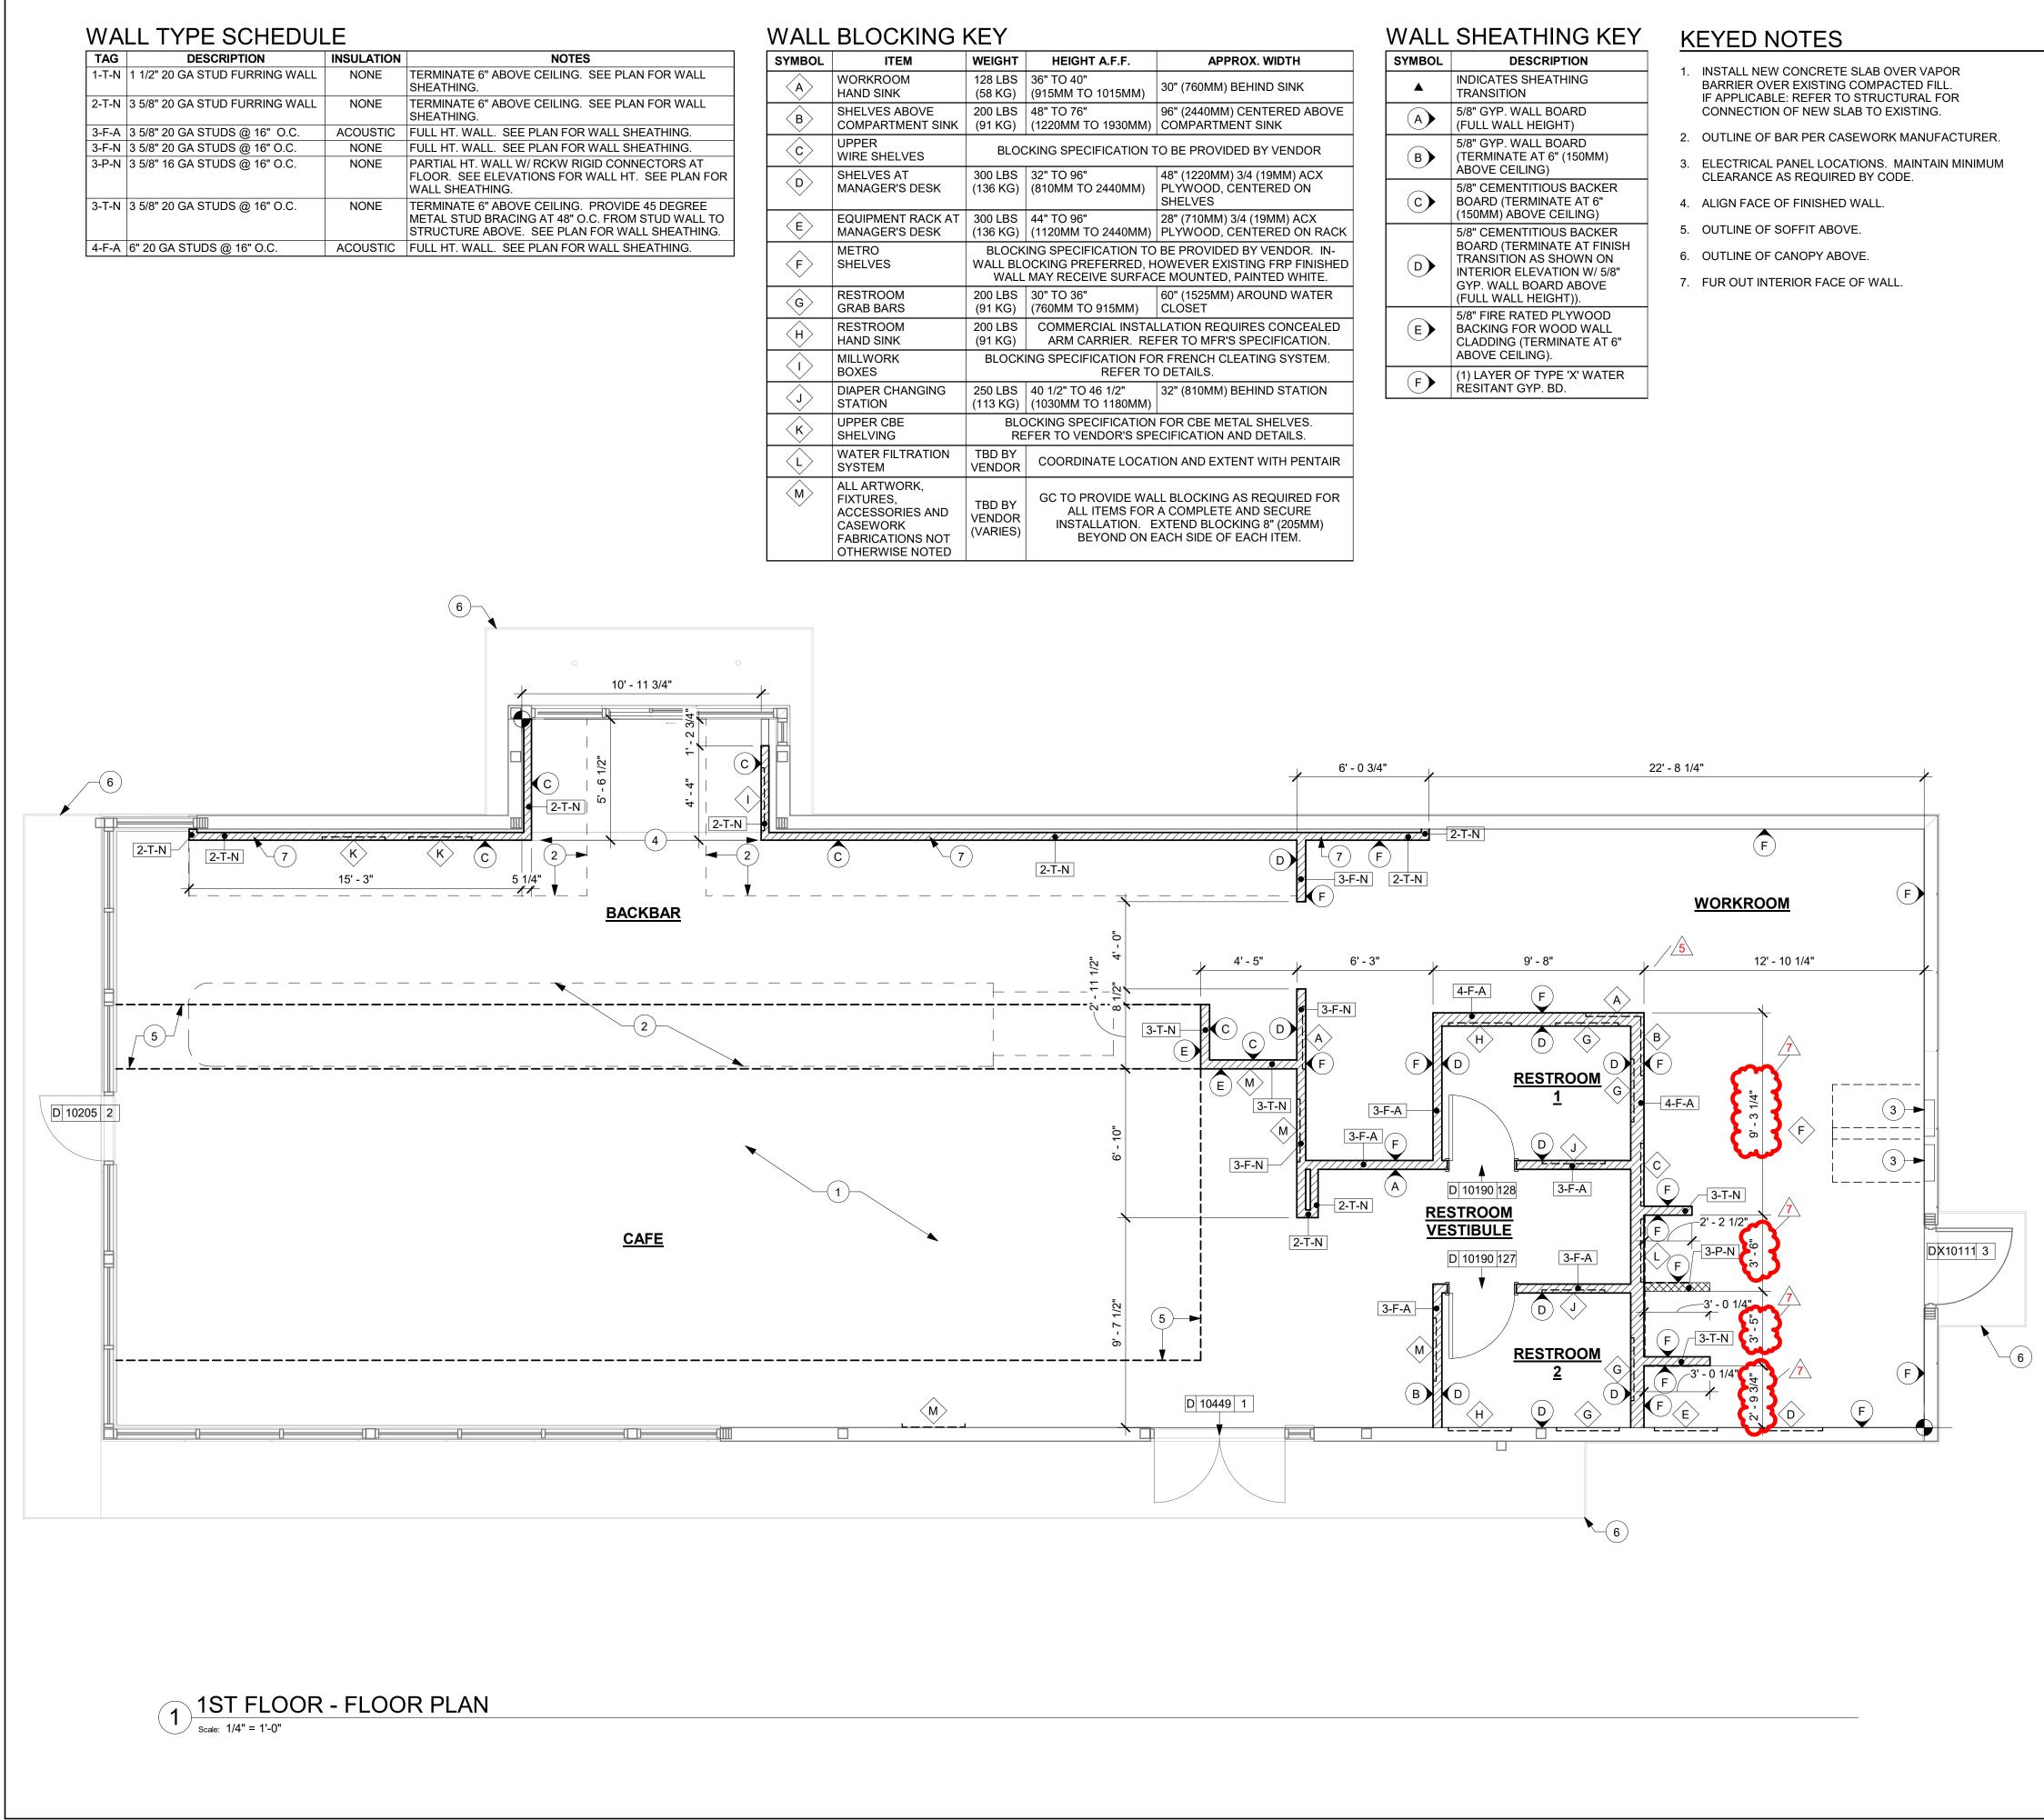

7								
ΗТ	HEIGHT A.F.F.	APPROX. WIDTH						
3S G)	36" TO 40" (915MM TO 1015MM)	30" (760MM) BEHIND SINK						
3S G)	48" TO 76" (1220MM TO 1930MM)	96" (2440MM) CENTERED ABOVE COMPARTMENT SINK						
LOCKING SPECIFICATION TO BE PROVIDED BY VENDOR								
3S (G)	32" TO 96" (810MM TO 2440MM)	48" (1220MM) 3/4 (19MM) ACX PLYWOOD, CENTERED ON SHELVES						
3S (G)	44" TO 96" (1120MM TO 2440MM)	28" (710MM) 3/4 (19MM) ACX PLYWOOD, CENTERED ON RACK						
OCKING SPECIFICATION TO BE PROVIDED BY VENDOR. IN- BLOCKING PREFERRED, HOWEVER EXISTING FRP FINISHED ALL MAY RECEIVE SURFACE MOUNTED, PAINTED WHITE.								
3S G)	30" TO 36" (760MM TO 915MM)	60" (1525MM) AROUND WATER CLOSET						
3S G)		LLATION REQUIRES CONCEALED FER TO MFR'S SPECIFICATION.						
CK		R FRENCH CLEATING SYSTEM. D DETAILS.						
BS (G)	40 1/2" TO 46 1/2" (1030MM TO 1180MM)	32" (810MM) BEHIND STATION						
BLOCKING SPECIFICATION FOR CBE METAL SHELVES. REFER TO VENDOR'S SPECIFICATION AND DETAILS.								
BY OR	COORDINATE LOCAT	ION AND EXTENT WITH PENTAIR						
BY OR ES)	ALL ITEMS FOR INSTALLATION. E	LL BLOCKING AS REQUIRED FOR A COMPLETE AND SECURE EXTEND BLOCKING 8" (205MM)						

WALL	SHEATHING KEY
SYMBOL	DESCRIPTION
	INDICATES SHEATHING TRANSITION
A	5/8" GYP. WALL BOARD (FULL WALL HEIGHT)
В	5/8" GYP. WALL BOARD (TERMINATE AT 6" (150MM) ABOVE CEILING)
C	5/8" CEMENTITIOUS BACKER BOARD (TERMINATE AT 6" (150MM) ABOVE CEILING)
D	5/8" CEMENTITIOUS BACKER BOARD (TERMINATE AT FINISH TRANSITION AS SHOWN ON INTERIOR ELEVATION W/ 5/8" GYP. WALL BOARD ABOVE (FULL WALL HEIGHT)).
E	5/8" FIRE RATED PLYWOOD BACKING FOR WOOD WALL CLADDING (TERMINATE AT 6" ABOVE CEILING).
F	(1) LAYER OF TYPE 'X' WATER RESITANT GYP. BD.

GENERAL NOTES

- A. GENERAL CONTRACTOR TO VERIFY ALL DIMENSIONS AND NOTIFY STARBUCKS CONSTRUCTION MANAGER OF ANY DISCREPANCIES PRIOR TO CONSTRUCTION. ALL DIMENSIONS TO BE TAKEN FROM DESIGNATED DATUM POINT.
- B. GENERAL CONTRACTOR TO PROVIDE FIRE TREATED WOOD STUD BLOCKING, OR EQUIVALENT TO SUPPORT ANY WALL ATTACHMENT AND/OR SIGNAGE.
- C. IF EXISTING EXTERIOR ENTRANCE THRESHOLD EXCEEDS MINIMUM BARRIER FREE PROVISION OF THE CODE, REMOVE AND REPLACE WITH ACCESSIBLE THRESHOLD. RAISED THRESHOLDS AND FLOOR LEVEL CHANGES AT ACCESSIBLE DOORWAYS TO BE BEVELED WITH A SLOPE NO GREATER THAN 1:12.
- D. ALL DIMENSIONS ARE TO FINISHED FACE UNLESS SHOWN OR NOTED OTHERWISE.
- E.. INSTALL MOISTURE RESISTANT GREEN BOARD ON BACKBAR WALL PER PROJECT MANUAL.
- F. ALL DOORS SHALL BE 32" (815MM) MINIMUM CLEAR OPENING WHEN OPENED TO 90 DEGREE POSITION UNLESS OTHERWISE NOTED.
- G. SEE SHEET A601 FOR EXTERIOR DOOR AND WINDOW SCHEDULES.
- H. STARBUCKS VENDOR TO PROVIDE DOOR HARDWARE COMPONENTS AND GC TO INSTALL.
- I. VERIFY ALL EXISTING DOORS, HARDWARE AND FRAMES MEET STARBUCKS AND/OR CODE REQUIREMENTS.
- J. PROVIDE FIRE EXTINGUISHERS AS NOTED ON THE APPROVED PLANS FROM THE CITY.
- K. SEE STRUCTURAL FOR KNEE WALL BRACING.
- L. SEE SHEET A501 FOR BUILDING DETAILS.
- M. REFER TO SHEET I104 FOR FLOOR FINISHES.

GENERAL LEGEND

<u> </u>

 $(\mathbf{x}\mathbf{x})$

EXISTING WALL

WALL BLOCKING CALL-OUT


NEW FULL HEIGHT WALL


NEW PARTIAL HEIGHT WALL


WALL SHEATHING CALL-OUT






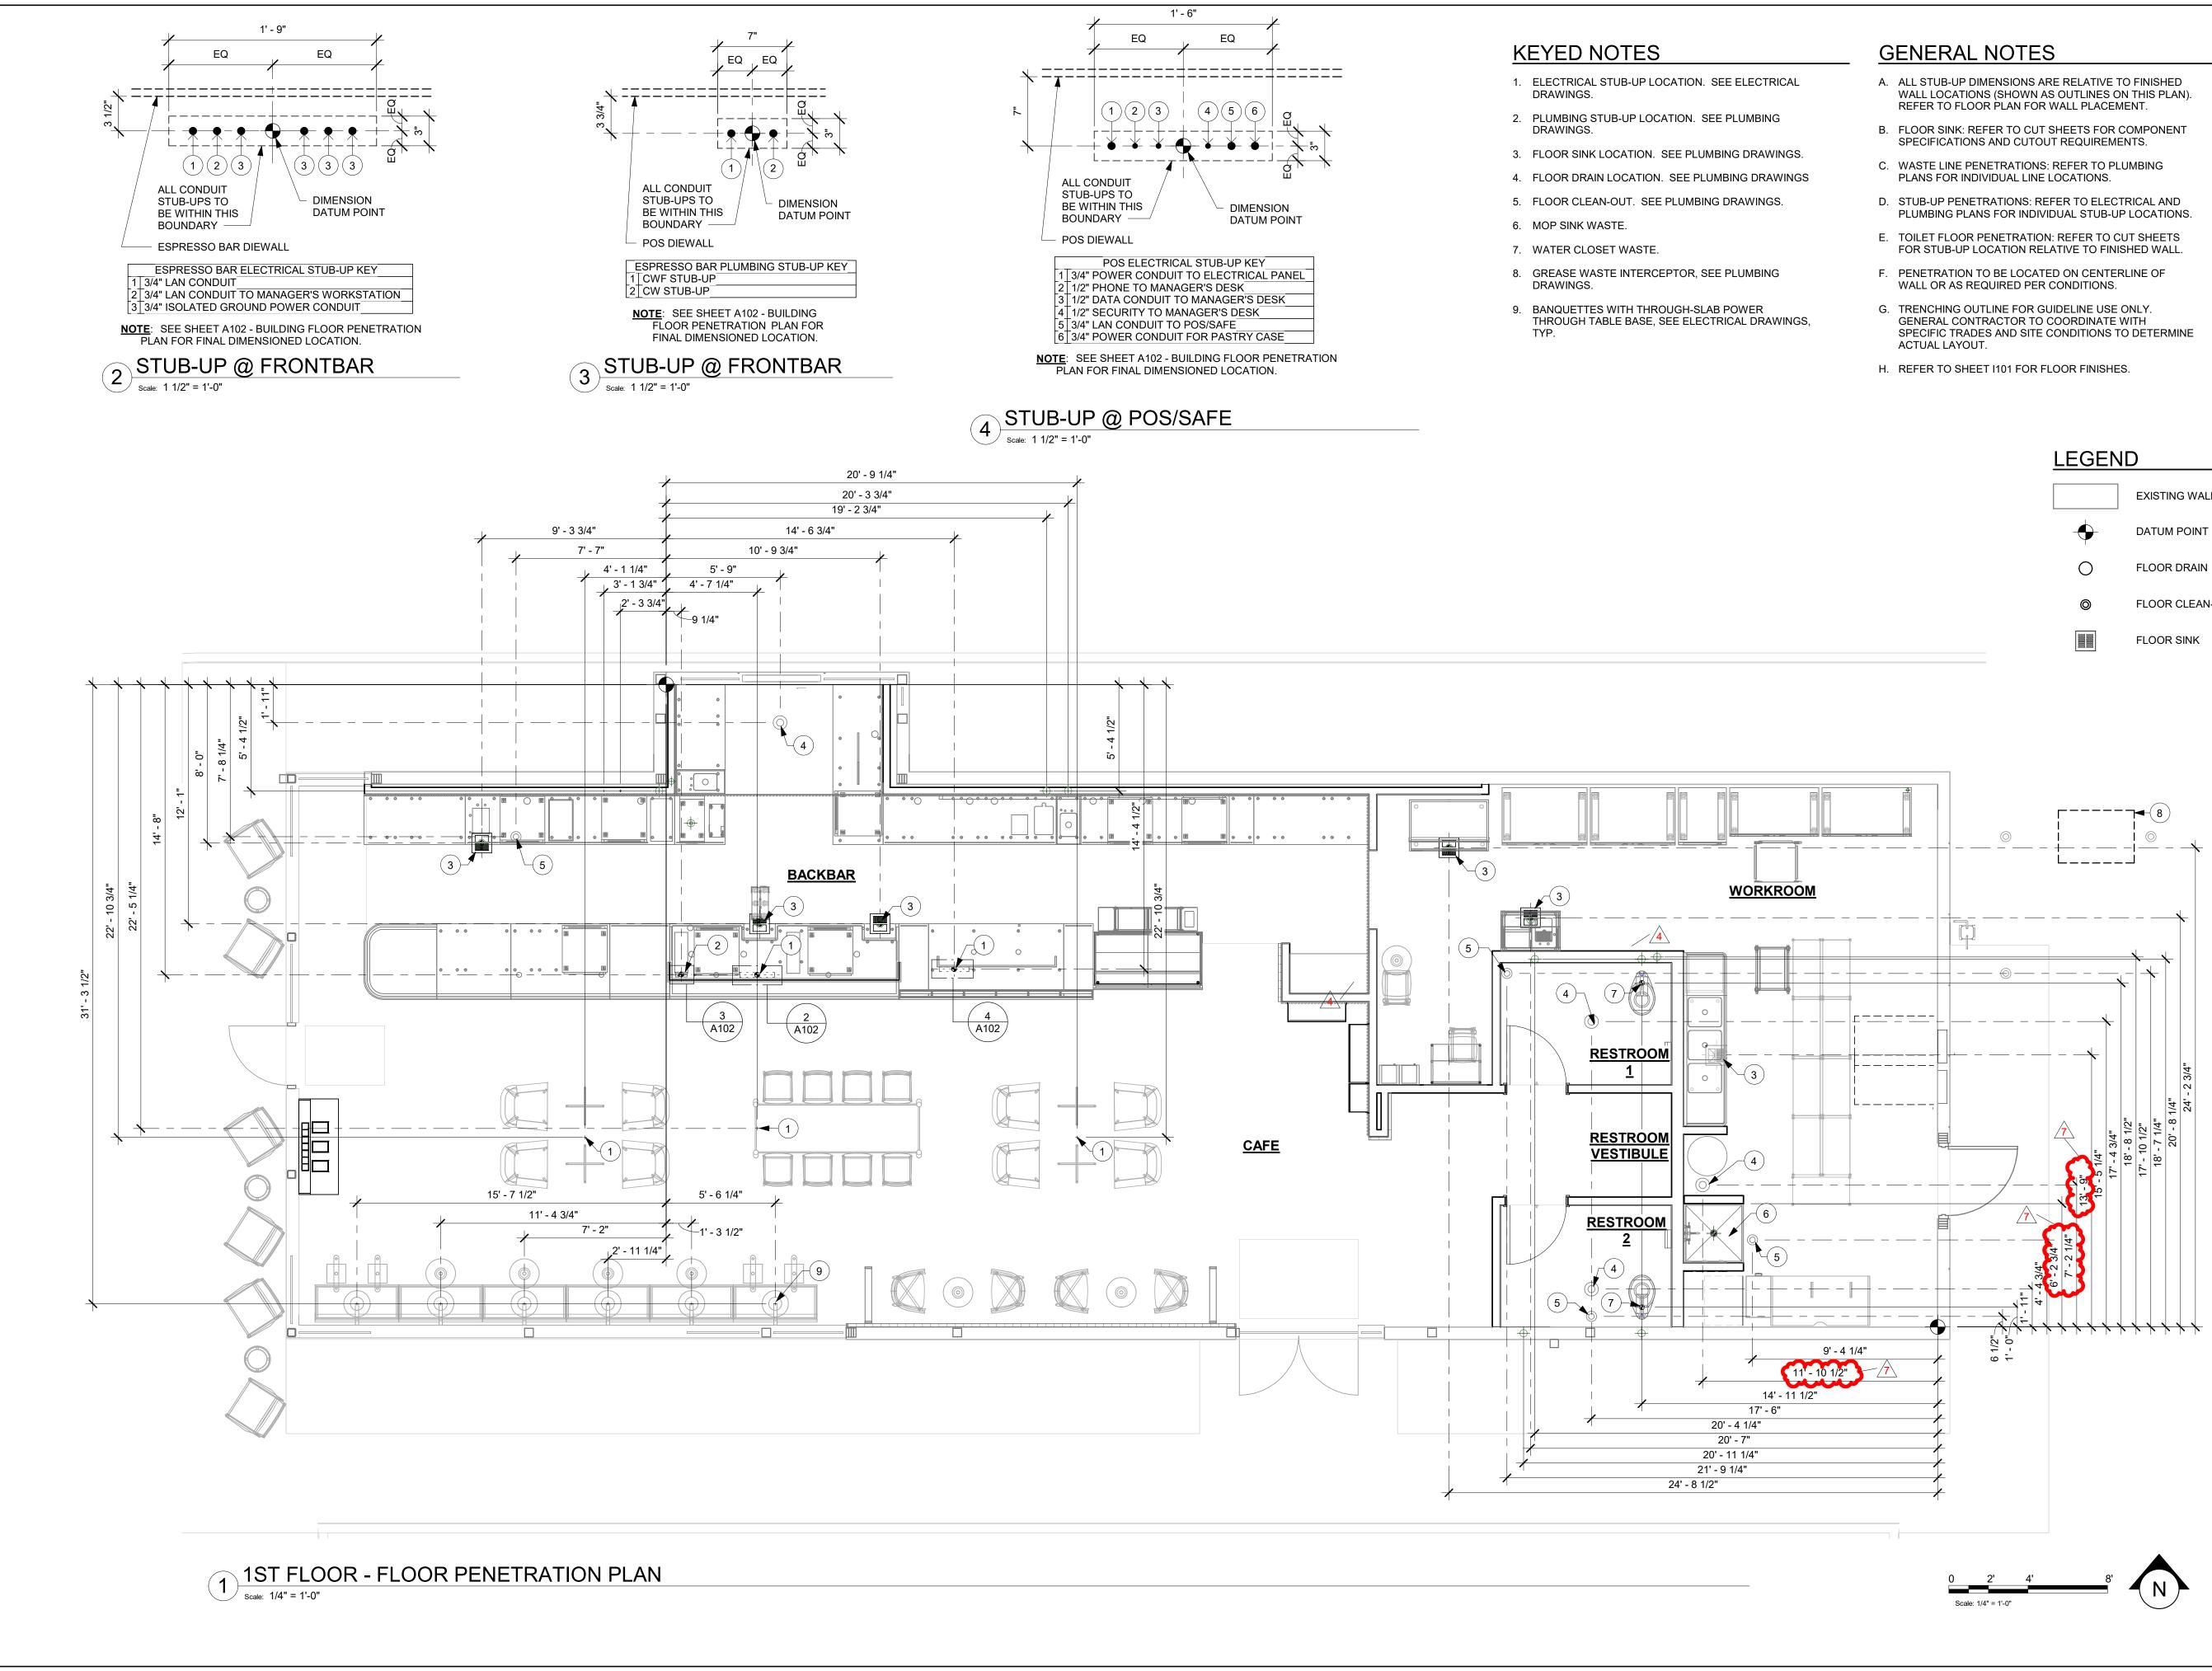


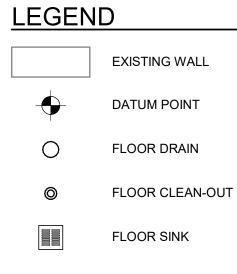

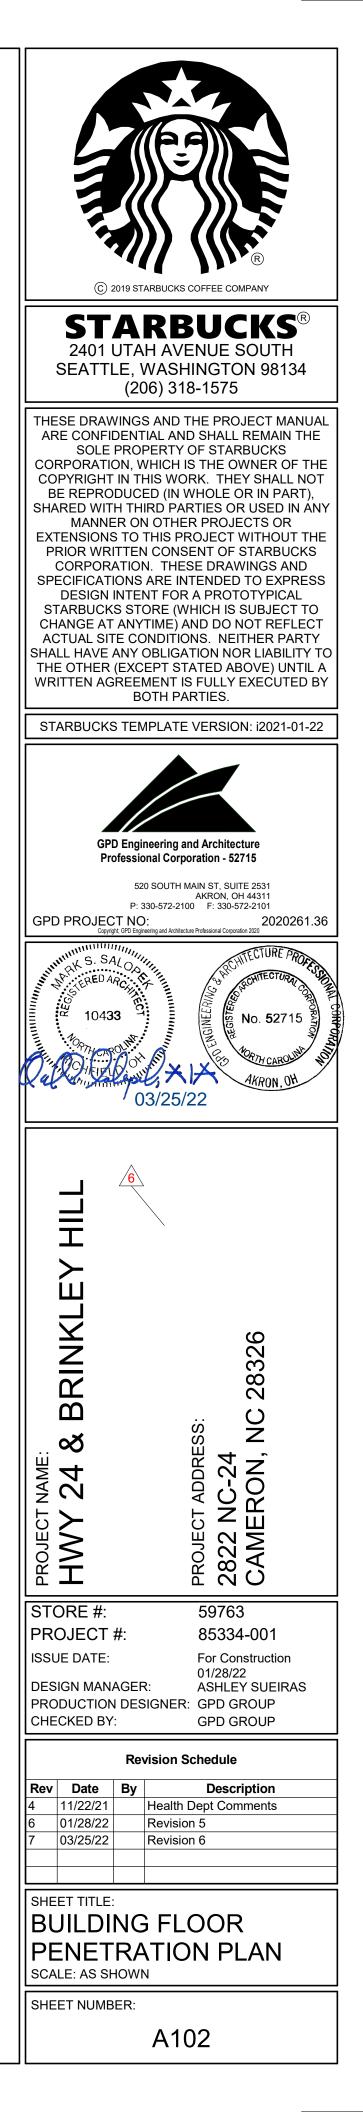

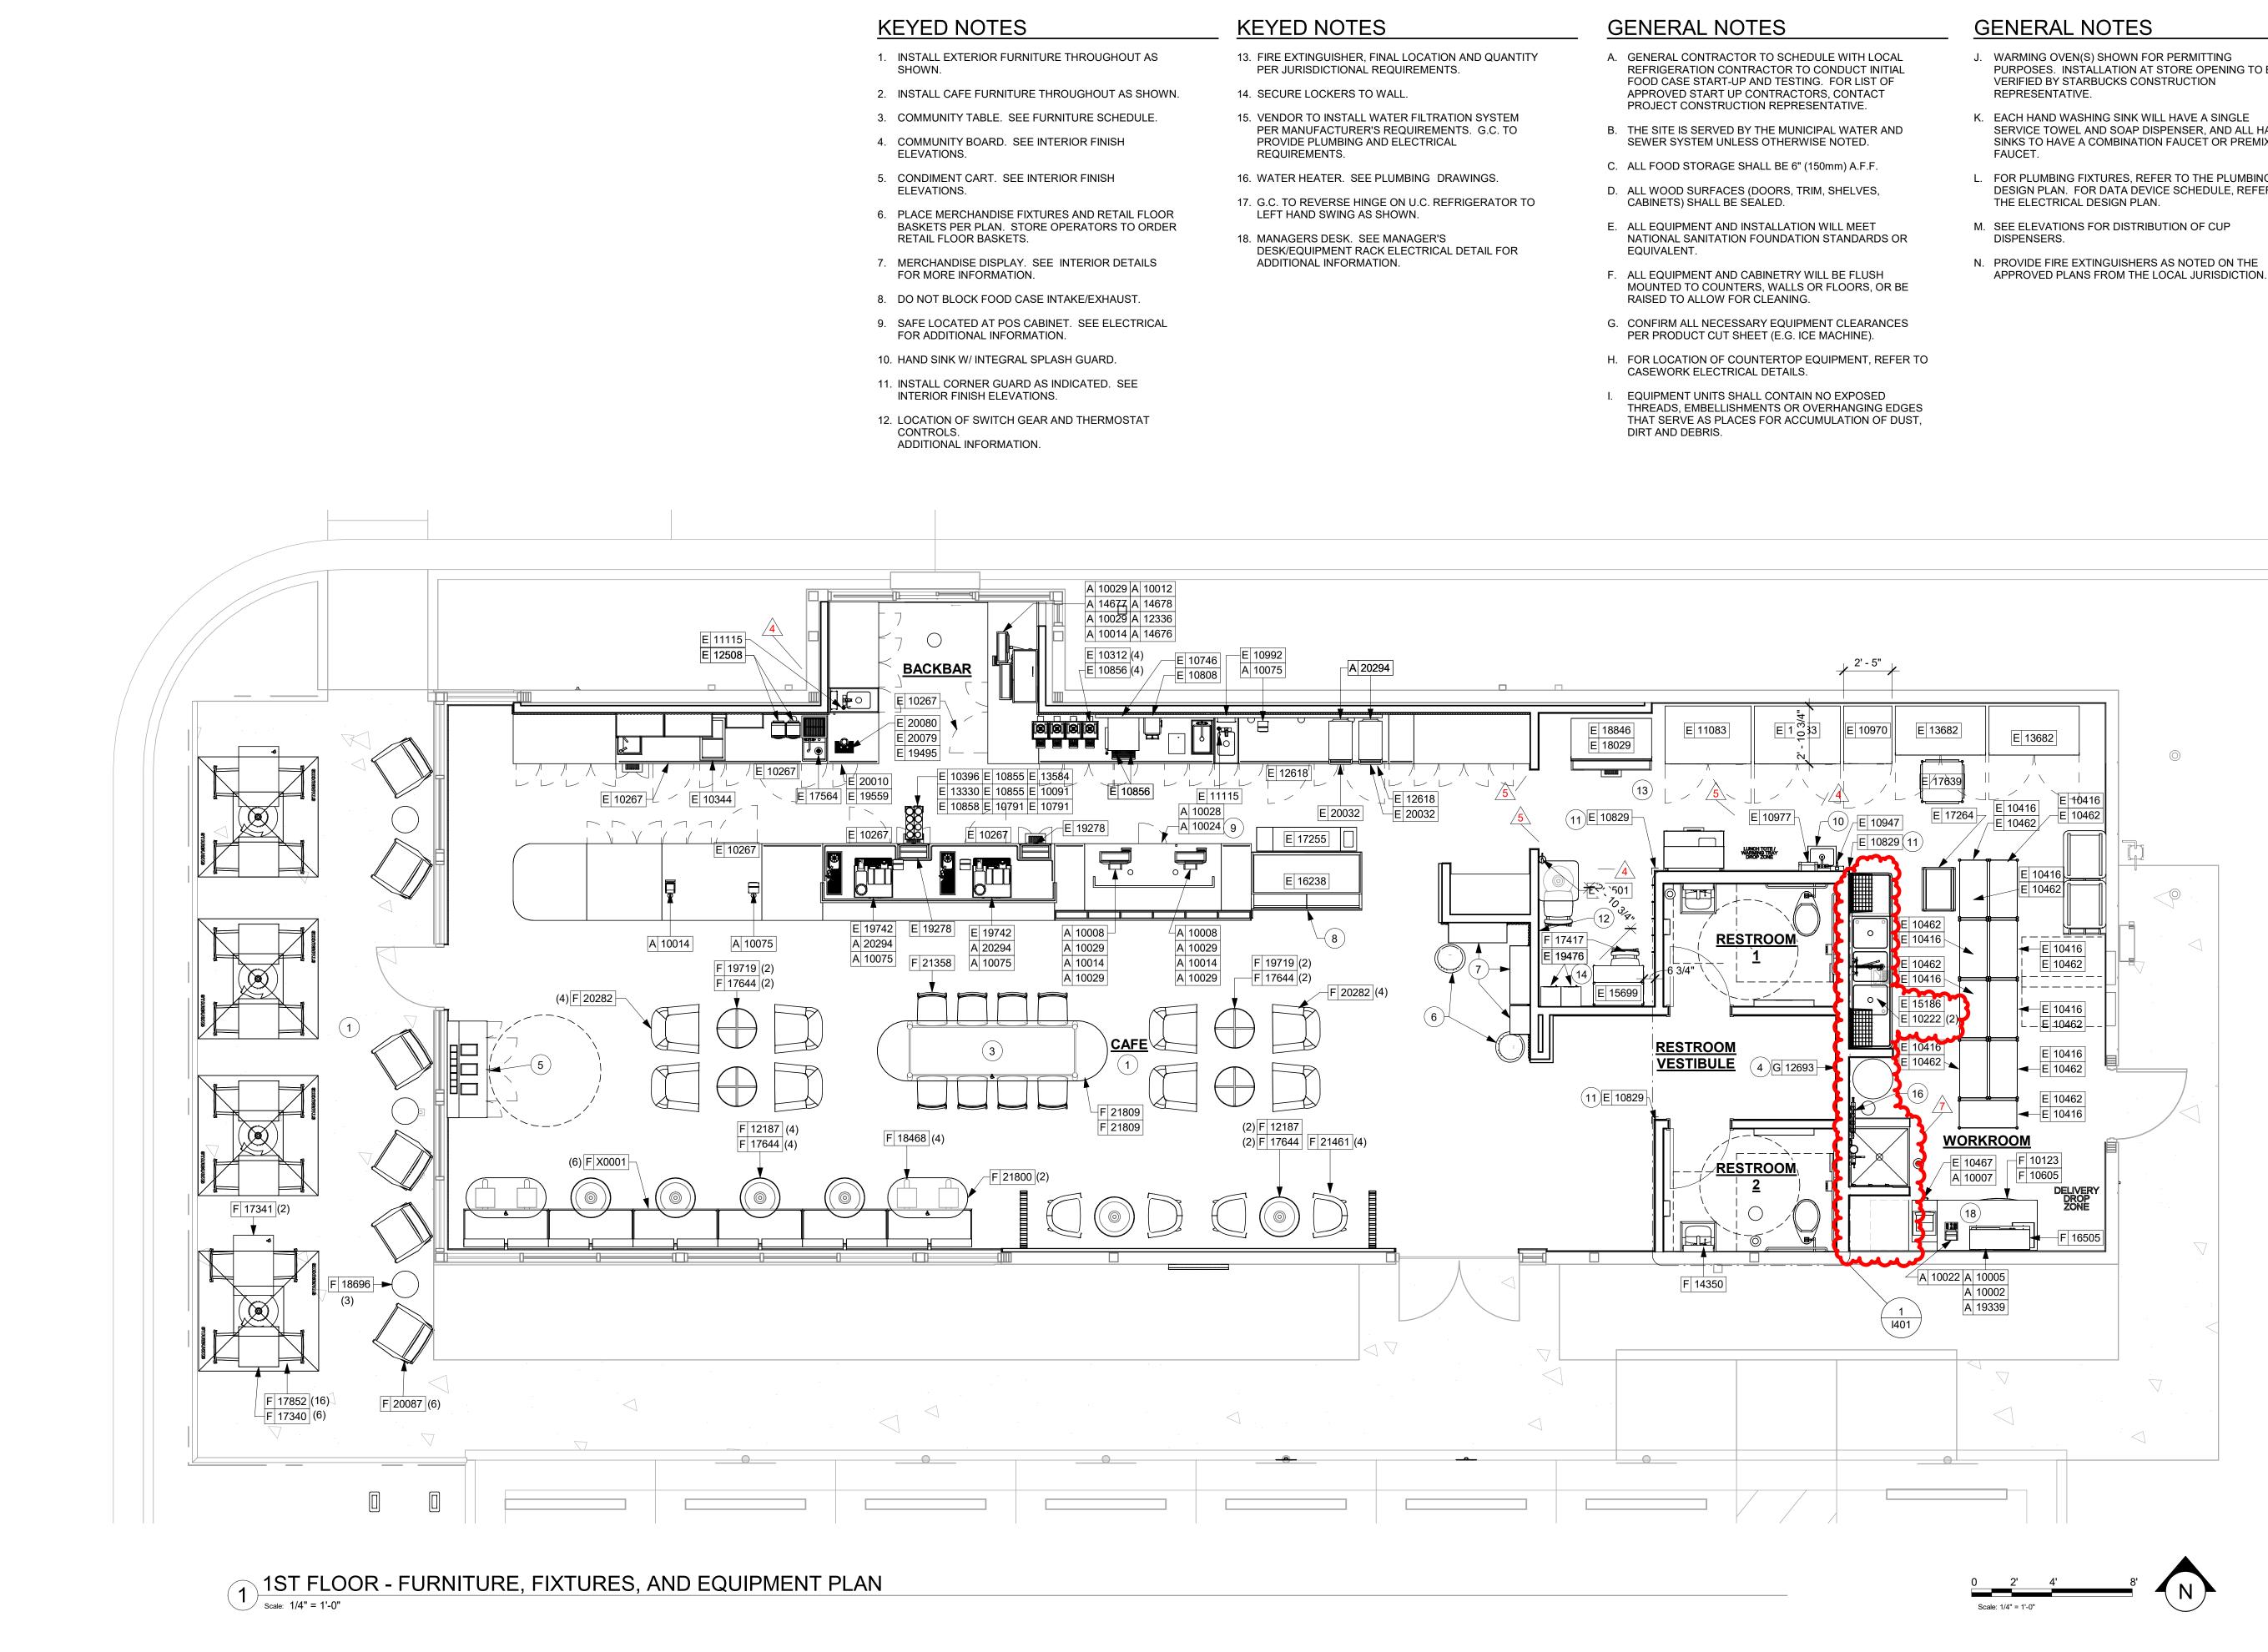


- J. WARMING OVEN(S) SHOWN FOR PERMITTING PURPOSES. INSTALLATION AT STORE OPENING TO BE
- K. EACH HAND WASHING SINK WILL HAVE A SINGLE SERVICE TOWEL AND SOAP DISPENSER, AND ALL HAND SINKS TO HAVE A COMBINATION FAUCET OR PREMIXING
- L. FOR PLUMBING FIXTURES, REFER TO THE PLUMBING DESIGN PLAN. FOR DATA DEVICE SCHEDULE, REFER TO
- N. PROVIDE FIRE EXTINGUISHERS AS NOTED ON THE

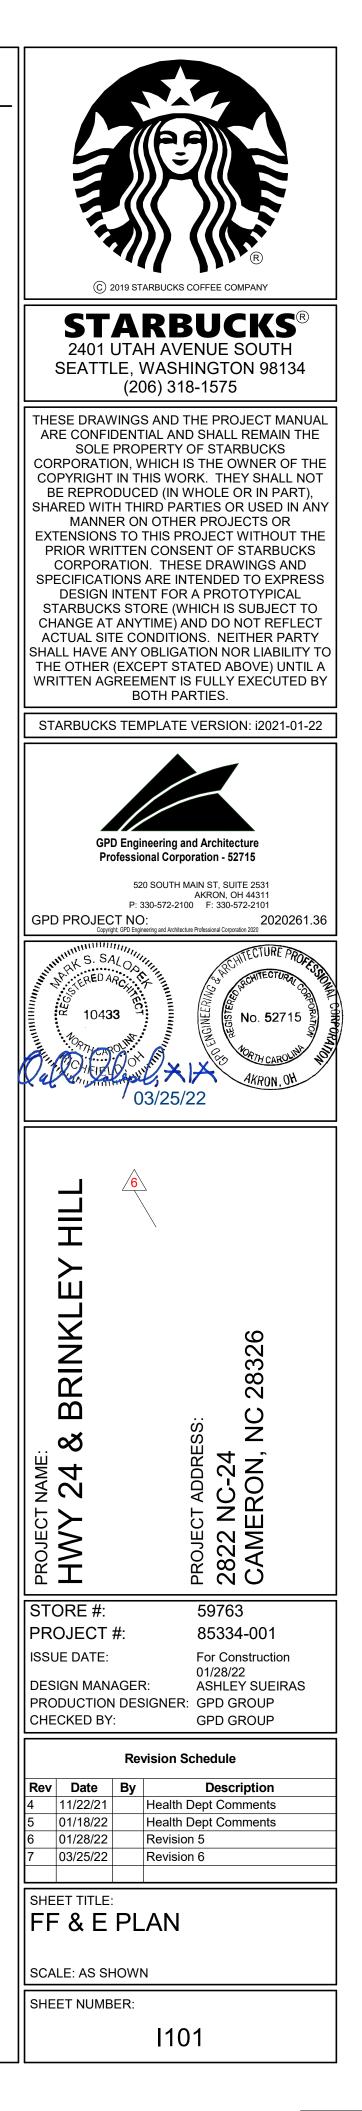


	P/	NNT SC	HEDULE		
DESIGN ID	DESCRIPTION	LRV	FURN. BY	INST. BY	COMMENTS
SW7031 S	6W7031 MEGA GREIGE, OR EQUIVALENT	37	GC		SW USE PRIMER CP-1; NCS - S 3005-Y50R; AKZO NOBEL - 20YY 37/094

	WALL TREATMENT (AREA) SCHEDULE - "Q"						
DESIGN ID	AREA	DESCRIPTION	FURN. BY	INST. BY	COMMENTS		
PLASTIC	PLASTIC						
11469	1595 SF	FRP - WHITE	GC	GC			
TILE		•					
20219	1032 SF	TILE - LUNAR - TITANIUM - 6X24IN 150X600MM	SB	GC	GROUT: MAPEI - 09 GRAY, OR EQUAL		
21046	289 SF	TILE - PENNY ROUND - BLACK SPECKLE - 11X22IN 580X560MM SHEET	SB	GC	GROUT: MAPEI -10 BLACK, OR EQUAL		
WALL COVE	WALL COVERING						
21058	362 SF	VINYL WALL COVERING - ACCORD - MYSTIC	SB	GC			

	WALL BASE SCHEDULE - "B"						
DESIGN ID	LENGTH	DESCRIPTION	FURN. BY	INST. BY	COMMENTS		
TILE BASE							
11403	168' - 2"	TILE BASE - BLACK - 6X12IN 150X305MM	SB	GC	GROUT GR0008: MAPEI 10 - BLACK; LATICRETE 45 - RAVEN; PRETOKOLL - P.FLEX PRETO		
19795	379' - 2 1/2"	POLYVINYL FLOOR TILE - ECOGRIP - PEWTER	GC	GC			
X51001	52' - 7 1/2"	SCHLUTER COVE BASE (TILE-TO-TILE)	GC	GC	LOCATED IN RESTROOMS. SATIN NICKEL. GC TO FIELD VERIFY TOTAL LENGTH PRIOR TO ORDERING		

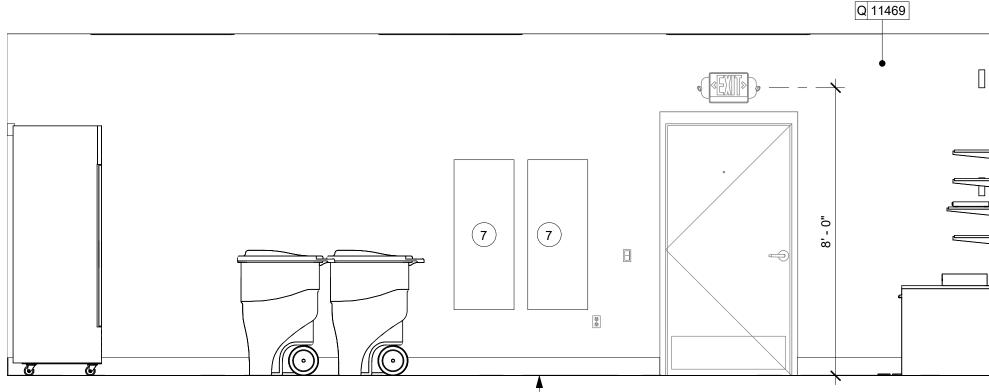




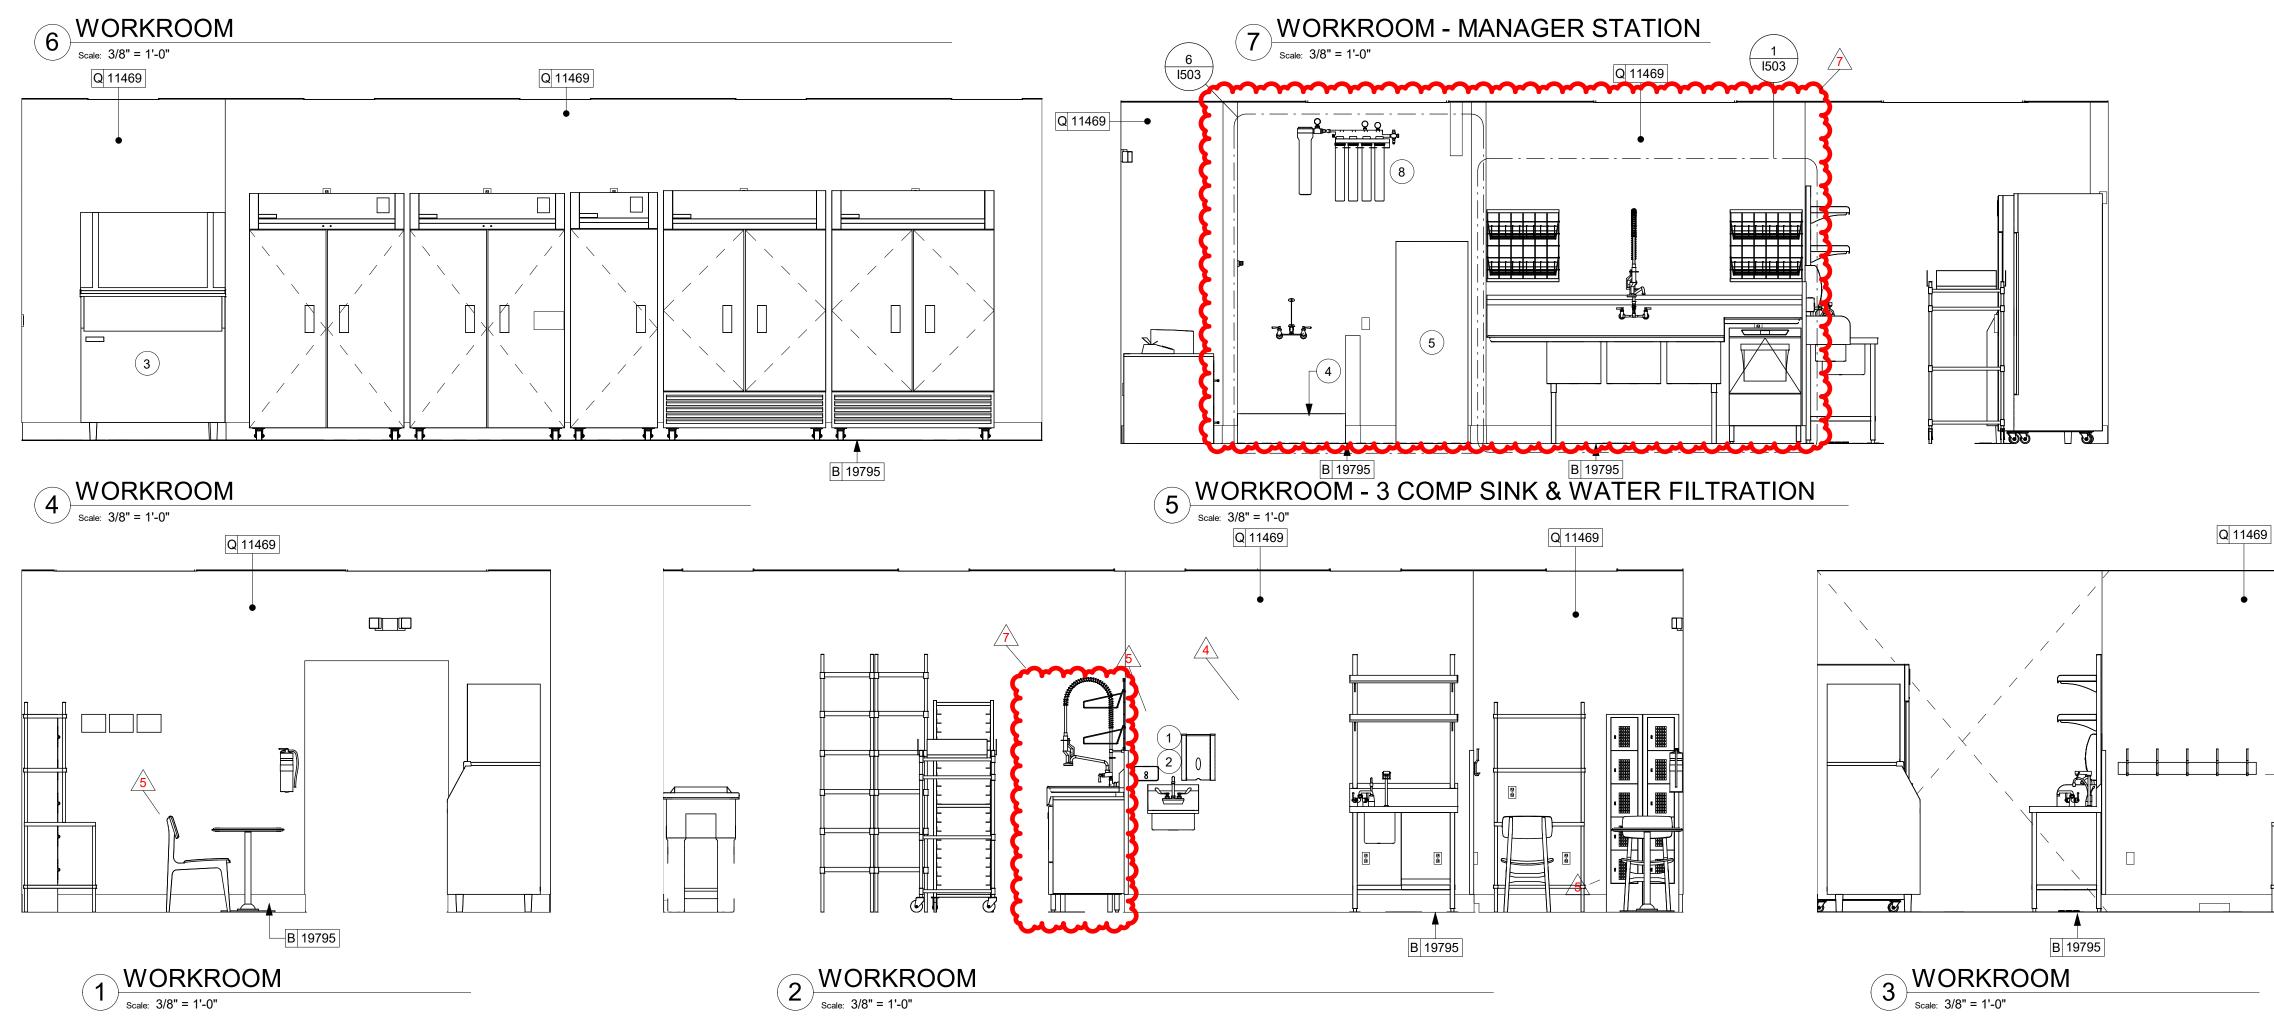

49

KEYED NOTES


- 1. PROVIDE 6" (150MM) MIN. INTEGRAL SPLASHGUARD AT HAND SINK PER JURISDICTIONAL REQUIREMENTS.
- 2. WALL MOUNT HAND SINK WITH SOAP AND PAPER TOWEL DISPENSER. G.C. TO PROVIDE BLOCKING FOR FASTENERS.
- 3. ICE MACHINE (SEE PLUMBING AND ELECTRICAL DRAWINGS FOR ADDITIONAL INFORMATION).
- 4. MOP SINK. FULL HEIGHT FRP AT ENCLOSURE (SEE PLUMBING PLANS FOR MORE INFORMATION).
- 5. WATER HEATER (SEE PLUMBING DRAWINGS).
- 6. MANAGER'S DESK (SEE ENLARGED DETAILS).
- 7. ELECTRICAL PANELS (SEE ELECTRICAL DRAWINGS FOR ADDITIONAL INFORMATION).
- 8. WATER FILTRATION EQUIPMENT (SEE PLUMBING DRAWINGS).

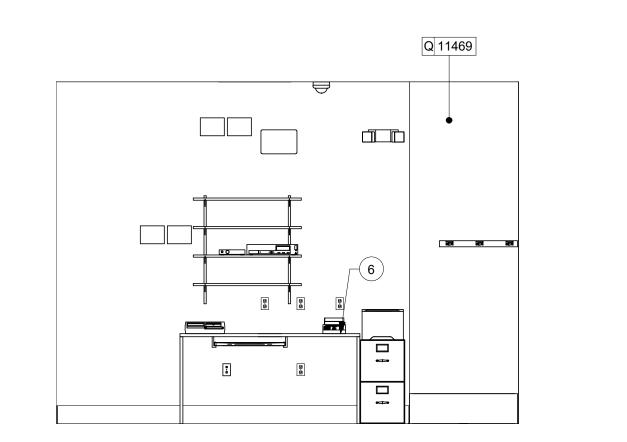


GENERAL NOTES

- A. FOR GRAPHICS SCHEDULE. REFER TO THE FURNITURE. FIXTURES, AND EQUIPMENT (FF & E) SCHEDULES ON SHEET 1601.
- B. REFER TO MANUFACTURER'S INSTRUCTIONS INCLUDED WITH ARTWORK/GRAPHICS FOR PROPER INSTALLATION.
- C. CHANGE PAINT COLOR ONLY AT INSIDE CORNERS UNLESS OTHERWISE INDICATED.
- D. PAINT FINISHES SHALL BE APPLIED AS FOLLOWS,
- UNLESS NOTED OTHERWISE: 1) WOODS AND METAL SURFACES SHALL BE SEMI-GLOSS OR EQUAL.
- 2) ACCENT AND TRIM PAINTS TO BE SEMI-GLOSS OR EQUAL. a. WALL AND CEILING PAINTS TO BE EGGSHELL OR
- EQUAL. 3) PAINTS IN BOH, RESTROOM(S) OR CAFE BAR SHALL BE SEMI-GLOSS OR EQUAL.
- E. PAINT SUBSTITUTIONS ARE NOT ALLOWED. USE STARBUCKS NATIONAL ACCOUNT COLOR CODE WHEN ORDERING PAINTS.
- F. FLOORS, WALLS AND CEILING FINISHES IN FOOD PREPARATION AREAS SHALL BE SMOOTH, NON-TOXIC, NON-ABSORBENT, DURABLE AND EASILY CLEANABLE. PAINT SHALL BE WASHABLE; SEMI-GLOSS OR HIGH GLOSS FINISH.
- G. ALL WOOD SURFACES (DOORS, TRIM, SHELVES, CABINETRY) SHALL BE SEALED.
- H. REFER TO CASEWORK FINISH SCHEDULE ON THE CASEWORK FINISH PLAN ON SHEET I102 FOR CASEWORK FINISH MATERIAL INFORMATION.
- I. ALIGN TILE TRANSITIONS ON WHOLE TILES AS SHOWN. J. ALL FLOOR AND WALL JUNCTIONS IN STORAGE AND
- FOOD PREPARATION AREAS SHALL HAVE A 6" COVED BASE.
- K. ALL FOOD STORAGE SHALL BE 6" (150MM) A.F.F.
- L. INSTALL BLOCKING AND HANGERS FOR WALL SHELVING BEFORE INSTALLING BACK BAR TILE.
- M. GENERAL CONTRACTOR TO PROVIDE AND INSTALL WORKROOM WALL FINISHES.



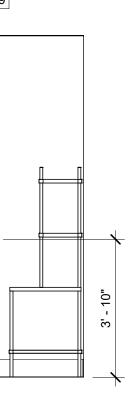

DESIGN ID	DESCRIPTION	VOLTAGE	WATTAGE	CIRCUIT BREAKER SIZE	PANEL	CIRCUIT NUMBER	WIRE SIZE
10267	1 DOOR UNDERCOUNTER REFRIGERATOR	120V	500	20A	В	1	2#12, 1#12G, 3/4"(
10267	1 DOOR UNDERCOUNTER REFRIGERATOR	120V	500	20A	В	3	2#12, 1#12G, 3/4"(
10267	1 DOOR UNDERCOUNTER REFRIGERATOR	120V	500	20A	В	15	2#12, 1#12G, 3/4"(
10267	1 DOOR UNDERCOUNTER REFRIGERATOR	120V	500	20A	В	34	2#12, 1#12G, 3/4"
10267	1 DOOR UNDERCOUNTER REFRIGERATOR	120V	500	20A	В	40	2#12, 1#12G, 3/4"
10267	1 DOOR UNDERCOUNTER REFRIGERATOR	120V	500	20A	В	43	2#12, 1#12G, 3/4"
10312	BREWER SOFT HEAT WARMING STAND	120V	90	20A	В	16	2#12, 1#12G, 3/4"
10312	BREWER SOFT HEAT WARMING STAND	120V	90	20A	В	16	2#12, 1#12G, 3/4"
10312	BREWER SOFT HEAT WARMING STAND	120V	90	20A	В	16	2#12, 1#12G, 3/4"
10312	BREWER SOFT HEAT WARMING STAND	120V	90	20A	В	16	2#12, 1#12G, 3/4"
10746	DUAL BREWER SOFT HEAT	208V	8200	50A	В	18,20	3#6, 1#10G, 3/4"(
10808	GRINDER	120V	1400	20A	В	19	2#12, 1#12G, 3/4
10970	1 DOOR REACH-IN REFRIGERATOR	120V	1200	20A	А	39	2#12, 1#12G, 3/4
11083	2 DOOR REACH-IN REFRIGERATOR	120V	1200	20A	А	35	2#12, 1#12G, 3/4"
11083	2 DOOR REACH-IN REFRIGERATOR	120V	1200	20A	А	37	2#12, 1#12G, 3/4"
20032	EIKON WARMING OVEN	208V	6000	30A	В	24,26	2#10, 1#10G, 3/4"
20032	EIKON WARMING OVEN	208V	6000	30A	В	25,27	2#10, 1#10G, 3/4"
12508	ON-COUNTER BLENDER	120V	1800	20A	В	4	2#12, 1#12G, 3/4"
12508	ON-COUNTER BLENDER	120V	1800	20A	В	5	2#12, 1#12G, 3/4"
12618	1 DOOR UNDERCOUNTER REFRIGERATOR	120V	500	20A	В	23	2#12, 1#12G, 3/4"
12618	1 DOOR UNDERCOUNTER REFRIGERATOR	120V	500	20A	В	28	2#12, 1#12G, 3/4"
13682	2 DOOR REACH-IN FREEZER	120V	1160	20A	А	40	2#12, 1#12G, 3/4"
13682	2 DOOR REACH-IN FREEZER	120V	1160	20A	А	41	2#12, 1#12G, 3/4"
15186	DISHWASHER	208V	6344	40A	А	31,33	3#8, 1#10G, 3/4"(
16238	ZEPHYR FOOD CASE	208V	1000	20A	В	29,31	2#12, 1#12G, 3/4"
18846	ICE MACHINE	208V	3600	30A	А	36,38	2#10, 1#100G, 3/4
19559	NITROGEN GENERATOR	120V	500	20A	В	7	2#12, 1#12G, 3/4"
19742	MASTRENA ESPRESSO MACHINE	208V	5800	50A	В	39,41	2#6, 1#10G, 3/4"(
19742	MASTRENA ESPRESSO MACHINE	208V	5800	50A	В	35,37	2#6, 1#10G, 3/4"(
20010	NITRO COOLER	120V	500	20A	В	8	2#12, 1#12G, 3/4"

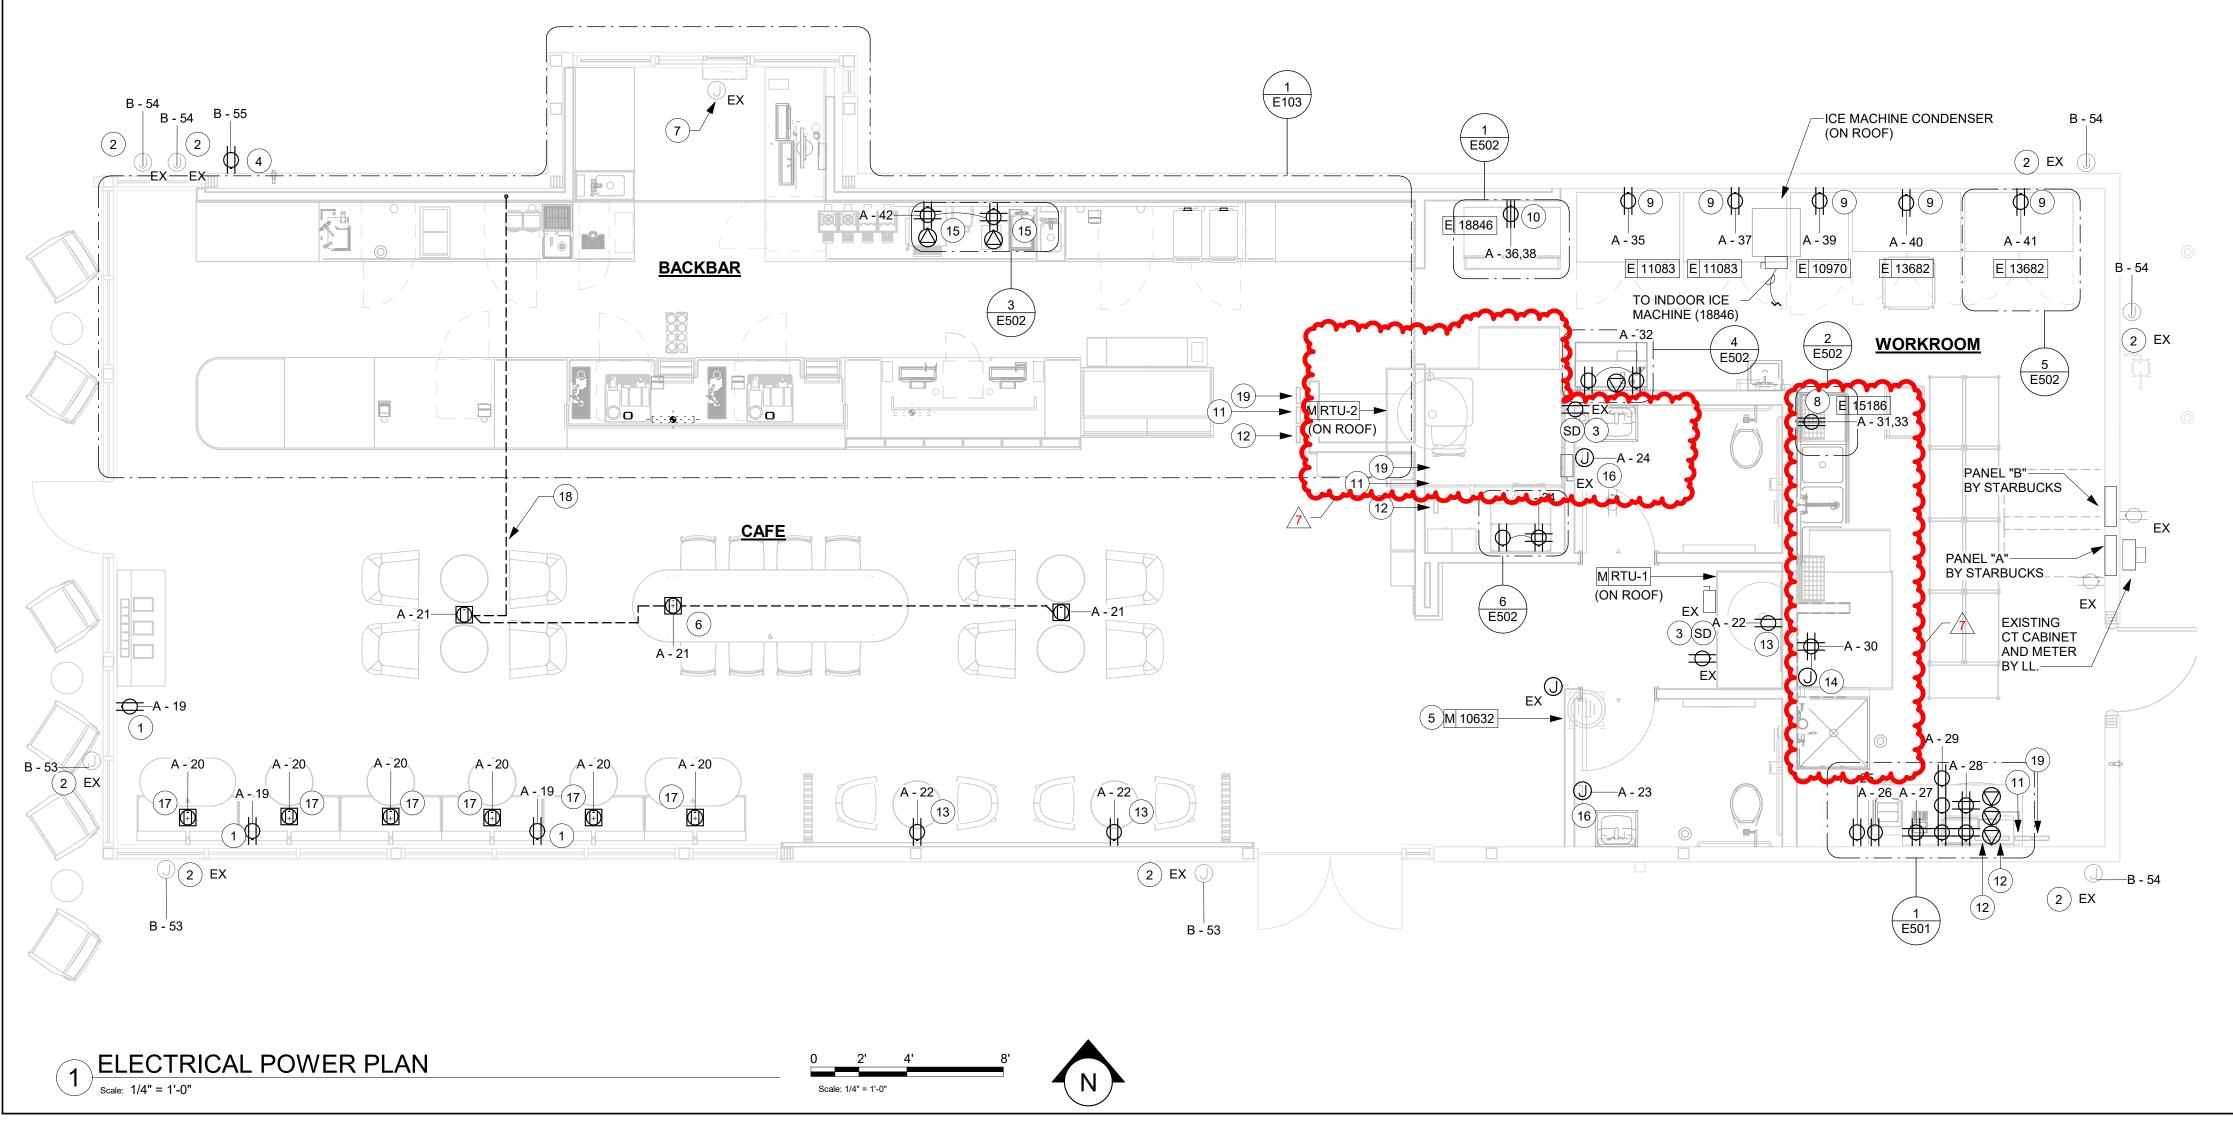

KEYED NOTES

- 1. SHOW WINDOW RECEPTACLE TO BE MOUNTED ABOVE WINDOWS.
- 2. EXTERIOR SIGNAGE. COORDINATE WITH SIGNAGE VENDOR/MANUFACTURER FOR CONNECTION AND POWER REQUIREMENTS. SEE ARCH PLANS FOR LOCATION. PROVIDE ALL PENETRATIONS AND CONNECTIONS, CONCEAL FROM VIEW. E.C. SHALL PROVIDE DISCONNECT SWITCH IF NOT PROVIDED PER CODE.
- 3. DUCT SMOKE DETECTOR. COORDINATE WITH MECHANICAL FOR QUANTITY AND HVAC INTERLOCK SHUT DOWN.
- 4. GFCI AND WP RECEPTACLE AT 18" AFF.
- 5. EXHAUST FAN. FAN TO RUN CONTINUOUSLY DURING OCCUPIED MODE. RUN THROUGH RESTROOM LIGHTING CONTROLS. COORDINATE WITH MECHANICAL.
- 6. FLOOR BOX (HUBBEL #S1CCFB OR EQUAL) WITH FLUSH FLOOR BOX COVER FOR WIRE MOLD AT COMMUNITY TABLE AND BANQUETTE. ROUTE FLEX CONDUIT TO CONNECTION POINT. SEE ARCH. DETAILS FOR LOCATION.
- 7. DT AIR CURTAIN BY LL.
- 8. DISH WASHER. E.C. SHALL PROVIDE 14-50R RECEPTACLE AND CORD @18" AFF.

9.	MOUNT REFRIG./FREEZER RECEPTACLE AT 84" AFF.	
10.	ICE MACHINE WITH REMOTE CONDENSER (ON ROOF) COORDINATE WITH MANUFACTURER SPECS FOR REQUIREMENTS AND CONNECTION. PROVIDE A RECEPTACLE AT 72" AFF.	
11.	CO2 SENSOR AND ALARM. COORDINATE WITH MECHANICAL FOR POWER REQUIREMENTS.	
12.	THEROMSTAT AND SENSOR. PROVIDE JUNCTION BOX FOR CONNECTION.	
13.	TAMPER RESISTANT CONVENIENCE OUTLET AT 18" AFF.	
14.	POWER FOR WATER HEATER/FILTRATION SYSTEM. PROVIDE POWER FOR RECIRCULATION PUMP IN CEILING AS NEEDED AND TOGGLE SWITCH FOR DISCONNECTION MEANS. SEE INTERIOR DETAILS FOR MORE INFORMATION.	
15.	POWER AND DATA FOR FUTURE MENU BOARDS. RUN SIX ETHERNET CABLES ABOVE CEILING TO DATA RACK. PROVIDE 120V, 20A CIRCUIT FOR POWER. SEE BACKBAR MENU DETAIL FOR MORE INFORMATION.	
16.	POWER FOR RESTROOM HAND DRYERS. COORDINATE WITH MANUFACTURER SPECIFICATIONS AND INTERIOR ELEVATIONS.	
17.	POWER FOR BANQUETTE SEATING. COORDINATE WIRE REQUIREMENTS WITH MANUFACTURER.	
18.	1" UNDERGROUND SCHED. 40PVC CONDUIT. ROUTE TO WALL AND TO ABOVE CEILING. CONDUIT AND WIRING TO BE PROVIDED BY E.C.	
19.	CO SENSOR AND ALARM. COORDINATE WITH MECHANICAL FOR POWER REQUIREMENTS.	

GENERAL NOTES

A. REFER TO ELECTRICAL DETAIL SHEETS FOR EXACT LOCATIONS AND MOUNTING HEIGHTS OF ELECTRICAL DEVICES.

- B. THE ELECTRICAL CONTRACTOR IS RESPONSIBLE FOR CONFIRMING ALL VOLTAGE REQUIREMENTS ON ALL EQUIPMENT AND PROVIDING BUCK-BOOST TRANSFORMERS AS MAY BE NEEDED FOR CODE. ALL ARE NOT NECESSARILY INDICATED.
- C. ELECTRICAL CONTRACTOR SHALL COORDINATE WITH PLUMBING AND HEATING, VENTILATING, AND AIR CONDITIONING (HVAC) CONTRACTORS FOR ANY ADDITIONAL EQUIPMENT NEEDING POWER.
- D. ANY EQUIPMENT NOTED AS 'FUTURE' SHALL BE PROVIDED WITH APPROPRIATE RECEPTACLES AND WIRING TO ENABLE FUTURE OPERATION.
- GROUND FAULT CIRCUIT INTERRUPTER (GFCI) BREAKERS (NOT RECEPTACLES) SHALL BE UTILIZED WHERE REQUIRED BY CODE AND AT ANY FLOOR BOXES. PROVIDE DEDICATED NEUTRAL WIRE FOR ALL THESE CIRCUITS.
- F. EQUIPMENT REQUIRES CONNECTION TO THE BUILDING ELECTRICAL SYSTEM. FURNISH AND INSTALL ALL NECESSARY CONDUIT, WIRE, CONNECTIONS, RECEPTACLES AND OVERCURRENT PROTECTION NECESSARY TO ENSURE THE EQUIPMENT FUNCTIONS PROPERLY AND COMPLIES WITH ALL APPLICABLE LOCAL AND NATIONAL CODES. COORDINATE EQUIPMENT REQUIREMENTS WITH MANUFACTURER CUT SHEET PRIOR TO ROUGH-IN.
- G. ALL FRONT BAR J-BOXES AND OUTLETS SHALL BE SURFACE MOUNTED. PROVIDE CONDUITS AS NEEDED AND ONE (1) ADDITIONAL SPARE CONDUIT BETWEEN ALL J-BOXES FOR FUTURE ELECTRICAL REQUIREMENTS. ALL J-BOXES SHALL BE POSITIONED TO AVOID OBSTRUCTION OF ANY EQUIPMENT SUCH AS REFRIGERATORS AND DISHWASHERS.
- H. REFERENCE LANDLORD WORK LETTER FOR DIVISION OF ELECTRICAL SCOPE OF WORK AND COORDINATE WITH STARBUCKS CONSTRUCTION MANAGER.

ELECTRICAL SCOPE OF WORK SUMMARY

THE FOLLOWING SCOPE OF WORK IS BASED ON THE LANDLORD'S WORK LETTER EXHIBIT C. THIS SCOPE OF WORK IS NOT INTENDED TO INDICATE THE FULL SCOPE, BUT ONLY A BROAD SUMMARY. THE GENERAL CONTRACTOR SHALL REFERENCE THE COMPLETE WORK LETTER FOR A MORE DETAILED DESCRIPTION OF WORK BY BOTH PARTIES. ANY QUESTIONS REGARDING SCOPE SHALL BE BROUGHT TO STARBUCKS ATTENTION FOR CLARIFICATION. RESPONSIBILITY INDICATED BELOW MEANS FURNISHED, PERMITTED AND INSTALLED BY THE PARTY INDICATED.

	RESPO	NSIBILITY
WORK DESCRIPTION	LANDLORD	STARBUCKS
MAIN BUILDING SERVICE AND POWER METER	х	
ELECTRICAL PANELS AND FEEDERS		х
TEMPORARY POWER	Х	
ELECTRICAL PANEL BREAKERS		X
ABOVE FLOOR BRANCH CIRCUIT DISTRIBUTION		x
UNDER-FLOOR / SLAB POWER CONDUITS IN BUILDING (WIRING BY STARBUCKS)	Х	
UNDERGROUND SITE CONDUITS FOR DT, SIGNS, MENU BOARD, DETECTOR LOOP & DCB (WIRING / CABLING BY STARBUCKS)	х	
SITE LIGHTING	Х	
EXTERIOR BUILDING & PATIO LIGHTING	Х	
DATA & PHONE SERVICE, DMARC & (2) 2" CONDUITS TO STARBUCKS SPACE	Х	
DT WINDOW POWER	Х	
DT WINDOW EXTERIOR LIGHTS (2 EACH)	х	
FIRE ALARM SYSTEM	Х	



PLUMBING SCOPE OF WORK SUMMARY

THE FOLLOWING SCOPE OF WORK IS BASED ON THE LANDLORD'S WORK LETTER EXHIBIT C. THIS SCOPE OF WORK IS NOT INTENDED TO INDICATE THE FULL SCOPE, BUT ONLY A BROAD SUMMARY. THE GENERAL CONTRACTOR SHALL REFERENCE THE COMPLETE WORK LETTER FOR A MORE DETAILED DESCRIPTION OF WORK BY BOTH PARTIES. ANY QUESTIONS REGARDING SCOPE SHALL BE BROUGHT TO STARBUCKS ATTENTION FOR CLARIFICATION. RESPONSIBILITY INDICATED BELOW MEANS FURNISHED, PERMITTED AND INSTALLED BY THE PARTY INDICATED.

WORK DESCRIPTION	RESPONSIBILITY		
WORK DESCRIPTION	LANDLORD	STARBUCKS	
WATER SERVICE AND METER	X		
BOOSTER PUMP FOR WATER SERVICE	x		
BELOW FLOOR / SLAB WASTE, VENT AND WATER PIPES	x		
ABOVE FLOOR / SLAB WASTE, VENT AND WATER PIPES	x		
PLUMBING VENT(S) THROUGH ROOF	x		
EXTERIOR HOSE BIBB(S)	X		
BASE COVERAGE SPRINKLER SYSTEM	x		
SPRINKLER SYSTEM MODIFICATIONS FOR TENANT BUILDOUT	x		

KEYED NOTES


- 1. WATER HEATER: ROUTE 1" COLD AND HOT WATER FROM WATER HEATER, UP IN CEILING SPACE. WATER HEATER INSTALLATION SHALL BE INCOMPLIANCE WITH APPLICABLE CODES AND ORDINANCES, REFER TO WATER HEATER DETAIL.
- 2. MOP SINK:

ROUTE 1/2" HOT AND COLD DOWN IN WALL AND CONNECT TO MOP SINK FAUCET. PROVIDE APPROVED BACKFLOW PREVENTION DEVICE ON SERVICE FAUCET AS REQUIRED. CAULK AND SEAL BACK OF SINK TO WALL.

- 3. WATER FILTER: ROUTE 3/4" COLD WATER DOWN IN WALL AND CONNECT TOWATER FILTER, EXTEND 3/4" FILTERED COLD WATER FROM WATER FILTER UP IN WALL TO CEILING SPACE. PLUMBING CONTRACTOR TO FOLLOW MANUFACTURERS INSTALLATION INSTRUCTIONS AND ACTIVATION PROCEDURES FOR FILTERS. INSTALL ASSEMBLY ON WALL, REFER TO WATER FILTER DETAIL.
- 4. 3-COMPARTMENT SINK: ROUTE 1/2" HOT AND COLD WATER DOWN IN WALL AND CONNECT TO FAUCET AND OVERHEAD SPRAY. CAULK AND SEAL BACK OF SINK TO WALL.
- 5. SANITIZER: ROUTE 3/4" COLD WATER DOWN IN WALL AND STUB OUT AT 18" A.F.F. PROVIDE WITH SHUT-OFF VALVE WITH 3/4" MALE HOSE-END FITTING. SHUT-OFF TO INCLUDE PRESSURE REDUCING VALVE ASSE 1022 COMPATIBLE, PRESSURE GAUGE (SET @ 20 PSIG, +/-5 PSIG), LINE STRAINER, AND SHOCK ARRESTOR IN ALL CONNECT SANITIZER TO HW SUPPLY WITH 72" LONG BRAIDED STAINLESS STEEL HOSE. PROVIDE ASSE 1070 MIXING VALVE. PROVIDE AND INSTALL ANY ADDITIONAL PIPING AND DEVICES AS REQUIRED FOR COMPLETE INSTALLATION.
- 6. ICE MACHINE: ROUTE 1/2" FILTERED COLD WATER DOWN IN WALL AND CONNECT TO ICE MACHINE, PROVIDE WITH REQUIRED BACKFLOW PREVENTION DEVICE. CONTRACTOR SHALL SUPPLY AND INSTALL 3/8" BRAIDED STAINLESS STEEL SUPPLY FROM SHUT-OFF TO MACHINE.

7. HAND SINK/LAVATORY: TO WALL.

- 8. COFFEE BREWER: ROUTE 1/2" FILTERED COLD WATER DOWN IN WALL. CONTRACTOR SHALL PROVIDE AND INSTALL SHUT-OFF VALVE IN CABINET AT 24" A.F.F. CONTRACTOR SHALL SUPPLY AND INSTALL 3/8" BRAIDED STAINLESS STEEL SUPPLY LINE FROM SHUT-OFF VALVE TO MACHINE.
- 9. ESPRESSO MACHINE: ROUTE 1/2" FILTERED COLD WATER IN CASEWORK AND CONNECT TO ESPRESSO MACHINE. PROVIDE AND INSTALL BRAIDED STAINLESS STEEL HOSE FROM SHUT-OFF VALVE TO PUMP AND FROM PUMP TO ESPRESSO MACHINE'S WATER INLET.
- 10. DIPPER WELL, HOT TAP, WATER TOWER, AND PITCHER RINSER: ROUTE 1/2" COLD, AND FILTERED COLD WATER IN CASEWORK. EXTEND 1/2" FILTERED COLD WATER UP IN CASEWORK AND CONNECT TO DIPPER WELL. EXTEND 3/8" FILTERED WATER UP IN CASEWORK AND CONNECT TO HOT WATER DISPENSER, CONTRACTOR SHALL REDUCE WATER SUPPLY LINE TO 1/4" AT UNIT. EXTEND 3/8" FILTERED COLD WATER UP IN CASEWORK AND CONNECT TO WATER TOWER FAUCET. EXTEND 1/2" AND COLD WATER UP IN CASEWORK AND CONNECT TO PITCHER RINSER FAUCET (2 HANDLE), REFER TO ESP SINK PIPING DETAIL.
- 11. WATER CLOSET: ROUTE 1" COLD WATER DOWN IN WALL AND CONNECT TO WATER CLOSET, PROVIDE WITH WATER HAMMER ARRESTOR IN SUPPLY LINE. CONTRACTOR SHALL CHOOSE RIGHT/LEFT HAND ORIENTATION TO BE ADA COMPLIANT PRIOR TO ORDERING.

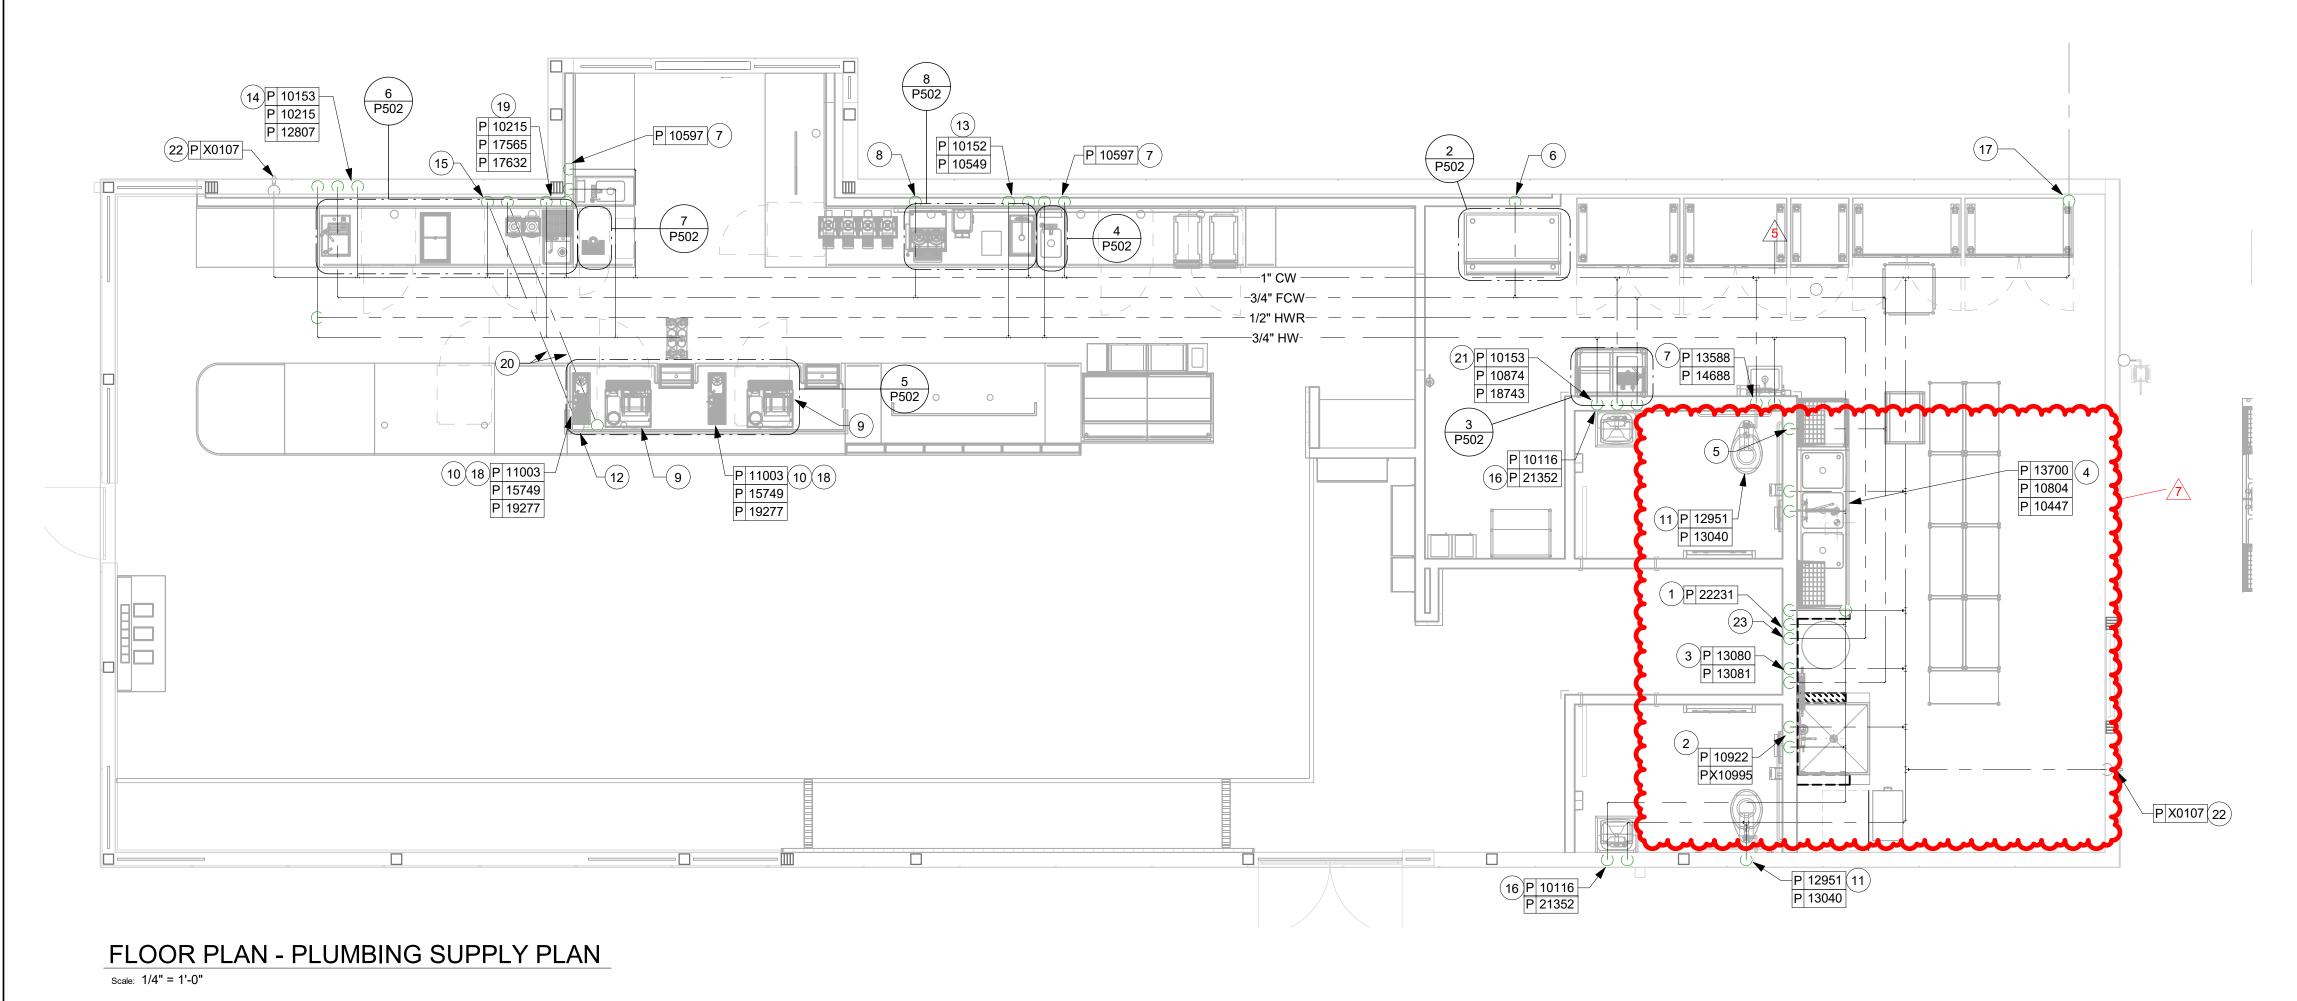


- ROUTE 1/2" HOT AND COLD WATER DOWN IN WALL AND CONNECT TO HAND SINK/LAVATORY, CONTRACTOR TO PROVIDE AND INSTALL
- THERMOSTATIC MIXING VALVE BELOW FIXTURE AND SET TO 110°F. MIXING VALVE SHALL BE ASSE 1070 COMPLIANT. REPLACE AERATOR PROVIDED WITH FAUCET WITH 0.5 GPM VANDAL RESISTANT FLOW CONTROL AERATOR. CAULK AND SEAL BACK OF SINK

- 12. ROUTE 3/4" COLD, AND FILTERED COLD WATER UP FROM BELOW GRADE THRU SLAB, PROVIDE WITH BALL SHUT-OFF VALVE AT FLOOR PENETRATION. PIPING SHALL BE ROUTED CONCEALED BELOW COUNTER AND TIGHT TO BAR WALL (COORDINATE WITH G.C.).
- 13. WORK SINK: ROUTE 1/2" HOT AND COLD WATER DOWN IN WALL AND CONNECT TO WORK SINK.
- 14. PITCHER RINSER FAUCET: ROUTE 1/2" HOT AND COLD WATER UP IN WALL. CONNECT 1/2" CW TO PITCHER RINSER FAUCET (1 HANDLE). EXTEND IN CASEWORK AND 1/2" HW AND CW CONNECT TO SINK FAUCET. CONTRACTOR SHALL PROVIDE AND INSTALL AN APPROVED BACKFLOW PREVENTER
- 15. ROUTE 3/4" COLD, AND FILTERED COLD WATER DOWN IN WALL AND EXTEND BELOW SLAB TO BAR AREA.
- 16. LAVATORY: ROUTE 1/2" HOT AND COLD WATER DOWN IN WALL AND CONNECT TO HAND SINK/LAVATORY, CONTRACTOR TO PROVIDE AND INSTALL THERMOSTATIC MIXING VALVE BELOW FIXTURE AND SET TO 100°F. MIXING VALVE SHALL BE ASSE 1070 COMPLIANT. REPLACE AERATOR PROVIDED WITH FAUCET WITH 0.5 GPM VANDAL RESISTANT FLOW CONTROL AERATOR. CAULK AND SEAL BACK OF SINK TO WALL.
- 17. ROUTE 1-1/2" COLD WATER LINE UP IN CEILING SPACE.
- 18. REPLACE AERATOR PROVIDED WITH FAUCET WITH 0.5 GPM VANDAL RESISTANT FLOW CONTROL AERATOR.
- 19. MAGIC SINK: ROUTE 1/2" COLD, HOT, AND FILTERED COLD WATER IN WALL, EXTEND 1/2" FILTERED COLD WATER IN CASEWORK AND CONNECT TO HOT WATER DISPENSER, CONTRACTOR SHALL REDUCE WATER SUPPLY LINE TO 1/4" AT UNIT. EXTEND 1/2" FILTERED COLD WATER IN CASEWORK AND CONNECT TO WATER TOWER FAUCET. ROUTE 1/2" COLD AND HOT WATER IN CASEWORK AND CONNECT TO LABORATORY FAUCET. REFER TO DETAIL 6/502 FOR MORE INFORMATION.

- 20. PIPING SHALL BE BELOW FLOOR.
- 21. ROUTE 1/2" HW, CW AND FCW DOWN IN WALL AND CONNECT TOWATER FILLING STATION. CONTRACTOR SHALL PROVIDED AND INSTALL APPROVED BACKFLOW PREVENTER.
- 22. HOSE BIB. FIELD VERIFY EXACT LOCATION.
- 23. ROUTE 1/2" HWR FROM CEILING SPACE AND CONNECT TO WATER HEATER. SEE DETAIL ON P502 FOR MORE INFORMATION.

GENERAL NOTES


- A. FURNISH AND INSTALL A COMPLETE AND OPERATING SYSTEM. ALL ITEMS ARE NOT NECESSARILY SHOWN.
- B. PLUMBING CONTRACTOR RESPONSIBLE FOR SITE INVESTIGATION PRIOR TO START OF WORK TO REVEAL FULL SCOPE OF WORK.
- C. ALL PLUMBING LINES TO BE ROUTED SUCH THAT THEY ARE NOT VISIBLE TO CUSTOMERS EXCEPT WHERE FIRST APPROVED BY STARBUCKS AT EXPOSED CEILING AREAS.
- D. REFER TO MANUFACTURER SPECIFICATIONS FOR LOCATION OF CONNECTIONS UNLESS OTHERWISE NOTED.
- E. DIMENSIONS ARE TO FINISH FACE UNLESS OTHERWISE NOTED.
- F. REFER TO DETAIL SHEETS FOR PLUMBING FITTINGS LOCATED IN CASEWORK.
- G. COLD WATER SUPPLY LINES INSIDE CASEWORK AND BAR AREA TO BE COVERED WITH 1/2" (10MM) THICK SELF SEALING, SECTIONAL CLOSED-CELL FOAM INSULATION. REFER TO SPECIFICATIONS FOR HOT WATER SUPPLY LINE INSULATION REQUIREMENTS.
- H. INSULATE ALL PIPING INCLUDING PIPES AT BAR AND IN CASEWORK PER THE REQUIREMENTS LISTED IN THE PROJECT MANUAL.
- I. GENERAL CONTRACTOR SHALL CONTACT WATER FILTRATION SUPPLIER TO COORDINATE SOW AND SCHEDULE PRIOR TO INSTALLATION OF WATER FILTRATION SYSTEM.

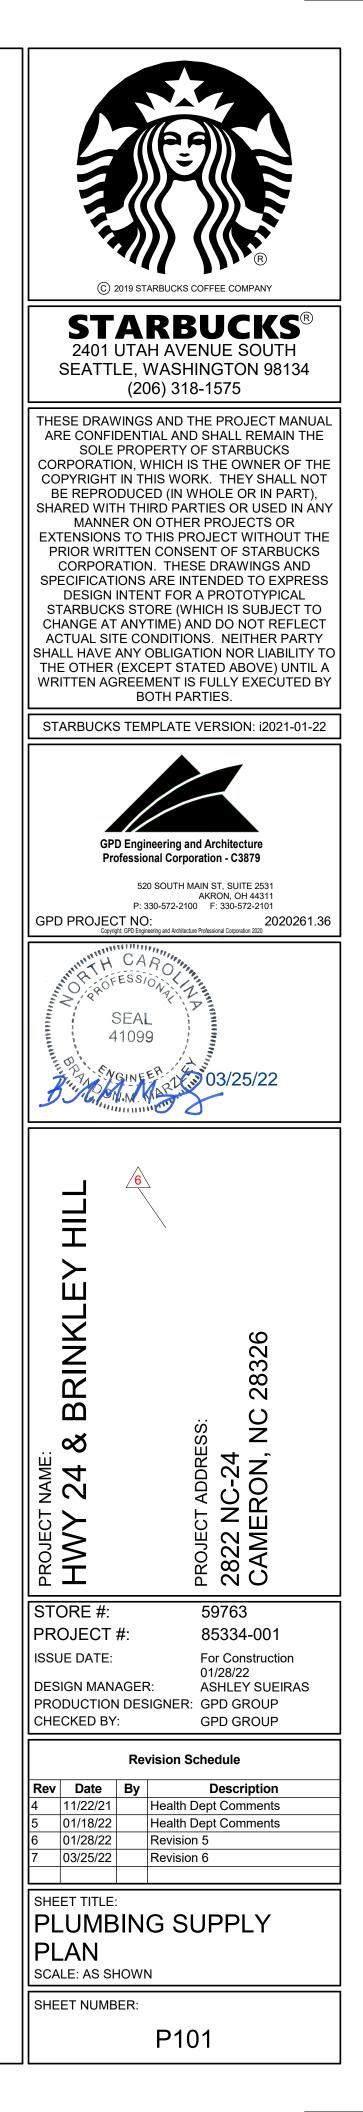



KEYED NOTES

- CONNECT TO EXISTING 4" SANITARY WASTE PI BELOW FLOOR. FIELD VERIFY EXACT LOCATION DEPTH OF INVERT, AND DIRECTION OF FLOW F START OF ANY WORK.
- 2. ESPRESSO SINK: ROUTE 1-1/2" INDIRECT WASTE PIPING IN CASE NEW FLOOR SINK, FIELD VERIFY EXACT LOCAT
- 3. ICE BIN: ROUTE 1-1/2" INDIRECT WASTE PIPING FROM IC CASEWORK TO FLOOR SINK, FIELD VERIFY EXA LOCATION.
- 4. HAND SINK: ROUTE 2" GREASE WASTE PIPING BELOW AND UP IN WALL, TRANSITION TO 1-1/2" GREASE WA PIPING AND CONNECT TO SINK. EXTEND 1-1/2" PIPING UP IN WALL TO CEILING SPACE.
- 5. WORK SINK: ROUTE 1-1/2" INDIRECT WASTE PIPING IN CASE NEW FLOOR SINK. FIELD VERIFY EXACT LOCAT APPROVED AIR GAP.
- 6. CONTRACTOR SHALL ROUTE 4" VENT THRU RO PENETRATION SHALL BE MADE BY LANDLORD'S CONTRACTOR. LANDLORD'S ROOFING CONTRA SHALL MAKE ROOF PENETRATION WEATHER T VENT THRU ROOF SHALL BE A MINIMUM OF 12' ANY OUTDOOR AIR INTAKES.
- 7. ROUTE 1" INDIRECT WASTE PIPING FROM CBS BOARD TO FLOOR SINK. FIELD VERIFY EXACT L
- 8. ROUTE 1-1/2" INDIRECT WASTE PIPING FROM P RINSER SINK TO FLOOR SINK. FIELD VERIFY EX LOCATION.
- 9. ROUTE INSULATED INDIRECT DRAIN PIPING BE UNDERCOUNTER REFRIGERATOR, TIGHT TO W CONTRACTOR SHALL PROVIDE AND INSTALL B GUARDS AS REQUIRED.
- 10. ROUTE WASTE PIPING FROM ESPRESSO MACH TRAY TO FLOOR SINK. COORDINATE EXACT REQUIREMENTS WITH EQUIPMENT MANUFACT RECOMMENDATIONS.
- 11. WATER HEATER: ROUTE 3/4" PRESSURE RELIEF TO MOP SINK. ROUTE 1" INDIRECT DRAIN FROM WATER HEATER DRAIN PAN TO MOP SINK. ROUTE CONDENSATE DRAIN FROM WATER HEATER TO MOP SINK.

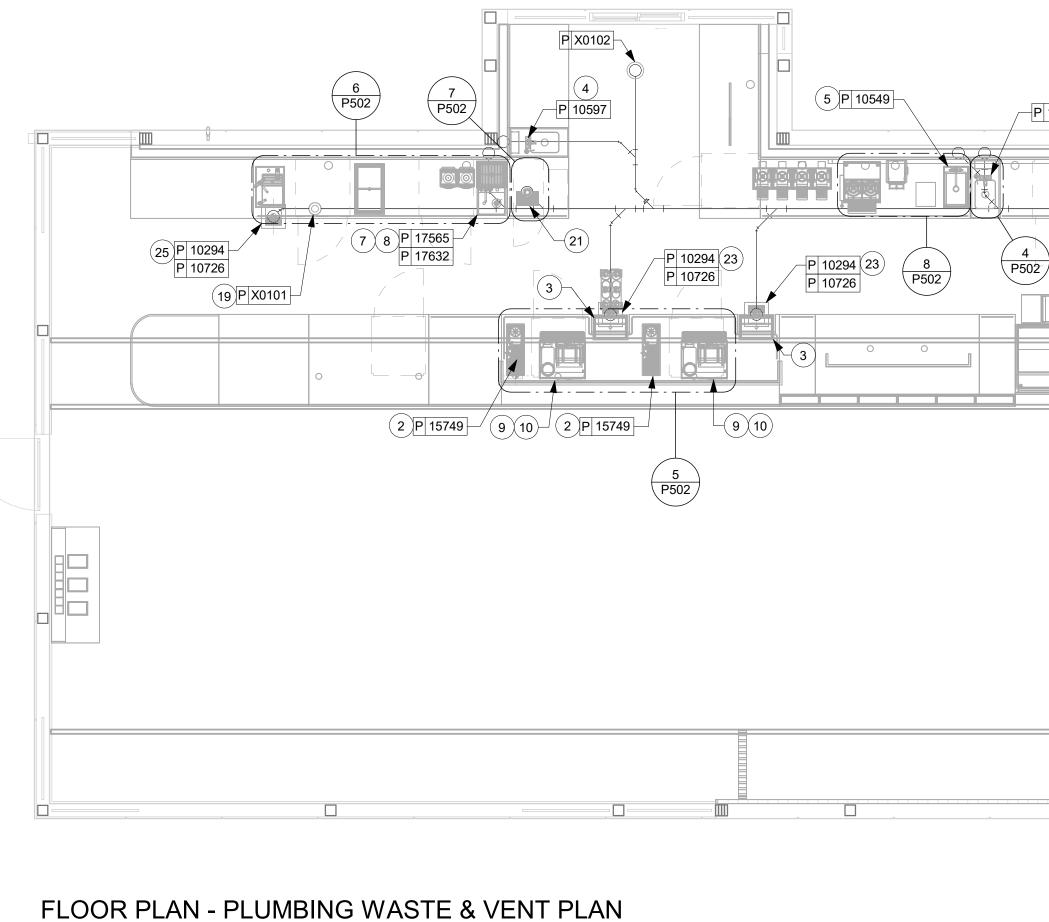

Scale: 1/4" = 1'-0"

12. MOP SINK: ROUTE 3" GREASE WASTE UP AND CONNECT TP MOP SINK, EXTEND 2" VENT UP IN WALL TO CEILING SPACE.	24. FLOOR DRAIN: ROUTE 3" SANITARY WASTE UP IN WALL AND CONNECT TO FLOOR DRAIN, EXTEND 1-1/2" VENT UP IN WALL TO CEILING SPACE.
13. WATER CLOSET: ROUTE 4" SANITARY WASTE UP AND CONNECT TO WATER CLOSET, EXTEND 2" VENT UP IN WALL TO CEILING SPACE.	25. MAGIC SINK: ROUTE 1-1/2" INDIRECT WASTE PIPING IN CASEWORK TO NEW FLOOR SINK WITH APPROVED AIR GAP, FIELD VERIFY EXACT LOCATION.
14. LAVATORY: ROUTE 2" SANITARY WASTE PIPING BELOW SLAB AND EXTEND UP IN WALL, TRANSITION TO 1-1/2" SANITARY WASTE PIPING AND CONNECT TO LAVATORY. EXTEND 1- 1/2" VENT PIPING UP IN WALL TO CEILING SPACE. CONTRACTOR SHALL PROVIDE AND INSTALL PIPE	26. ROUTE INDIRECT DRAIN FROM WATER FILLING STATION TO FLOOR SINK WITH APPROVED AIR GAP.
PROTECTOR FOR P-TRAP AND SUPPLIER, TRUEBRO LAVGUARD 2 OR EQUAL.	
15. 3-COMPARTMENT SINK: SINK SHALL DISCHARGE TO GREASE INTERCEPTOR. ROUTE WASTE PIPING FROM SINK TO FLOOR SINK	
THROUGH MINIMUM 2" AIR GAP.	
ROUTE 1-1/2" INDIRECT DRAIN TO CLOSET FLOOR SINK.	
17. ICE MACHINE: ROUTE (2) 3/4" INSULATED INDIRECT DRAINS TO FLOOR SINK. DO NOT INTERCONNECT DRAINS.	
 FLOOR SINK: ROUTE 3" GREASE WASTE UP AND CONNECT TO FLOOR SINK, EXTEND 1-1/2" VENT UP IN WALL TO CEILING SPACE. 	
19. FLOOR CLEANOUT: CLEANOUT SHALL BE INSTALLED FLUSH WITH FINISHED FLOOR.	
20. NOT USED.	
21. ROUTE 1" INDIRECT DRAIN FROM NITRO DRIP TRAY TO FLOOR SINK WITH APPROVED AIR GAP.	
22. CONNECT TO EXISTING 4" GREASE WASTE/SANITARY WASTE PIPING BELOW GRADE. FIELD VERIFY EXACT LOCATION, SIZE, DEPTH OF INVERT, AND DIRECTION OF FLOW PRIOR TO START OF ANY WORK.	
	 ROUTE 3" GREASE WASTE UP AND CONNECT TP MOP SINK, EXTEND 2" VENT UP IN WALL TO CEILING SPACE. 13. WATER CLOSET: ROUTE 4" SANITARY WASTE UP AND CONNECT TO WATER CLOSET, EXTEND 2" VENT UP IN WALL TO CEILING SPACE. 14. LAVATORY: ROUTE 2" SANITARY WASTE PIPING BELOW SLAB AND EXTEND UP IN WALL, TRANSITION TO 1-1/2" SANITARY WASTE PIPING AND CONNECT TO LAVATORY. EXTEND 1- 1/2" VENT PIPING UP IN WALL TO CEILING SPACE. CONTRACTOR SHALL PROVIDE AND INSTALL PIPE PROTECTOR FOR P-TRAP AND SUPPLIER, TRUEBRO LAVGUARD 2 OR EQUAL. 15. 3-COMPARTMENT SINK: SINK SHALL DISCHARGE TO GREASE INTERCEPTOR. ROUTE WASTE PIPING FROM SINK TO FLOOR SINK THROUGH MINIMUM 2" AIR GAP. 16. SANITIZER: ROUTE 1-1/2" INDIRECT DRAIN TO CLOSET FLOOR SINK. 17. ICE MACHINE: ROUTE (2) 3/4" INSULATED INDIRECT DRAINS TO FLOOR SINK. DO NOT INTERCONNECT DRAINS. 18. FLOOR SINK: ROUTE 3" GREASE WASTE UP AND CONNECT TO FLOOR SINK, EXTEND 1-1/2" VENT UP IN WALL TO CEILING SPACE. 19. FLOOR CLEANOUT: CLEANOUT SHALL BE INSTALLED FLUSH WITH FINISHED FLOOR. 20. NOT USED. 21. ROUTE 1" INDIRECT DRAIN FROM NITRO DRIP TRAY TO FLOOR SINK WITH APPROVED AIR GAP. 22. CONNECT TO EXISTING 4" GREASE WASTE/SANITARY WASTE PIPING BELOW GRADE. FIELD VERIFY EXACT LOCATION, SIZE, DEPTH OF INVERT, AND DIRECTION OF

23. FLOOR SINK: ROUTE 4" GREASE WASTE UP AND CONNECT TO FLOOR SINK.

2 P502 - P 10597 4 (22) P X0101 <u>/5</u> P 10294 P 10726 17 18 3 P502 (6)--(4)P 14688 ▰ 26 P 10294 **N** ϕ P 10726 (19) P X0101 -P X0101 P 10116 (14) P X0102 (24) P 10294 15 18 P 10726 11 X0102 PX10995 12 (24) P X0102 – P X0101 (19) 14 P 10116 P 12951 (13) 19 P X0101

GENERAL NOTES

A. SEE PLUMBING SPECIFICATIONS FOR FURTHER REQUIREMENTS.

B. ALL PLUMBING LINES TO BE ROUTED SUCH THAT THEY ARE NOT VISIBLE TO CUSTOMERS EXCEPT WHERE FIRST APPROVED BY STARBUCKS AT EXPOSED CEILING AREAS.

C. REFER TO MANUFACTURER SPECIFICATIONS FOR LOCATION OF CONNECTIONS UNLESS OTHERWISE NOTED.

D. COORDINATE WITH ELECTRICAL CONTRACTOR FOR POWER CONNECTION TO ALL PLUMBING EQUIPMENT.

E. DIMENSIONS ARE TO FINISH FACE UNLESS OTHERWISE NOTED.

F. REFER TO DETAIL SHEETS FOR PLUMBING FITTINGS LOCATED IN CASEWORK.

G. WHEN BUILDING SEVERAL INDIRECT WASTE LINES TO DRAIN INTO A FLOOR SINK, A UNISTRUT IS REQUIRED FOR SECURING AND BRACING ALL LINES ABOVE THE DRAIN.

H. FURNISH & INSTALL ALL NEEDED INDIRECT DRAINS PER CODE (NOT ALL SHOWN). INSTALL DRAINS AT 2% SLOPE WHERE POSSIBLE WITHOUT DIPS OR SAGS. ALL INDIRECT DRAINS SHALL RUN SEPARATELY FROM EACH OTHER TO INDIRECT DRAIN RECEPTOR AND SHALL TERMINATE WITH AN AIR GAP PER CODE.

I. FURNISH & INSTALL WALL CLEANOUTS AT ALL SINKS, AS NEEDED, AND PER CODE (NOT ALL SHOWN).

J. INSULATE ICE BIN DRAINAGE PIPES PER THE REQUIREMENTS ON THE PLUMBING SPECIFICATION SHEET.

K. STACK TEST ON DRAINS AND VENTS SHALL BE PROVIDED AT TIME OF UNDERGROUND AND ROUGH IN INSPECTIONS.

L. ANY PVC DRAIN AND VENT PIPING SHALL BE SCHEDULE 40 PVC ASTM 2665. NO CELLULAR CORE PVC OR ABS PIPE ALLOWED.



© 2019 STARBUCKS COFFEE COMPANY STARBUCKS ® 2401 UTAH AVENUE SOUTH SEATTLE, WASHINGTON 98134 (206) 318-1575
THESE DRAWINGS AND THE PROJECT MANUAL ARE CONFIDENTIAL AND SHALL REMAIN THE SOLE PROPERTY OF STARBUCKS CORPORATION, WHICH IS THE OWNER OF THE COPYRIGHT IN THIS WORK. THEY SHALL NOT BE REPRODUCED (IN WHOLE OR IN PART), SHARED WITH THIRD PARTIES OR USED IN ANY MANNER ON OTHER PROJECTS OR EXTENSIONS TO THIS PROJECT WITHOUT THE PRIOR WRITTEN CONSENT OF STARBUCKS CORPORATION. THESE DRAWINGS AND SPECIFICATIONS ARE INTENDED TO EXPRESS DESIGN INTENT FOR A PROTOTYPICAL STARBUCKS STORE (WHICH IS SUBJECT TO CHANGE AT ANYTIME) AND DO NOT REFLECT ACTUAL SITE CONDITIONS. NEITHER PARTY SHALL HAVE ANY OBLIGATION NOR LIABILITY TO THE OTHER (EXCEPT STATED ABOVE) UNTIL A WRITTEN AGREEMENT IS FULLY EXECUTED BY BOTH PARTIES.
STARBUCKS TEMPLATE VERSION: i2021-01-22
GPD Engineering and Architecture Professional Corporation - C3879 520 SOUTH MAIN ST, SUITE 2531 AKRON, OH 44311 P: 330-572-2100 F: 330-572-2101 GPD PROJECT NO: 2020261.36 Copyright GPD Engineering and Architecture Professional Corporation 2020
PROJECT NAME: HWY 24 & BRINKLEY HI PROJECT ADDRESS: 2822 NG-24 CAMERON, NC 28326
STORE #:59763PROJECT #:85334-001ISSUE DATE:For Construction 01/28/22DESIGN MANAGER:ASHLEY SUEIRASPRODUCTION DESIGNER:GPD GROUP GPD GROUPCHECKED BY:GPD GROUP
Revision Schedule Rev Date By Description
4 11/22/21 Health Dept Comments 5 01/18/22 Health Dept Comments 6 01/28/22 Revision 5 7 03/25/22 Revision 6
SHEET TITLE: PLUMBING WASTE & VENT PLAN SCALE: AS SHOWN SHEET NUMBER:

P102