AMP AMPERE

ABBREVIATIONS

ARCH ARCHITECT BOH BACK OF HOUSE

CAB CABINET CL CENTER LINE CLG CEILING STARBUCKS CM CONSTRUCTION MANAGER

CENTER COMMISSIONING CXA COMMISSIONING AGENT

DET DETAIL DIA DIAMETER DIMENSION STARBUCKS DESIGN MANAGER DN DOWN

EΑ EACH ELEVATION EQ EQUAL EXIST EXISTING EXT EXTERIOR

FT FOOT/FEET

DEG DEGREE

FF&E FURNITURE. FIXTURE, AND EQUIPMENT FLR FLOOR

FOH FRONT OF HOUSE FOIC FURNISHED BY OWNER, INSTALLED BY CONTRACTOR FOIO FURNISHED BY OWNER **INSTALLED BY OWNER**

GROUND GENERAL CONTRACTOR GWB GYPSUM WALLBOARD

HC HOLLOW CORE HDW HARDWARE HOLLOW METAL HORIZ HORIZONTAL HR HOUR HT HEIGHT HVAC HEATING, VENTILATING AND AIR CONDITIONING

I.D. INSIDE DIAMETER

LEED LEADERSHIP IN ENERGY AND ENVIRONMENTAL DESIGN

"MECHANICAL, ELECTRICAL

LANDLORD LV LOW VOLTAGE MAX MAXIMUM

AND PLUMBING"

MFR MANUFACTURER MIN MINIMUM NIC NOT IN CONTRACT

NIGHT LIGHT NTS NOT TO SCALE

PIR PASSIVE INFRARED SENSOR

PLC PLACE RADIUS REF REFERENCE REQ'D REQUIRED

OC ON CENTER

REV REVISION RND ROUND STARBUCKS SOLID CORE SQUARE FEET

SHEET SIMILAR SPEC SPECIFICATION SQ SQUARE

TEMP TEMPORARY TYP TYPICAL


VERT VERTICAL VIF VERIFY IN FIELD

UC UNDER COUNTER UNO UNLESS NOTED OTHERWISE

RESPONSIBILITY LEGEND

GC GENERAL CONTRACTOR LL LANDLORD SB STARBUCKS

ARCHITECTURAL SYMBOL LEGEND

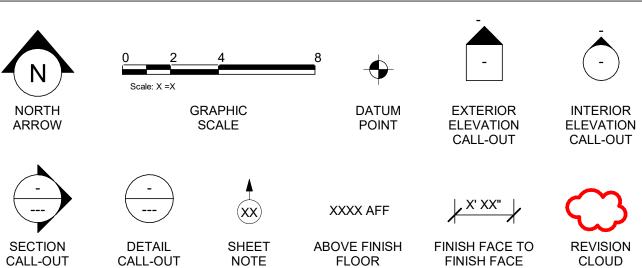


HEIGHT TAG


DIMENSION

P|XXXXX XXXXXX DXXXXXX XX (W XXXXX) X-X-X REVISION PAINT DESIGN ID DOOR WINDOW INTERIOR TAG TAG TAG TAG TAG WALL TAG

CALLOUT

AERIAL MAP

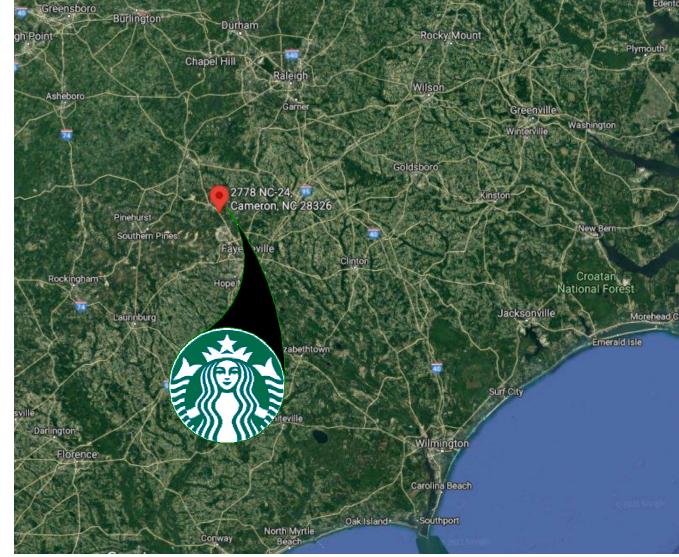

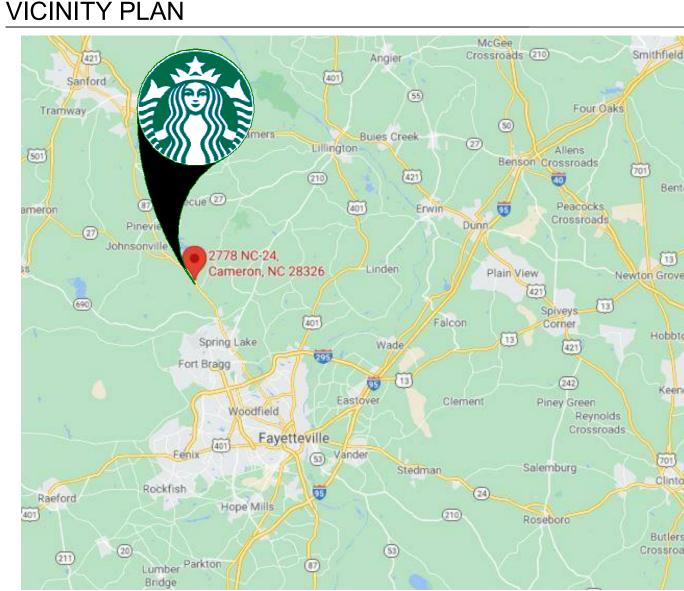

SOURCE: GOOGLE MAP

PROJECT CONTACTS

MAILING STARBUCKS COFFEE COMPANY ADDRESS: 2401 UTAH AVENUE SOUTH MS STOP: S-SD10

SEATTLE, WASHINGTON 98134 (206) 318-1575

DESIGN GIDA AVILA MANAGER: STARBUCKS COFFEE COMPANY 95 MERRICK WAY SUITE 650 CORAL GABLES, FL 33134 (305) 529-5375

STORE **ASHLEY SUEIRAS** DESIGNER:

STARBUCKS COFFEE COMPANY 95 MERRICK WAY SUITE 650 CORAL GABLES, FL 33134 (786) 946-2505

CONSTRUCTION RICK JOHNSON MANAGER: STARBUCKS COFFEE COMPANY (404) 991 - 9837 rjohnson@Starbucks.com

LANDLORD: PRIMAX PROPERTIES, LLC MIKE ERICKSON 1100 MOREHEAD STREET CHARLOTTE, NC 28204 PHONE: 980-938-5471

GPD ENGINEERING AND ARCHITECTURE ARCHITECT OF RECORD: PROFESSIONAL CORPORATION - 52715 520 SOUTH MAIN STREET **SUITE 2531**

AKRON, OH 44311 330-572-2100 **GPD ENGINEERING AND ARCHITECTURE** PROFESSIONAL CORPORATION - C3879 CONSULTANT

520 SOUTH MAIN STREET **SUITE 2531** AKRON, OH 44311 330-572-2100

STRUCTURAL GPD ENGINEERING AND ARCHITECTURE PROFESSIONAL CORPORATION - C3879 520 SOUTH MAIN STREET **SUITE 2531**

AKRON, OH 4431

330-572-2100

SCOPE OF WORK

OF RECORD:

NEW PROPOSED TENANT IMPROVEMENT FOR NEW STARBUCKS STORE

INTERIOR SCOPE OF WORK INCLUDES INTERIOR WALLS, WALL FINISHES, FIXTURES, EQUIPMENT, CASEWORK, AND ACCESSIBLE EMPLOYEE

NO EXTERIOR SCOPE OF WORK EXCEPT FOR BUILDING SIGNAGE PERMITTED SEPARATELY.

SHELL BUILDING SIGNAGE PERMITTED SEPARATELY BY OTHERS.

GENERAL NOTES

- 1. THE DRAWINGS AND PROJECT MANUAL TOGETHER CONSTITUTE THE CONTRACT DOCUMENTS FOR CONSTRUCTION. ALL GENERAL REQUIREMENTS ARE TO BE MET AND ALL MATERIALS, FINISHES AND SYSTEMS ARE TO BE INSTALLED AND PERFORM PER SPECIFICATIONS UNLESS OTHERWISE NOTED.
- 2. GENERAL CONTRACTOR SHALL VISIT THE SITE, REVIEW THE BUILDING SHELL DRAWINGS AS SUBMITTED BY THE LANDLORD OR STARBUCKS AND BECOME THOROUGHLY FAMILIAR WITH THE SITE CONDITIONS PRIOR TO CONSTRUCTION.
- 3. GENERAL CONTRACTOR SHALL CONSULT WITH STARBUCKS CONSTRUCTION MANAGER TO RESOLVE ANY CHANGES, OMISSIONS OR PLAN DISCREPANCIES PRIOR TO CONSTRUCTION.
- 4. ALL WORK SHALL BE PERFORMED IN STRICT COMPLIANCE WITH LOCAL, COUNTY, STATE AND FEDERAL CODES AND ORDINANCES.
- 5. GENERAL CONTRACTOR SHALL VERIFY THE LOCATION OF ALL UTILITIES.
- 6. GENERAL CONTRACTOR TO VERIFY ALL DIMENSIONS, INCLUDING CLEARANCES REQUIRED BY OTHER TRADES AND NOTIFY STARBUCKS CONSTRUCTION MANAGER OF ANY DISCREPANCIES PRIOR TO PROCEEDING WITH THE WORK. ALL DIMENSIONS ARE TO THE FACE OF THE FINISHED SURFACE UNLESS NOTED OTHERWISE. ALL DIMENSIONS TO BE TAKEN FROM DESIGNATED DATUM POINT. DO NOT SCALE DRAWINGS.
- 7. GENERAL CONTRACTOR SHALL PATCH AND REPAIR ALL EXISTING WALLS, FLOORS, CEILINGS, OR OTHER SURFACES IDENTIFIED TO REMAIN THAT MAY BECOME DAMAGED DURING THE COURSE OF THE
- 8. THE GENERAL CONTRACTOR IS RESPONSIBLE FOR OBTAINING PERMITS FOR FIRE PROTECTION, PLUMBING, MECHANICAL, AND ELECTRICAL SYSTEMS PRIOR TO INSTALLATION OF SUCH SYSTEMS.
- 9. GENERAL CONTRACTOR SHALL RETAIN ONE SET OF PERMIT PLANS ON-SITE TO DOCUMENT ALL CHANGES MADE DURING CONSTRUCTION. THE RECORD DRAWINGS SHALL BE ISSUED TO THE OWNER AT PROJECT CLOSE-OUT AS DESCRIBED IN THE GENERAL REQUIREMENTS OF THE PROJECT MANUAL.
- 10. GENERAL CONTRACTOR IS RESPONSIBLE FOR COORDINATING DELIVERY OF MATERIALS FROM STARBUCKS CONTRACTED THIRD PARTY LOGISTICS DISTRIBUTION SERVICES AND VENDOR DIRECT SHIPMENTS. SEE THE PROJECT MANUAL FOR ADDITIONAL INFORMATION.
- 11. RESPONSIBILITY FOR SUPPLY AND DELIVERY OF MATERIALS AND EQUIPMENT IS IDENTIFIED IN THE DRAWING SCHEDULE SHEETS UNDER THE COLUMN LABELED "RESPONSIBILITY".
- 12. FOR THE PURPOSE OF THE DOCUMENTS, TO "INSTALL", SHALL MEAN TO PROVIDE ALL FASTENERS, MISCELLANEOUS HARDWARE, BLOCKING, ELECTRICAL CONNECTIONS, PLUMBING CONNECTIONS AND OTHER ITEMS REQUIRED FOR A COMPLETE AND OPERATIONAL INSTALLATION, UNLESS OTHERWISE NOTED.
- 13. ALL ITEM SUBSTITUTIONS MUST BE APPROVED BY THE STARBUCKS CONSTRUCTION MANAGER.

2018 NC FIRE PREVENTION CODE

2009 NC FOOD CODE

2009 ICC ANSI A117.1

019594010706

2,324 NET SF

B - BUSINESS

V-B

NO

2,480 GROSS SF

SITE INFORMATION

FIRE CODE:

ZONING:

HEALTH CODE:

ACCESSIBILITY CODE:

PARCEL NUMBER:

LEASABLE AREA:

CONSTRUCTION TYPE:

OCCUPANCY TYPE:

FIRE SPRINKLER:

CODE AUTHORITIES: BUILDING CODE: 2018 NC BUILDING CODE PLUMBING CODE: 2018 NC PLUMBING CODE MECHANICAL CODE: 2018 NC MECHANICAL CODE ELECTRICAL CODE: 2017 NATIONAL ELECTRICAL CODE (NFPA 70) **ENERGY CODE:** 2018 NC ENERGY CONSERVATION CODE

DITIMBING

Reviewed For Code Compliance By: Roger Sullivan Deputy Fire Marshal 10/14/2021 7:48:36 AM

P601 PLUMBING SCHEDULES

INDEX OF SHEETS

LEGEND: X - SHEET ISSUED R - SHEET ISSUED FOR REFERENCE AND COORDINATION ONLY SEE TITLEBLOCK FOR REVISION ISSUE DATE(S) SHEET SHEET TITLE

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D-STE-7A	DTE MENU BOARDS			
D-STE-7B	DTE MENU BOARDS			
D-STE-8	DTE DOS POST AND CANOPY			

GENERAL				
G001	GENERAL INFORMATION			
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G004	3D VIEWS			

ARCHITE	CTURAL			
A001	ARCHITECTURAL SITE PLAN			
A003	ARCHITECTURAL SITE DETAILS			
A004	ARCHITECTURAL SITE DETAILS			
A005	RAILING DETAILS			
A101	BUILDING FLOOR PLAN			
A102	BUILDING FLOOR PENETRATION PLAN			
A103	BUILDING ROOF PLAN			
A201	BUILDING EXTERIOR ELEVATIONS			
A202	BUILDING EXTERIOR ELEVATIONS			
A601	SCHEDULES			

A602 WINDOW AND DOOR SCHEDULES & DETAILS

INTERIORS	5			
I101	FF & E PLAN			
I102	CASEWORK PLAN			
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I103B	LIGHTING PLAN			
I104	FLOOR FINISH PLAN			
1201	INTERIOR FINISH ELEVATIONS			
1202	INTERIOR FINISH ELEVATIONS			
1203	INTERIOR FINISH ELEVATIONS			
I401	RESTROOM PLAN & ELEVATIONS			
I501	INTERIOR DETAILS			
1502	INTERIOR DETAILS			
1503	DESIGN DETAILS			
1504	DESIGN DETAILS			
I601	CASEWORK AND FF&E SCHEDULES			
1602	INTERIOR FINISHES SCHEDULES			

STRUCTU	RAL			
S001	STRUCTURAL GENERAL NOTES			
S101	STRUCTURAL SLAB PLAN			
S501	SITE FOUNDATIONS			
S502	SITE FOUNDATIONS			

0302	OHETOONDAHONO			ĺ
ELECTRIC	AL			
E001	ELECTRICAL NOTES			
E003	ELECTRICAL SITE PLAN			
E101	POWER PLAN			
E102	LIGHTING PLAN			
E103	ENLARGED ELECTRICAL PLACEMENT PLAN			
E104	DATA DEVICE PLAN			
E501	ELECTRICAL DETAILS			
E502	ELECTRICAL DETAILS			
E513	GENERAL ELECTRICAL - EMS, NO LIGHTING			
E601	ELECTRICAL PANEL SCHEDULES			

L001	LEEGTHOALT ANEL GOTTEBBEEG			
MECHANIC	CAL			
M001	MECHANICAL NOTES			
M101	MECHANICAL DESIGN PLAN			
M102	MECHANICAL ROOF PLAN			
M501	MECHANICAL DETAILS			
M601	MECHANICAL SCHEDULES			

PLUMBING				
P001	PLUMBING NOTES			
P101	PLUMBING SUPPLY PLAN			
P102	PLUMBING WASTE & VENT PLAN			
P103	PLUMBING WASTE & SANITARY ISOMETRIC			
P501	PLUMBING DETAILS			
P502	PLUMBING DETAILS			

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STARBUCKS

2401 UTAH AVENUE SOUTH SEATTLE, WASHINGTON 98134 (206) 318-1575


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EXTENSIONS TO THIS PROJECT WITHOUT THE PRIOR WRITTEN CONSENT OF STARBUCKS CORPORATION. THESE DRAWINGS AND SPECIFICATIONS ARE INTENDED TO EXPRESS DESIGN INTENT FOR A PROTOTYPICAL STARBUCKS STORE (WHICH IS SUBJECT TO CHANGE AT ANYTIME) AND DO NOT REFLECT ACTUAL SITE CONDITIONS. NEITHER PARTY SHALL HAVE ANY OBLIGATION NOR LIABILITY TO THE OTHER (EXCEPT STATED ABOVE) UNTIL A WRITTEN AGREEMENT IS FULLY EXECUTED BY **BOTH PARTIES.**

STARBUCKS TEMPLATE VERSION: i2021-01-22



AKRON, OH 44311 P: 330-572-2100 F: 330-572-2101

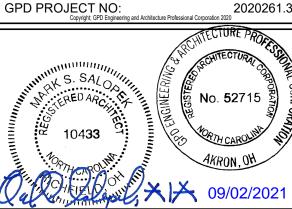

PROJECT 2778 CAME

()

STORE #: 59763 85334-001 PROJECT #: ISSUE DATE: For Construction **DESIGN MANAGER:**

ASHLEY SUEIRAS PRODUCTION DESIGNER: GPD GROUP CHECKED BY: GPD GROUP

Revision Schedule

GENERAL INFORMATION

SCALE: AS SHOWN

SHEET NUMBER:

G001

OUTDOOR SEATING CALCULATIONS					
DESCRIPTION	NUMBER OF ITEMS	SEATS	PER ITEM		
TABLE TOP, SQUARE	6	2	12		
TABLE TOP, RECTANGLE	2	2	4		
TABLE TOP, ROUND	3	2	6		
		TOTAL ACCESSIBLE SEATS (≥ 5%)	2		
		TOTAL	22		

EGRESS CALCULATIONS	
EXIT WIDTH REQUIRED - 60 OCC. x 0.2	= 12 IN.
EXIT WIDTH PROVIDED	= 150 IN.
EXITS	= 72 IN. PRIMARY ENTRY, 36 IN. SECONDARY ENTRY, 42 IN WORKROOM
NUMBER OF EXITS REQUIRED	= 2
NUMBER OF EXITS PROVIDED	= 3
MAXIMUM. ALLOWABLE TRAVEL DISTANCE	= 200' - 0"
MAXIMUM. TRAVEL DISTANCE PROVIDED	= 38' - 8"
MINIMUM. EXIT SEPARATION	= 87' - 3" (MAXIMUM DIAGONAL) / 2 = 43' - 7 1/2"
EXIT SEPARATION PROVIDED	= 49' - 3 1/4"

PLUMBING	FIXTURE	CALCULA	TIONS				
CHAPTER29-2	018 IBC TABL	E 2902.1					
OCCUPANCY	MALE	FEMALE	TOTAL				
OCCUPANCI	30 OCC.	30 OCC.	60 OCC.				
	\	WATER CLOSE	TS	URINALS*	LAVA	TORY	WATER FOUNTAIN**
FIXTURES	2 PER 100				1 PE	R 200	1 PER 100 OR STATION
	REQUIRED	1 M	1 F	0 M	1 M	1 F	0
	PROVIDED	1 M	1 F	0 M	1 M	1 F	0
*IN EACH BATI	HROOM OR T	OILET ROOM,	URINALS SHAL	L NOT BE SUBSTIT	TUTED FOR MO	RE THAN 67% O	F THE REQUIRED

WATER CLOSETS IN ASSEMBLY OCCUPANCIES.

**RETAIL ESTABLISHMENT SERVES WATER UPON REQUEST.

NAME	ADEA
NAME	AREA
BACKBAR	624 S
WORKROOM	518 S
RESTROOM VESTIBULE	119 5
RESTROOM 1	53 \$
RESTROOM 2	53 S
CAFE	890 \$
GRAND TOTAL	2258 S

OCCUPANCY CALCULATIONS	
CAFE: 690 SQ. FT. / 15 SQ. FT./ OCC.	46 OCC.
MERCANTILE: 200 SQ. FT. / 30 SQ. FT. / OCC.	7 OCC.
BAR: 624 SQ. FT. / 200 SQ. FT. /	3 OCC.
WORKROOM: 519 SQ. FT. / 300 SQ. FT. / OCC.	2 OCC.
RESTROOMS: 106 SQ. FT. / 300 SQ. FT. / OCC.	1 OCC.
VESTIBULE: 119 SQ. FT. / 300 SQ. FT. / OCC.	1 OCC.
TOTAL OCC. LOAD:	60 OCC.

HEALTH DEPT. PLAN NOTES

- A. GENERAL CONTRACTOR TO SCHEDULE WITH REFRIGERATION CONTRACTOR TO CONDUCT INITIAL FOOD CASE START-UP AND TESTING. FOR APPROVED CONTRACTOR, CONTACT THE VENDOR.
- B. THE SPACE IS SERVED BY THE MUNICIPAL WATER AND SEWER SYSTEM UNLESS OTHERWISE NOTED.
- C. ALL EQUIPMENT AND INSTALLATION WILL MEET NATIONAL SANITATION FOUNDATION STANDARDS OR EQUIVALENT.
- D. EQUIPMENT UNITS SHALL CONTAIN NO EXPOSED THREADS, EMBELLISHMENTS OR OVERHANGING EDGES THAT SERVE AS PLACES FOR ACCUMULATION OF DUST, DIRT AND DEBRIS
- E. WARMING OVEN(S) SHOWN FOR PERMITTING PURPOSES. INSTALLATION AT STORE OPENING TO BE VERIFIED BY STARBUCKS CONSTRUCTION REPRESENTATIVE.
- F. EACH HAND WASHING SINK WILL HAVE A SINGLE SERVICE TOWEL AND SOAP DISPENSER AND ALL HAND SINKS TO HAVE A COMBINATION FAUCET OR PREMIXING FAUCET.
- G. REFERENCE INTERIOR SCHEDULE SHEETS (1600 SERIES) FOR ADDITIONAL INFORMATION.
- H. PROVIDE SNEEZE GUARDS WHERE REQUIRED BY JURISDICTION.

BARRIER FREE PATH OF TRAVEL

EMERGENCY LIGHT

FIRE EXTINGUISHER

ADA ACCESSIBLE SEATING

EXIT SIGN

(MIN 3'-0" (915MM) - NO PINCH POINT)

36" (915MM) X 48" (1220MM) CLEAR AREA

I. ALL FOOD STORAGE AND DISPLAY SHELVING SHALL BE A MINIMUM 6" (150MM) ABOVE FINISH FLOOR.

HEALTH DEPT. FINISH SCHEDULE

1. THRESHOLDS TO BE BARRIER FREE COMPLIANT PER ALL

5. 32" (815 MM) MINIMUM CLEAR AT RESTROOM DOOR.

REQUIRED BY APPLICABLE LAWS OR CODES.

3. 30" (160 MM) X 48" (1220 MM) CLEAR FOR WHEELCHAIR ACCESS.

4. 60" (1525 MM) DIAMETER MINIMUM TURN RADIUS FOR WHEELCHAIR

6. POS TRANSACTION PLANE, CONDIMENT CART TOP AND HAND-OFF

7. PROVIDE BARRIER-FREE SIGNAGE AT ACCESSIBLE RESTROOMS

9. PROVIDE INTERNATIONAL SYMBOL OF ACCESSIBILITY SIGN WHERE

PLANE ARE 34 INCHES (860 MM) ABOVE THE FINISHED FLOOR FOR

APPLICABLE CODES.

ACCESS.

2. BARRIER-FREE PATH OF TRAVEL.

WHEELCHAIR ACCESSIBILITY.

PER ALL APPLICABLE CODES.

8. PROVIDE TACTILE "EXIT" SIGNAGE.

10. ADA EXIT SIGNAGE.

BAR	
FLOOR:	POLYVINYL FLOORING
WALL:	WALL TILE, BACKSPLASH
	BASE

SH, WOOD PLANKS, WITH POLYVINYL

CEILING: GYPSUM CEILING

CONCRETE STAIN FINISH WALL:

GYP. W/ VINYL WALL COVERING, WOOD PLANK CEILING: GYPSUM CEILING, ACT

FLOOR: POLYVINYL FLOORING FRP WITH POLYVINYL BASE CEILING: ACOUSTICAL CEILING TILE

CONCRETE STAIN FINISH WALL: WALL TILE. CEILING: GYPSUM CEILING

MEANS OF EGRESS NOTES **KEYED NOTES**

- A. EVERY ROOM OR SPACE THAT IS ASSEMBLY OCCUPANCY SHALL HAVE THE OCCUPANT LOAD OF THE ROOM OR SPACE POSTED IN A CONSPICUOUS PLACE, NEAR THE MAIN EXIT ACCESS DOORWAY. POSTED SIGNS SHALL BE OF AN APPROVED LEGIBLE PERMANENT DESIGN AND SHALL BE MAINTAINED BY THE OWNER AUTHORIZED AGENT. (1004.3)
- B. EGRESS SHALL NOT PASS THROUGH KITCHENS, STORAGE ROOMS, CLOSETS OR SIMILAR SPACES. (1014.2)
- C. PANIC AND FIRE EXIT HARDWARE. WHERE INSTALLED ON DOORS IN THIS BUILDING SHALL SATISFY THE FOLLOWING (1008.1.10):
- 1) THE ACTUATION PORTION OF THE RELEASING DEVICE SHALL
- EXTEND AT LEAST ONE-HALF OF THE DOOR LEAF WIDTH.
- 2) THE MAXIMUM UNLATCHING FORCE DOES NOT EXCEED 15 POUNDS (6.8 KG).
- 3) PIVOTED OR BALANCED DOORS SHALL BE OF THE PUSH-PAD TYPE WHERE PANIC HARDWARE IS REQUIRED AND THE PAD SHALL NOT EXTEND ACROSS MORE THAN ONE-HALF OF THE
- DOOR WIDTH, MEASURED FROM THE LATCH SIDE. 4) PANIC HARDWARE LISTED IN ACCORDANCE WITH UL 305.
- 5) FIRE EXIT HARDWARE LISTED IN ACCORDANCE WITH UL 10C AND UL 305.
- D. STRUCTURAL ELEMENTS, FIXTURES OR FURNISHINGS SHALL NOT PROJECT HORIZONTALLY FROM EITHER SIDE MORE THAN 4 INCHES (100 MM) OVER ANY WALKING SURFACE BETWEEN 27 INCHES (685 MM) AND 80 INCHES (2030 MM) ABOVE THE WALKING SURFACE. EXCEPTION: HANDRAILS SERVING STAIRS AND RAMPS ARE PERMITTED TO PROTRUDE 4 1/2 INCHES (115 MM) FROM THE WALL. (1003.3.3)
- E. THE PATH OF EGRESS TRAVEL EXITS AND WITHIN EXITS IN THIS BUILDING SHALL BE IDENTIFIED BY EXIT SIGNS CONFORMING TO THE REQUIREMENTS OF SECTION 1011 AND AS NOTED BELOW:
- 1) EXIT SIGNS SHALL BE READILY VISIBLE FROM ANY DIRECTION OF EGRESS TRAVEL.
- 2) EXIT SIGNS SHALL BE LOCATED AS NECESSARY TO CLEARLY INDICATE THE DIRECTION OF EGRESS TRAVEL.
- 3) NO POINT IN A CORRIDOR SHALL BE MORE THAN 100 FT (30.5 M) OR THE LISTED VIEWING DISTANCE FOR THE SIGN, WHICHEVER IS LESS, FROM THE NEAREST VISIBLE EXIT SIGN.
- F. WHERE KEY OPERATED LOCKING DEVICES ARE USED, POST A SIGN ON OR ADJACENT TO THE REQUIRED MAIN EXIT DOOR WITH 1 INCH (25 MM) LETTERING STATING THAT "THIS DOOR TO REMAIN UNLOCKED WHEN BUILDING IS OCCUPIED". (1008.1.9.3)
- G. EGRESS DOORS OR GATES SHALL BE OPENABLE FROM THE EGRESS SIDE WITHOUT THE USE OF A KEY, SPECIAL KNOWLEDGE OR EFFORT. DOOR HANDLES, PULLS, LATCHES, LOCKS AND OTHER OPERATING DEVICES SHALL BE INSTALLED 34 INCHES (860 MM) TO 48 INCHES (1220 MM) ABOVE FINISHED FLOOR. MANUALLY OPERATED FLUSH BOLTS OR SURFACE BOLTS ARE NOT PERMITTED. THE UNLATCHING OF ANY DOOR OR LEAF SHALL NOT REQUIRE MORE THAN ONE OPERATION. (1008.1.9)
- H. LANDINGS SHALL BE PROVIDED ON EACH SIDE OF DOORS AND SUCH LANDING SHALL BE AT THE SAME ELEVATION ON EACH SIDE OF THE DOOR LANDINGS SHALL HAVE A WIDTH NOT LESS THAN THE WIDTH OF THE DOOR AND LENGTH MEASURED IN THE DIRECTION OF TRAVEL OF NOT LESS THAN 44 INCHES (11120 MM).



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STARBUCKS 2401 UTAH AVENUE SOUTH

SEATTLE, WASHINGTON 98134 (206) 318-1575 THESE DRAWINGS AND THE PROJECT MANUAL

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PRIOR WRITTEN CONSENT OF STARBUCKS CORPORATION. THESE DRAWINGS AND SPECIFICATIONS ARE INTENDED TO EXPRESS DESIGN INTENT FOR A PROTOTYPICAL STARBUCKS STORE (WHICH IS SUBJECT TO CHANGE AT ANYTIME) AND DO NOT REFLECT ACTUAL SITE CONDITIONS. NEITHER PARTY SHALL HAVE ANY OBLIGATION NOR LIABILITY TO

BOTH PARTIES. STARBUCKS TEMPLATE VERSION: i2021-01-22

THE OTHER (EXCEPT STATED ABOVE) UNTIL A

WRITTEN AGREEMENT IS FULLY EXECUTED BY



520 SOUTH MAIN ST, SUITE 2531

AKRON, OH 44311 P: 330-572-2100 F: 330-572-2101

GPD PROJECT NO: 2020261.36

STORE #: PROJECT #: ISSUE DATE:

85334-001 For Construction **ASHLEY SUEIRAS** PRODUCTION DESIGNER: GPD GROUP


59763

CHECKED BY: **GPD GROUP**

LIFE SAFETY AND ACCESSIBILITY PLAN

SCALE: AS SHOWN SHEET NUMBER:

G002

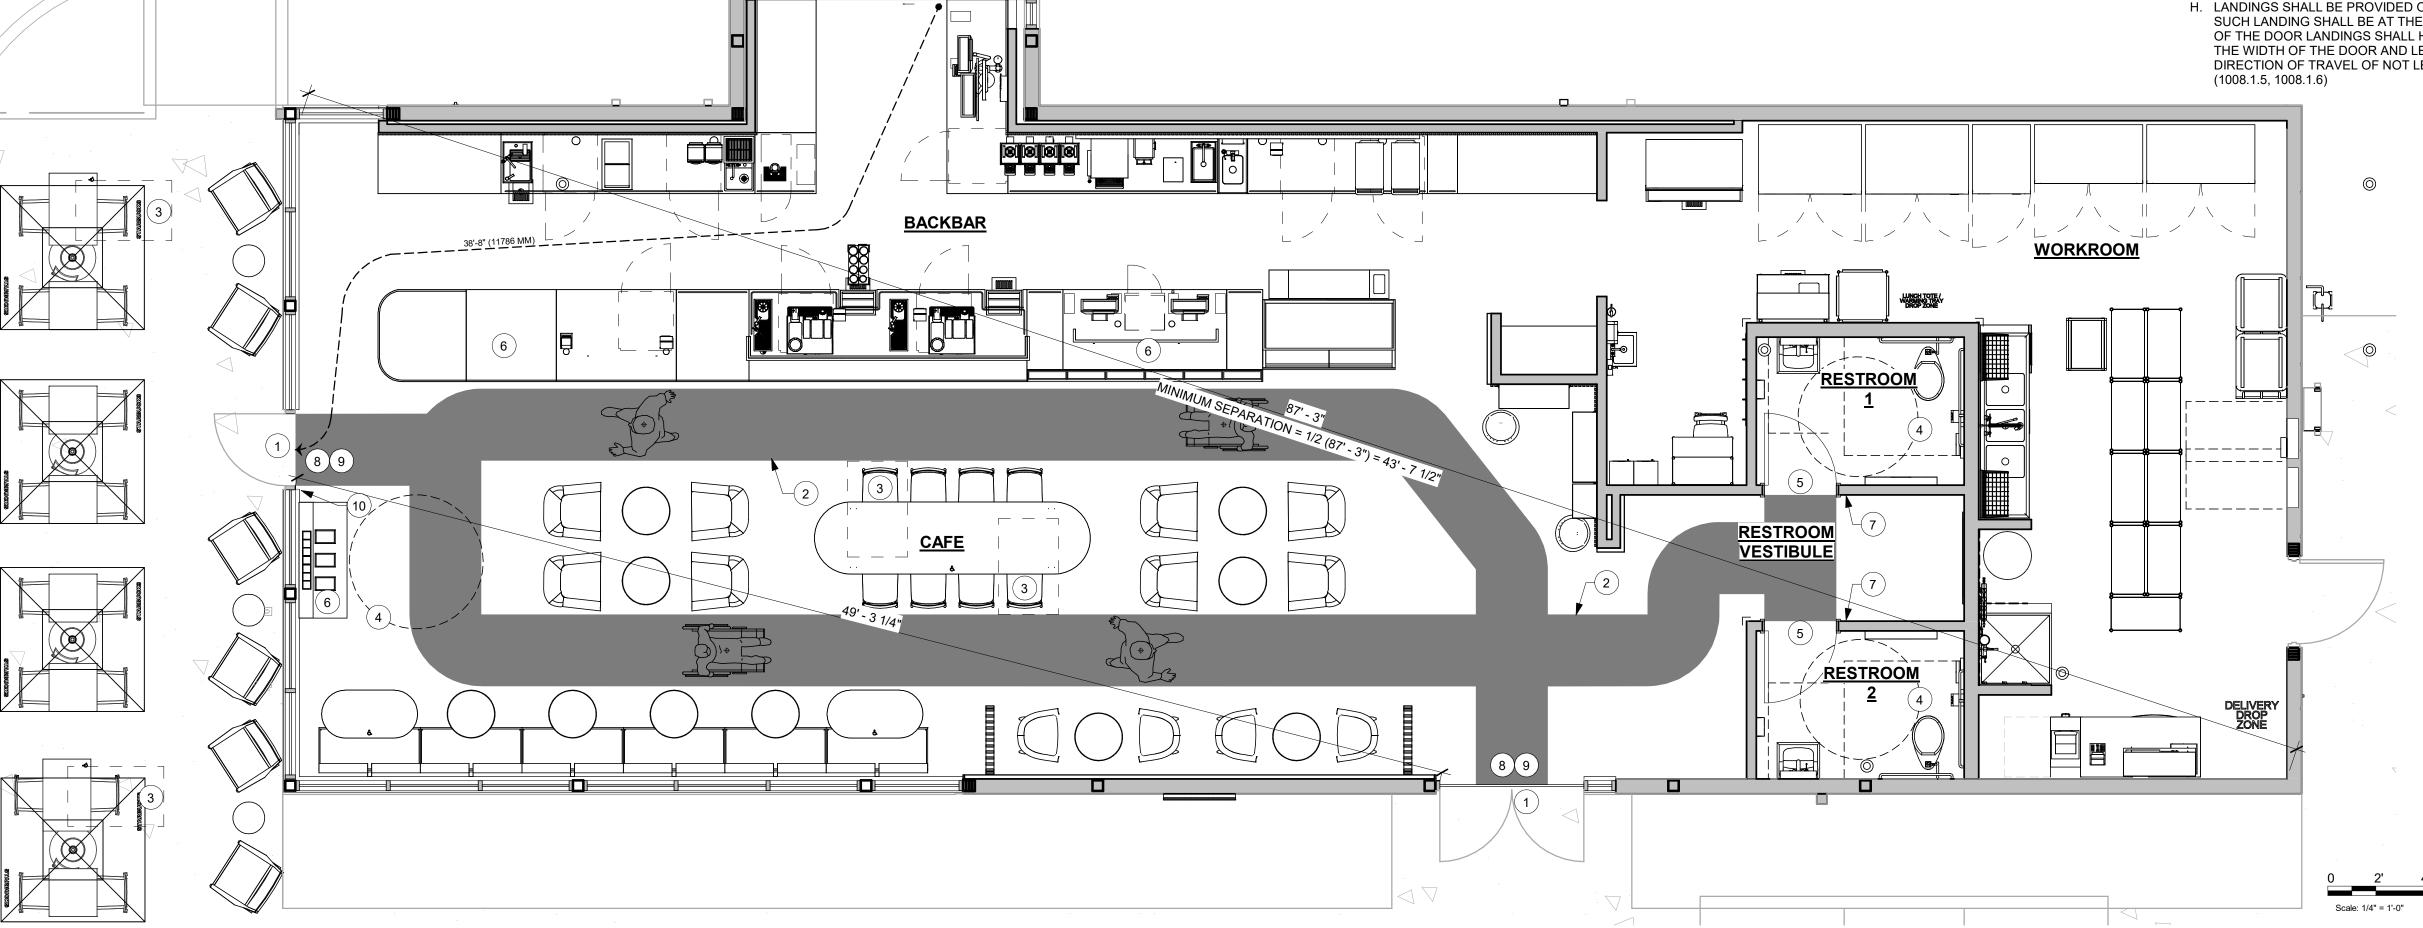

LEGEND

∠ X'-X" (XXMM) **→** TRAVEL DISTANCE

1ST FLOOR - LIFE SAFETY PLAN

31M36C	
Ħ Ħ	
0://Starbucks 2020 (Revit 2021)/85334-001_59763 Hwy 24 & Brinkley Hill_BIM360	
evit 2021)/85334-001	
BIM 360://Starbucks 2020 (R	
:021 8:55:14 AM	

(EXCEPT 1 AND 2-FAMILY DWELLINGS AND TOWNHOUSES) (Reproduce the following data on the building plans sheet 1 or 2) Name of Project: Starbucks - Hwy 24 & Brinkley Hill Zip Code 27705 Address: 2778 NC-24, Cameron, NC 28236 Owner/Authorized Agent: Mike Erickson Phone # (980) 938 - 5471 E-Mail ☐ City/County ☐ Private State Code Enforcement Jurisdiction: X City Cameron County State CONTACT: DESIGNER NAME LICENSE # TELEPHONE # E-MAIL Architectural Professional Corporation - 52715 Mark S. Salopak, AIA 10433 (330)572-3661 msalopek@gpdgroup.com Civil Electrical Steven P. Schaub 40102 (_330_)572-3561 sschaub@spdgroup.com. Fire Alarm GPD Engineering and Architecture Projessional Compression, C-3879 Brandon M. Marzley 41099 (330)572-3951 Imarzley@gpdgroup.com Plumbing Mechanical Professional Corporation - C3878 Brandon M. Marziey 41099 (330_) 572,3561 bmarziey@godgroup.com Sprinkler-Standpipe _____ Structural Retaining Walls >5' High _____ (___)____ ("Other" should include firms and individuals such as truss, precast, pre-engineered, interior designers, etc.) 2018 NC BUILDING CODE: X New Building Addition 1st Time Interior Completions ☐ Shell/Core* ☐ Phased Construction* *Contact the local inspection jurisdiction for possible additional procedures and requirements. 2018 NC EXISTING BUILDING CODE: Prescriptive Alteration Level I Historic Property Repair Alteration Level II Change of Use (check all that apply) ☐ Chapter 14 ☐ Alteration Level III CONSTRUCTED: (datc) presently CURRENT OCCUPANCY(S) (Ch. 3): B RENOVATED: (date) _____ PROPOSED OCCUPANCY(S) (Ch. 3): _B OCCUPANCY CATEGORY (Table 1604.5): Current: V-B Proposed: V-B BASIC BUILDING DATA Construction Type: ☐ II-B ☐ III-B □ NFPA 13 □ NFPA 13R □ NFPA 13D Sprinklers: No Partial Standpipes: No Class I II III Wet Dry Primary Fire District: X No Yes Flood Hazard Area: No Yes Special Inspections Required: Yes No If special inspections are required, contact the local inspection jurisdiction for additional procedures and requirements. 2018 NC Administrative Code and Policies ACCESSIBLE DWELLING UNITS (SECTION 1107) ACCESSIBLE PARKING (SECTION 1106) REGULAR WITH 5' ACCESS AISLE PLUMBING FIXTURE REQUIREMENTS (TABLE 2902.1)

SPECIAL APPROVALS

Special approval: (Local Jurisdiction, Department of Insurance, OSC, DPI, DHHS, etc., describe below)

2018 NC Administrative Code and Policies

2018 APPENDIX B

BUILDING CODE SUMMARY FOR ALL COMMERCIAL PROJECTS

Mezzanine 1st Floor	2,480 SF	=	2,480 SF		
Basement					
TOTA	L 2,480 SF	:	2,480 SF		
		ALLO	WABLE AREA		
Primary Occ	upancy Classificatio		***************************************		
Assembly		□ A-3 □ A-4	☐ A-5		
Business	\boxtimes		_		
Education					
Factory Hazardou	F-1 Moderate		e H-3 Comb	ust H-4 Health	П н.5 нрм
	nal		Condition		n-5 nrm
	☐ I-3 ☐ I-4	I-3 Cond	lition	1 2 1 2	3 4 5
Mercanti Residenti	= -	Пва Пва			
Storage	S-1 Moderate	_ =	Low His	th-piled	
	Parking Garas	ge Open E			
-	d Miscellaneous				
-	ccupancy Classificati				
	_	N/A	/*		
_	(Chapter 4 – List Co				
Special Prov Mixed Occup		List Code Section ☐ Yes	s): N/A Separation:		:
	Separated Use (508.3)	_	эчраганон:	III. Exception	
_			ulations for each	story, the area of the occ	cupancy shall be such that
_ = 54541	the	sum of the ratios of	the actual floor ar		by the allowable floor area
4	for tual Area of Occupan	each use shall not en		cuenamor D	
	лиат Area of Оссиран wable Area of Оссира		<u>ctual Area of Oc</u> wable Area of O		
					= < 1.00
_	N/A	- + -	N/A	+	= ≤ 1.00
STORY	DESCRIPTION AND	(A)	(B)	(c)	(D)
NO.	USE	BLDG AREA PER	TABLE 506.24	AREA FOR FRONTAGE	ALLOWABLE AREA PER
		STORY (ACTUAL)	AREA	INCREASE ^{1,5}	STORY OR UNLIMITED ^{2,3}
1	Restaurant	2,480 SF	2,480 SF	N/A	2,480 SF
Ft	- :	506.2			
	a increases from Sect neter which fronts a p			foot minimum width	- (F)
	Building Perimeter	=		rect illillillillilli widil	(1)
c. Ratio	(F/P) =	(F/P)			
d. W =	Minimum width of purea applicable under o	iblic way =	(W)		
	suilding Area = total n			D (maximum3 stories	(506.2)
					num area of air traffic
control tow	ers must comply with	Table 412.3.1.			
5 Frontage inc	rease is based on the	ansprinklered area	value in Table :	506.2.	
2018 NC Admi	nistrative Code and Pol	icies			
		FNFR	SY SUMMARY	7	
	QUIREMENTS:				
he following	data shall be consider				the energy code shall
					on for the plan data sheet. nual energy cost for the
roposed desig		idai chergy cost ic	n une standard f	referee design vs an	nual energy cost for the
		_			
xisting build	ing envelope compli	es with code: X	(If checked the	emainder of this sect	ion is not applicable.)
xempt Build	ing: Provide e	ode or statutory re	eference:		
	ing Flovide C	ode of statutory re			
Clim	ate Zone: 3A				
	ate Zone: 3A				
Meth	ate Zone: 3A	X 4A □ 5A			
Meth	ate Zone: 3A	X 4A □ 5A		3 NOT	
Meth	ate Zone: 3A	X 4A □ 5A		3 NOT	
Meth	ate Zone: 3A	X 4A □ 5A		3 NOT	
Meth	ate Zone: 3A	X 4A □ 5A		5 NOT	
Meth	ate Zone: 3A	X 4A □ 5A		3 NOT	
Meth	ate Zone: 3A	X 4A □ 5A		3 NOT	

Description of assembly: U-Value of total assembly:

R-Value of insulation:

Description of assembly:

U-Value of total assembly:

R-Value of insulation:

Walls below grade (each assembly)

Description of assembly:

R-Value of insulation:

Description of assembly:

Floors slab on grade

2018 NC Administrative Code and Policies

slab heated:

U-Value of total assembly:

Description of assembly:

U-Value of total assembly: R-Value of insulation:

U-Value of total assembly:

Floors over unconditioned space (each assembly)

R-Value of insulation:

Horizontal/vertical requirement: N/A

(existing wood floor joist in LL

shell scope)

N/A

Exterior Walls (each assembly)

Skylights in each assembly:

U-Value of skylight:

Openings (windows or doors with glazing)

Solar heat gain coefficient: projection factor: Door R-Values:

U-Value of assembly:

total square footage of skylights in each assembly:

Gross Building Area Table

NEW (SQ FT)

n area of air traffic	
e energy code shall for the plan data sheet.	
al energy cost for the	
is not applicable.)	
	1

Party/Fire Wall Separation	N/A			\perp
Smoke Barrier Separation	N/A			+
Smoke Partition	N/A			+
Tenant/Dwelling Unit/ Sleeping Unit Separation	N/A			
Incidental Use Separation	N/A			
2018 NC Administrative Code	and Policies			
(PRO	2018 APPE DE SUMMARY FOR STRUCTURA VIDE ON THE STRUCTURA	ALL COMM L DESIGN		JEC
DESIGN LOADS:				
Importance Factor	Snow (I _S) Seismic (I _E)	_		
Live Loads: NO STRUCTU	IRAL MEZZanine Floor	OF WORK psf psf psf		
Ground Snow Loa	d: psf			
Wind Load:	Basic Wind Speed Exposure Category	mph (ASCE-	7)	
SEISMIC DESIGN CATE	GORY:	ПВ ∏С	\sqcap D	
Provide the following Seismi Occupancy Catego	ry (Table 1604.5)		□ IV	
Spectral Response Site Classification		B □ C □ D	E	
Basic structural sy Bearing Buildin EXISTANG Analygip PloyedTG	Stem (check one) Wall Dual WSpecial CONSTRUCTION THIS SCOPE OF WOF	mediate R/C or Spe Mulum Equivalent Latera	rcial Steel	nic
Architectural, Med	hanical, Components anchore	d? Yes No		
LATERAL DESIGN CON		Wind		
Field Test (provide Presumptive Bearin Pile size, type, and o	copy of test report)	psf psf		

ALLOWABLE HEIGHT

FIRE PROTECTION REQUIREMENTS

N/A

N/A

ilding Height in Feet (Table 504.3)

Building Height in Stories (Table 504.4)

Structural Frame,

Bearing Walls

South

North

West

South

loor Construction

Floor Ceiling Assembly

Roof Ceiling Assembly

Shaft Enclosures - Exit

aft Enclosures - Other

ecupancy/Fire Barrier Separation

Roof Construction, including

upporting beams and joists

and joists

Including supporting beams

onbearing Walls and

Interior


ncluding columns, girders

de code reference if the "Shown on Plans" quantity is not based on Table 504.3 or 504.4.

N/A

0

EPARATION DISTANCE

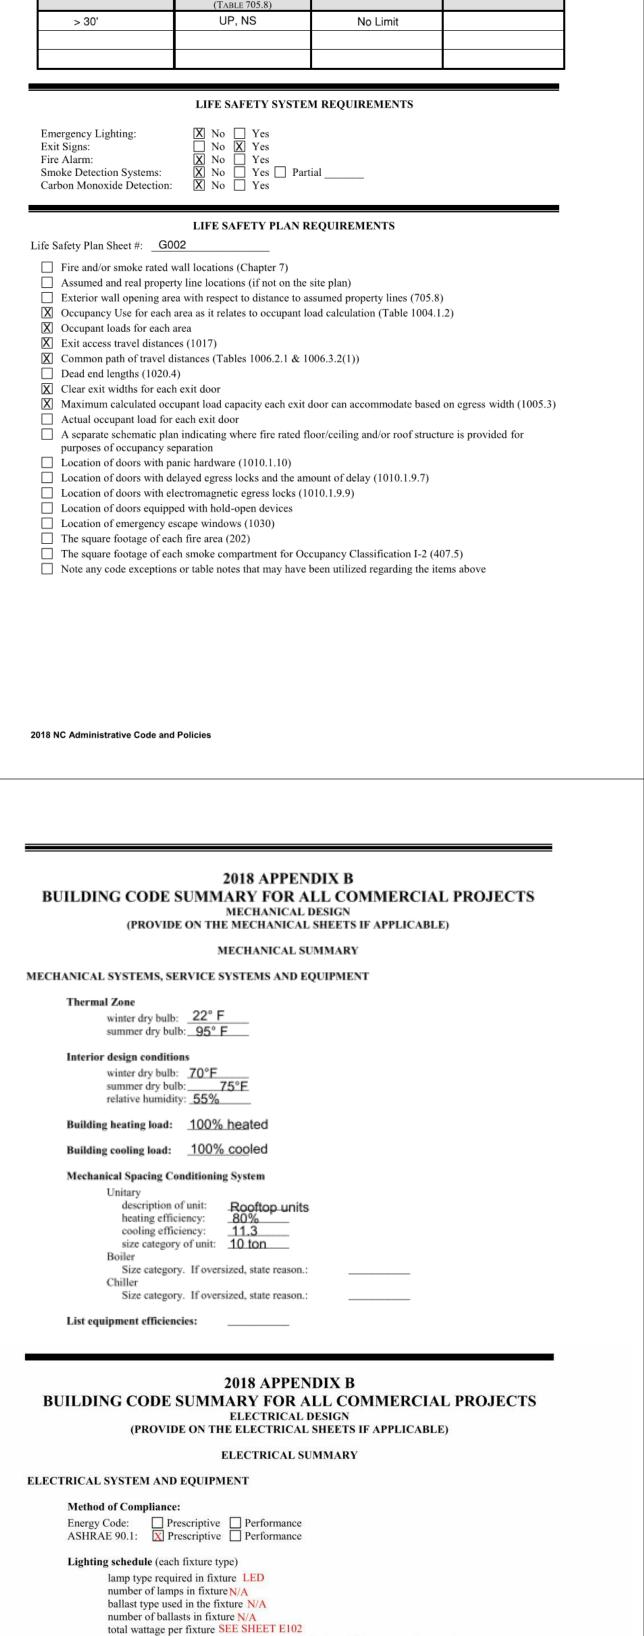

total interior wattage specified vs. allowed (whole building or space by space)

total exterior wattage specified vs. allowed N/A

(When using the 2018 NCECC; not required for ASHRAE 90.1)

C406.3 Reduced Lighting Power Density C406.4 Enhanced Digital Lighting Controls

C406.5 On-Site Renewable Energy

C406.6 Dedicated Outdoor Air System

C406.2 More Efficient HVAC Equipment Performance

C406.7 Reduced Energy Use in Service Water Heating

Additional Efficiency Package Options

PERCENTAGE OF WALL OPENING CALCULATIONS

PROTECTION

FEET) FROM PROPERTY LIN



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BOTH PARTIES.



520 SOUTH MAIN ST, SUITE 2531

AKRON, OH 44311 P: 330-572-2100 F: 330-572-2101 GPD PROJECT NO:

工 28 ()

PROJECT 2778 CAMI STORE #: 59763 85334-001 PROJECT #: ISSUE DATE: For Construction 09/01/21

DESIGN MANAGER: **ASHLEY SUEIRAS** PRODUCTION DESIGNER: GPD GROUP CHECKED BY: GPD GROUP

Revision Schedule

 _,	

SHEET TITLE: APPENDIX B


SCALE: AS SHOWN

SHEET NUMBER:


G003

2018 NC Administrative Code and Policies



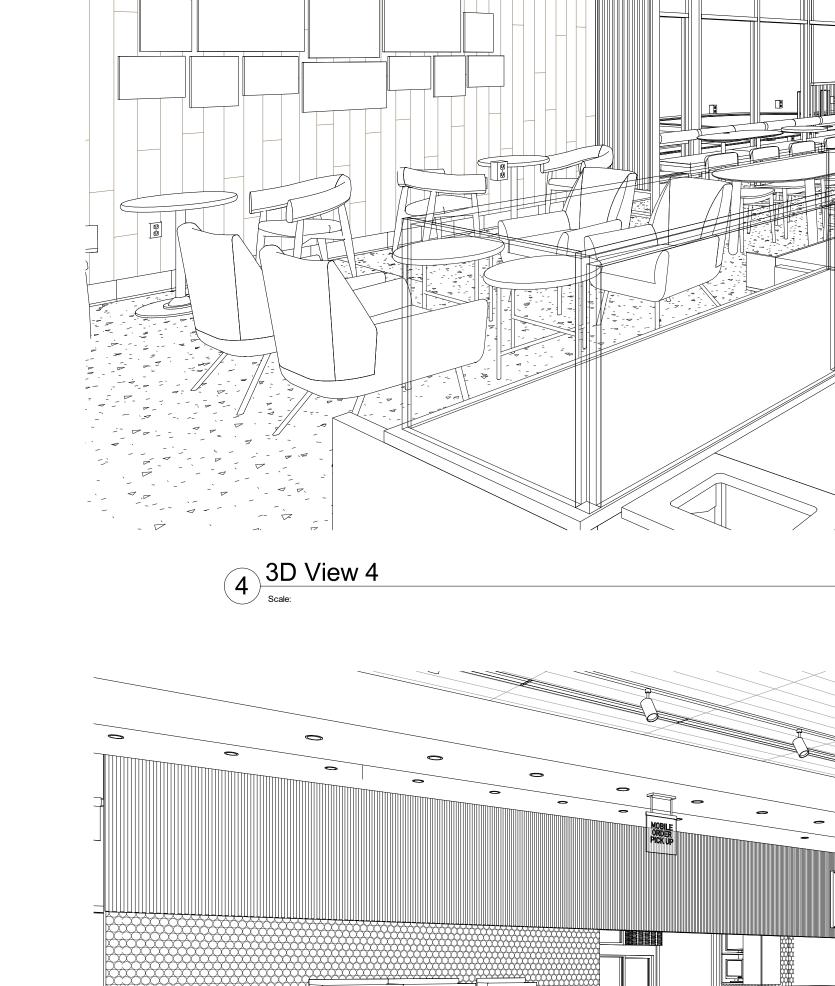

2 3D View 2

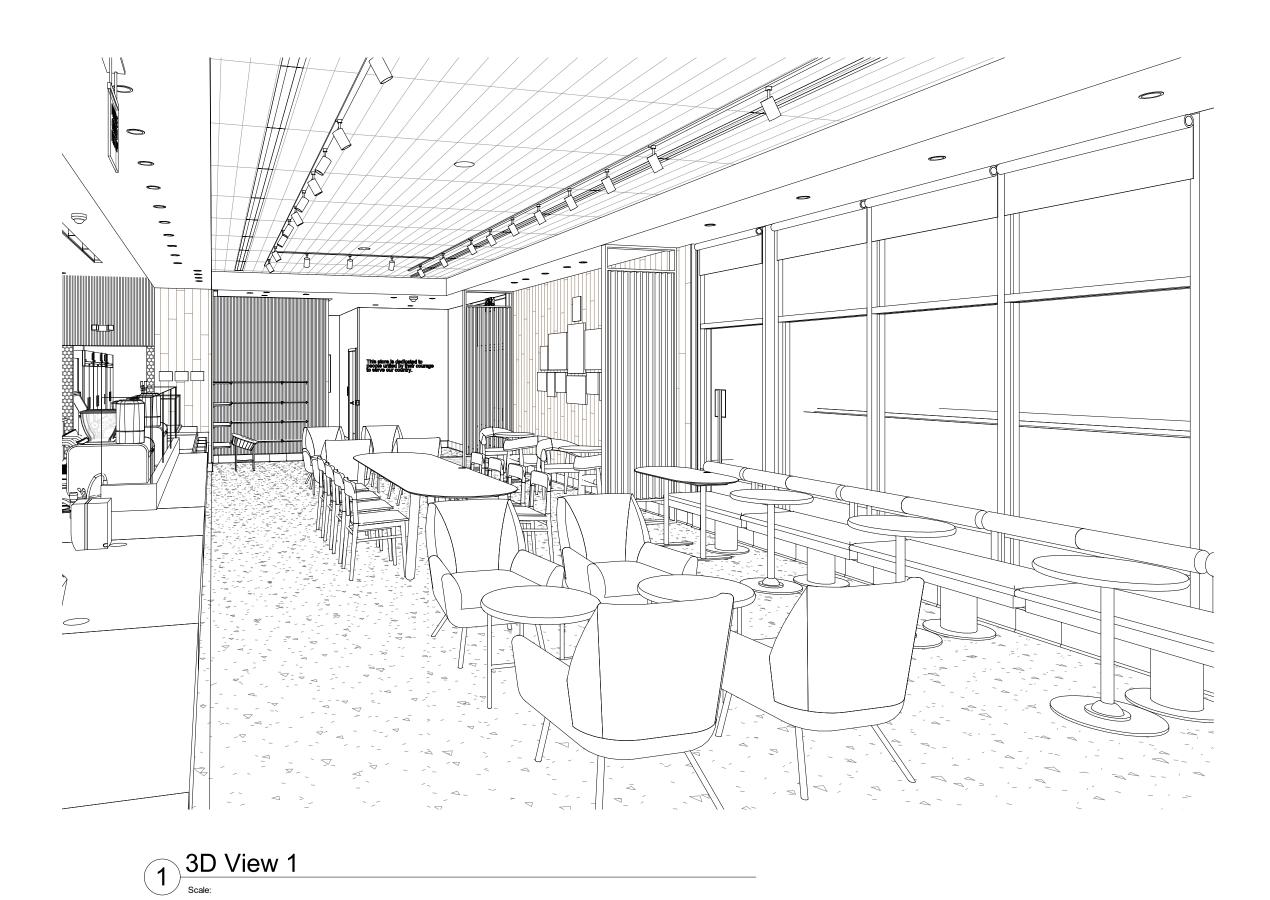





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STORE #: 85334-001 PROJECT #: ISSUE DATE:

DESIGN MANAGER:

PRODUCTION DESIGNER: GPD GROUP

CHECKED BY:

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Revision Schedule

Rev	Date	Ву	Description


SHEET TITLE:
3D VIEWS

SCALE: AS SHOWN

SHEET NUMBER:

G004

						221117172
DESIGN ID		DESCRIPTION	FURN. BY	INST. BY	BULB	COMMENTS
SIGNAGE - I	DISK					
13163	3	SIGN - DISK SF ILLUMINATED FLUSH MOUNTED EVOLVED - 48IN 1220MM	SB	GC		
X13162	1	SIGN - DISK SF NON- ILLUMINATED FLUSH MOUNTED EVOLVED - 36IN 915MM	SB	GC		
SIGNAGE - I	DRIVE THR	Ü	•			•
14091	1	SIGN - DT DIRECTIONAL EXIT SIGN ILLUMINATED ARROW SERIES - 46IN 1170MM	SB	GC		FOUNDATIONS BY GC AND CONDUITS BY LL.
14099	3	SIGN - DRIVE THRU ILLUMINATED ARROW SERIES FLUSH MOUNTED - RH - 48IN 1220MM	SB	GC		FOUNDATIONS BY GC AND CONDUITS BY LL.
14106	1	CLEARANCE BAR	SB	GC		FOUNDATIONS BY GC.
14327	3	SIGN - DT DIRECTIONAL ILLUMINATED	SB	GC		FOUNDATIONS BY GC AND CONDUITS BY LL.
SIGNAGE -	OTHER		1	1		
21163	1	SIGN - MOBILE ORDER PICK UP ILLUMINATED BLADE MOUNT	SB	GC		BOTTOM OF SIGN AT 8' - 6" A.F.F. VENDOR : HILTON
21297	2	SIGN - 5 MINUTE PARKING	SB	GC		FOOTING PROVIDED BY AND INSTALLED BY GC
21720	1	SIGN - MOBILE ORDER PICK UP SUSPENSION KIT	SB	GC		
SIGNAGE - \	NORDMAR	K	•			•
18497	1	SIGN - WORDMARK STARBUCKS FLUSH MOUNTED - 18IN 455MM	SB	GC		

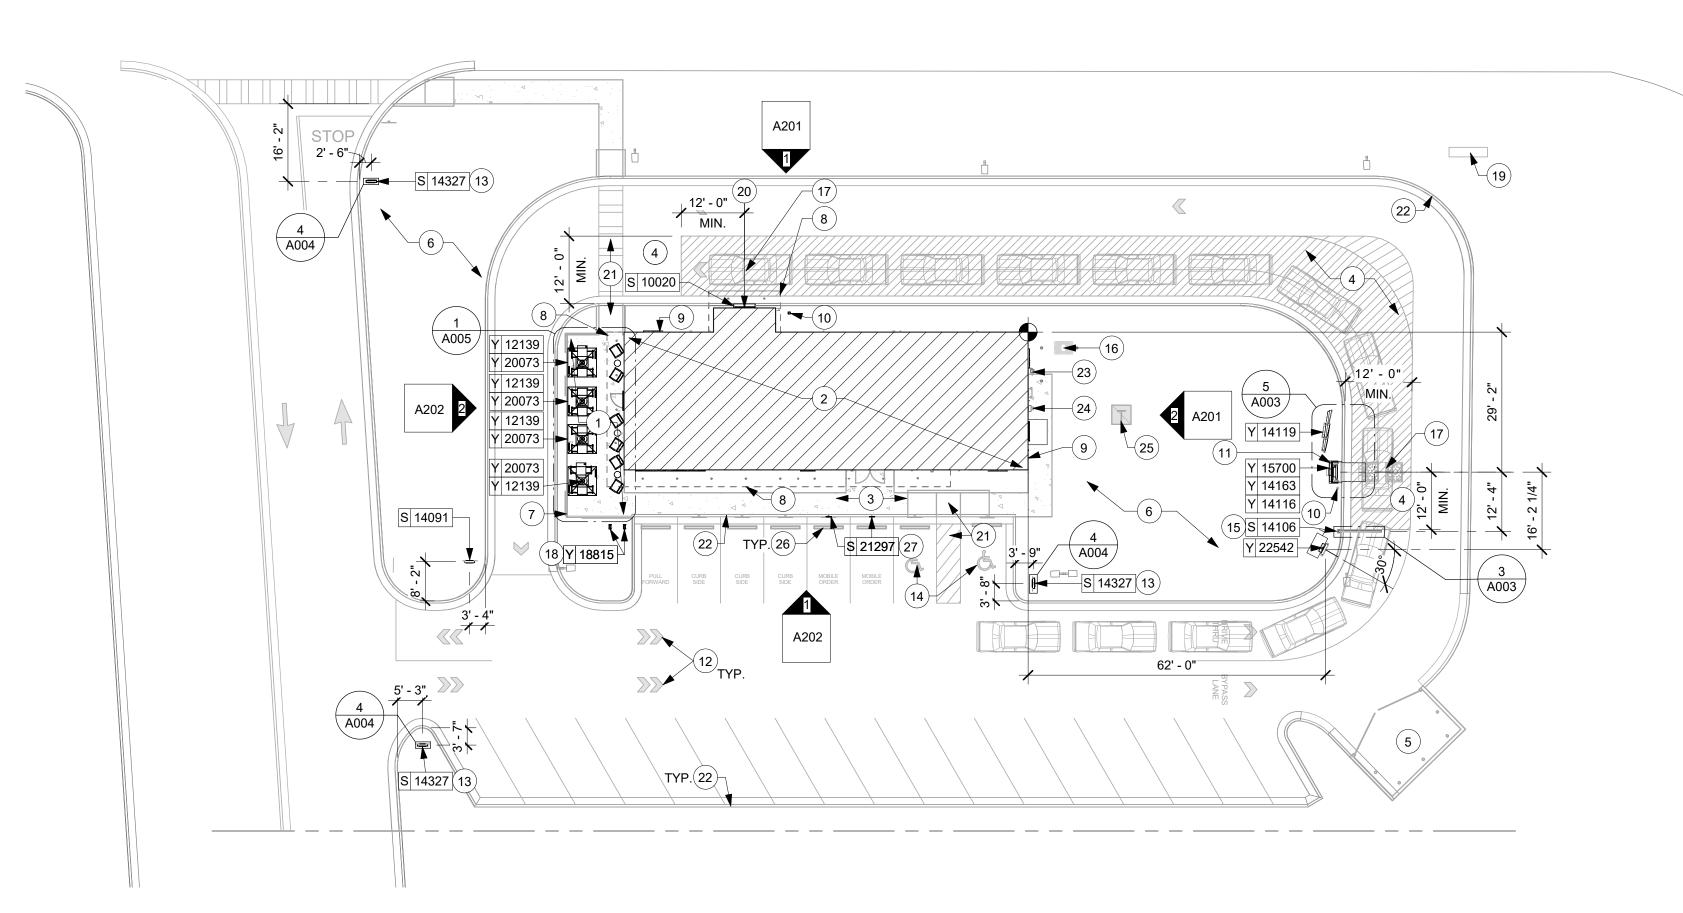

KEYED NOTES

- 1. STARBUCKS PATIO / SEATING AREA.
- 2. HATCH INDICATES STARBUCKS TENANT SPACE.
- 3. SIDEWALKS, BY LL, ENSURE ACCESSIBLE PATH OF TRAVEL TO ENTRY.
- 4. MINIMUM 12'-0" WIDE 6" THICK CONCRETE DRIVE-THRU LANE WITH 6" CURB. EXTEND 12' BEYOND CENTERLINE OF DT WINDOW AND 12' BEFORE ORDER POINT. (BY LL)
- 5. TRASH ENCLOSURE, BY LL.
- 6. LANDSCAPE AREA. BY LL.
- 7. PATIO RAILING, BY LL, REFER TO SHELL CONSTRUCTION DRAWINGS.
- 8. CANOPY ABOVE, BY LL.
- 9. HOSE BIBB (BY LL). LOCATION PER SHELL DRAWINGS, SEE SHELL DRAWINGS FOR ADDITIONAL INFORMATION.
- 10. NON-ILLUMINATED BOLLARD AND FOOTING, BY LL.
- 11. STARBUCKS DRIVE-THRU EQUIPMENT. ASSOCIATED FOUNDATION AND ELECTRICAL CONDUIT WITH PULL STRINGS BY LL, SEE STRUCTURAL AND ELECTRICAL DRAWINGS FOR ADDITIONAL INFORMATION.
- 12. DIRECTIONAL GRAPHIC, BY LL.
- 13. SITE DIRECTIONAL SIGNAGE LOCATION. ASSOCIATED FOOTING AND ELECTRICAL CONDUIT WITH PULL STRINGS BY LL. SEE STRUCTURAL AND ELECTRICAL DRAWINGS.
- 14. ACCESSIBLE PARKING SPACES, BY LL, SEE CIVIL PLANS.
- 15. DT CLEARANCE BAR LOCATION. ASSOCIATED FOOTING BY LL.
- 16. PROPOSED LOCATION OF BELOW-GROUND GREASE INTERCEPTOR, BY LL, SEE PLUMBING DRAWINGS.
- 17. DT DETECTOR LOOP AT ORDER POINT AND DT WINDOW, BY LL, SEE ELECTRICAL FOR MORE INFORMATION.
- 18. HOOP BIKE RACK, BY LL. SEE SHELL BUILDING CONSTRUCTION DRAWINGS FOR DETAILS.
- 19. LOCATION OF POLE SIGN BY LANDLORD. ASSOCIATED FOOTING AND ELECTRICAL CONDUIT WITH PULL STRINGS BY G.C., FOOTINGS AND SIGN TO BE DESIGNED AND PERMITTED BY OTHERS UNDER SEPARATE SUBMITTAL.
- 20. DRIVE-THRU WINDOW WITH AIR CURTAIN, BY LL.
- 21. STRIPING AND CURB RAMP BY LL.
- 22. 6" CONCRETE CURB, TYPICAL.
- 23. GAS METER LOCATION BY LL.
- 24. ELECTRICAL CABINET AND METER LOCATION BY LL.
- 25. LOCATION FOR PAD MOUNTED TRANSFORMER, BY LL. CONFIRM WITH UTILITY COMPANY.
- 26. WHEEL STOPS BY LL
- 27. LOCATION OF MOP CUSTOMER PARKING SIGNAGE.

GENERAL NOTES

WALKWAY SURFACES.

- A. REFER TO EXTERIOR ELEVATIONS ON SHEET A201 FOR BUILDING SIGNAGE LOCATION AND DESIGN ID. REFER TO ELECTRICAL PLANS FOR ELECTRICAL REQUIREMENTS.
- B. LANDSCAPING TO BE PROVIDED PER ZONING CODE AND SUSTAINABILITY REQUIREMENTS.
- C. DRIVE-THRU EQUIPMENT INCLUDING VEHICLE DETECTION LOOP, WIRELESS COMMUNICATION AND MONITORS SHALL BE COORDINATED BY STARBUCKS CONSTRUCTION MANAGER. REFER TO ELECTRICAL DRAWINGS FOR ADDITIONAL REQUIREMENTS.
- D. PROVIDE 6" (150MM) THICK CONCRETE PAVING THE LENGTH OF THE DRIVE-THRU LANE, EXTENT TO INCLUDE DRIVE-THRU ENTRY POINT THROUGH WINDOW STANDING PAD.
- E. GENERAL CONTRACTOR TO APPLY CONCRETE SEALER TO ALL EXTERIOR CONCRETE PATIO AND
- F. GENERAL CONTRACTOR TO VERIFY ALL EXISTING ELEVATIONS AND BUILDING CONDITIONS IN FIELD PRIOR TO START OF CONSTRUCTION.
- G. PROVIDE DETECTABLE WARNING (IF APPLICABLE PER LOCAL CODE) AT TRANSITION FROM SIDEWALK TO DRIVE AISLE.
- H. ACCESSIBLE PARKING SPACES AND ACCESS AISLES SHALL HAVE SURFACE SLOPE NOT TO EXCEED 2% IN ALL DIRECTIONS.
- I. REFER TO ELECTRICAL DRAWINGS FOR SITE RELATED ELECTRICAL WORK.
- J. SCRAPE AND REPAINT ALL EXISTING PAINTED SITE FEATURES, INCLUDING, BUT NOT LIMITED TO CURBS, BOLLARDS, RAILINGS AND SITE LIGHTING BASES.
- K. SEE SHEET A002 FOR ARCHITECTURAL SITE

LEGEND

 $\underset{\downarrow}{\cancel{2}} \underset{\downarrow}{\cancel{2}} \underset{\downarrow}{\cancel{2}} \underset{\downarrow}{\cancel{2}} \underset{\downarrow}{\cancel{2}} \underset{\downarrow}{\cancel{2}}$ LANDSCAPE AREA

NEW CONCRETE WALKWAY

NEW 6" (150MM) CONCRETE CURB

CONCRETE DRIVE THRU LANE

———— ACCCESSIBLE PATH OF TRAVEL



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GPD PROJECT NO: 2020261.36

STORE #: PROJECT #: ISSUE DATE:


85334-001 For Construction ASHLEY SUEIRAS


59763


PRODUCTION DESIGNER: GPD GROUP CHECKED BY: **GPD GROUP**


ARCHITECTURAL SITE PLAN

SCALE: AS SHOWN SHEET NUMBER:

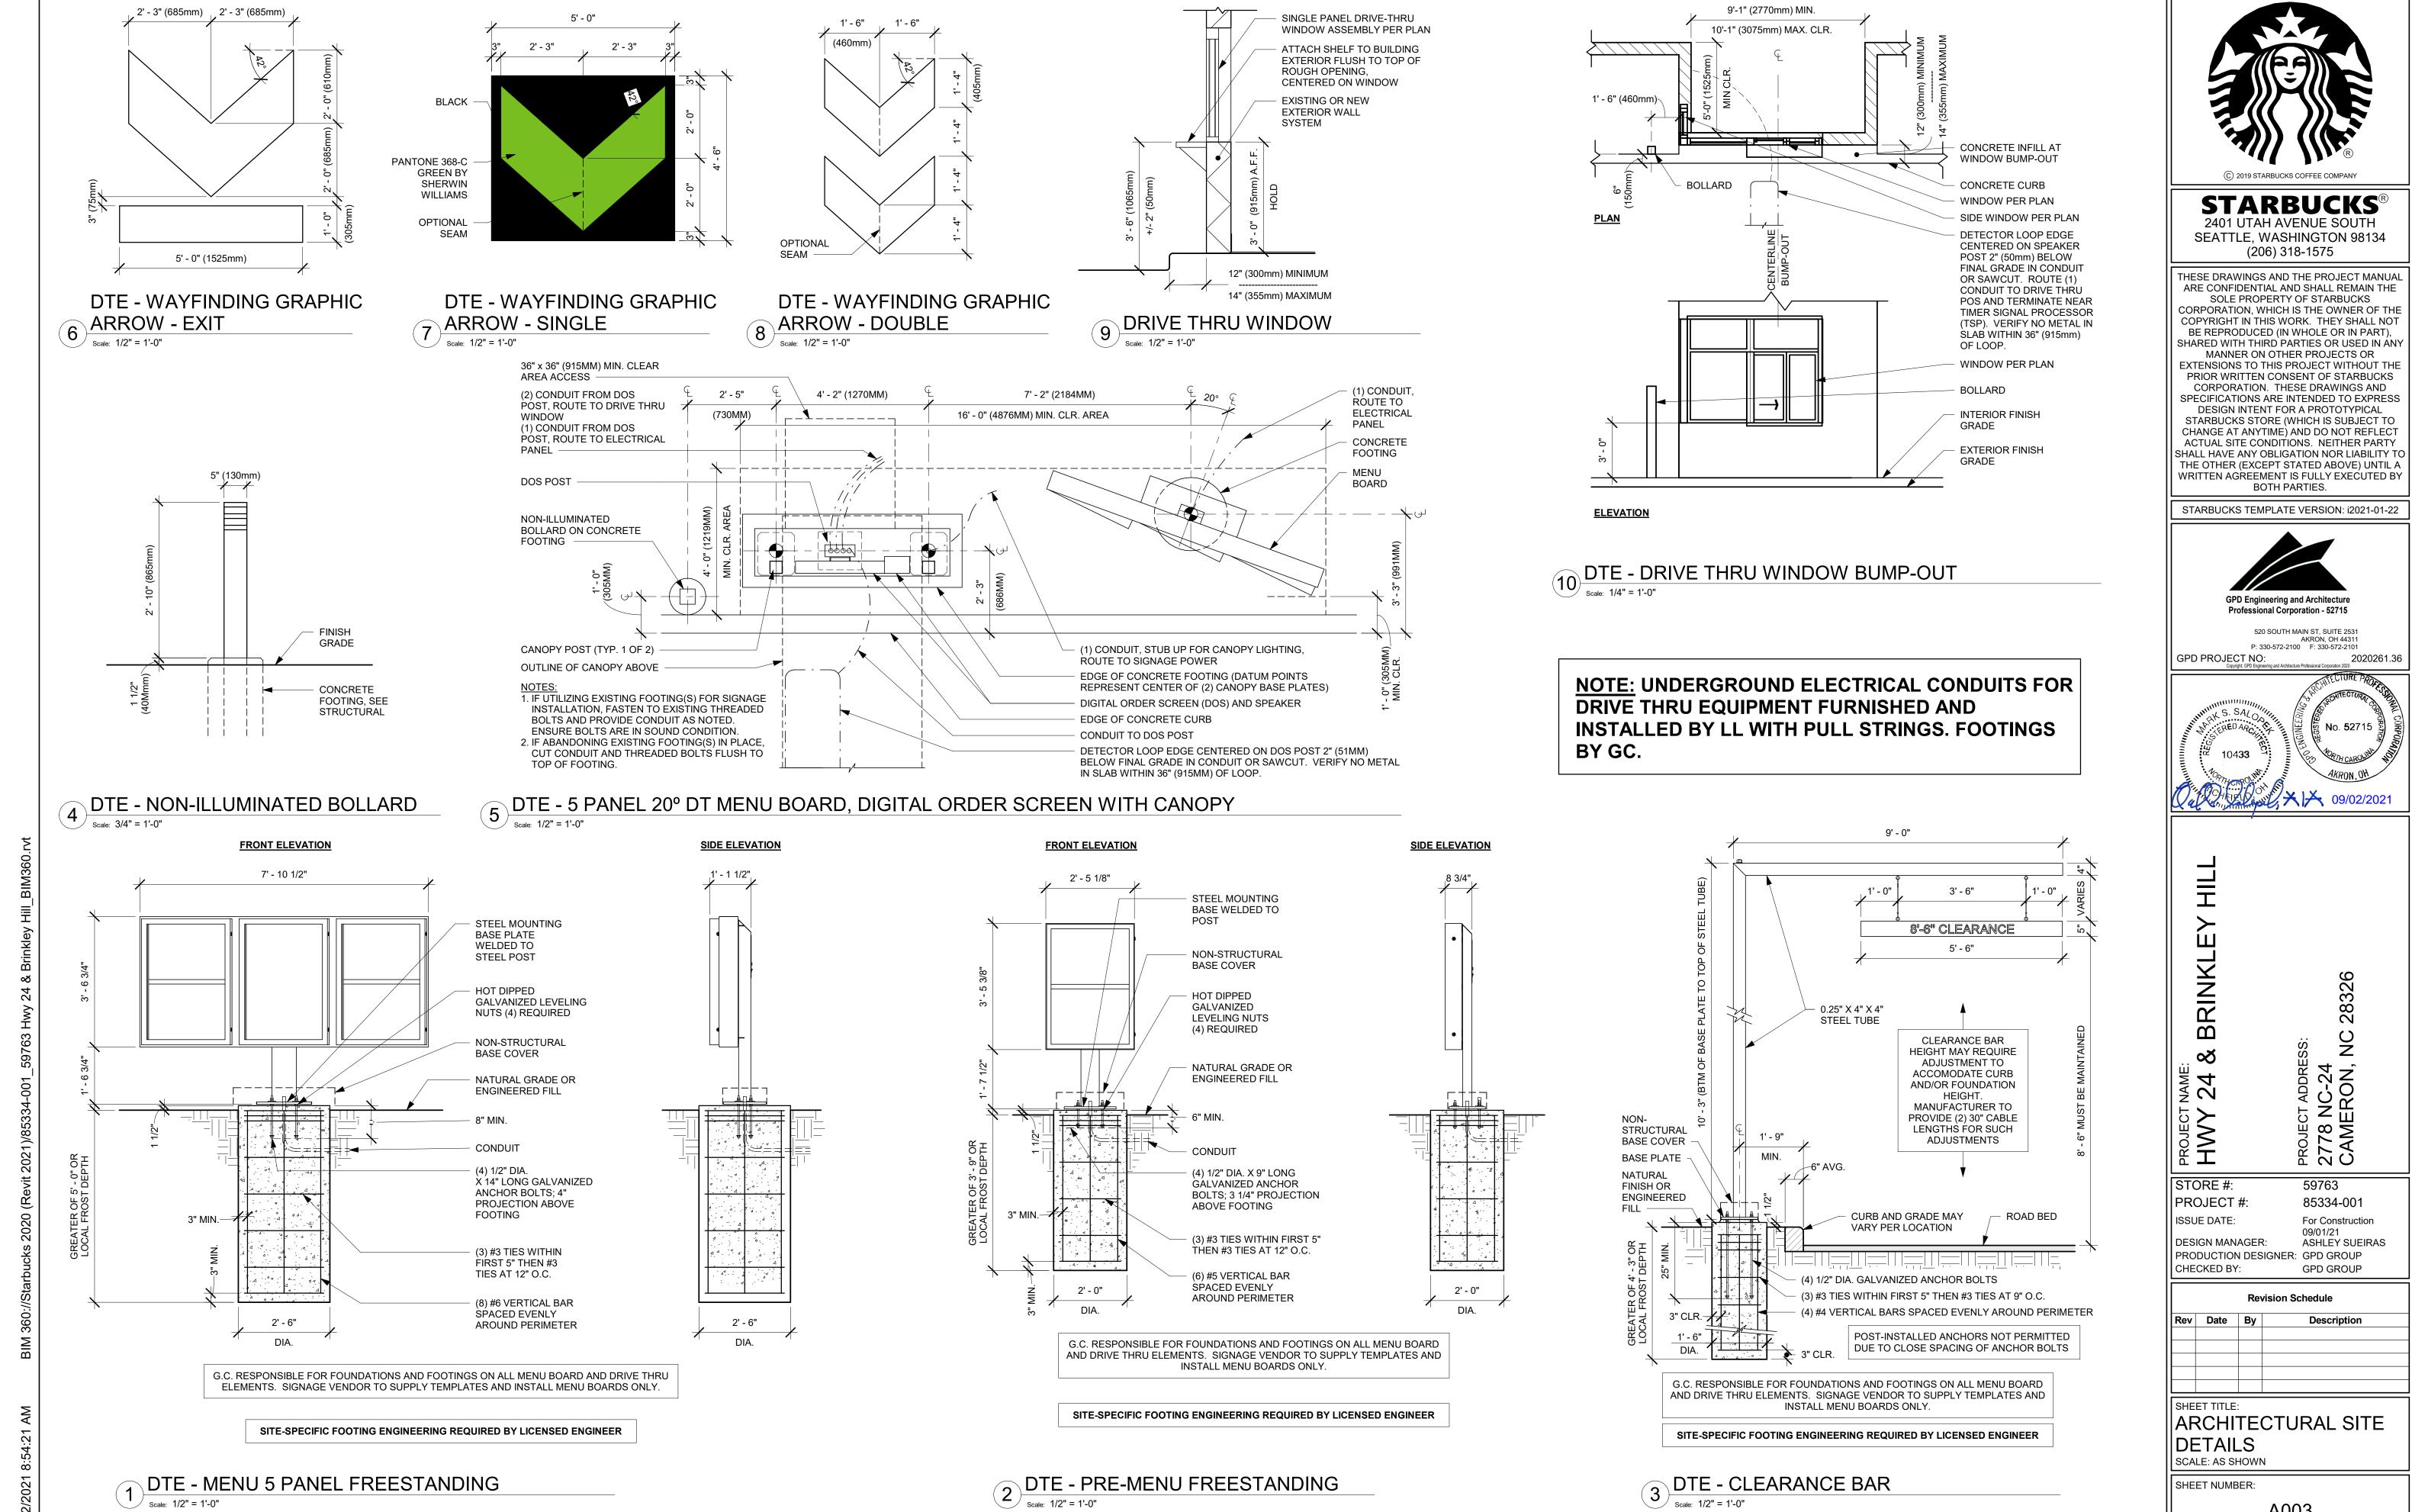

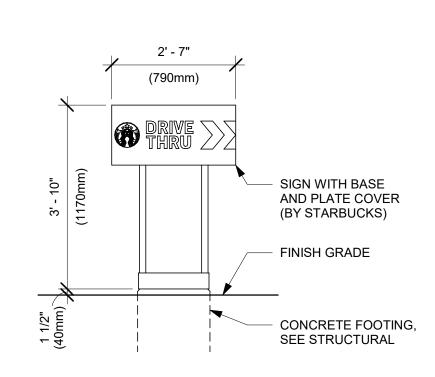

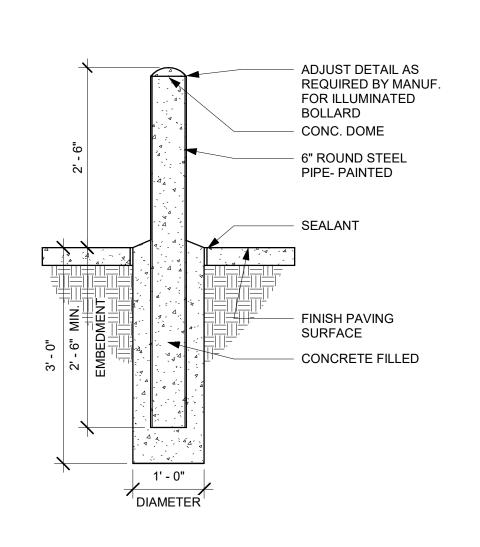

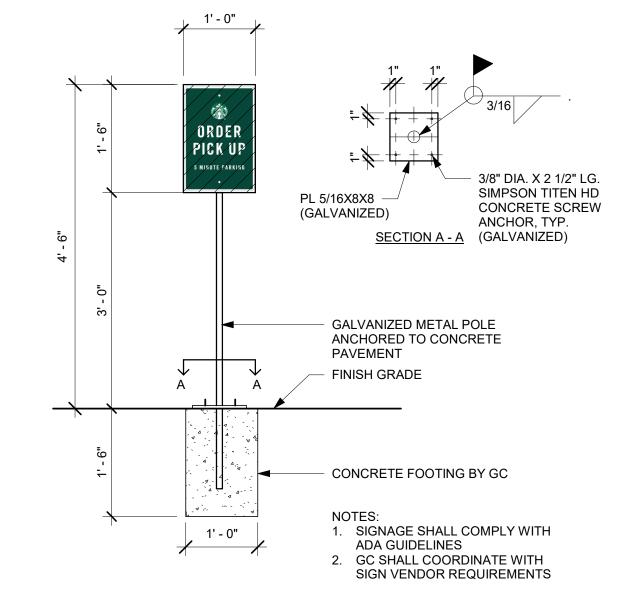

3 DTE - DIRECTIONAL SIGN

4 DTE - DIRECTIONAL SIGN - ENTRY

5 SITE - BOLLARD DETAIL - BY LL

6 MOP FOOTING (BY GC)

FRONT ELEVATION SIDE ELEVATION 6' - 7 7/8" CANOPY ABOVE DOS AND SPEAKER STEEL BASE PLATE WELDED TO STEEL POSTS BY MFR. 1/2" HOT DIPPED GALVANIZED LEVELING NUTS (12) REQUIRED NON-STRUCTURAL BASE COVER NATURAL GRADE OR ENGINEERED FILL 6" MIN. (12) 1/2" DIA. **GALVANIZED ANCHOR RODS** WITH 6" MIN. EMBEDMENT; 3" PROJECTION ABOVE FOOTING (TYP. AT EACH PLATE) CONDUIT 3" CLR. (5) #5 LONG LENGTH, (10) #5 SHORT __3" CLR. LENGTH TOP AND BOTTOM 2' - 0" 6' - 0"

SITE-SPECIFIC FOOTING ENGINEERING REQUIRED BY LICENSED ENGINEER

DTE - DIGITAL ORDER SCREEN AND CONTROL BOX WITH CANOPY

(4) AT EACH CANOPY BASE PLATE (4) AT DOS BASE PLATE FOOTING SITE PLAN EDGE OF CONCRETE FOOTING -2' - 5" 3' - 1" **OUTLINE OF CANOPY** BASE PLATE (TYP. 1 OF 2)) DOS STUB-UPS **CANOPY LIGHTING** STUB-UP -

ANCHORS TO

BE PROVIDED

ROUTE

ELECTRICAL

ALL CONDUIT

BE 3" ABOVE

CONDUIT PER | STUB-UPS TO

2 DTE DOS CANOPY BOLT PATTERN (TOP VIEW)

Scale: 1" = 1'-0"

BASE COVER OUTLINE

ANCHOR BOLT (TYP.):

OUTLINE OF DOS POST BASE PLATE

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GPD PROJECT NO:



PROJECT 2778 CAMI

59763

GPD GROUP

STORE #: PROJECT #: ISSUE DATE:

CHECKED BY:

85334-001 For Construction DESIGN MANAGER: ASHLEY SUEIRAS PRODUCTION DESIGNER: GPD GROUP

Revision Schedule

Description

ARCHITECTURAL SITE DETAILS SCALE: AS SHOWN

SHEET NUMBER:


12' - 0 1/4"

RAILING SPECIFICATION:

MANUFACTURER: AMERISTAR FENCE
STYLE: ECHELON PLUS 3/4 RAIL MAJESTIC PANEL

FINISH: BLACK POWDER-COATED ALUMINUM

NOTE: CONTRACTOR TO PROVIDE SHOP DRAWINGS TO

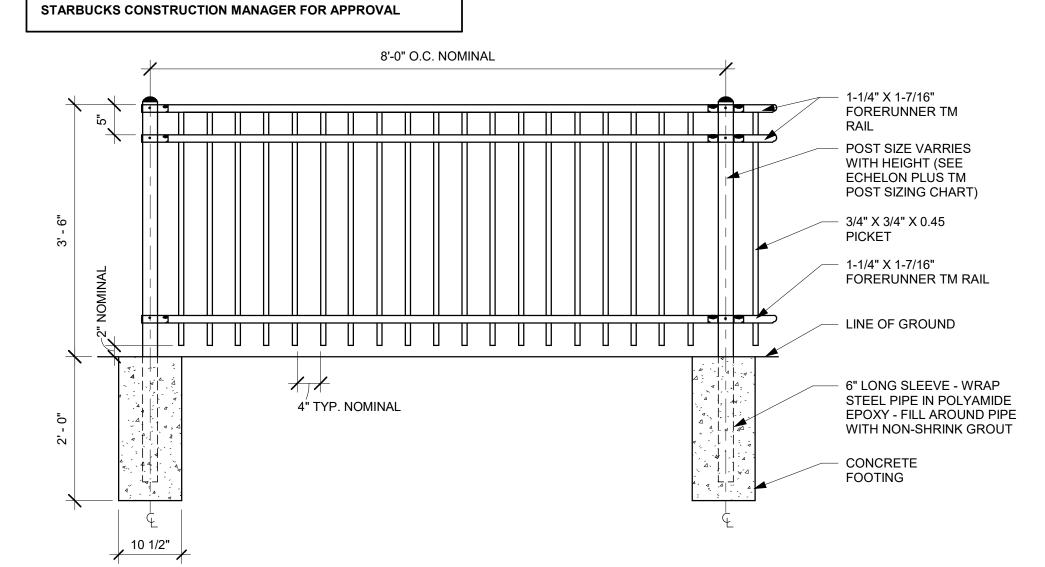

2 RAILING DETAIL

Scale: N.T.S.



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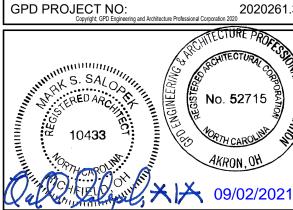
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24 & BRINKLEY HILL

PROJECT ADDRESS: 2778 NC-24 CAMERON, NC

STORE #: 59763
PROJECT #: 85334-001
ISSUE DATE: For Construction 09/01/21
DESIGN MANAGER: ASHLEY SUEIRA

DESIGN MANAGER: ASHLEY SUEIRAS PRODUCTION DESIGNER: GPD GROUP CHECKED BY: GPD GROUP

Revision Schedule

Rev Date By Description

RAILING DETAILS

SCALE: AS SHOWN

SHEET NUMBER:

4-F-A 6" 20 GA STUDS @ 16" O.C.

D 10205 2

TAG	DESCRIPTION	INSULATION	NOTES
1-T-N	1 1/2" 20 GA STUD FURRING WALL	NONE	TERMINATE 6" ABOVE CEILING. SEE PLAN FOR WALL SHEATHING.
2-T-N	3 5/8" 20 GA STUD FURRING WALL	NONE	TERMINATE 6" ABOVE CEILING. SEE PLAN FOR WALL SHEATHING.
3-F-A	3 5/8" 20 GA STUDS @ 16" O.C.	ACOUSTIC	FULL HT. WALL. SEE PLAN FOR WALL SHEATHING.
3-F-N	3 5/8" 20 GA STUDS @ 16" O.C.	NONE	FULL HT. WALL. SEE PLAN FOR WALL SHEATHING.
3-P-N	3 5/8" 16 GA STUDS @ 16" O.C.		PARTIAL HT. WALL W/ RCKW RIGID CONNECTORS AT FLOOR. SEE ELEVATIONS FOR WALL HT. SEE PLAN FOR WALL SHEATHING.
3-T-N	3 5/8" 20 GA STUDS @ 16" O.C.		TERMINATE 6" ABOVE CEILING. PROVIDE 45 DEGREE METAL STUD BRACING AT 48" O.C. FROM STUD WALL TO STRUCTURE ABOVE. SEE PLAN FOR WALL SHEATHING.

15' - 3"

ACOUSTIC FULL HT. WALL. SEE PLAN FOR WALL SHEATHING.

10' - 11 3/4"

BACKBAR

WALL BLOCKING KEY

WALL BLOCKING RET						
SYMBOL	ITEM	WEIGHT	HEIGHT A.F.F.	APPROX. WIDTH		
A	WORKROOM HAND SINK	128 LBS (58 KG)	36" TO 40" (915MM TO 1015MM)	30" (760MM) BEHIND SINK		
B	SHELVES ABOVE COMPARTMENT SINK	200 LBS (91 KG)	48" TO 76" (1220MM TO 1930MM)	96" (2440MM) CENTERED ABOVE COMPARTMENT SINK		
C	UPPER WIRE SHELVES	BLOC	CKING SPECIFICATION 1	O BE PROVIDED BY VENDOR		
D	SHELVES AT MANAGER'S DESK	300 LBS (136 KG)	32" TO 96" (810MM TO 2440MM)	48" (1220MM) 3/4 (19MM) ACX PLYWOOD, CENTERED ON SHELVES		
E	EQUIPMENT RACK AT MANAGER'S DESK	300 LBS (136 KG)	44" TO 96" (1120MM TO 2440MM)	28" (710MM) 3/4 (19MM) ACX PLYWOOD, CENTERED ON RACK		
F	METRO SHELVES	WALL BLO	OCKING PREFERRED, H	BE PROVIDED BY VENDOR. IN- OWEVER EXISTING FRP FINISHED E MOUNTED, PAINTED WHITE.		
G	RESTROOM GRAB BARS	200 LBS (91 KG)	30" TO 36" (760MM TO 915MM)	60" (1525MM) AROUND WATER CLOSET		
H	RESTROOM HAND SINK	200 LBS (91 KG)		LLATION REQUIRES CONCEALED FER TO MFR'S SPECIFICATION.		
	MILLWORK BOXES	BLOCK		R FRENCH CLEATING SYSTEM.) DETAILS.		
J	DIAPER CHANGING STATION	250 LBS (113 KG)	40 1/2" TO 46 1/2" (1030MM TO 1180MM)	32" (810MM) BEHIND STATION		
K	UPPER CBE SHELVING	BLOCKING SPECIFICATION FOR CBE METAL SHELVES. REFER TO VENDOR'S SPECIFICATION AND DETAILS.				
L	WATER FILTRATION SYSTEM	TBD BY VENDOR	COORDINATE LOCAT	ION AND EXTENT WITH PENTAIR		
M	ALL ARTWORK, FIXTURES, ACCESSORIES AND CASEWORK FABRICATIONS NOT OTHERWISE NOTED	TBD BY VENDOR (VARIES)	ALL ITEMS FOR INSTALLATION. E	LL BLOCKING AS REQUIRED FOR A COMPLETE AND SECURE EXTEND BLOCKING 8" (205MM) EACH SIDE OF EACH ITEM.		

WALL SHEATHING KEY K

SYMBOL	DESCRIPTION
A	INDICATES SHEATHING TRANSITION
A	5/8" GYP. WALL BOARD (FULL WALL HEIGHT)
В	5/8" GYP. WALL BOARD (TERMINATE AT 6" (150MM) ABOVE CEILING)
c	5/8" CEMENTITIOUS BACKER BOARD (TERMINATE AT 6" (150MM) ABOVE CEILING)
D	5/8" CEMENTITIOUS BACKER BOARD (TERMINATE AT FINISH TRANSITION AS SHOWN ON INTERIOR ELEVATION W/ 5/8" GYP. WALL BOARD ABOVE (FULL WALL HEIGHT)).
E	5/8" FIRE RATED PLYWOOD BACKING FOR WOOD WALL CLADDING (TERMINATE AT 6" ABOVE CEILING).
F	(1) LAYER OF TYPE 'X' WATER RESITANT GYP. BD.

6' - 0 3/4"

3-F-N 2-T-N

9' - 8"

6' - 3"

D 10449 1

KEYED NOTES

- INSTALL NEW CONCRETE SLAB OVER VAPOR BARRIER OVER EXISTING COMPACTED FILL. IF APPLICABLE: REFER TO STRUCTURAL FOR CONNECTION OF NEW SLAB TO EXISTING.
- 2. OUTLINE OF BAR PER CASEWORK MANUFACTURER.
- 3. ELECTRICAL PANEL LOCATIONS. MAINTAIN MINIMUM CLEARANCE AS REQUIRED BY CODE.
- 4. ALIGN FACE OF FINISHED WALL.
- 5. OUTLINE OF SOFFIT ABOVE.
- 6. OUTLINE OF CANOPY ABOVE.

22' - 8 1/4"

(F)

12' - 10 1/4"

DX10111 3

WORKROOM

7. FUR OUT INTERIOR FACE OF WALL.

GENERAL NOTES

- A. GENERAL CONTRACTOR TO VERIFY ALL DIMENSIONS AND NOTIFY STARBUCKS CONSTRUCTION MANAGER OF ANY DISCREPANCIES PRIOR TO CONSTRUCTION. ALL DIMENSIONS TO BE TAKEN FROM DESIGNATED DATUM POINT.
- B. GENERAL CONTRACTOR TO PROVIDE FIRE TREATED WOOD STUD BLOCKING, OR EQUIVALENT TO SUPPORT ANY WALL ATTACHMENT AND/OR SIGNAGE.
- C. IF EXISTING EXTERIOR ENTRANCE THRESHOLD EXCEEDS MINIMUM BARRIER FREE PROVISION OF THE CODE, REMOVE AND REPLACE WITH ACCESSIBLE THRESHOLD. RAISED THRESHOLDS AND FLOOR LEVEL CHANGES AT ACCESSIBLE DOORWAYS TO BE BEVELED WITH A SLOPE NO GREATER THAN 1:12.
- D. ALL DIMENSIONS ARE TO FINISHED FACE UNLESS SHOWN OR NOTED OTHERWISE.
- E.. INSTALL MOISTURE RESISTANT GREEN BOARD ON BACKBAR WALL PER PROJECT MANUAL.
- F. ALL DOORS SHALL BE 32" (815MM) MINIMUM CLEAR OPENING WHEN OPENED TO 90 DEGREE POSITION UNLESS OTHERWISE NOTED.
- G. SEE SHEET A601 FOR EXTERIOR DOOR AND WINDOW SCHEDULES.
- H. STARBUCKS VENDOR TO PROVIDE DOOR HARDWARE COMPONENTS AND GC TO INSTALL.
- I. VERIFY ALL EXISTING DOORS, HARDWARE AND FRAMES MEET STARBUCKS AND/OR CODE REQUIREMENTS.
- J. PROVIDE FIRE EXTINGUISHERS AS NOTED ON THE
- APPROVED PLANS FROM THE CITY.
- K. SEE STRUCTURAL FOR KNEE WALL BRACING.
- L. SEE SHEET A501 FOR BUILDING DETAILS.
- M. REFER TO SHEET I104 FOR FLOOR FINISHES.

GENERAL LEGEND

<u>////////</u>	NEW FULL HEIGHT WALL
	NEW PARTIAL HEIGHT WALL
	EXISTING WALL
<u> </u>	WALL BLOCKING CALL-OUT
(xx)	WALL SHEATHING CALL-OUT



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BOTH PARTIES.



520 SOUTH MAIN ST, SUITE 2531 AKRON, OH 44311 P: 330-572-2100 F: 330-572-2101

P: 330-572-2100 F: 330-572-2101

GPD PROJECT NO: 2020

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S. SAL

No. 52715

No. 52715

AKRON, OH

O9/02/2021

24 & BRINKLEY HILI
ADDRESS:
IC-24

STORE #: 59763
PROJECT #: 85334-001
ISSUE DATE: For Construct 09/01/21

ISSUE DATE: For Construction 09/01/21
DESIGN MANAGER: ASHLEY SUEIRAS PRODUCTION DESIGNER: GPD GROUP CHECKED BY: GPD GROUP

Revision Schedule

Rev	Date	Ву	Description

BUILDING FLOOR PLAN


SCALE: AS SHOWN

SHEET NUMBER:
A101

ST FLOOR - FLOOR PLAN

cale: 1/4" = 1'-0"

0 2' 4' 8' N

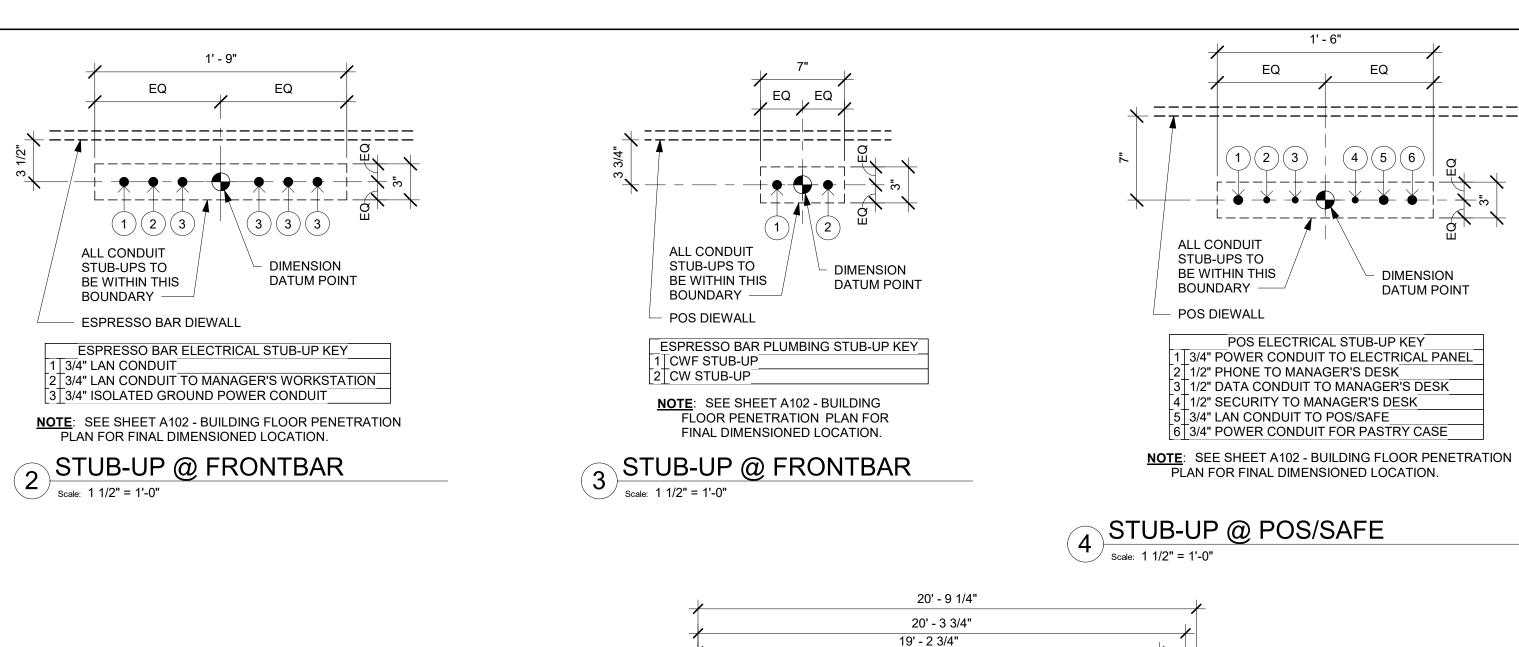

KEYED NOTES

- 1. ELECTRICAL STUB-UP LOCATION. SEE ELECTRICAL
- 2. PLUMBING STUB-UP LOCATION. SEE PLUMBING DRAWINGS.
- 3. FLOOR SINK LOCATION. SEE PLUMBING DRAWINGS.
- 4. FLOOR DRAIN LOCATION. SEE PLUMBING DRAWINGS
- 5. FLOOR CLEAN-OUT. SEE PLUMBING DRAWINGS.
- 6. MOP SINK WASTE.
- 7. WATER CLOSET WASTE.
- 8. GREASE WASTE INTERCEPTOR, SEE PLUMBING DRAWINGS.
- 9. BANQUETTES WITH THROUGH-SLAB POWER THROUGH TABLE BASE, SEE ELECTRICAL DRAWINGS,

GENERAL NOTES

- A. ALL STUB-UP DIMENSIONS ARE RELATIVE TO FINISHED WALL LOCATIONS (SHOWN AS OUTLINES ON THIS PLAN). REFER TO FLOOR PLAN FOR WALL PLACEMENT.
- B. FLOOR SINK: REFER TO CUT SHEETS FOR COMPONENT SPECIFICATIONS AND CUTOUT REQUIREMENTS.
- C. WASTE LINE PENETRATIONS: REFER TO PLUMBING
- D. STUB-UP PENETRATIONS: REFER TO ELECTRICAL AND PLUMBING PLANS FOR INDIVIDUAL STUB-UP LOCATIONS.
- E. TOILET FLOOR PENETRATION: REFER TO CUT SHEETS
- FOR STUB-UP LOCATION RELATIVE TO FINISHED WALL.
- F. PENETRATION TO BE LOCATED ON CENTERLINE OF WALL OR AS REQUIRED PER CONDITIONS.

PLANS FOR INDIVIDUAL LINE LOCATIONS.

- G. TRENCHING OUTLINE FOR GUIDELINE USE ONLY. GENERAL CONTRACTOR TO COORDINATE WITH SPECIFIC TRADES AND SITE CONDITIONS TO DETERMINE ACTUAL LAYOUT.
- H. REFER TO SHEET I101 FOR FLOOR FINISHES.



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520 SOUTH MAIN ST, SUITE 2531 AKRON, OH 44311 P: 330-572-2100 F: 330-572-2101

GPD PROJECT NO:

PROJECT #:

59763 85334-001 For Construction 09/01/21 ASHLEY SUEIRAS


DESIGN MANAGER: PRODUCTION DESIGNER: GPD GROUP CHECKED BY: **GPD GROUP**

BUILDING FLOOR PENETRATION PLAN

SCALE: AS SHOWN SHEET NUMBER:

STORE #:

ISSUE DATE:

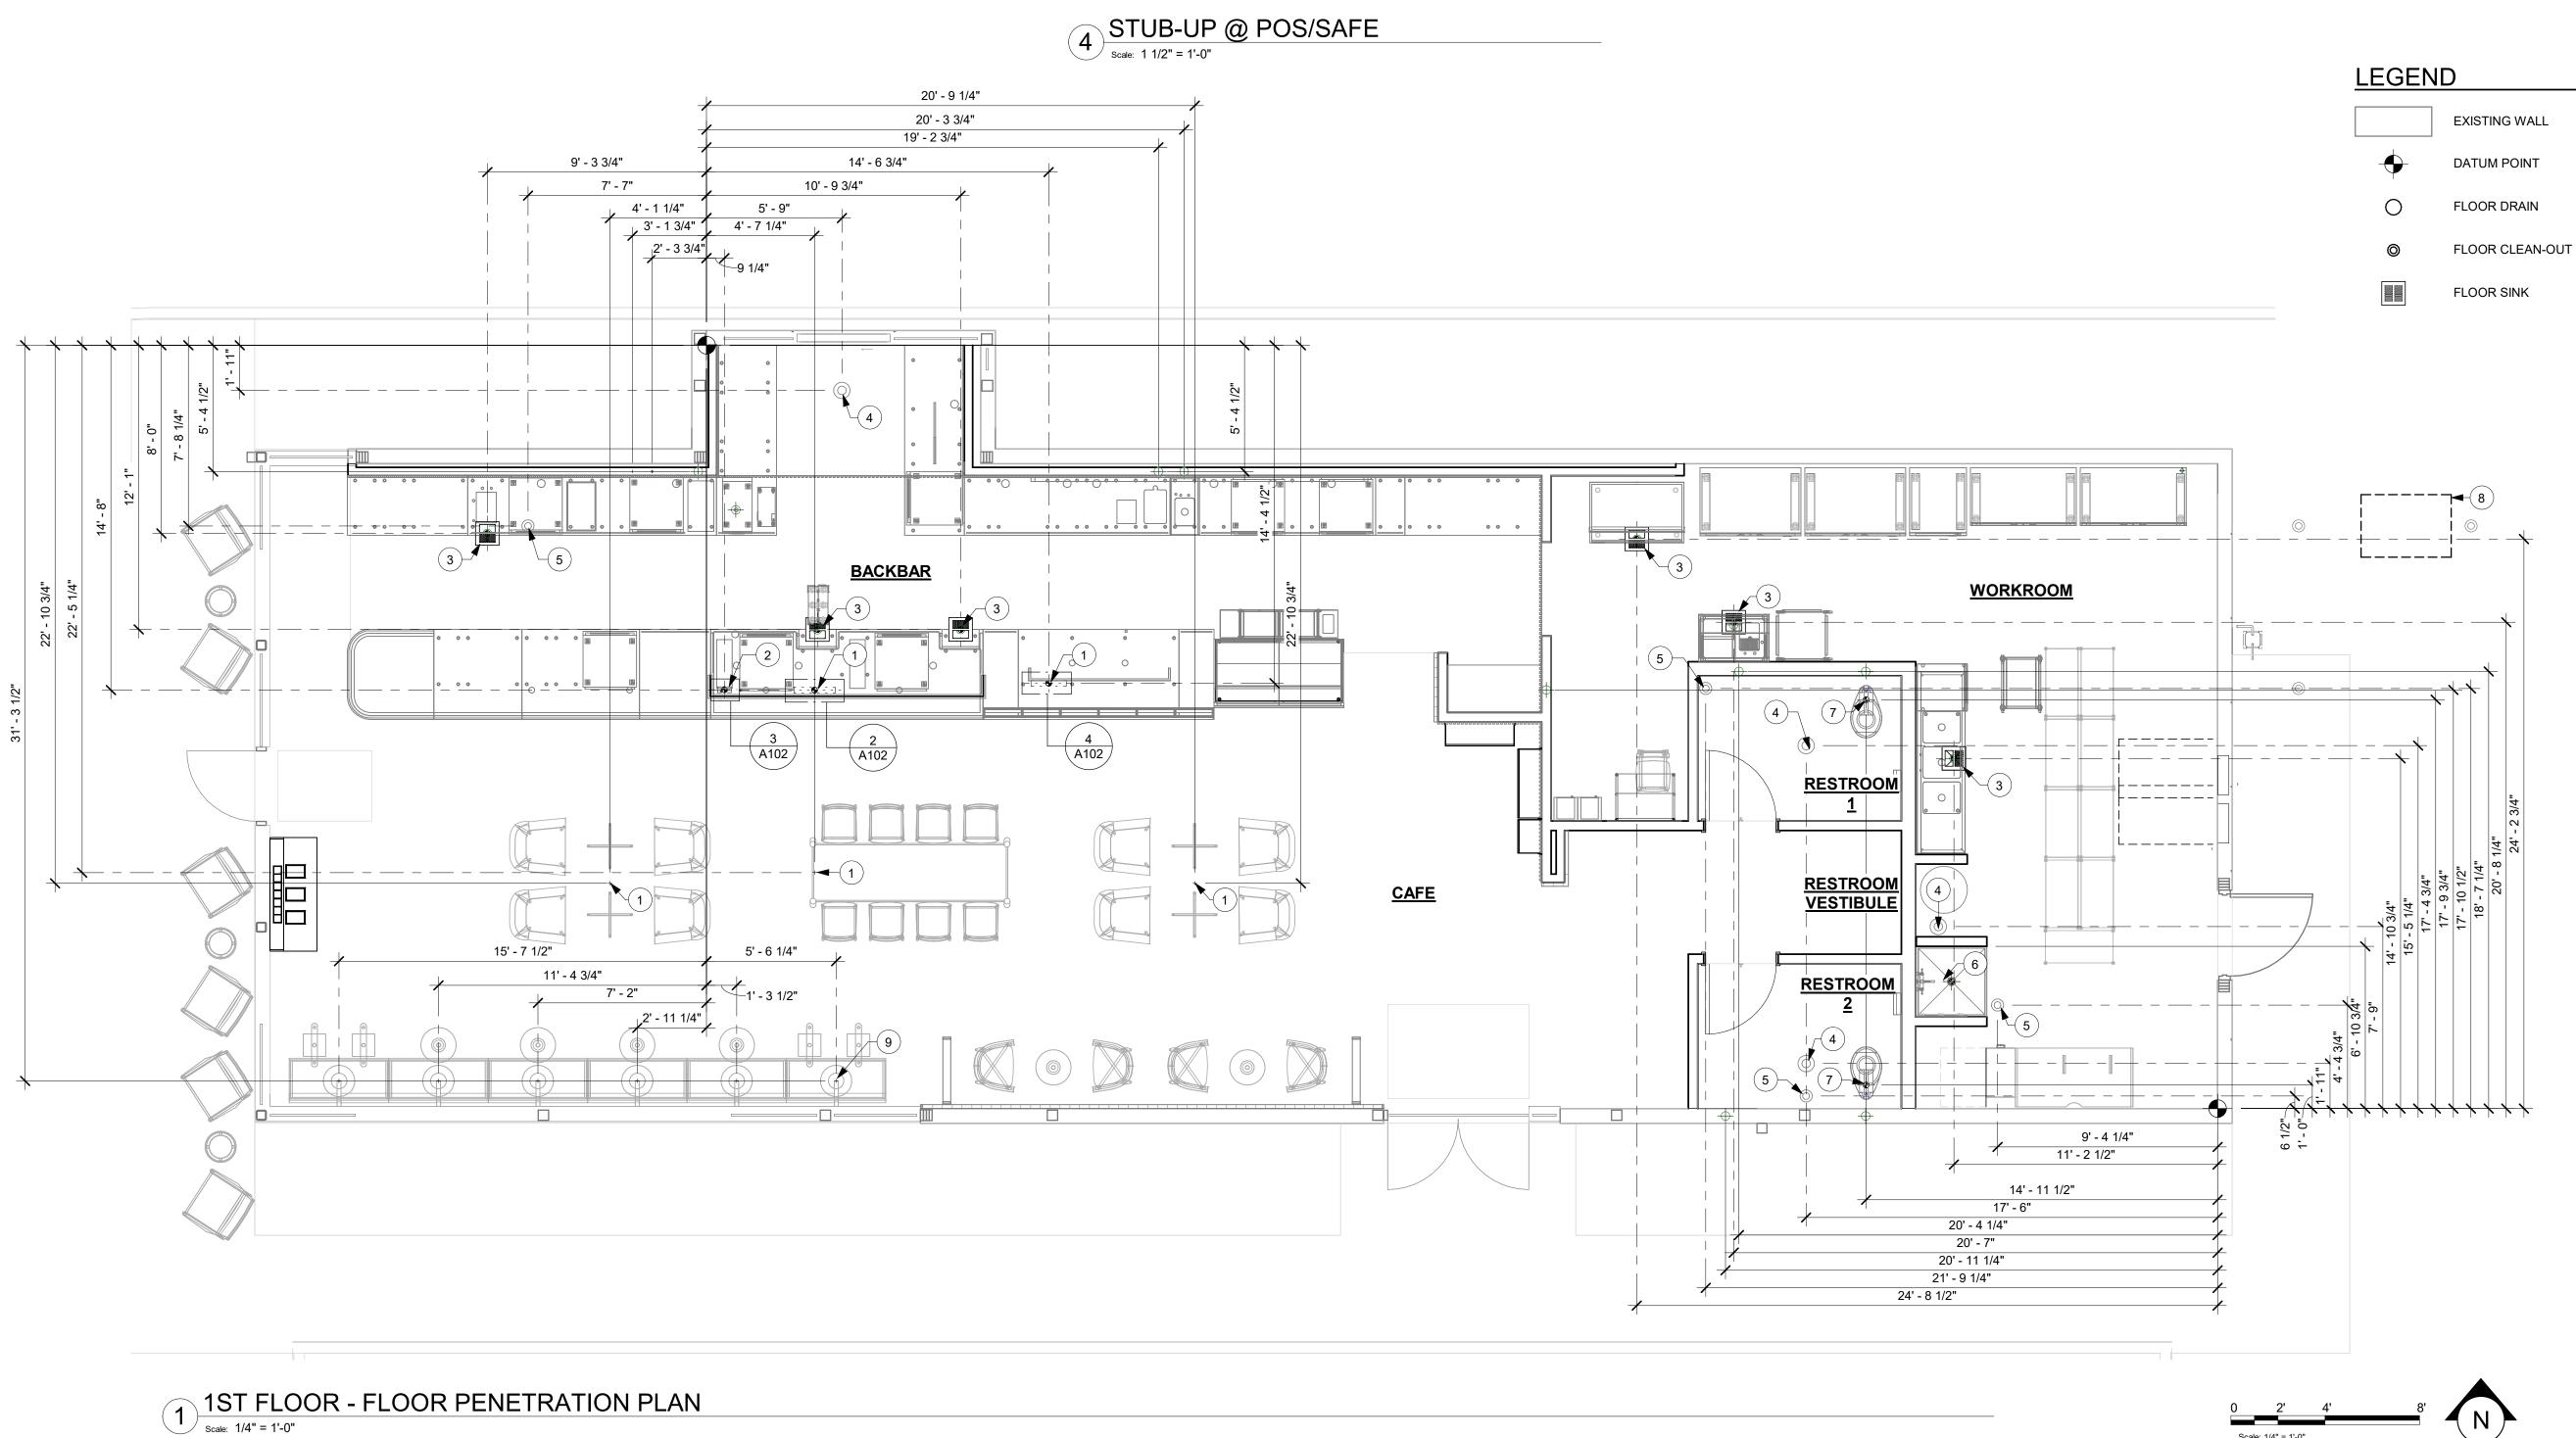

1 ROOF PLAN


Scale: 1/4" = 1'-0"

GENERAL NOTES

- A. GENERAL CONTRACTOR TO VERIFY ALL DIMENSIONS AND NOTIFY STARBUCKS CONSTRUCTION MANAGER OF ANY DISCREPANCIES PRIOR TO CONSTRUCTION. ALL DIMENSIONS TO BE TAKEN FROM DESIGNATED DATUM POINT.
- B. IN FREEZE THAW CLIMATES ONLY: INSTALL SELF-REGULATING HEAT TAPE IN ALL DOWNSPOUTS. SEE ELECTRICAL FOR FURTHER INFORMATION.
- C. ROOF TOP PLUMBING VENTS ARE NOT SHOWN FOR CLARITY. REFER TO PLUMBING DRAWINGS FOR VTR LOCATIONS AND FURTHER INFORMATION.

KEYED NOTES

- SCUPPER AND DOWN SPOUT CONNECT TO UNDERGROUND STORM DRAIN – REFER TO CIVIL DRAWINGS FOR CONTINUATION.
- ROOF ACCESS LADDER.
- 3. PRE -FINISHED METAL COPING (TYP.).
- 4. MEMBRANE ROOFING SLOPE MINIMUM 1/4" PER FOOT (TYP.).
- 5. ROOF CRICKET SLOPE AT 1/4" PER 12".
- 6. ROOF TOP EQUIPMENT. SEE MECHANICAL.
- 7. RESTROOM EXHAUST FAN. SEE MECHANICAL.
- 8. ICE MACHINE CONDENSER. SEE MECHANICAL.
- 9. WATER HEATER FLUE. SEE MECHANICAL.
- 10. INSTALL SECOND LAYER OF ROOF MEMBRANE FOR 36" PERIMETER AROUND ROOF TOP EQUIPMENT AND ROOF HATCH (TYP.).
- 11. OUTLINE OF CANOPY BELOW. SEE ELEVATIONS.

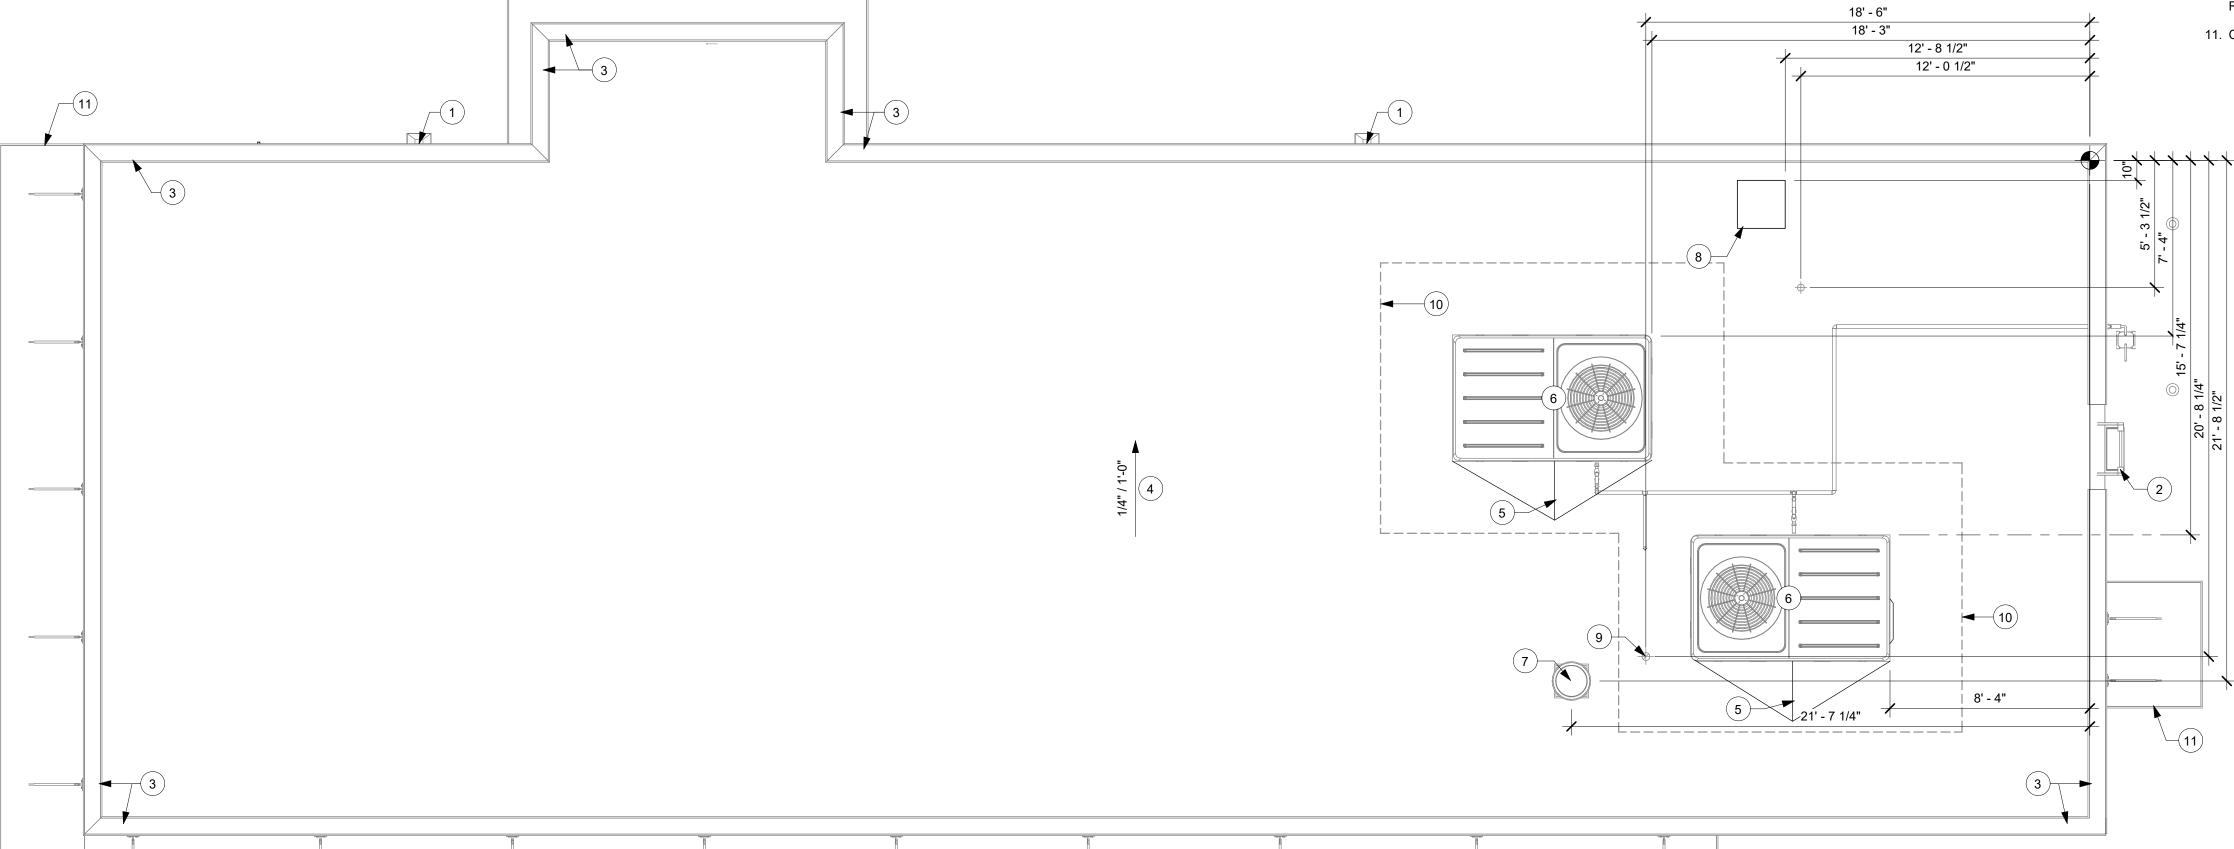

-(11)







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C

& BKINKLEY MILL
RESS:

STORE #: 59763
PROJECT #: 85334-001

PROJECT #: 85334-001

ISSUE DATE: For Construction 09/01/21

DESIGN MANAGER: ASHLEY SUEIRAS PRODUCTION DESIGNER: GPD GROUP

Revision Schedule

GPD GROUP

Rev Date By Description

BUILDING ROOF PLAN

SCALE: AS SHOWN

CHECKED BY:

SHEET NUMBER:

(14)S | 13163 (1) (2) (3) (15)S 14099 (1) 2) 3 TO/ PARAPET _ **8** (11)¬ BOT/ OF CANOPY BOT/ OF CANOPY (12)— Interior 1st Floor

KEYED NOTES

- 1. PROVIDE J-BOX FOR BUILDING SIGNAGE. COORDINATE LOCATION WITH SIGNAGE VENDOR SHOP DRAWINGS.
- 2. PROVIDE SIGNAGE DISCONNECT ON INSIDE FACE OF
- 3. 3/4" MARINE GRADE PLYWOOD BLOCKING FOR EXTERIOR SIGNAGE. EXTEND BLOCKING 8" (205MM) MIN. BEYOND EDGE OF SIGNAGE.
- 4. NON-ILLUMINATED PROTECTIVE BOLLARD.
- ELECTRICAL METER.
- 6. SERVICE DOOR.
- 7. PRE-FINISHED METAL COPING, TYPICAL.
- 8. OUTLINE OF ROOF BEYOND.
- 9. DT WINDOW. PROVIDE READY ACCESS DT SERVICE WINDOW. WINDOW AND AIR CURTAIN FINISH TO MATCH ADJACENT STOREFRONT.
- 10. DT WINDOW SHELF. INSTALL SERVICE WINDOW SHELF AT 36" (915MM) INSIDE.
- 11. STEEL CANOPY. SEE BUILDING DETAIL SHEETS AND STRUCTURAL DRAWINGS.
- 12. CANOPY DOWNSPOUTS. CONNECT TO UNDERGROUND STORM DRAIN.
- 13. ROOF SCUPPER AND EMERGENCY OVERFLOW. CONNECT VERTICAL LEADERS TO UNDERGROUND STORM DRAIN.
- 14. BUILDING SIGNAGE.
- 15. DRIVE-THRU SIGN.
- 16. EXTERIOR SCONCE LIGHTING.
- 17. EXTERIOR EGRESS LIGHTING.
- 18. EXTERIOR SPEAKER. SEE REFLECTED CEILING PLAN AND BUILDING CANOPY DETAILS.
- 19. LOCKABLE HOSE BIB. SEE PLUMBING DRAWINGS.
- 20. GAS METER. SEE PLUMBING SHEETS FOR ADDITIONAL INFORMATION.

GENERAL NOTES

- A. GENERAL CONTRACTOR TO COORDINATE AND SCHEDULE SIGNAGE INSTALLATION WITH THE SIGNAGE CONTRACTOR PROVIDING A MINIMUM SCHEDULING NOTICE OF 4 WEEKS AND 1 WEEK PRIOR TO SCHEDULED DATE OF INSTALLATION. CONSTRUCTION MANAGER TO PROVIDE GENERAL CONTRACTOR WITH SIGNAGE CONTRACTOR CONTACT INFORMATION.
 - B. GENERAL CONTRACTOR SHALL COORDINATE WITH ELECTRICAL CONTRACTOR TO FURNISH AND INSTALL ELECTRICAL CIRCUITS INCLUDING ALL CONDUIT, WIRE, CONNECTIONS AND BREAKER AT PANEL BOARD NECESSARY TO SERVE SIGNAGE.
 - C. GENERAL CONTRACTOR TO PROVIDE FIRE TREATED WOOD STUD BLOCKING OR EQUIVALENT TO SUPPORT
 - D. SIGNAGE CONTRACTOR SHALL VERIFY SIZE AND LOCATION OF ANY AND ALL ALLOWABLE MONUMENT OR POLE SIGNAGE AND PROVIDE SHOP DRAWING(S) PRIOR TO FABRICATION TO THE STARBUCKS DESIGNER FOR APPROVAL.
 - E. SIGNAGE CONTRACTOR TO INSTALL SIGNAGE IN COMPLIANCE WITH LOCAL CODES AND OBTAIN PERMIT.
 - F. SIGNAGE CONTRACTOR TO SUPPLY SHOP DRAWINGS TO CONSTRUCTION MANAGER AND TO THE GENERAL CONTRACTOR AS NEEDED. GENERAL CONTRACTOR TO NOTIFY CONSTRUCTION MANAGER IMMEDIATELY IF SHOP DRAWINGS OR INSTALLATION IS IN DISCREPANCY WITH ARCHITECTURAL DRAWINGS.
 - G. GENERAL CONTRACTOR TO CLEAN, PATCH AND REPAIR EXISTING EXTERIOR AS REQUIRED.



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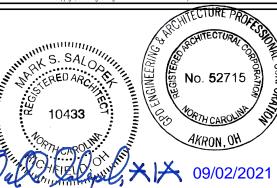
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GPD PROJECT NO: 2020261.36



BRINKL

STORE #: PROJECT #: ISSUE DATE:

For Construction 09/01/21 ASHLEY SUEIRAS **DESIGN MANAGER:** PRODUCTION DESIGNER: GPD GROUP CHECKED BY: **GPD GROUP**

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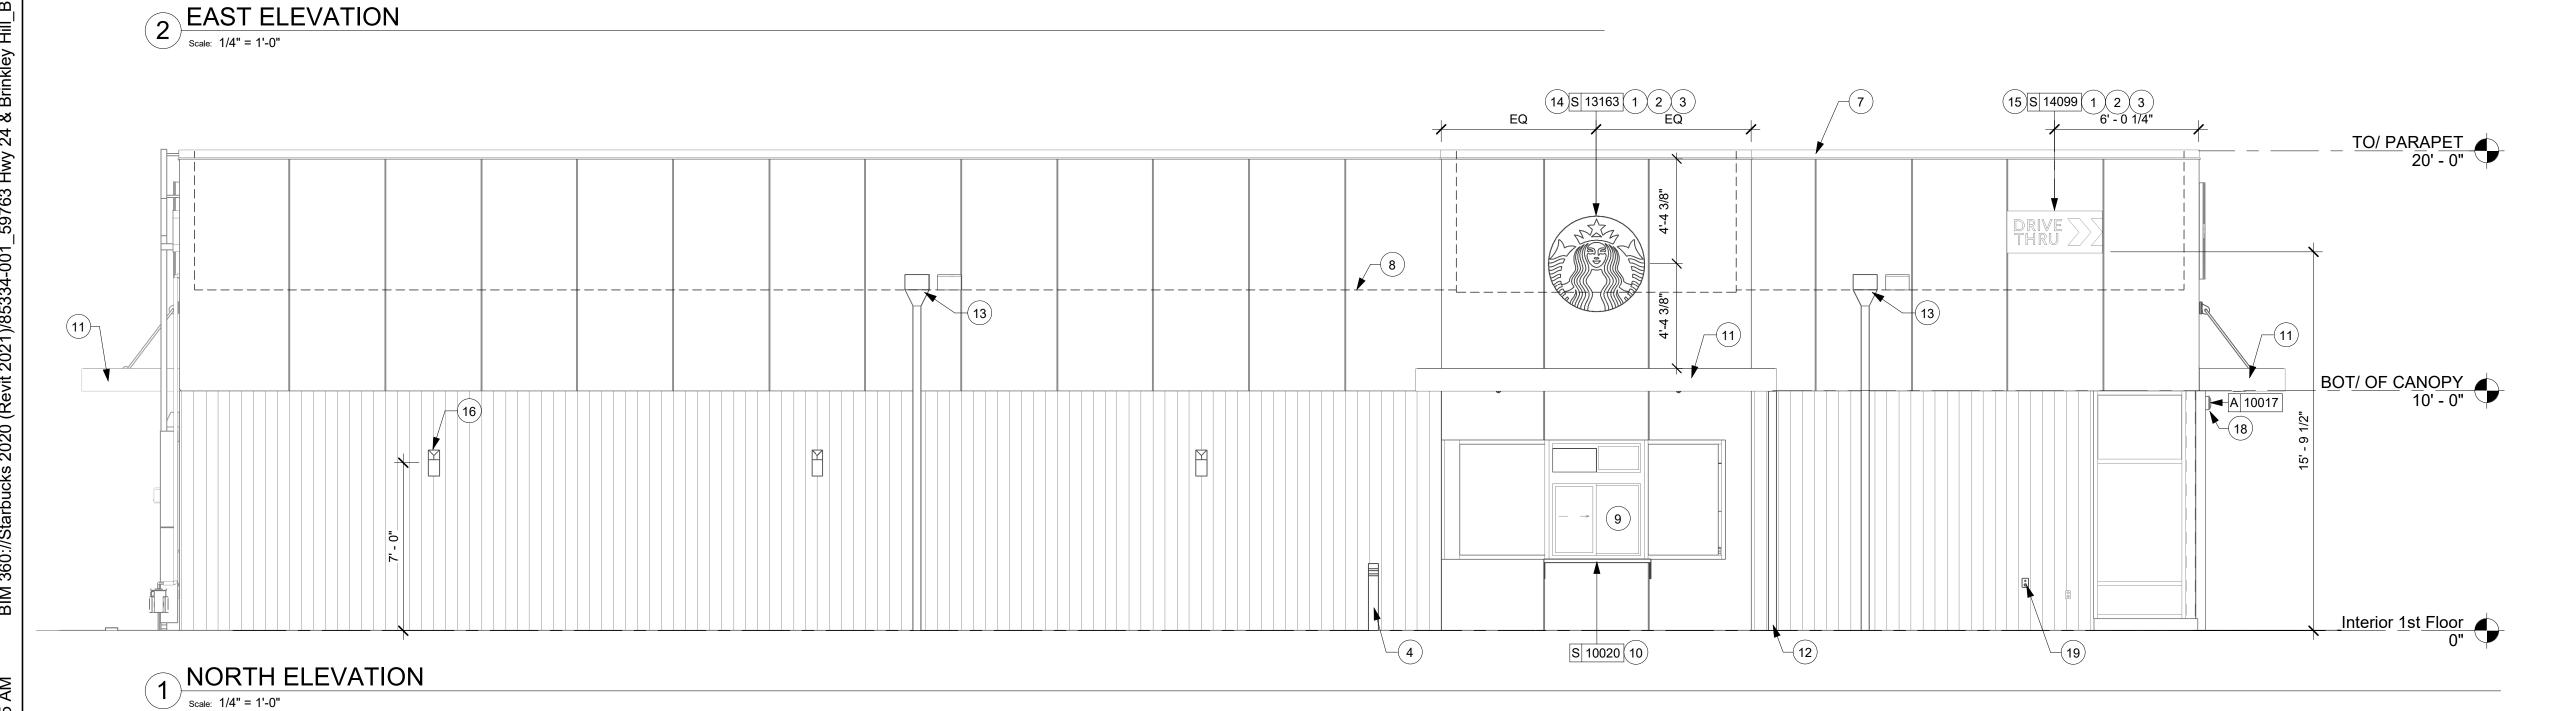
85334-001

Revision Schedule

Rev	Date	Ву	Description

BUILDING EXTERIOR ELEVATIONS SCALE: AS SHOWN

SHEET NUMBER:



MOUNTED - 18IN 455MM

Scale: 1/4" = 1'-0"

(13)S 13163 (2)(3)(4) 14' - 4 1/4" TO/ PARAPET 20' - 0" (10)— (12) BOT/ OF CANOPY 10' - 0" (17)A 10017 ► A 10017 (17) (9)S 10020 Interior 1st Floor

KEYED NOTES

- 1. PROVIDE 3" (75MM) HIGH BLACK ACRYLIC STORE ADDRESS ON GLAZING OR PER LOCAL JURISDICTIONAL CODE REQUIREMENTS.
- 2. PROVIDE J-BOX FOR BUILDING SIGNAGE. COORDINATE LOCATION WITH SIGNAGE VENDOR SHOP DRAWINGS.
- 3. PROVIDE SIGNAGE DISCONNECT ON INSIDE FACE OF
- 4. 3/4" MARINE GRADE PLYWOOD BLOCKING FOR EXTERIOR SIGNAGE. EXTEND BLOCKING 8" (205MM) MIN. BEYOND EDGE OF SIGNAGE.
- 5. ELECTRICAL METER.
- 6. PRE-FINISHED METAL COPING, TYPICAL.
- OUTLINE OF ROOF BEYOND.
- 8. DT WINDOW. PROVIDE READY ACCESS DT SERVICE WINDOW. WINDOW AND AIR CURTAIN FINISH TO MATCH ADJACENT STOREFRONT.
- 9. DT WINDOW SHELF. INSTALL SERVICE WINDOW SHELF AT 36" (915MM) INSIDE.
- 10. STEEL CANOPY. SEE BUILDING DETAIL SHEETS AND STRUCTURAL DRAWINGS.
- 11. CANOPY DOWNSPOUTS. CONNECT TO UNDERGROUND STORM DRAIN.
- 12. ROOF SCUPPER AND EMERGENCY OVERFLOW. CONNECT VERTICAL LEADERS TO UNDERGROUND STORM DRAIN.
- 13. BUILDING SIGNAGE.
- 14. DRIVE-THRU SIGN.
- 15. EXTERIOR SCONCE LIGHTING.
- 16. EXTERIOR EGRESS LIGHTING.
- 17. EXTERIOR SPEAKER. SEE REFLECTED CEILING PLAN AND BUILDING CANOPY DETAILS.
- 18. GAS METER. SEE PLUMBING SHEETS FOR ADDITIONAL INFORMATION.

GENERAL NOTES

- A. GENERAL CONTRACTOR TO COORDINATE AND SCHEDULE SIGNAGE INSTALLATION WITH THE SIGNAGE CONTRACTOR PROVIDING A MINIMUM SCHEDULING NOTICE OF 4 WEEKS AND 1 WEEK PRIOR TO SCHEDULED DATE OF INSTALLATION. CONSTRUCTION MANAGER TO PROVIDE GENERAL CONTRACTOR WITH SIGNAGE CONTRACTOR CONTACT INFORMATION.
- B. GENERAL CONTRACTOR SHALL COORDINATE WITH ELECTRICAL CONTRACTOR TO FURNISH AND INSTALL ELECTRICAL CIRCUITS INCLUDING ALL CONDUIT, WIRE, CONNECTIONS AND BREAKER AT PANEL BOARD NECESSARY TO SERVE SIGNAGE.
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- D. SIGNAGE CONTRACTOR SHALL VERIFY SIZE AND LOCATION OF ANY AND ALL ALLOWABLE MONUMENT OR POLE SIGNAGE AND PROVIDE SHOP DRAWING(S) PRIOR TO FABRICATION TO THE STARBUCKS DESIGNER FOR APPROVAL.
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- G. GENERAL CONTRACTOR TO CLEAN, PATCH AND REPAIR EXISTING EXTERIOR AS REQUIRED.



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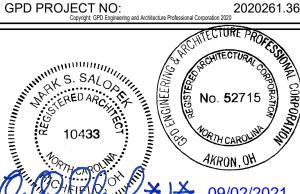
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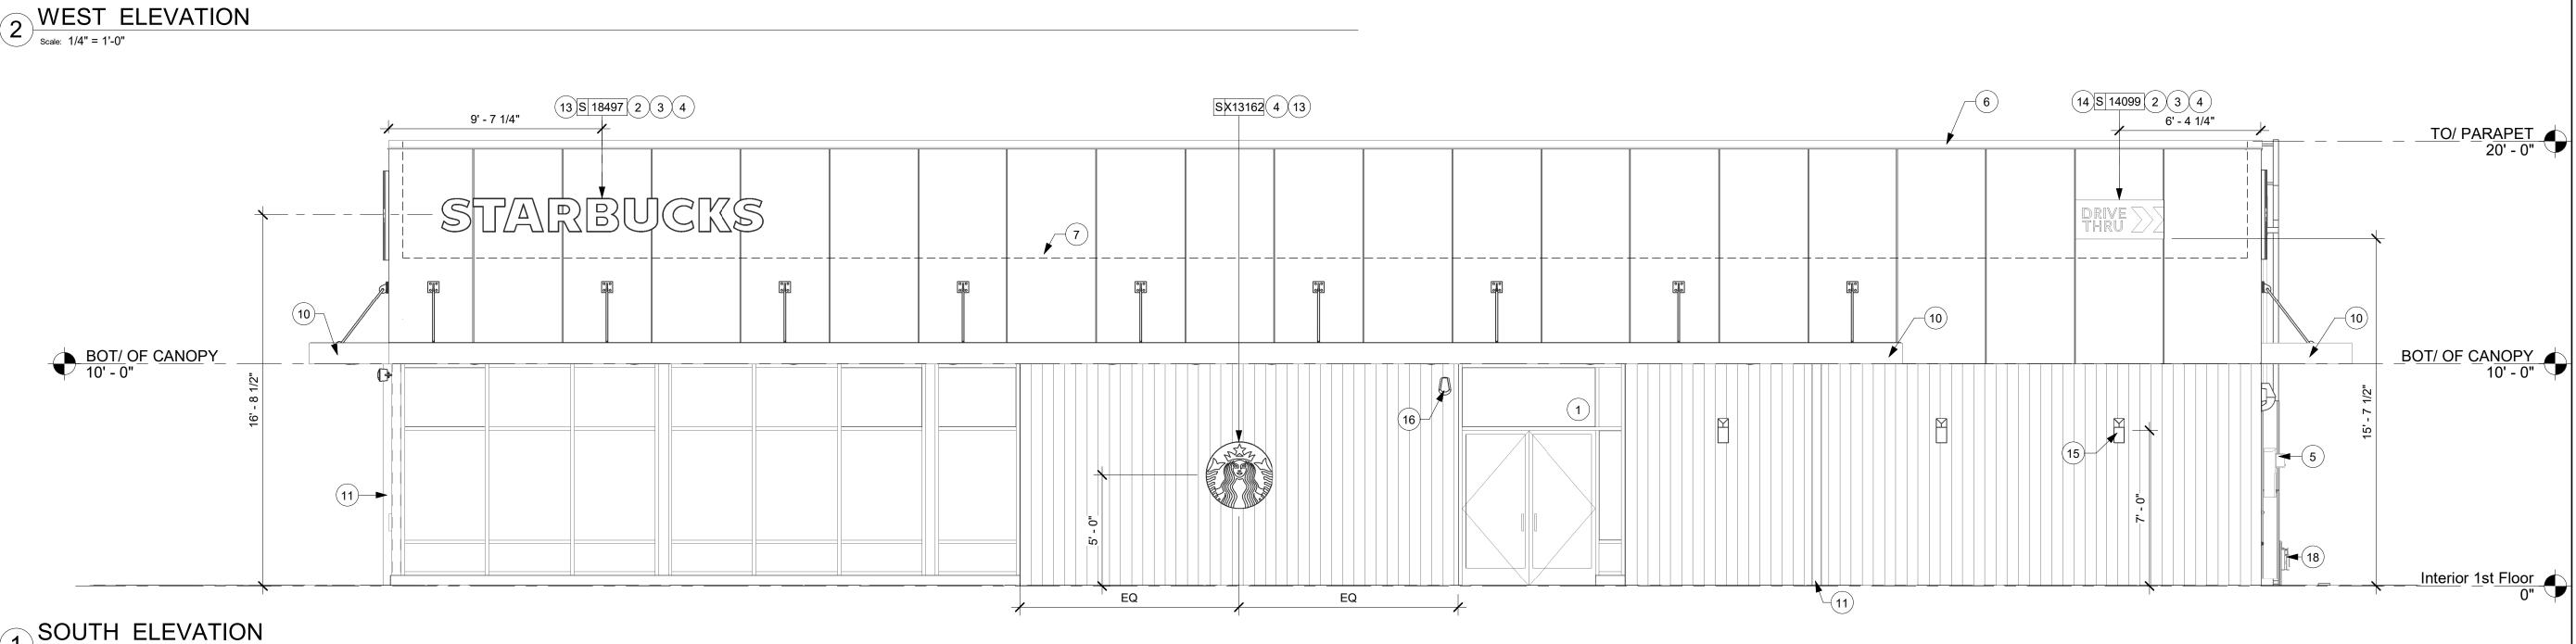
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85334-001

BUILDING EXTERIOR ELEVATIONS

SHEET NUMBER:

SCALE: AS SHOWN



	SITE SCHEDULE - "Y"									
ESIGN ID	COUNT	DESCRIPTION	FURN. BY	INST. BY	COMMENTS					
XTERIOR I	MENU		•	•						
14116	1	MENU BOARD - DT DIGITAL ORDER SCREEN - FLAT BLACK MT0028	SB	GC	FOUNDATIONS BY GC AND CONDUITS BY LL.					
14119	1	5 PANEL MENU BOARD	SB	GC	FOUNDATIONS BY GC AND CONDUITS BY LL.					
15700	1	MENU BOARD - DT DIGITAL ORDER SCREEN CONTROL BOX	SB	GC	FOUNDATIONS BY GC AND CONDUITS BY LL.					
22542	1	MENU BOARD - DT PRE MENU SQUARE FRAME FREESTANDING - 29X61IN 735X1550MM - BLACK	SB	GC						
THER				•						
10020	1	DT WINDOW SHELF - 48IN 1205MM - SST	LL	LL	VENDOR: READY ACCESS					
14103	1	BOLLARD NONILLUMINATED	LL	LL	FOUNDATIONS BY LL.					
14163	1	DT ORDER POINT CANOPY FREESTANDING - FLAT BLACK MT0028	SB	GC	FOUNDATIONS BY GC AND CONDUITS BY LL.					
18815	2	BIKE RACKS	LL	LL	FOUNDATIONS BY LL.					
MBRELLA				•						
12139	4	UMBRELLA - BASE 95LB 43KG - SILVER MT0021	SB	GC						
20073	4	UMBRELLA - WITHOUT VALANCE - 6FT 183CM - GREEN CANVAS WITH WORDMARK F0056	SB	GC						

DESIGN ID	COUNT	DESCRIPTION	FURN. BY	INST. BY	BULB	COMMENTS
SIGNAGE - [DISK	1	1	1		
13163	3	SIGN - DISK SF ILLUMINATED FLUSH MOUNTED EVOLVED - 48IN 1220MM	SB	GC		
X13162	X13162 1 SIGN - DISK SF NON- ILLUMINATED FLUSH MOUNTED EVOLVED - 36IN 915MM			GC		
SIGNAGE - [DRIVE THR	Ú				
14091	1	SIGN - DT DIRECTIONAL EXIT SIGN ILLUMINATED ARROW SERIES - 46IN 1170MM	SB	GC		FOUNDATIONS BY GC AND CONDUITS BY LL.
14099	3	SIGN - DRIVE THRU ILLUMINATED ARROW SERIES FLUSH MOUNTED - RH - 48IN 1220MM	SB	GC		FOUNDATIONS BY GC AND CONDUITS BY LL.
14106	1	CLEARANCE BAR	SB	GC		FOUNDATIONS BY GC.
14327	3	SIGN - DT DIRECTIONAL ILLUMINATED	SB	GC		FOUNDATIONS BY GC AND CONDUITS BY LL.
SIGNAGE - C	OTHER					
21163	1	SIGN - MOBILE ORDER PICK UP ILLUMINATED BLADE MOUNT	SB	GC		BOTTOM OF SIGN AT 8' - 6" A.F.F. VENDOR : HILTON
21297	2	SIGN - 5 MINUTE PARKING	SB	GC		FOOTING PROVIDED BY AND INSTALLED BY GC
21720	1	SIGN - MOBILE ORDER PICK UP SUSPENSION KIT	SB	GC		
SIGNAGE - V	VORDMAR	K				
18497	1	SIGN - WORDMARK STARBUCKS FLUSH MOUNTED - 18IN 455MM	SB	GC		



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PROJECT ADDRESS:
2778 NC-24
CAMPRON NC 28

85334-001

STORE #:
PROJECT #:
ISSUE DATE:

ISSUE DATE:
For Construction
09/01/21
DESIGN MANAGER: ASHLEY SUEIRAS
PRODUCTION DESIGNER: GPD GROUP
CHECKED BY: GPD GROUP

Revision Schedule

Rev	Date	Ву	Description

SHEET TITLE:
SCHEDULES

SCALE: AS SHOWN

SHEET NUMBER:

DOOR LEGEND

EXTERIOR

SINGLE

SERVICE

EXTERIOR

STOREFRONT

METAL FRAME

DOUBLE (TYPE A) **EXTERIOR**

STOREFRONT

METAL FRAME

SINGLE

(TYPE B)

INTERIOR

SINGLE

FLUSH

No.	Item	Description	Manufacturer	Finish
3	Hanging Devices	TH2314/MPB91	McKinney	630
1	Securing Devices	CD35A-NL-OP Panic Device	Von Duprin	628/630
2	Securing Devices	C607 7-Pin Core Combinated "A" Keyway	Falcon Lock	626
1	Securing Devices	KB609-2 Cut Control Key "A" Keyway	Falcon Lock	
9	Securing Devices	KB632-2 Cut User Key "A" Keyway	Falcon Lock	
1	Securing Devices	C953 7-Pin Rim Cylinder Housing	Falcon Lock	626
1	Securing Devices	C987 7-Pin Mortise Cylinder Housing w/AR Cam	Falcon Lock	626
1	Securing Devices	A08794-003 Adjustable Ring, Mortise Cyl. 516-13/32	Falcon Lock	626
1 Operating Trim 108 Door Pull Ha		108 Door Pull Handle	Rockwood	630
1	Closing Devices	8916 Door Closer 8916 AF89P	Dorma	689
1	Stops and Holders	473 Door Stop w/ Hook	Rockwood	626
1	Threshold	325 Half Saddle Threshold	National Guard	
1	Sign	Vinyl Sign: "THIS DOOR MUST REMAIN UNLOCKED WHEN BUILDING IS OCCUPIED"	Seton	

				occupancy)	
No.	Item	Item Description			
6	Hanging Devices	TH2314/MPB91	McKinney	630	
1	Securing Devices (active leaf)	MS1850S Deadbolt	Adams RIte	626	
1	Securing Devices (inactive	MS1880 Two-Point Flushbolt	Adams Rite	626	
2	Securing Devices (active leaf)	Falcon Lock	626		
1	Securing Devices (active leaf)	KB609-2 Cut Control Key "A" Keyway	Falcon Lock		
9	Securing Devices (active leaf)	KB632-2 Cut User Key "A" Keyway	Falcon Lock		
2	Securing Devices (active leaf)	C987 7-Pin Mortise Cylinder Housing w/AR Cam	Falcon Lock	626	
2	Securing Devices (active leaf)	A08794-003 Adjustable Ring, Mortise Cyl. 5/16-13/32	Falcon Lock	626	
2	Operating Trim	108 Door Pull Handle	Rockwood	630	
2	Operating Trim	48 Push Bar x 31	Rockwood	630	
2	Closing Devices	8916 Door Closer 8916 AF89P AL	Dorma	689	
2	Stops and Holders	473 Door Stop w/Hook	Rockwood	626	
2	Accessories	Door Sweep 18062CNB36		А	
1	Threshold	325 Half Saddle Threshold	National Guard		
1	Sign	Vinyl Sign: "THIS DOOR MUST REMAIN UNLOCKED WHEN BUILDING IS OCCUPIED"	Seton		

No.	Item	Description	Manufacturer	Finish
3	Hanging Items	TA2714/MPB79 Hinge MacPro Bearing 4.5 x 4.5	McKinney	626
1	Securing Devices	PB5425LN Lock, Shallow Coin Turn, Privacy PB5425LN-693-497 1-3/4	Yale Lock	626
1	Closing Devices	8916 Door Closer 8916 AF89P	Dorma	689
2	Protective Trim Units	K1050 B4E Kickplate 8" x 34" Each Side 32D	Rockwood	630
3	Accessories	GJ64 Rubber Silencer	Glynn Johnson	Gray
1	Stops and Holders	473 Door Stop w/ Hook	Rockwood	626

No.	Item	Description	Manufacturer	Finish		
3	Hanging Devices	TH2314/MPB91 Hinge MacPro Bearing 4.5 x 4.5	McKinney	630		
1	Securing Devices	ng Devices C607 7-Pin Core Combinated "A" Keyway Falcon				
1	Securing Devices	I/O 2000L-03IC Auto Locking Door Alarm, IC; No CTR Includes Mortise Cylinder	Sur-Lock			
1	Closing Devices	8916 Door Closer 8916 AF89P	Dorma	689		
1	Protective Trim Units	K1050 B4E Kickplate 10" x 40"	Rockwood	630		
1	Accessories 137NA Weather Strip 20' 42" x 84"		National Guard	А		
1	Accessories	Door Sweep 18062CNB36	Pemko	Α		
1	Miscellaneous Items	DS / 1000 Door Scope	Security Products	Silver		
1	Miscellaneous Items	MCV309NWHGL Door Bell	Nutone	As Selected		

GENERAL NOTES

- A. STARBUCKS VENDOR TO PROVIDE DOOR HARDWARE COMPONENTS. GC TO INSTALL.
- B. SEE SHEET A101 FOR TAGGED LOCATION OF EXTERIOR DOORS AND WINDOWS.
- C. EGRESS SHALL NOT PASS THROUGH KITCHENS, STORAGE ROOMS, CLOSETS OR SIMILAR SPACES. (1014.2)
- D. PANIC AND FIRE EXIT HARDWARE, WHERE INSTALLED ON DOORS IN THIS BUILDING SHALL SATISFY THE FOLLOWING (1008.1.10):
- a) THE ACTUATION PORTION OF THE RELEASING DEVICE SHALL EXTEND AT LEAST ONE-HALF OF THE DOOR LEAF WIDTH.
- b) THE MAXIMUM UNLATCHING FORCE DOES NOT EXCEED 15 POUNDS (6.8 KG).
- c) PIVOTED OR BALANCED DOORS SHALL BE OF THE PUSH-PAD TYPE WHERE PANIC HARDWARE IS REQUIRED AND THE PAD SHALL NOT EXTEND ACROSS MORE THAN ONE-HALF OF THE DOOR WIDTH, MEASURED FROM THE LATCH SIDE.
- d) PANIC HARDWARE LISTED IN ACCORDANCE WITH UL 305.
- e) FIRE EXIT HARDWARE LISTED IN ACCORDANCE WITH UL 10C AND UL 305.
- E. SPY SCOPE HARDWARE, WHERE INSTALLED SHALL BE CENTERED IN DOOR AT 54" (1370MM) A.F.F.



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No. 52715

No. 52715

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& BRINKLEY HI

PROJECT ADDRESS: 2778 NC-24 CAMERON, NC 2

59763 85334-001

STORE #:
PROJECT #:
ISSUE DATE:

ISSUE DATE: For Construction 09/01/21
DESIGN MANAGER: ASHLEY SUEIRAS PRODUCTION DESIGNER: GPD GROUP CHECKED BY: GPD GROUP

Revision Schedule

Rev Date By Description

SHEET TITLE:

WINDOW AND DOOR SCHEDULES & DETAILS

SCALE: AS SHOWN
SHEET NUMBER:

A602

BIM 360://Starbucks 2020 (Revit 2021)/85334-001 59763 Hwy 24 & Brinkley Hill BIM360.rv

021 8:54:59 AN

KEYED NOTES

- 1. INSTALL EXTERIOR FURNITURE THROUGHOUT AS
- 2. INSTALL CAFE FURNITURE THROUGHOUT AS SHOWN.
- 3. COMMUNITY TABLE. SEE FURNITURE SCHEDULE.
- 4. COMMUNITY BOARD. SEE INTERIOR FINISH ELEVATIONS.
- 5. CONDIMENT CART. SEE INTERIOR FINISH ELEVATIONS.
- 6. PLACE MERCHANDISE FIXTURES AND RETAIL FLOOR BASKETS PER PLAN. STORE OPERATORS TO ORDER RETAIL FLOOR BASKETS.
- 7. MERCHANDISE DISPLAY. SEE INTERIOR DETAILS FOR MORE INFORMATION.
- 8. DO NOT BLOCK FOOD CASE INTAKE/EXHAUST.
- 9. SAFE LOCATED AT POS CABINET. SEE ELECTRICAL FOR ADDITIONAL INFORMATION.
- 10. HAND SINK W/ INTEGRAL SPLASH GUARD.
- 11. INSTALL CORNER GUARD AS INDICATED. SEE INTERIOR FINISH ELEVATIONS.
- 12. LOCATION OF SWITCH GEAR AND THERMOSTAT CONTROLS. ADDITIONAL INFORMATION.

KEYED NOTES

- 13. FIRE EXTINGUISHER, FINAL LOCATION AND QUANTITY PER JURISDICTIONAL REQUIREMENTS.
- 14. SECURE LOCKERS TO WALL.
- 15. VENDOR TO INSTALL WATER FILTRATION SYSTEM PER MANUFACTURER'S REQUIREMENTS. G.C. TO PROVIDE PLUMBING AND ELECTRICAL REQUIREMENTS.
- 16. WATER HEATER. SEE PLUMBING DRAWINGS.
- 17. G.C. TO REVERSE HINGE ON U.C. REFRIGERATOR TO LEFT HAND SWING AS SHOWN.
- 18. MANAGERS DESK. SEE MANAGER'S DESK/EQUIPMENT RACK ELECTRICAL DETAIL FOR ADDITIONAL INFORMATION.

GENERAL NOTES

EQUIVALENT.

DIRT AND DEBRIS.

- K. EACH HAND WASHING SINK WILL HAVE A SINGLE SERVICE TOWEL AND SOAP DISPENSER, AND ALL HAND SINKS TO HAVE A COMBINATION FAUCET OR PREMIXING
 - L. FOR PLUMBING FIXTURES, REFER TO THE PLUMBING DESIGN PLAN. FOR DATA DEVICE SCHEDULE, REFER TO
 - THE ELECTRICAL DESIGN PLAN.

J. WARMING OVEN(S) SHOWN FOR PERMITTING

VERIFIED BY STARBUCKS CONSTRUCTION

PURPOSES. INSTALLATION AT STORE OPENING TO BE

M. SEE ELEVATIONS FOR DISTRIBUTION OF CUP DISPENSERS.

GENERAL NOTES

REPRESENTATIVE.

N. PROVIDE FIRE EXTINGUISHERS AS NOTED ON THE APPROVED PLANS FROM THE LOCAL JURISDICTION.



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85334-001

STORE #: PROJECT #: ISSUE DATE:


For Construction ASHLEY SUEIRAS PRODUCTION DESIGNER: GPD GROUP CHECKED BY: **GPD GROUP**

FF & E PLAN

SCALE: AS SHOWN

SHEET NUMBER:

1101

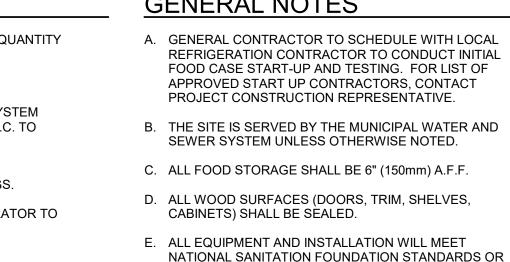

F. ALL EQUIPMENT AND CABINETRY WILL BE FLUSH

RAISED TO ALLOW FOR CLEANING.

CASEWORK ELECTRICAL DETAILS.

MOUNTED TO COUNTERS, WALLS OR FLOORS, OR BE

G. CONFIRM ALL NECESSARY EQUIPMENT CLEARANCES

H. FOR LOCATION OF COUNTERTOP EQUIPMENT, REFER TO

THREADS, EMBELLISHMENTS OR OVERHANGING EDGES

THAT SERVE AS PLACES FOR ACCUMULATION OF DUST,

PER PRODUCT CUT SHEET (E.G. ICE MACHINE).


I. EQUIPMENT UNITS SHALL CONTAIN NO EXPOSED


A 10029 A 10012 A 14677 A 14678 A 10029 A 12336 A 10014 A 14676 E 10312 (4) E 12508 E 10746 **BACKBAF** ⊣A 20294 | E 10856 (4) A 10075 E 10808 E 10267 E 20080 E 11083 E 11083 E 18846 ∃ 10970 I E 13682 E 13682 E 20079 E 18029 / E 10267 E 10396 E 10855 E 13584 JÉ 20010 E 10856 E 13330 E 10855 E 10091 E 17564 E 19559 E 11115 E 10344 $\mathsf{WORKROOM}^{oldsymbol{arPhi}}$ E 10858 E 10791 E 10791 E 10416 A 10028 E 20032 ─E 20032 (11)E 10829 (11)E 10829 17264 E 10416 E 17255 10462 E 10501 (13) | E 15186 | ≤√E 10977 E 16238 E 10947 10222 --(12) E 19742 | E 19278 | A 10008 4 10008 E 19742 E 10416 A 10075 A 10014 A 20294 E 19476 1 A 10029 A 10029 A 10075 F 21358 F 19719 (2) F 17644 (2) A 10014 A 10029 A 10075 A 10014 F 19719 (2) 17644 (2) F 20282 (4) (4) F 20282 E 10416 ⊢E 10416 E 10462 3 **VESTIBULE** 4 G 12693 ► 10462 **⋖** E 10462 11 E 10829 F 21809 (2) F 12187 (2) F 17644 F 21461 (4) **RESTROOM** A 10022 A 10005 A 10002 A 19339

1ST FLOOR - FURNITURE, FIXTURES, AND EQUIPMENT PLAN

| Scale: 1/4" = 1'-0"



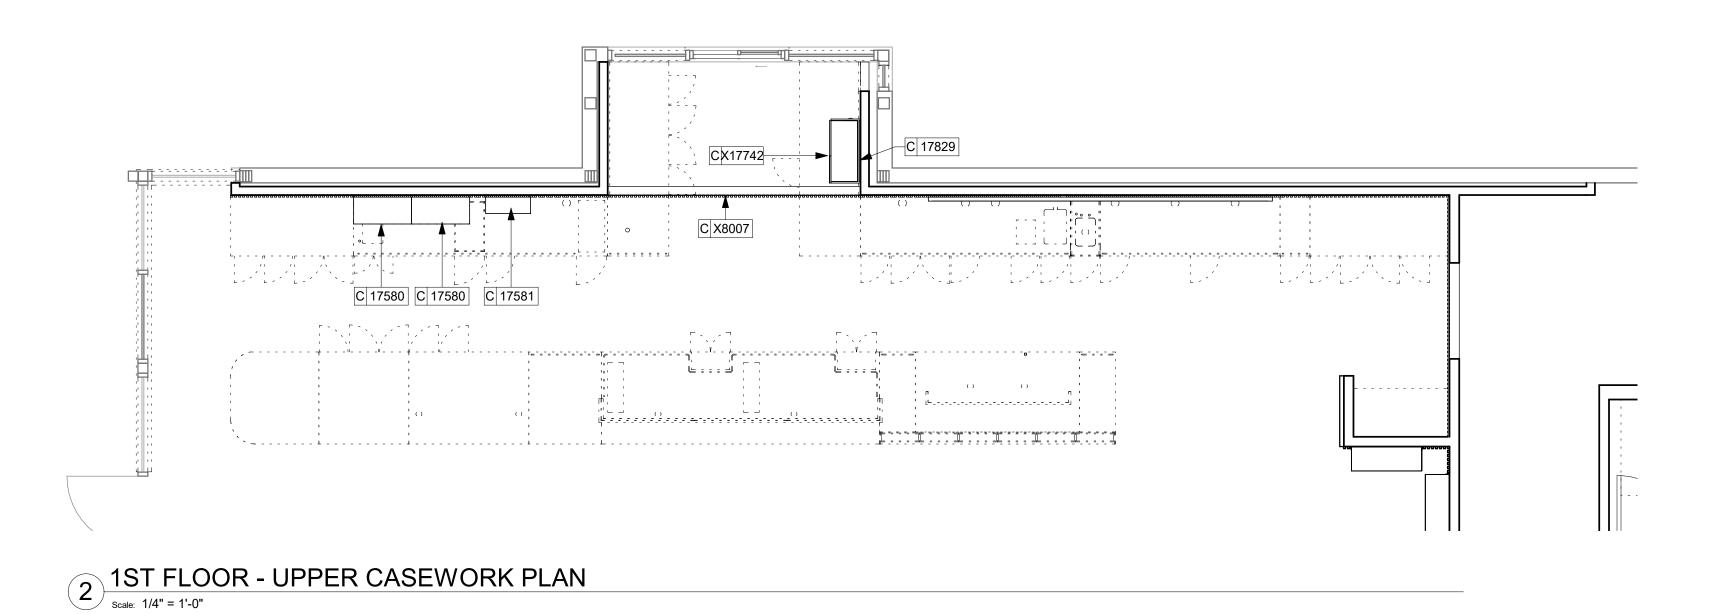

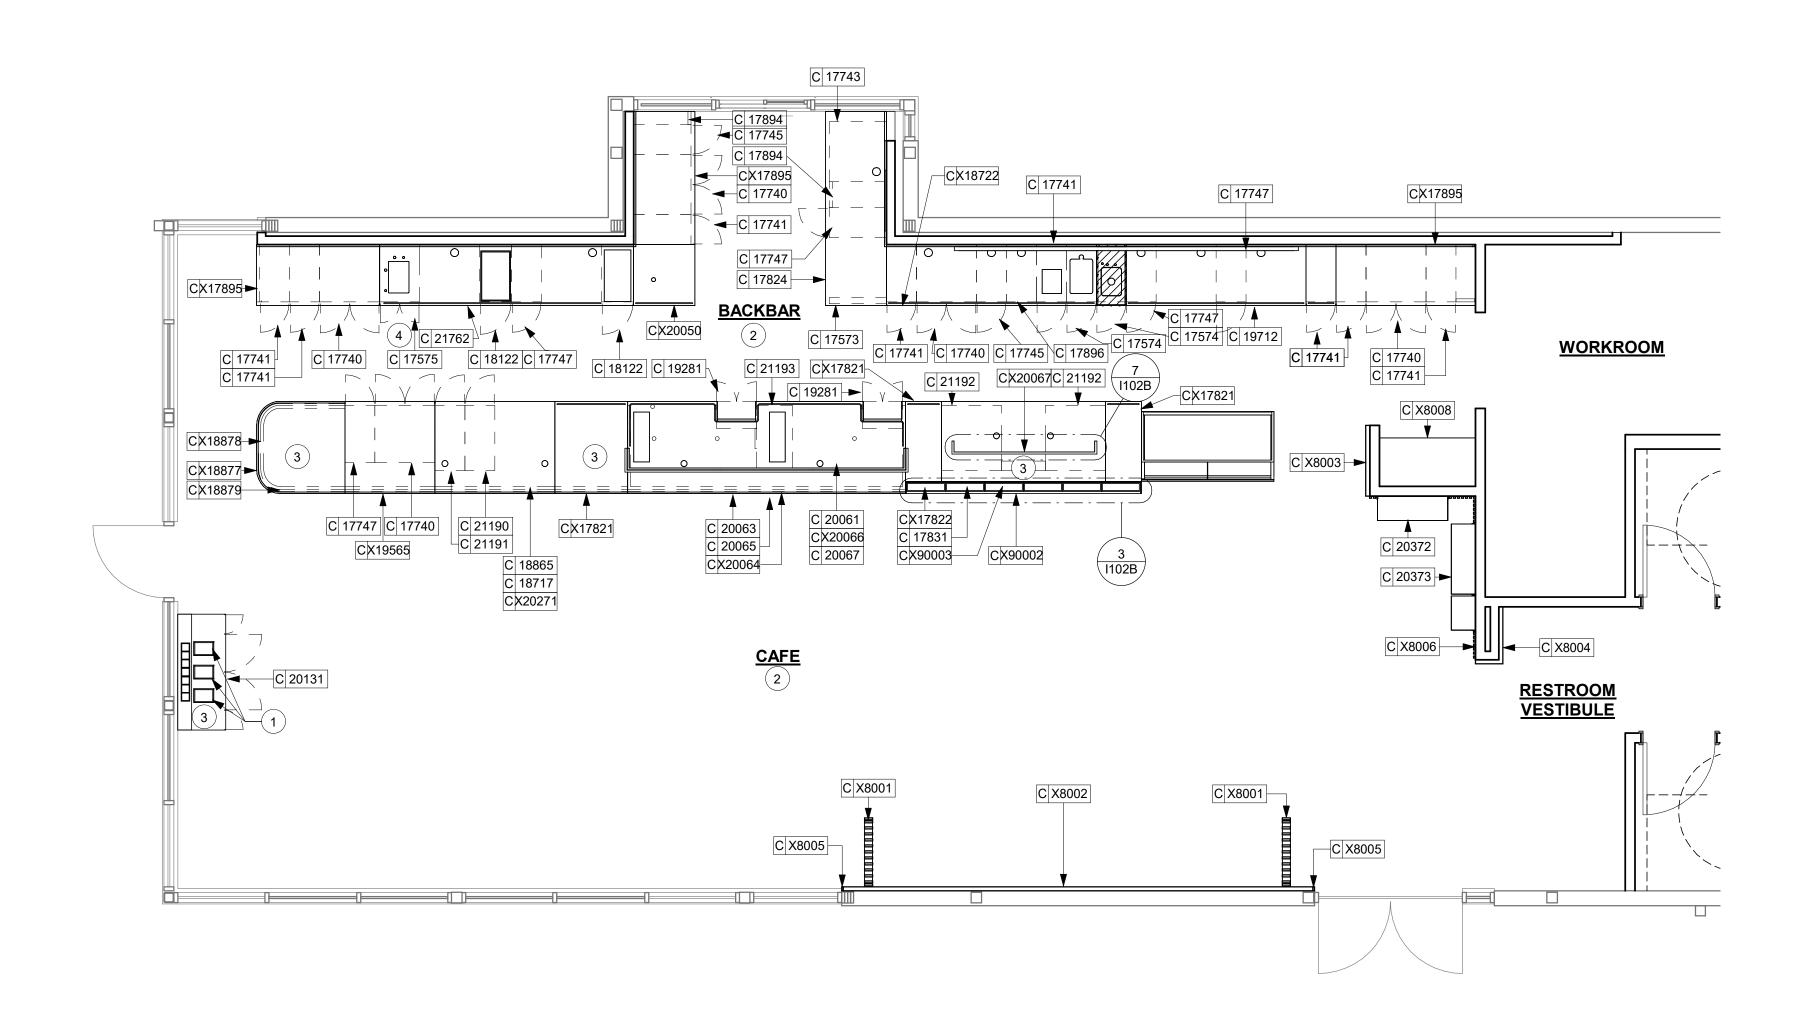

1 Scale: 1/4" = 1'-0"

KEYED NOTES

- 1. DO NOT CAULK TRASH RINGS TO COUNTERTOPS.
- 2. INSTALL CASEWORK, COUNTERTOPS, SHELVES, CUBBIES, FINISHES, TRIM AND TABLE TOPS THROUGHOUT. REFERENCE FINISH SCHEDULE AND MANUFACTURER'S SPECIFICATIONS FOR ADDITIONAL INFORMATION.
- 3. ALL COUNTERTOPS UTILIZED FOR CUSTOMER TRANSACTIONS, INCLUDING BAR, CONDIMENT AND SALES COUNTERTOPS SHALL BE INSTALLED AT 2'-10" MAXIMUM A.F.F.
- 4. FLOOR DRAIN BELOW. CASEWORK MANUFACTURER TO COORDINATE DESIGN TO INSURE THIS AREA IS READILY ACCESSIBLE FOR CLEANING AND FREE OF COUNTERTOP SUPPORT.

GENERAL NOTES

- A. GENERAL CONTRACTOR TO NOTIFY CONSTRUCTION MANAGER IMMEDIATELY IF A DISCREPANCY EXISTS BETWEEN CASEWORK SHOP DRAWINGS, EXITING SITE CONDITIONS, ARCHITECTURAL DRAWINGS OR BUILT FIXTURES. ALL DIMENSIONS SHALL BE FIELD VERIFIED BY GC PRIOR TO SHOP DRAWINGS PRODUCTION.
- B. STARBUCKS CONSTRUCTION MANAGER TO COORDINATE AND SCHEDULE CASEWORK DELIVERY DATE. GENERAL CONTRACTOR TO CONFIRM CASEWORK DELIVERY DATE WITH CASEWORK MANUFACTURER AT FOUR (4) WEEKS PRIOR AND THEN ONE (1) WEEK PRIOR TO SCHEDULED DATE OF DELIVERY.
- C. STARBUCKS CONTRACTS DIRECTLY WITH CASEWORK VENDOR TO SUPPLY CASEWORK LISTED IN THE CASEWORK SCHEDULE, UNLESS OTHERWISE NOTED.
- D. CASEWORK VENDOR TO PROVIDE COMPLETE SHOP DRAWINGS AND INSTALLATION PACKAGE TO GENERAL CONTRACTOR TO FACILITATE PROPER INSTALLATION.
- E. ALL CASEWORK BOX BASE / TOE KICKS SHALL BE SET AND LEVELED USING 1/4" (6 MM) NON-ABSORBENT PLASTIC SHIMS PROVIDED BY CASEWORK VENDOR.
- F. SEE INTERIOR FINISH ELEVATIONS AND SCHEDULES FOR LOCATION AND TAGGING OF WALL TREATMENTS BY CV AND OTHERS.
- G. SEE REFLECTED CEILING PLAN FOR CASEWORK SOFFIT LOCATIONS.
- H. REFERENCE PLUMBING AND ELECTRICAL PLANS FOR PLACEMENT OF ELECTRICAL, DATA AND PLUMBING ON FRONT AND BACKLINE OF BAR.
- I. PROVIDE ACCENT LIGHTING AT FRONT EDGE OF BAR. SEE INTERIOR ELEVATIONS AND ELECTRICAL FOR ADDITIONAL INFORMATION.
- J. CASEWORK VENDOR TO ENGINEER PROPER COUNTERTOP SUPPORT AT ESPRESSO BAR AND OTHER WORKSTATIONS PER STARBUCKS MINIMUM PERFORMANCE REQUIREMENTS.



INDICATES STAINLESS STEEL (SST) COUNTERTOP

INDICATES SOLID SURFACE (SS) COUNTERTOP



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STORE #: 59763
PROJECT #: 85334-001
ISSUE DATE: For Construction 09/01/21
DESIGN MANAGER: ASHLEY SUEIRAS

DESIGN MANAGER: ASHLEY SUE PRODUCTION DESIGNER: GPD GROUP CHECKED BY: GPD GROUP

Revision	Schedule

Rev	Date	Ву	Description


HEET TITLE:

CASEWORK PLAN

SCALE: AS SHOWN

SHEET NUMBER:


I102

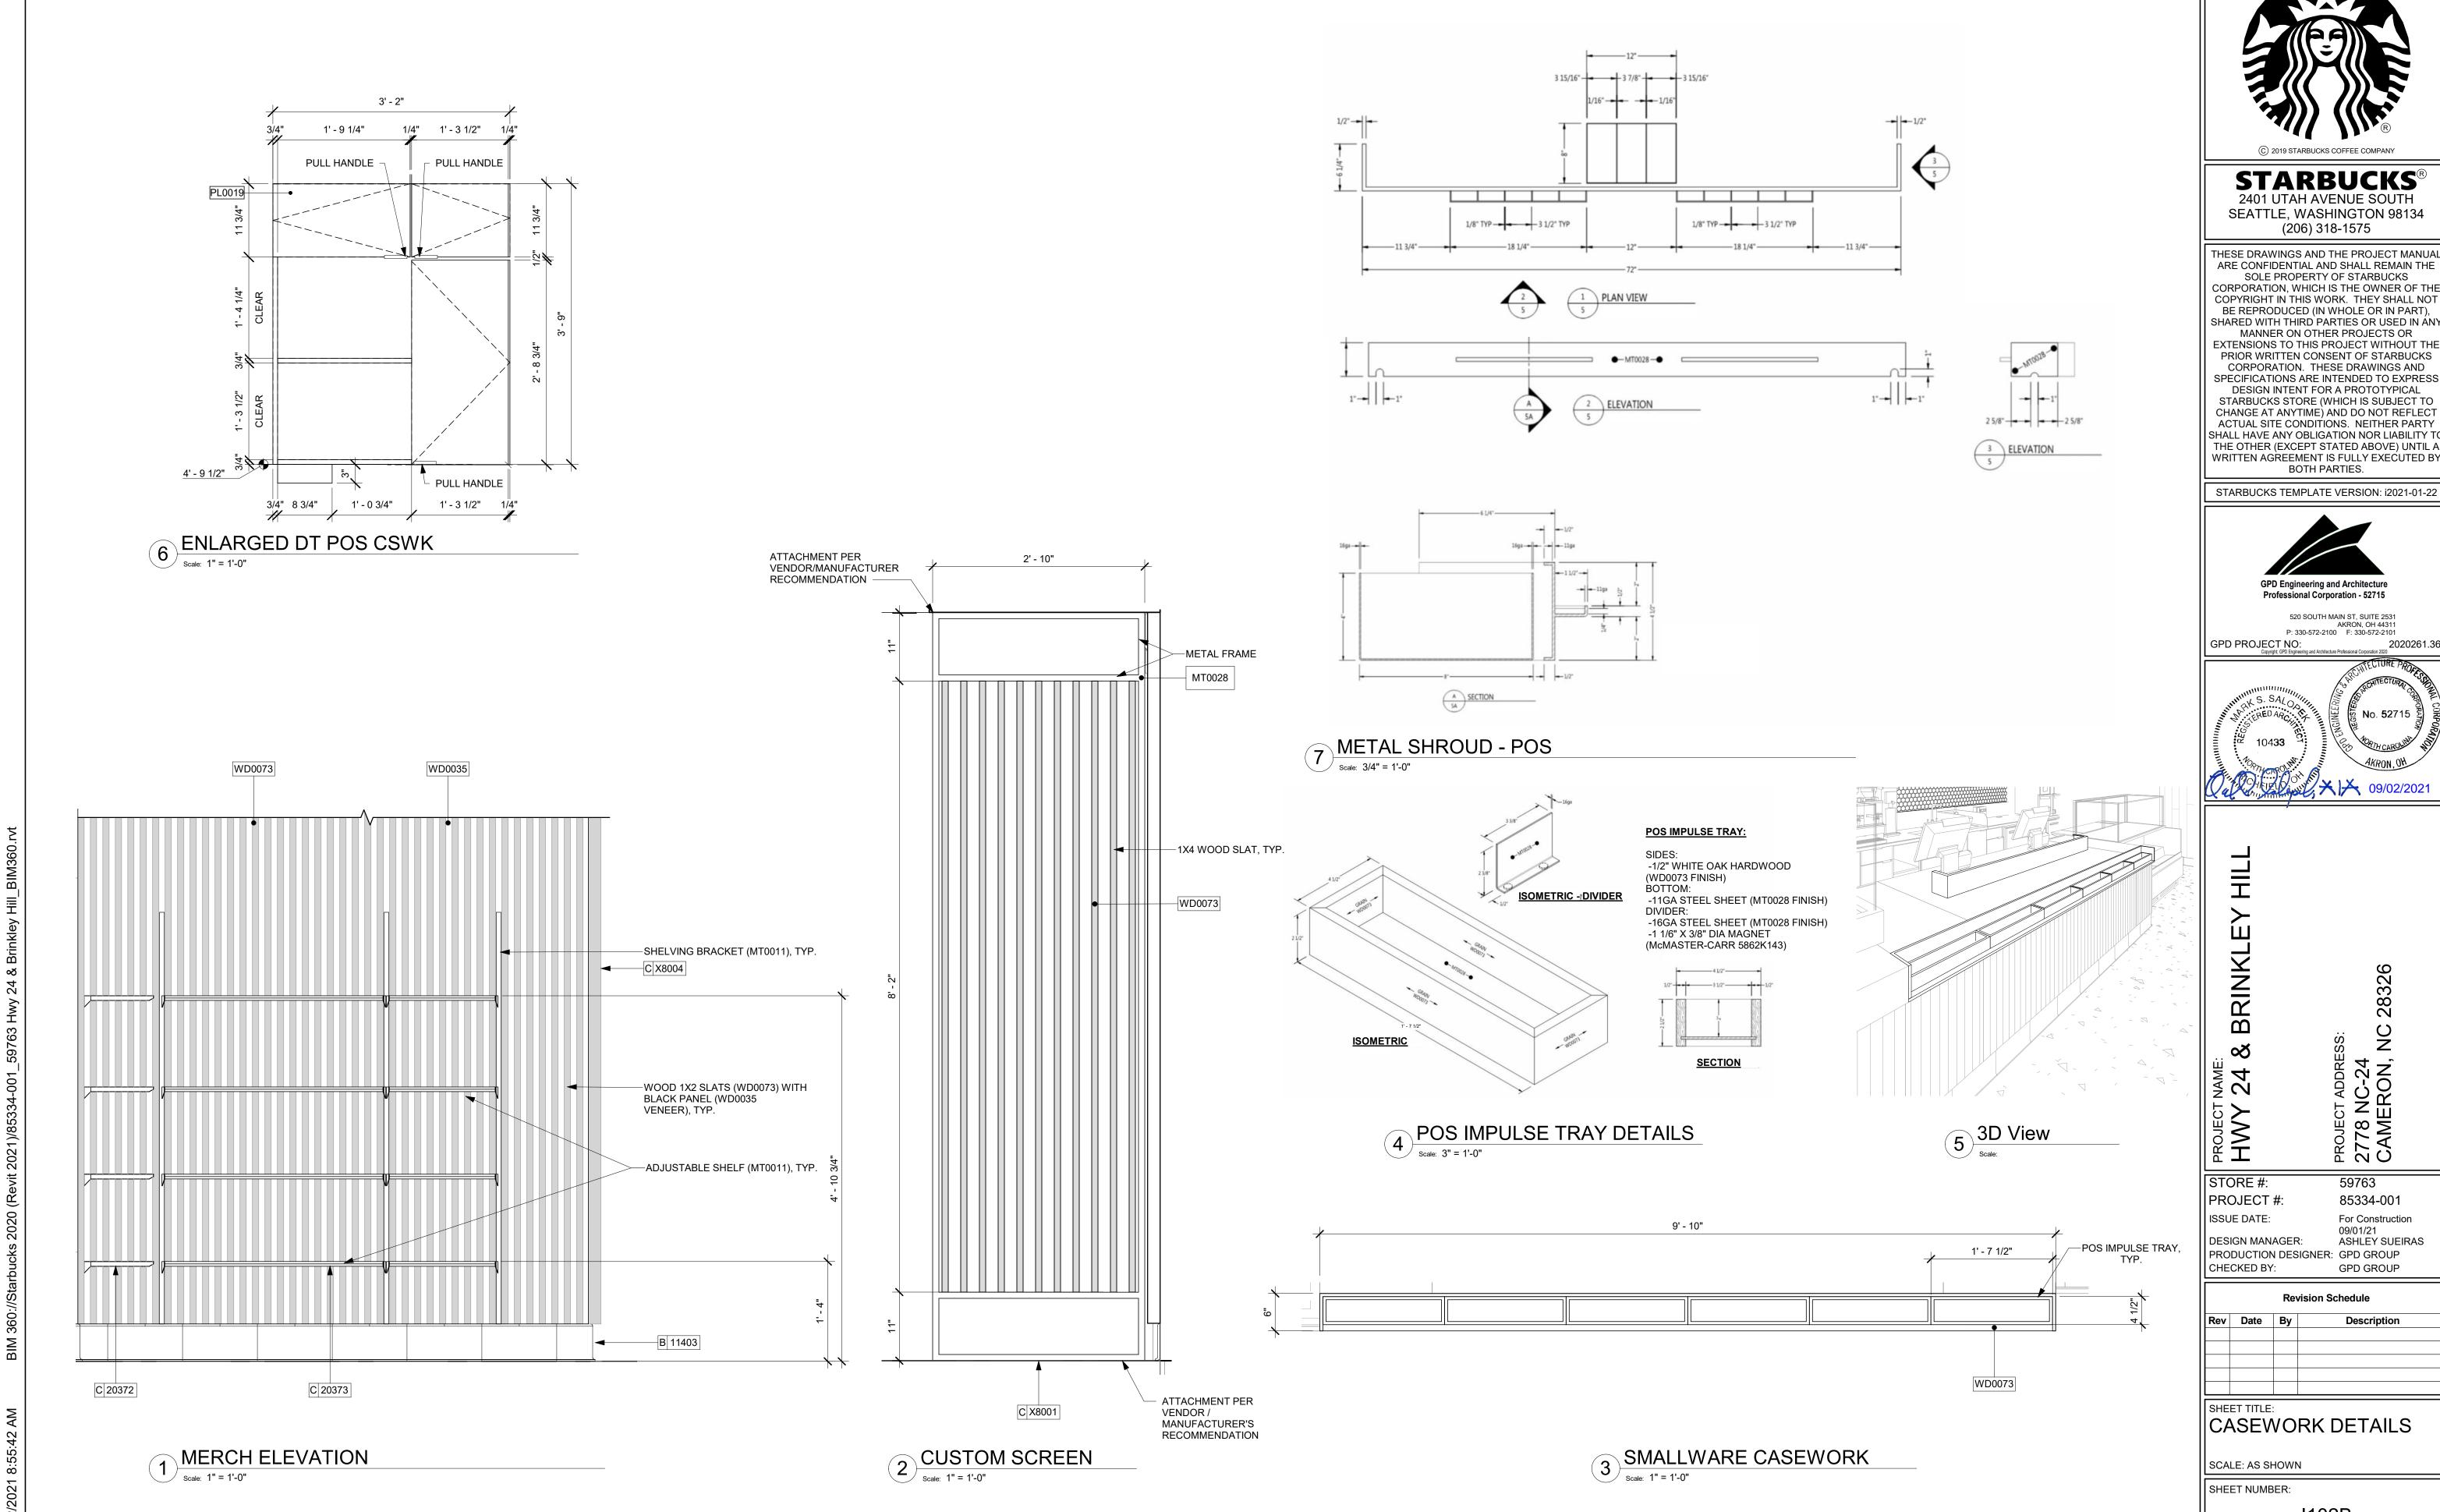



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Rev	Date	Ву	Description					
SHE	ET TITLE:	:						
CASEWORK DETAILS								


I102B

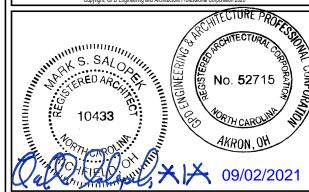KEYED NOTES

- GWB SOFFIT WITH SMOOTH FINISH (PAINT AS SCHEDULED).
- 2. GWB CEILING. PAINT CEILING DIFFUSERS AS INDICATED.
- 3. WASHABLE CEILING TILE LOCATED IN BACK OF HOUSE .
- 4. ROOF LADDER AND ACCESS HATCH.
- 5. LED STRIP LIGHT IN LIGHT COVE.
- 6. EXISTING EXTERIOR LIGHT SCONCE. SEE EXTERIOR ELEVATIONS BY LL , TYP.
- EXTEROR SPEAKER REFER TO EXTERIOR ELEVATIONS FOR MOUNTING HEIGHT
- 8. LIGHT SCONCE. SEE RESTROOM ELEVATIONS FOR MOUNTING LOCATION, SEE ELECTRICAL FOR ADDITIONAL DETAILS.
- 9. SECURITY CAMERA.
- 10. 2X4 LIGHT TROFFER, SEE ELECTRICAL, TYP.
- 11. EXIT LIGHTING, SEE ELECTRICAL.
- 12. EMERGENCY LIGHT, SEE ELECTRICAL BY LL.
- 13. TRACK LIGHTING FIXTURE, SEE INTERIOR ELEVATIONS FOR HEIGHTS, SEE ELECTRICAL FOR MORE INFORMATION, TYP.
- 14. RECESSED CAN LIGHT, SEE ELECTRICAL, TYP.
- 15. SUPPLY DIFFUSER PAINT TO MATCH CEILING, SEE MECHANICAL, TYP.
- 16. RETURN GRILLE PAINT TO MATCH CEILING, SEE MECHANICAL, TYP.
- 17. EXHAUST GRILLE, SEE MECHANICAL, TYP.
- 18. RECESSED SPEAKER.

GENERAL NOTES

- A. REFERENCE LOW VOLTAGE PLAN SHEET AND ELECTRICAL DRAWINGS.
- B. IF REQUIRED BY LOCAL CODE, GENERAL CONTRACTOR TO PROVIDE SEMI-RECESSED SPRINKLER HEADS WITH POLISHED CHROME ESCUTCHEONS CENTERED IN ACOUSTICAL CEILING TILE. IF PENDANT HEADS ARE REQUIRED IN GWB SOFFIT OVER FRONT BAR, CONCEAL SUPPLY PIPING WITHIN SOFFIT. GENERAL CONTRACTOR TO SUBMIT SPRINKLER LAYOUT TO STARBUCKS' CONSTRUCTION MANAGER FOR APPROVAL PRIOR TO INSTALLATION.
- C. LEAVE TEN (10) ADDITIONAL RETAIL CEILING TILES TO MATCH RETAIL CEILING PAINT COLOR ABOVE THE WORKROOM CEILING AT MANAGER'S DESK FOR FUTURE USE
- D. PROVIDE GROMMET AT ACOUSTIC CEILING PENETRATIONS FOR FIXTURES OF SUPPORTS.
- E. HEATING, VENTILATING AND AIR CONDITIONING SHOWN ON THIS PLAN PROVIDED FOR REFERENCE ONLY. SEE MECHANICAL DRAWINGS FOR ADDITIONAL INFORMATION.
- F. DIFFUSERS AND RETURNS IN ACOUSTICAL CEILING TILE TO BE CENTERED IN TILE AND PAINTED TO MATCH ADJACENT FINISHES (TYP.).
- G. PAINT ALL EXPOSED HVAC DUCTS, HVAC DIFFUSERS, LIGHT TRIM RINGS, PIPING, CONDUIT AND JUNCTION BOXES THE SAME COLOR AS SPECIFIED ON SURROUNDING CEILING OR SOFFIT UNLESS OTHERWISE NOTED. TYPICAL THROUGHOUT RETAIL AREA OF STORE.
- H. PAINT SUBSTITUTIONS ARE NOT ALLOWED. USE STARBUCKS' NATIONAL ACCOUNT "COLOR CODE" WHEN ORDERING PAINTS.
- I. DATA CABLING ABOVE HEAD SHALL BE IN PLENUM WHEN AVAILABLE.
- J. DATA CABLING AT EXPOSED CEILING SHALL BE INSTALLED IN METAL CONDUIT OR PER LOCAL CODE REQUIREMENT.

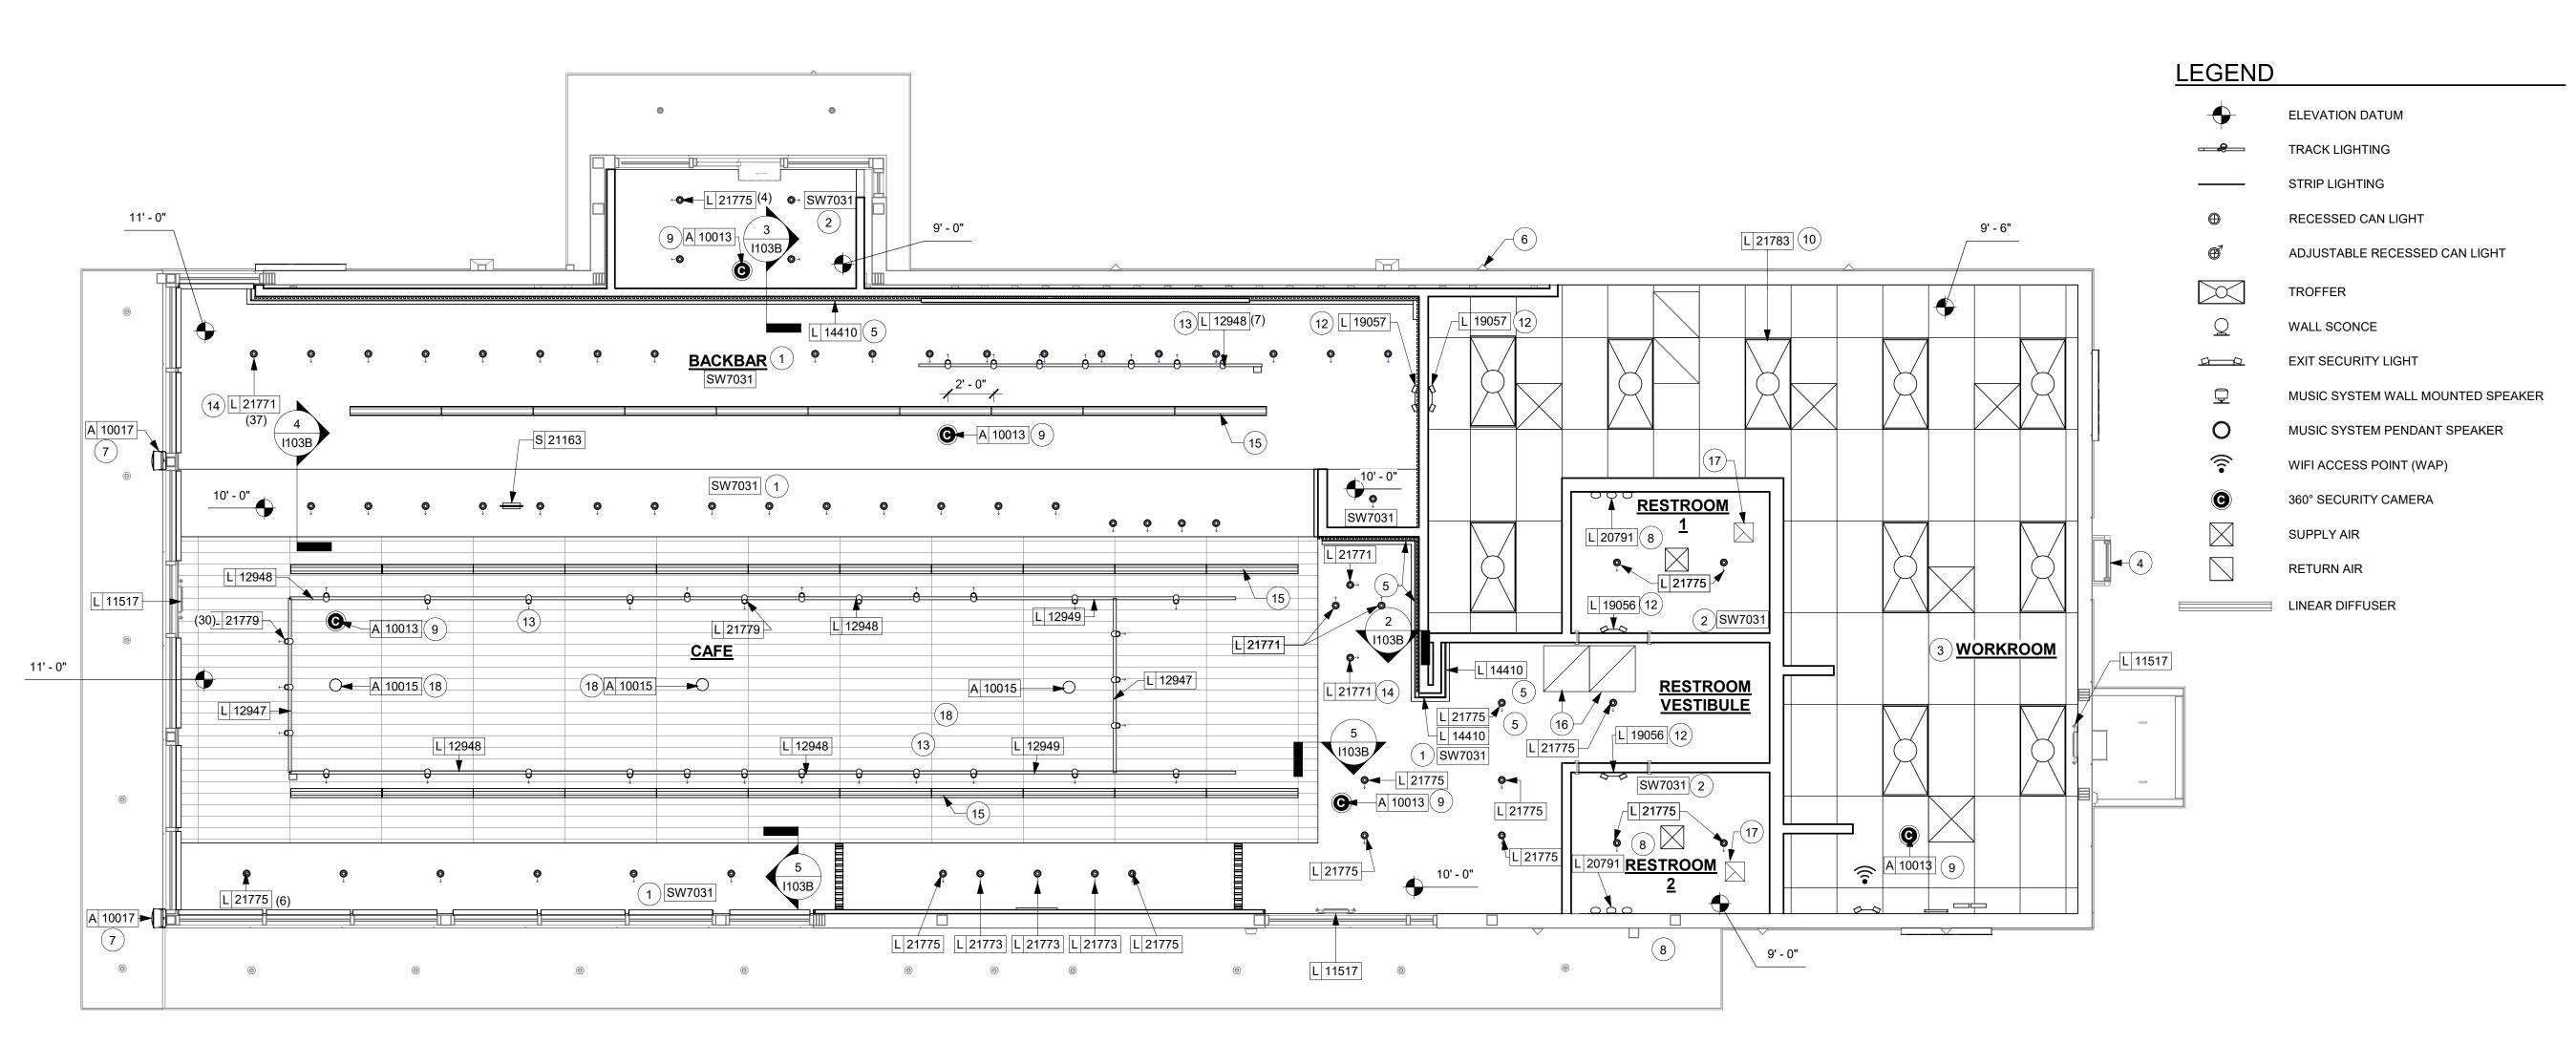

0 2' 4' 8
Scale: 1/4" = 1'-0"





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RECTURE PROJECTIVE OF THE CTURE PROFESSIONAL CONTROL OF THE CTURE PROFESSIONA

4 & BRINKLEY HILL

DRESS:
24

PROJECT ADDRESS

STORE #: 59763
PROJECT #: 85334-001
ISSUE DATE: For Construction 09/01/21
DESIGN MANAGER: ASHLEY SUEIRA

DESIGN MANAGER: ASHLEY SUEIRAS
PRODUCTION DESIGNER: GPD GROUP
CHECKED BY: GPD GROUP

Revision Schedule

Rev Date By Description


REFLECTED CEILING
PLAN
SCALE: AS SHOWN

SHEET NUMBER:

I103

1 1ST FLOOR - REFLECTED CEILING PLAN

| Scale: 1/4" = 1'-0"

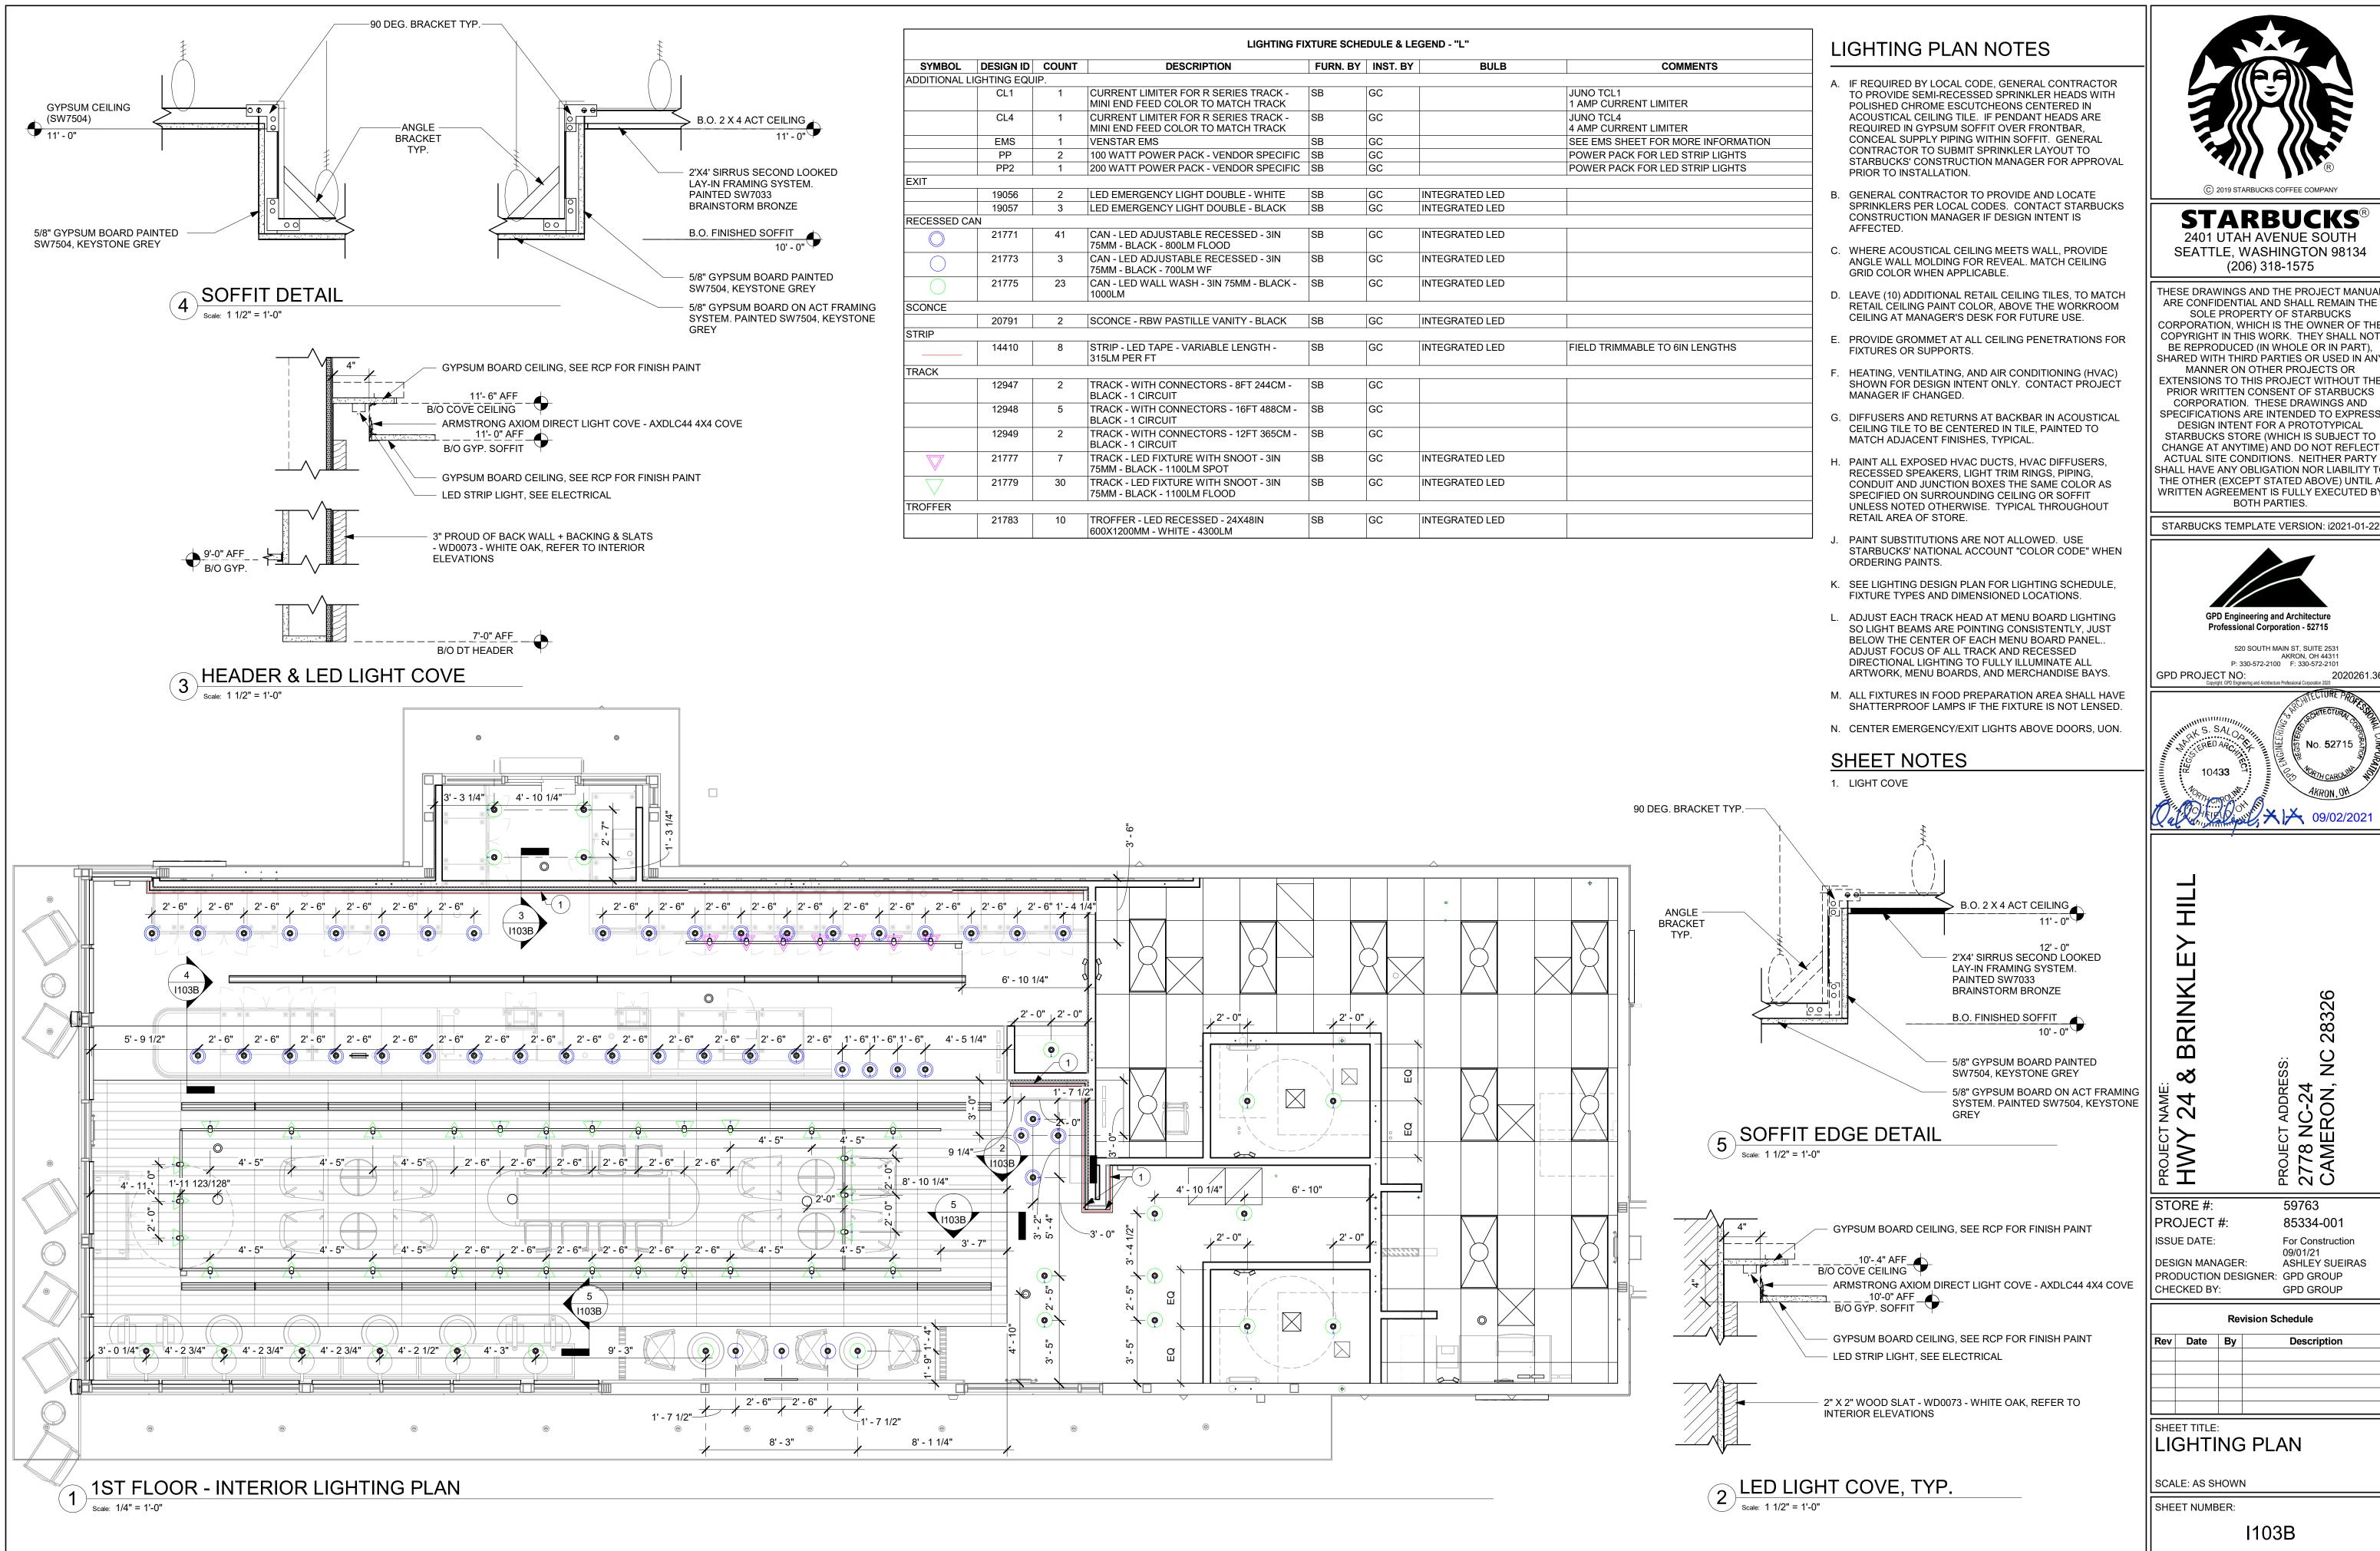

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520 SOUTH MAIN ST, SUITE 2531

2020261.36



S

85334-001 For Construction **ASHLEY SUEIRAS**

PRODUCTION DESIGNER: GPD GROUP **GPD GROUP**

WALL BASE SCHEDULE - "B"						
DESIGN ID	LENGTH	DESCRIPTION	FURN. BY	INST. BY	COMMENTS	
TILE BASE	•		•	•		
11403	168' - 2"	TILE BASE - BLACK - 6X12IN 150X305MM	SB	GC	GROUT GR0008: MAPEI 10 - BLACK; LATICRETE 45 - RAVEN; PRETOKOLL - P.FLEX PRETO	
19795	379' - 2 1/2"	POLYVINYL FLOOR TILE - ECOGRIP - PEWTER	GC	GC		
X51001	52' - 7 1/2"	SCHLUTER COVE BASE (TILE-TO-TILE)	GC	GC	LOCATED IN RESTROOMS. SATIN NICKEL. GC TO FIELD VERIFY TOTAL LENGTH PRIOR TO ORDERING	

CONCRETE FINISH NOTES

FINISHING PROCESS FOR CONCRETE SLAB

- INTEGRAL GRINDING WILL BEGIN AT A MINIMUM OF 36 HYBRID BOND DIAMOND GRIT, AFTER A UNIFORM SCRATCH PATTERN HAS BEEN DEVELOPED IN THE SURFACE OF THE CONCRETE; BEGIN GRINDING THE FLOOR UP TO A DIAMOND GRIT ACCEPTABLE FOR DENSIFING. LEVEL OF FINISH TO BE [OPEN AGGREGATE, SALT & PEPPER, LIGHT SAND]. GC TO HAND GRIND OR USE A STAND-UP EDGER FOR GRINDING/POLISHING EDGE AND INSIDE CORNER CONDITIONS.

- CLEAN FLOOR WITH VEXCON CERTI-SHINE CLEAR DENSIFIER APPLIED IN MULTIPLE COATS. - AFTER THE DENSIFIER HAS CURED, RINSE THE FLOOR WITH VEXCON CERTI-SHINE FIXATIVE, REMOVING UN-REACTED SILICATES FROM THE SURFACE OF THE CONCRETE AND IMPROVING THE CHEMICAL AND STAIN RESISTANCE OF THE POLISHED CONCRETE SYSTEM.

- ONCE THE RINSE HAS BEEN COMPLETED CONTINUE POLISHING THE FLOOR UP TO A 400 GRIT POLISH. - CLEAN FLOOR AGAIN AND APPLY A VEXCON CERTISHINE FINISH COAT ULTRA WB IN MULTIPLE COATS. ALLOWING FOR

- AFTER THE STAIN PROTECTANT HAS CURED, BURNISH THE FLOOR WITH A HIGH SPEED BUFFER.

POLISHING PROCEDURE:

- ADHERE TO INDUSTRY STANDARD POLISHING PROCEDURES FOR DRY AND WET GRINDING/POLISHING IS ACCEPTABLE WHEN INDUSTRY STANDARD POLISHING PROCEDURES ARE ADHERED TO.

- SCRUB AND RINSE SLAB SURFACE WITH CLEAN WATER AND VACUUM WITH AUTO-SCRUBBER BETWEEN AND AFTER FINAL POLISHING PASSES..

- SEQUENTIAL PROGRESSION OF DIAMOND POLISHING STEPS SHALL BE REQUIRED AND LIMITED TO NO MORE THAN DOUBLE THE GRIT VALUE OF THE PREVIOUS DIAMONDS USED.

- OVERLAP ADJACENT POLISHING PASSES BY 25 PERCENT PERFORM EACH PASS PERPENDICULAR TO THE OTHER PASS NORTH/SOUTH THEN EAST/WEST; MULTIPLE PASSES

MAY BE NEEDED. - PROGRESSIVELY GRIND AND POLISH THE SLAB SURFACE UTILIZING APPROVED DIAMOND SEGMENTS AS NECESSARY

TO PRODUCE FINISHING REQUIREMENTS.

- Clean dirt, dust, oil, grease and other contaminants that interfere with penetration or performance of specified product from surfaces. Use appropriate concrete cleaners approved by the concrete surface treatment manufacturer where necessary. Rinse thoroughly using pressure water spray to remove cleaner residues. Allow surfaces to dry completely before application of product.
- cure completely before application of product. - Variations in substrate texture and color will affect final appearance and should be corrected prior to application of sealer/hardener

- Repair, patch and fill cracks, voids, defects and damaged areas in surface as approved by the Architect. Allow repair materials to

- system and the polishing steps. - Protect surrounding areas prior to application of densifiers and stains. If products are accidentally misapplied to adjacent surfaces,
- flush with water immediately before material dries. - Avoid contact in areas not to be treated. Avoid contact with metal, glass and painted surfaces.
- Apply specified sealants and caulking and allow complete curing before application of penetrating concrete hardener/densifier.
- Test surfaces with droplets of water. If water beads and does not penetrate surface, or penetrates only in some areas, profile
- surfaces by grinding, sanding, or abrasive blasting. Retest and continue profiling surface until water droplets immediately darken and uniformly penetrate concrete surfaces.

KEYED NOTES

- 1. ALIGN TILE TRANSITION WITH FACE OF ADJACENT WALL/SURFACE WHERE INDICATED.
- 2. FLOOR SINK LOCATION. SEE BUILDING FLOOR PENETRATION PLAN ON SHEET A102 AND PLUMBING FOR ADDITIONAL INFORMATION.
- 3. RECESSED ELECTRICAL. SEE BUILDING FLOOR PENETRATION PLAN ON SHEET A102 AND ELECTRICAL FOR ADDITIONAL INFORMATION.
- 4. RECESSED WALK-OFF MAT AT ENTRY.
- 5. MOP SINK WHERE INDICATED. SEE PLUMBING PLANS FOR MORE INFORMATION.
- 6. SEE BUILDING FLOOR PENETRATION PLAN AND PLUMBING AND ELECTRICAL DRAWINGS FOR ADDITIONAL INFORMATION.

GENERAL NOTES

- A. WORKROOM TO BE FINISHED PER LOCAL CODE REQUIREMENTS.
- B. FLOORS, WALLS AND CEILING FINISHES IN FOOD PREPARATION AREAS SHALL BE SMOOTH, NON-TOXIC, NON-ABSORBENT, DURABLE AND EASILY CLEANABLE. PAINT SHALL BE WASHABLE; SEMI-GLOSS OR HIGH-GLOSS FINISH.
- C. STARBUCKS TO SUPPLY FLOORING AND BASE FOR FRONT AND BACK OF HOUSE AS NOTED IN SCHEDULES. GENERAL CONTRACTOR TO INSTALL. GENERAL CONTRACTOR TO SUPPLY WORKROOM TILE AND BASE AND INSTALL. GENERAL CONTRACTOR TO SUPPLY AND INSTALL MORTAR, ADHESIVE, AND GROUT, GENERAL CONTRACTOR TO INSPECT ALL TILES AND REJECT DAMAGED OR SUBSTANDARD TILES PRIOR TO INSTALLATION.
- D. ALIGN TILE TRANSITIONS ON WHOLE TILES AS SHOWN.
- E. ALL FLOOR AND WALL JUNCTIONS IN STORAGE AND FOOD PREPARATION AREAS SHALL HAVE A 6" COVED



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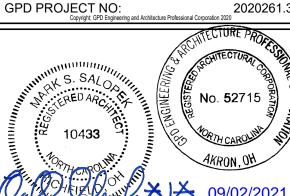
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STORE #: PROJECT #:

85334-001 ISSUE DATE: For Construction ASHLEY SUEIRAS


PRODUCTION DESIGNER: GPD GROUP CHECKED BY:

Revision Schedule

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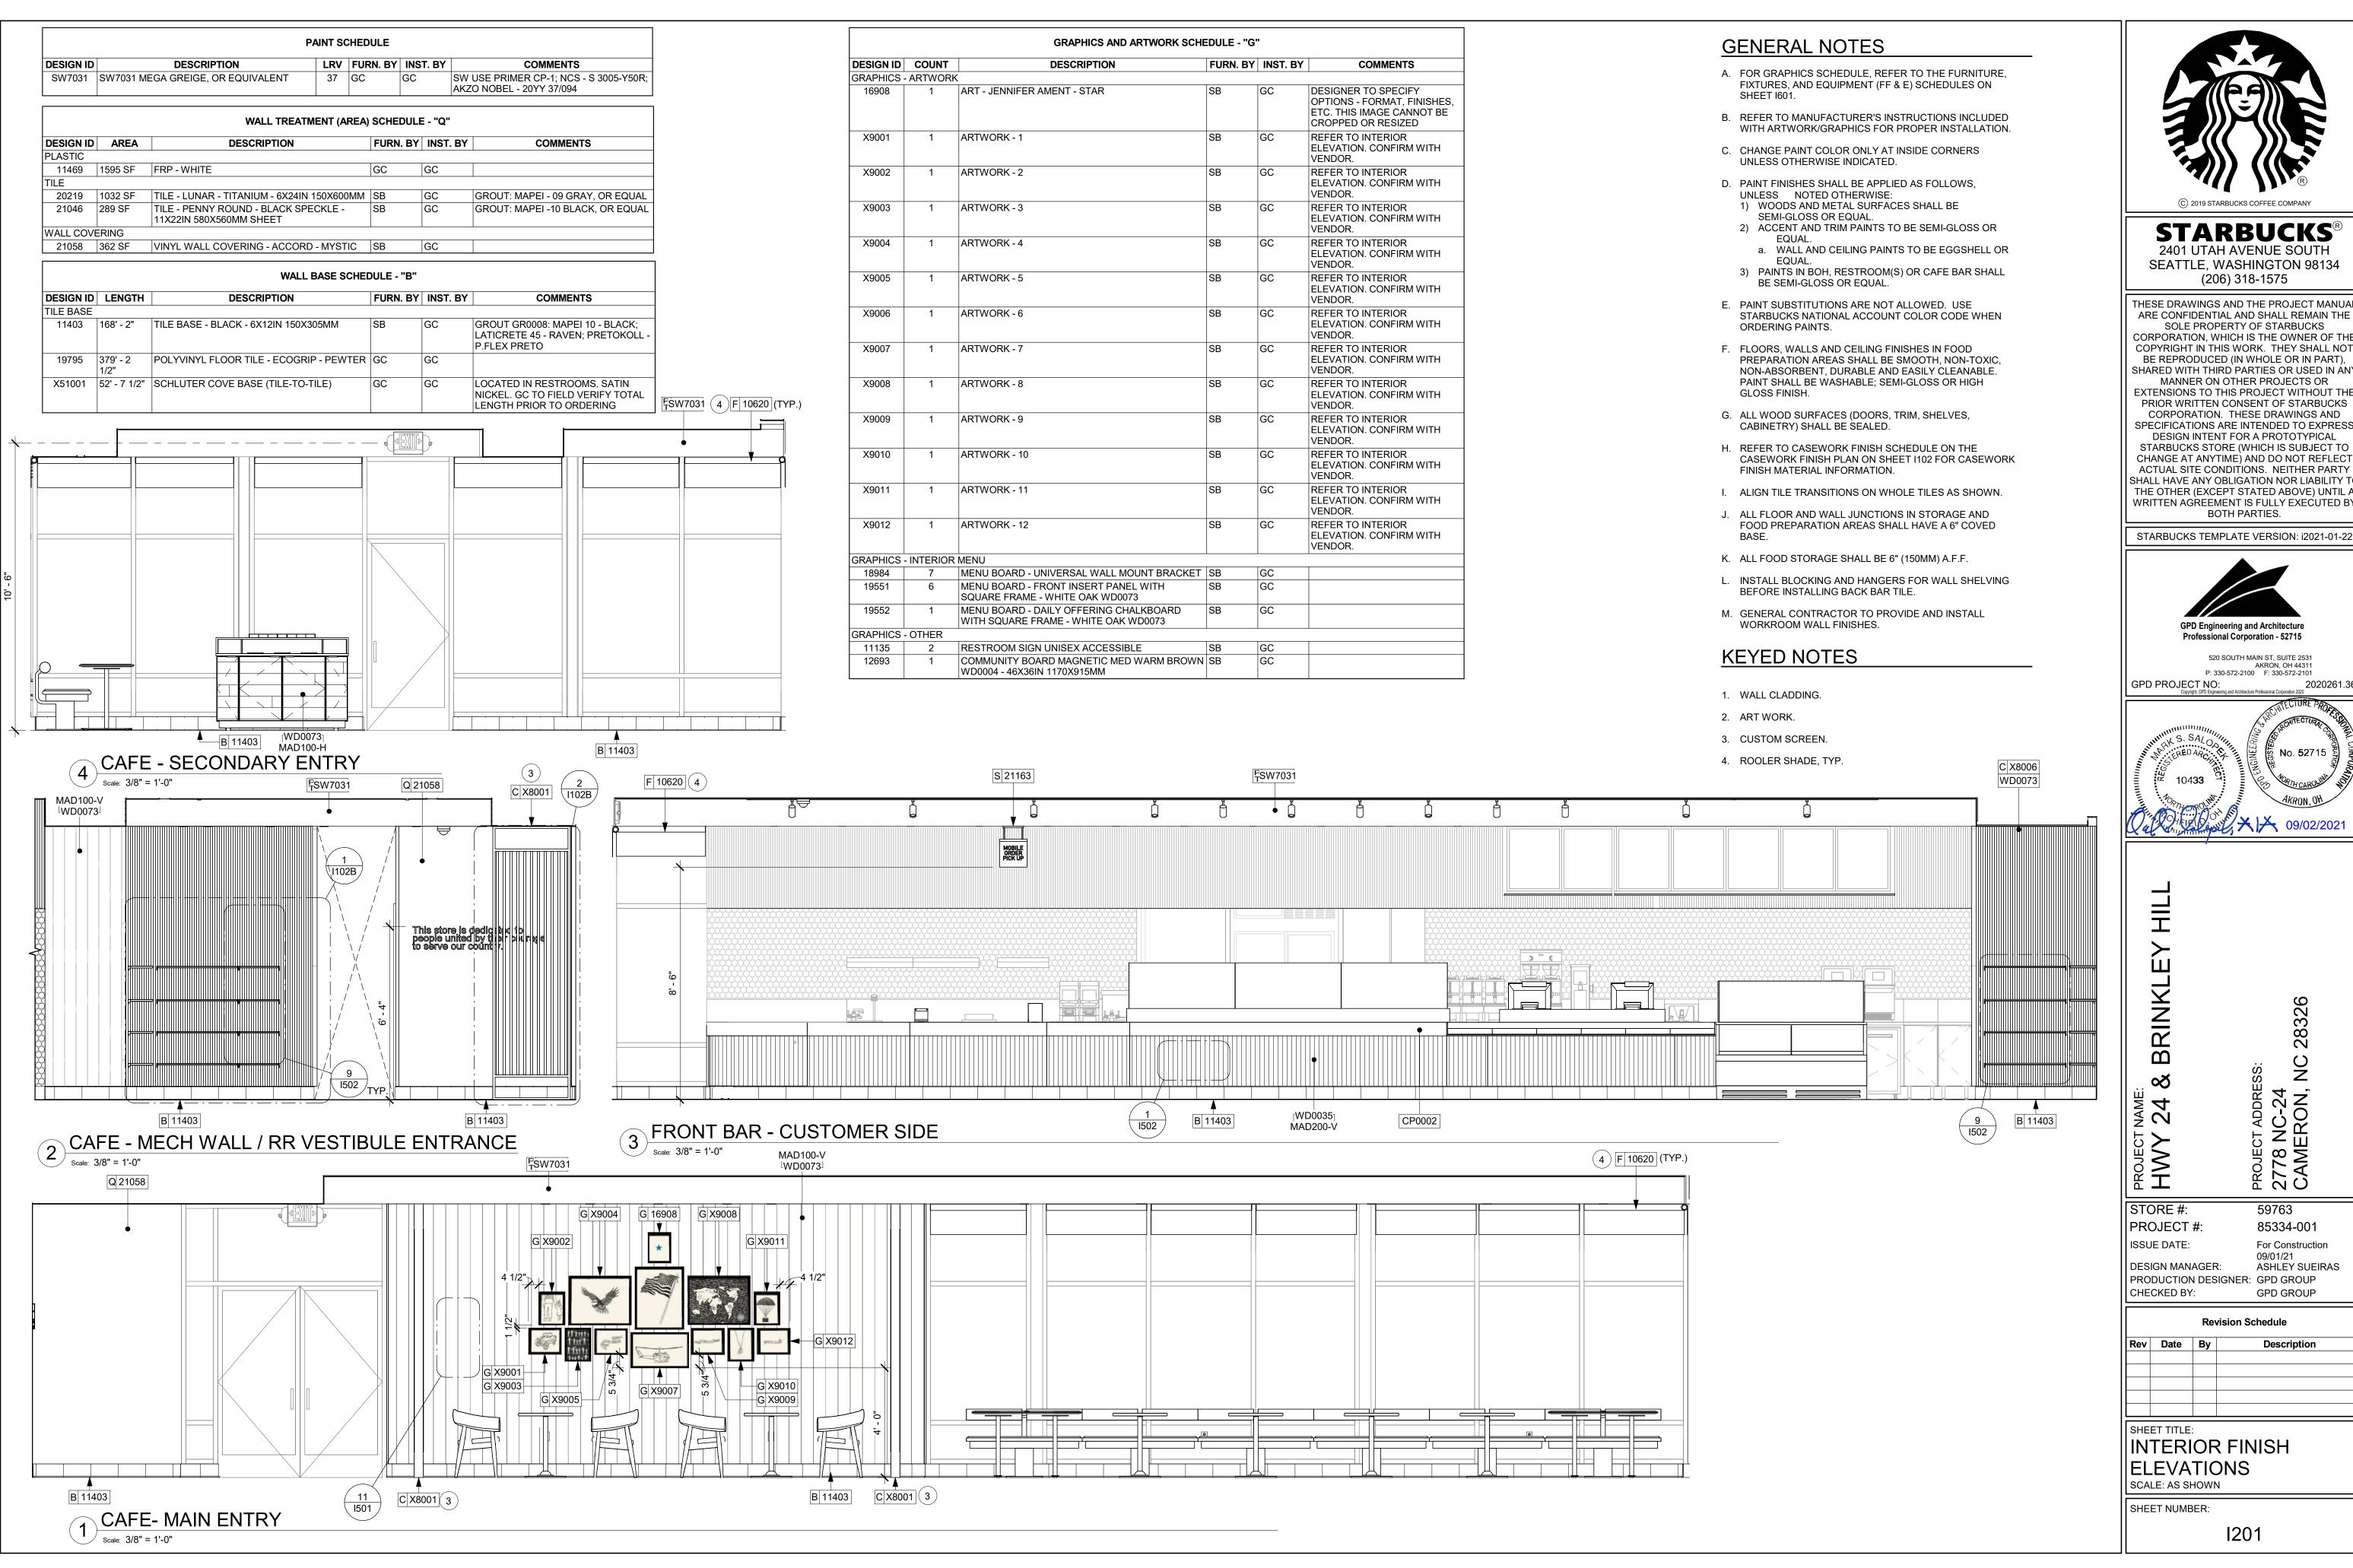
SCALE: AS SHOWN SHEET NUMBER:

I104

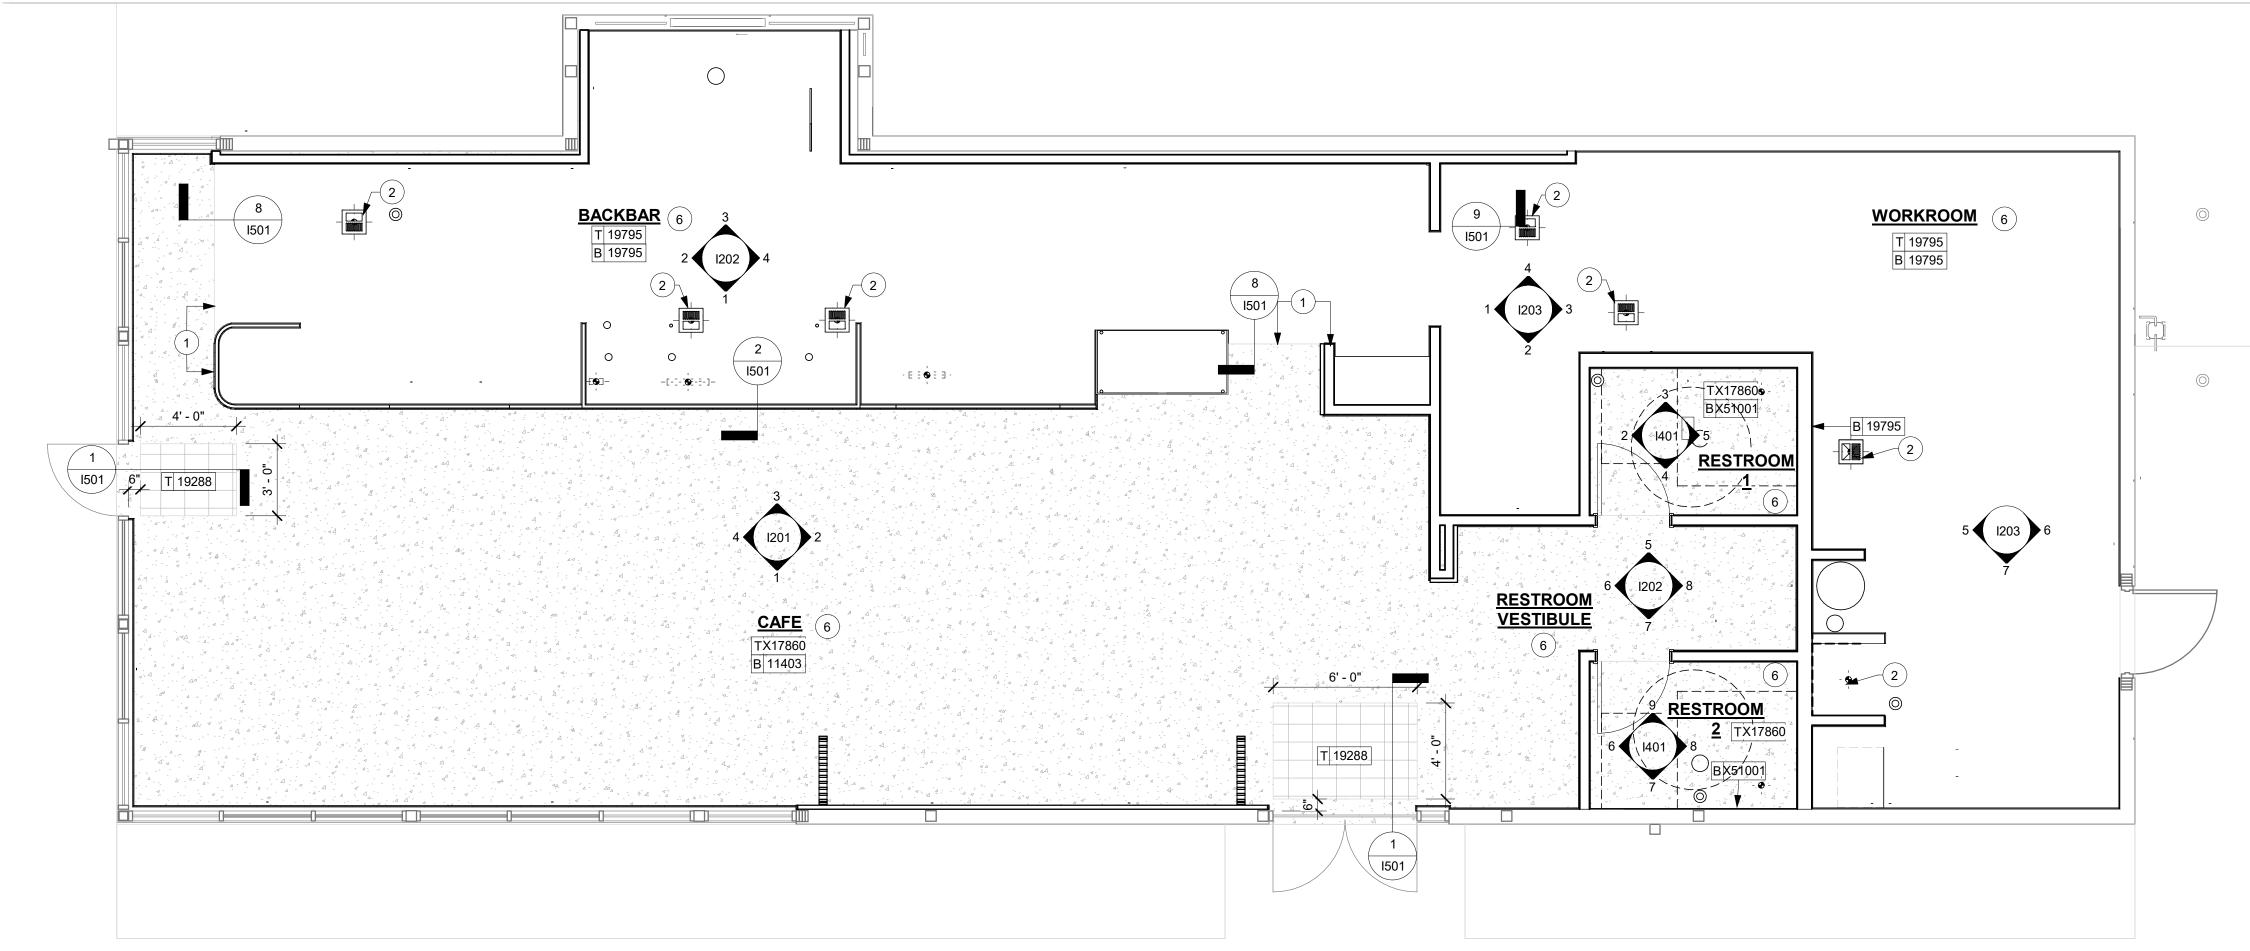

1ST FLOOR - FLOOR FINISH PLAN

Scale: 1/4" = 1'-0"



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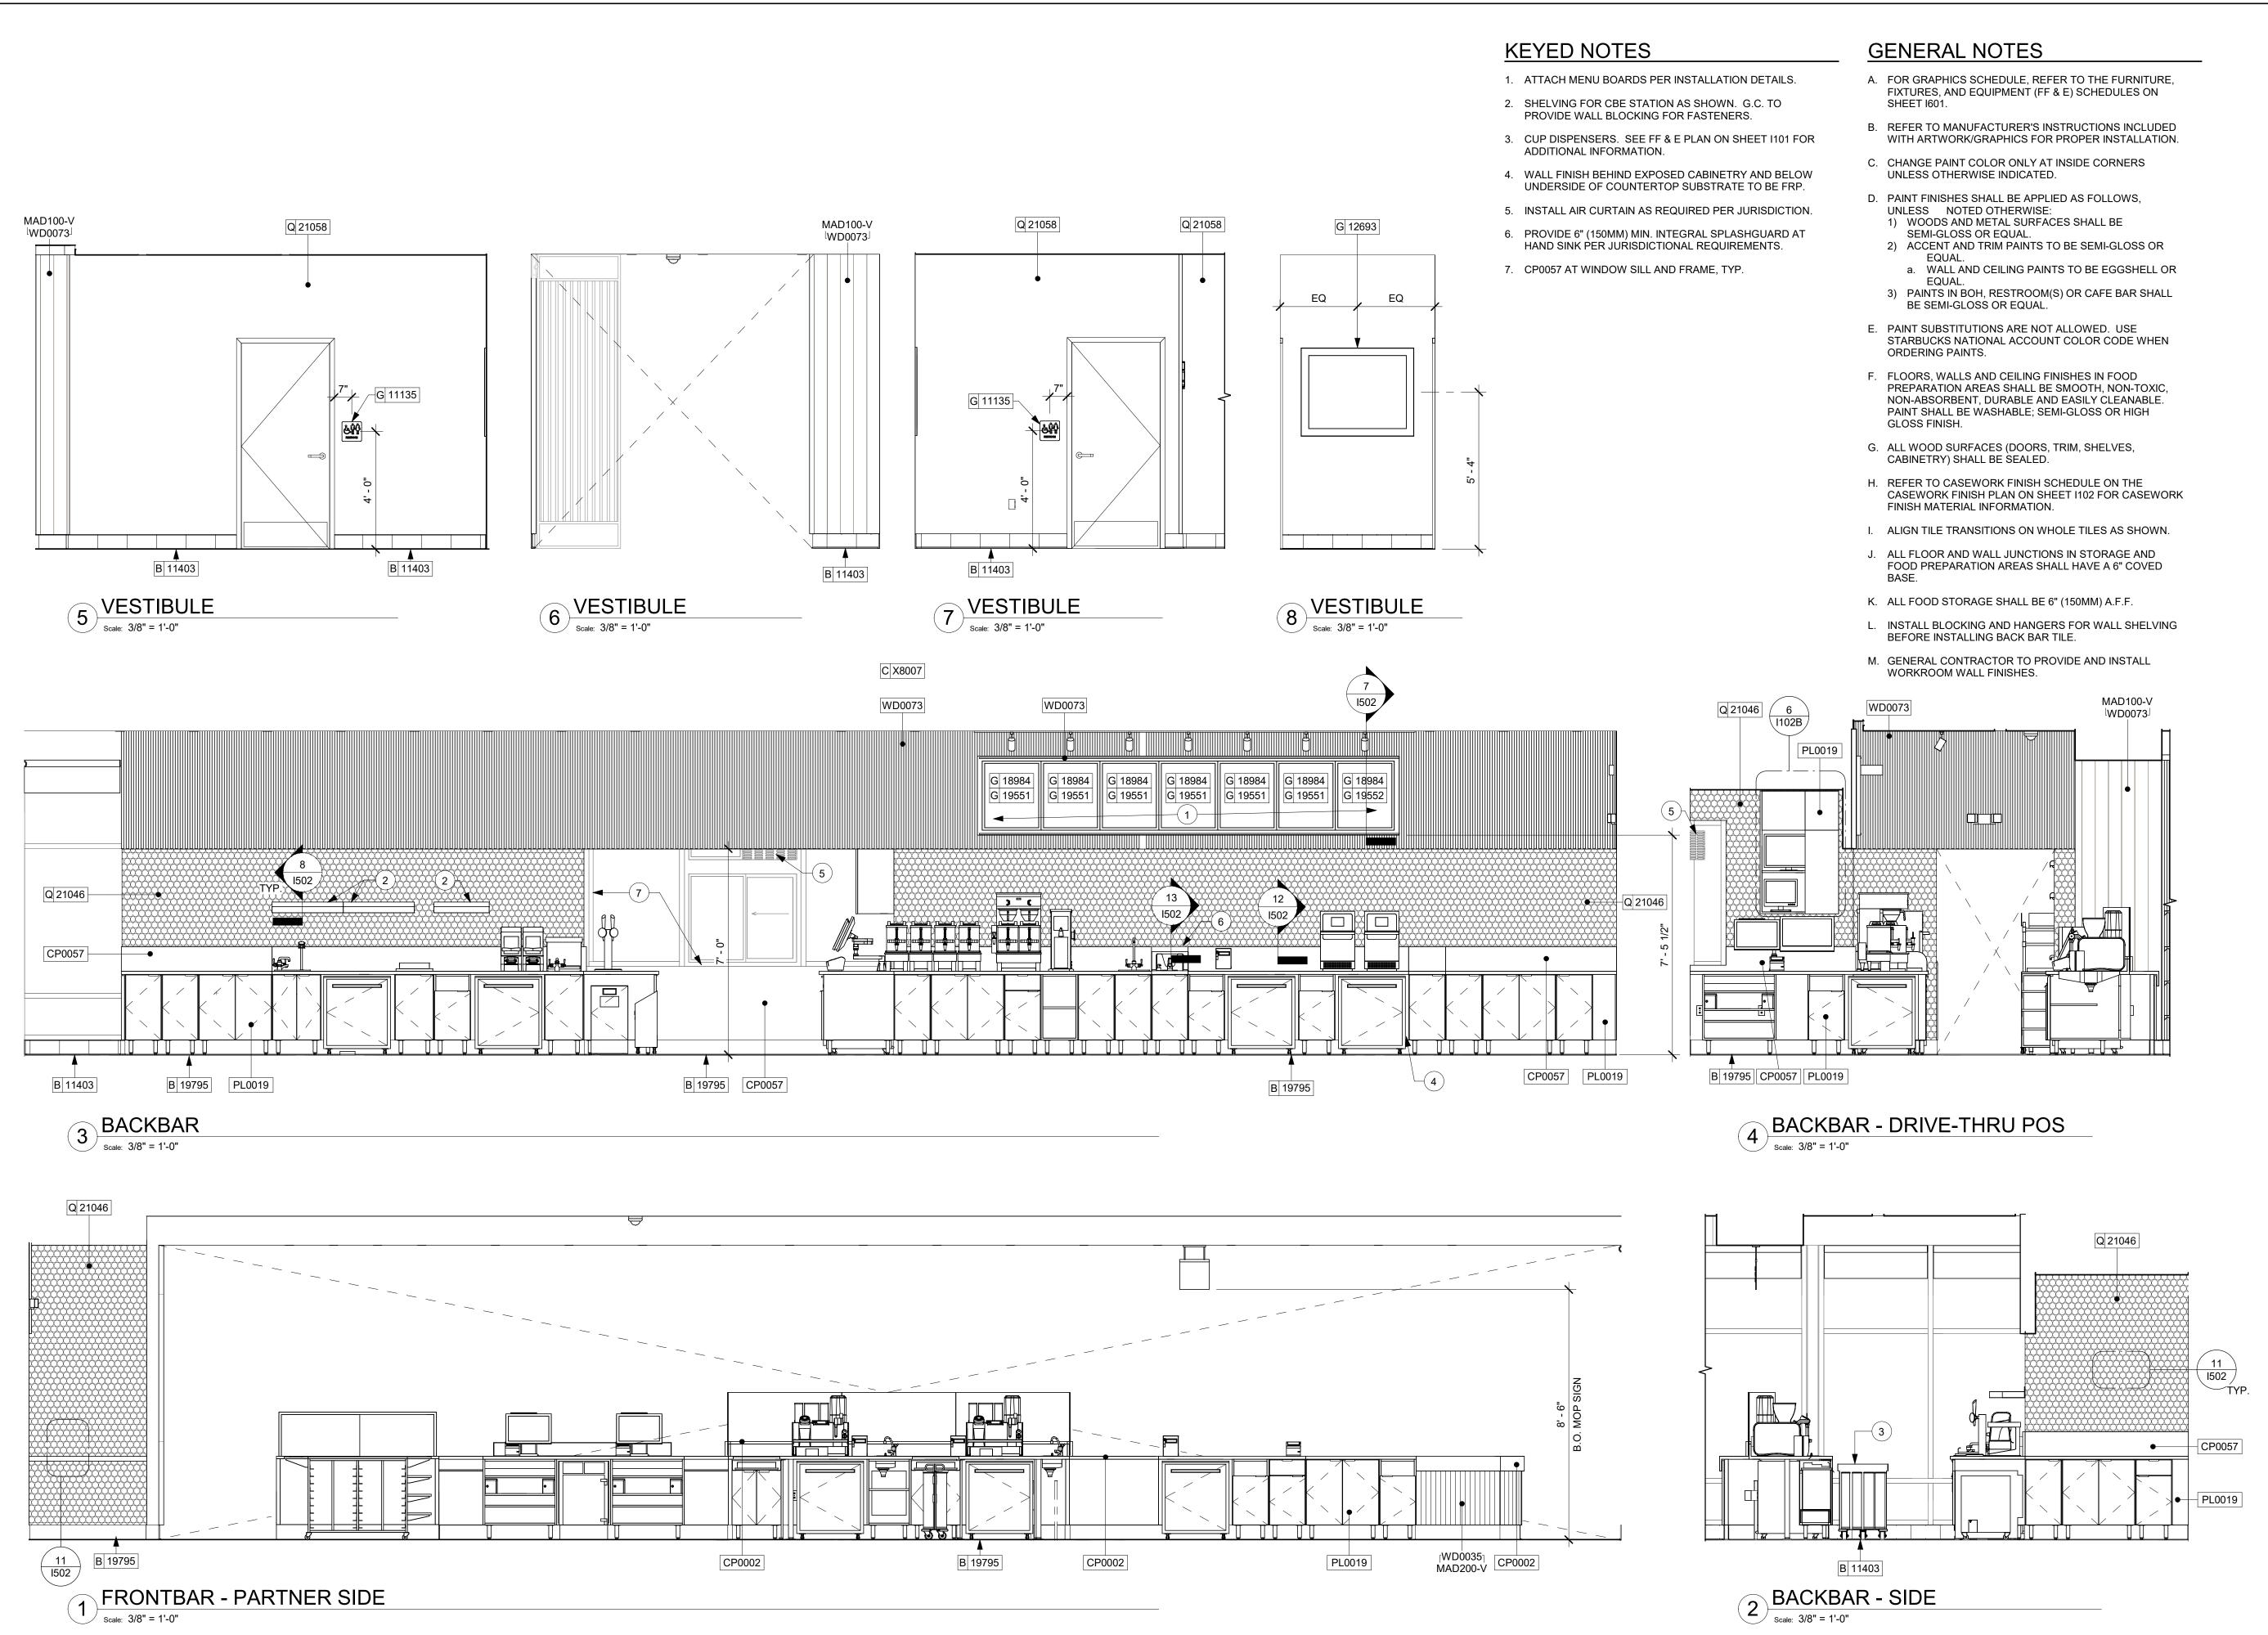
59763 85334-001 For Construction ASHLEY SUEIRAS

DESIGN MANAGER: PRODUCTION DESIGNER: GPD GROUP CHECKED BY: **GPD GROUP**

INTERIOR FINISH ELEVATIONS

SHEET NUMBER:

1201



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GPD PROJECT NO:
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Architecture Profes

No. 52715 & No. 52

Y 24 & BRINKLEY HIL

CT ADDRESS:

NC-24

STORE #: 59763
PROJECT #: 85334-001
ISSUE DATE: For Construction 09/01/21

DESIGN MANAGER: ASHLEY SUEIRAS PRODUCTION DESIGNER: GPD GROUP CHECKED BY: GPD GROUP

Revision Schedule

Rev Date By Description

SHEET TITLE:

INTERIOR FINISH ELEVATIONS SCALE: AS SHOWN

SHEET NUMBER:

1202

/2021 8:56:10 AM

	WALL TREATMENT (AREA) SCHEDULE - "Q"							
DESIGN ID	AREA	DESCRIPTION	FURN. BY	INST. BY	COMMENTS			
PLASTIC	PLASTIC							
11469	1595 SF	FRP - WHITE	GC	GC				
TILE								
20219	1032 SF	TILE - LUNAR - TITANIUM - 6X24IN 150X600MM	SB	GC	GROUT: MAPEI - 09 GRAY, OR EQUAL			
21046	289 SF	TILE - PENNY ROUND - BLACK SPECKLE - 11X22IN 580X560MM SHEET	SB	GC	GROUT: MAPEI -10 BLACK, OR EQUAL			
WALL COVE	WALL COVERING							
21058	362 SF	VINYL WALL COVERING - ACCORD - MYSTIC	SB	GC				

WALL BASE SCHEDULE - "B"							
DESIGN ID	LENGTH	DESCRIPTION	FURN. BY	INST. BY	COMMENTS		
TILE BASE	•		1	•			
11403	168' - 2"	TILE BASE - BLACK - 6X12IN 150X305MM	SB	GC	GROUT GR0008: MAPEI 10 - BLACK; LATICRETE 45 - RAVEN; PRETOKOLL - P.FLEX PRETO		
19795	379' - 2 1/2"	POLYVINYL FLOOR TILE - ECOGRIP - PEWTER	GC	GC			
X51001	52' - 7 1/2"	SCHLUTER COVE BASE (TILE-TO-TILE)	GC	GC	LOCATED IN RESTROOMS. SATIN NICKEL. GC TO FIELD VERIFY TOTAL LENGTH PRIOR TO ORDERING		

KEYED NOTES

- PROVIDE 6" (150MM) MIN. INTEGRAL SPLASHGUARD AT HAND SINK PER JURISDICTIONAL REQUIREMENTS.
- 2. WALL MOUNT HAND SINK WITH SOAP AND PAPER TOWEL DISPENSER. G.C. TO PROVIDE BLOCKING FOR FASTENERS.
- 3. ICE MACHINE (SEE PLUMBING AND ELECTRICAL DRAWINGS FOR ADDITIONAL INFORMATION).
- 4. MOP SINK. FULL HEIGHT FRP AT ENCLOSURE (SEE PLUMBING PLANS FOR MORE INFORMATION).
- 5. WATER HEATER (SEE PLUMBING DRAWINGS).
- 6. MANAGER'S DESK (SEE ENLARGED DETAILS).
- 7. ELECTRICAL PANELS (SEE ELECTRICAL DRAWINGS FOR ADDITIONAL INFORMATION).
- 8. WATER FILTRATION EQUIPMENT (SEE PLUMBING DRAWINGS).

GENERAL NOTES

- A. FOR GRAPHICS SCHEDULE, REFER TO THE FURNITURE, FIXTURES, AND EQUIPMENT (FF & E) SCHEDULES ON SHEET 1601.
- B. REFER TO MANUFACTURER'S INSTRUCTIONS INCLUDED WITH ARTWORK/GRAPHICS FOR PROPER INSTALLATION.
- C. CHANGE PAINT COLOR ONLY AT INSIDE CORNERS UNLESS OTHERWISE INDICATED.
- D. PAINT FINISHES SHALL BE APPLIED AS FOLLOWS, UNLESS NOTED OTHERWISE:
- WOODS AND METAL SURFACES SHALL BE SEMI-GLOSS OR EQUAL.
- 2) ACCENT AND TRIM PAINTS TO BE SEMI-GLOSS OR EQUAL.
 a. WALL AND CEILING PAINTS TO BE EGGSHELL OR
- EQUAL.
 3) PAINTS IN BOH, RESTROOM(S) OR CAFE BAR SHALL
- BE SEMI-GLOSS OR EQUAL.
- E. PAINT SUBSTITUTIONS ARE NOT ALLOWED. USE STARBUCKS NATIONAL ACCOUNT COLOR CODE WHEN ORDERING PAINTS.
- F. FLOORS, WALLS AND CEILING FINISHES IN FOOD PREPARATION AREAS SHALL BE SMOOTH, NON-TOXIC, NON-ABSORBENT, DURABLE AND EASILY CLEANABLE. PAINT SHALL BE WASHABLE; SEMI-GLOSS OR HIGH GLOSS FINISH.
- G. ALL WOOD SURFACES (DOORS, TRIM, SHELVES, CABINETRY) SHALL BE SEALED.
- H. REFER TO CASEWORK FINISH SCHEDULE ON THE CASEWORK FINISH PLAN ON SHEET I102 FOR CASEWORK FINISH MATERIAL INFORMATION.
- I. ALIGN TILE TRANSITIONS ON WHOLE TILES AS SHOWN.
- J. ALL FLOOR AND WALL JUNCTIONS IN STORAGE AND FOOD PREPARATION AREAS SHALL HAVE A 6" COVED BASE.
- K. ALL FOOD STORAGE SHALL BE 6" (150MM) A.F.F.
- L. INSTALL BLOCKING AND HANGERS FOR WALL SHELVING BEFORE INSTALLING BACK BAR TILE.
- M. GENERAL CONTRACTOR TO PROVIDE AND INSTALL WORKROOM WALL FINISHES.



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GPD PROJECT NO: 202026

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No. 52715 3 AKRON, OH AKRON, OH O9/02/2021

DJECT ADDRESS:
78 NC-24

STORE #: 59763
PROJECT #: 85334-001
ISSUE DATE: For Construction 09/01/21
DESIGN MANAGER: ASHLEY SUEIRAS

PRODUCTION DESIGNER: GPD GROUP

Revision Schedu

GPD GROUP

Rev Date By Description

SHEET TITLE:
INTERIOR FINISH
ELEVATIONS
SCALE: AS SHOWN

SHEET NUMBER:

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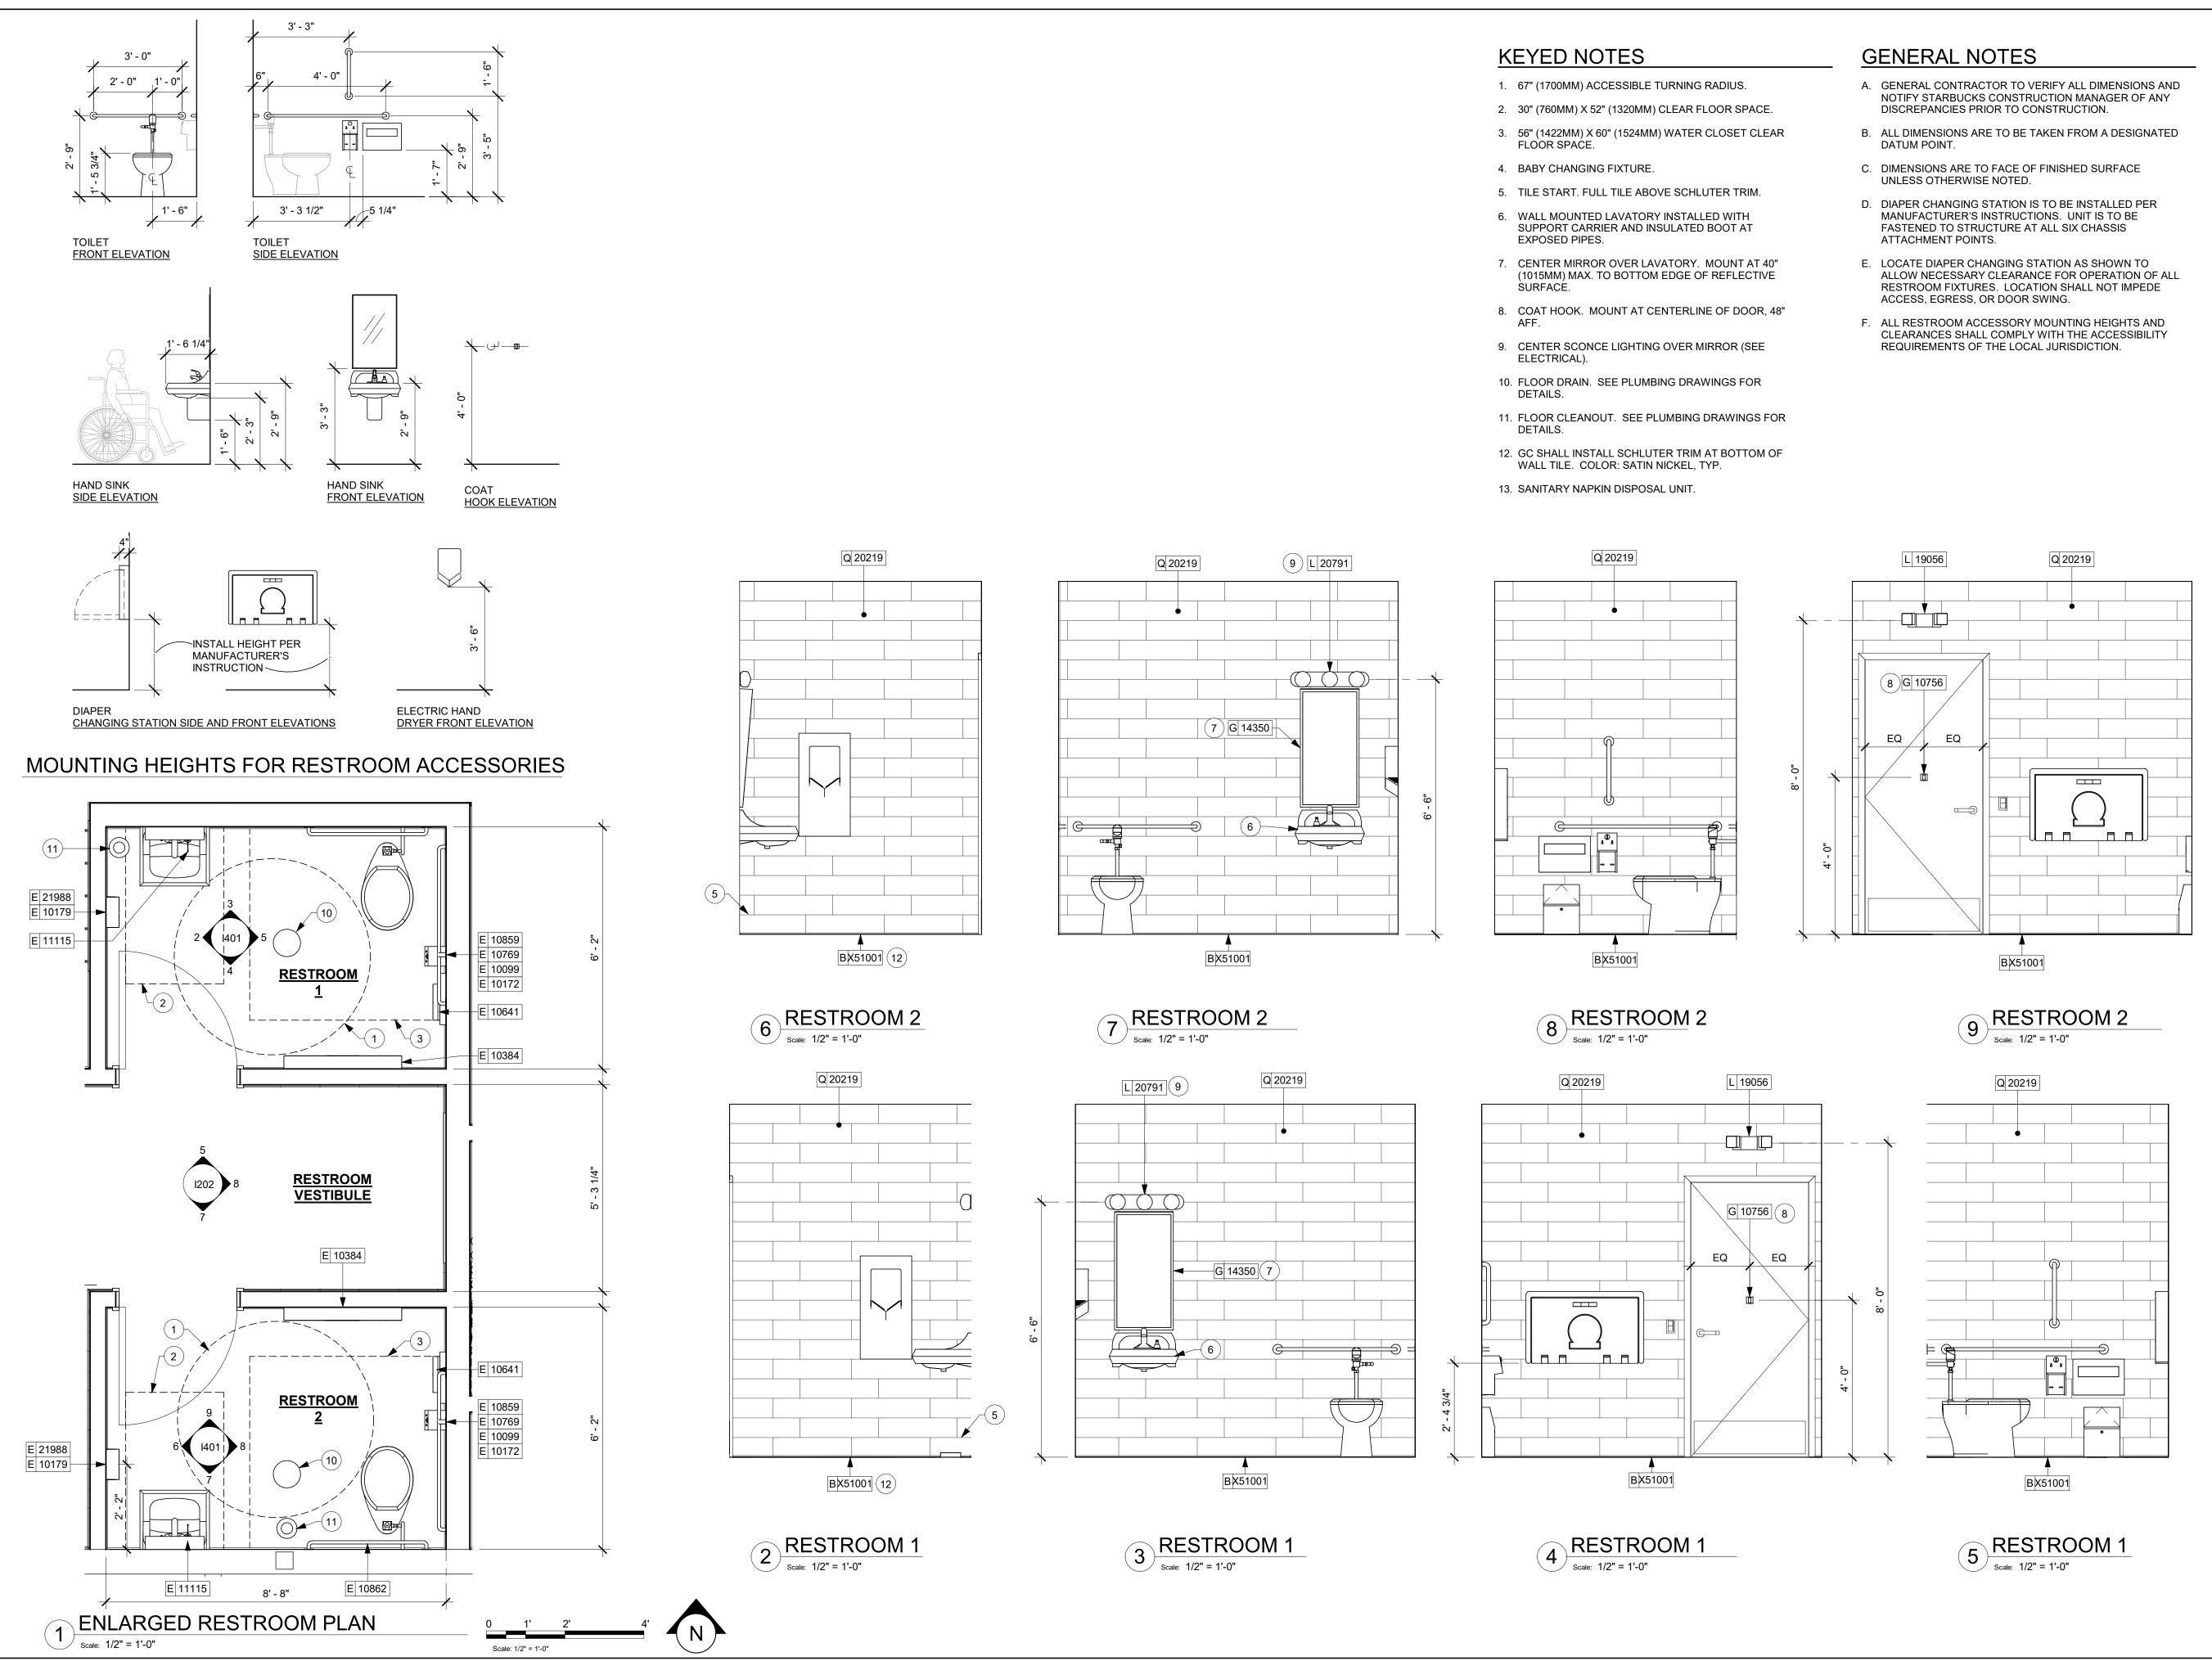
1203

Q 11469 Q 11469 B 19795 WORKROOM - MANAGER STATION WORKROOM Q 11469 Q 11469 Q 11469 5 3 WORKROOM - 3 COMP SINK & WATER FILTRATION

Scale: 3/8" = 1'-0" B 19795 4 WORKROOM

Scale: 3/8" = 1'-0" Q 11469 Q 11469 Q 11469 B 19795 (1) WORKROOM 2 WORKROOM
| Scale: 3/8" = 1'-0" 3 WORKROOM

Scale: 3/8" = 1'-0" Scale: 3/8" = 1'-0"



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GPD PROJECT NO:

PROJECT ADDRES 2778 NC-24 CAMERON, I 59763

85334-001 For Construction ASHLEY SUEIRAS

PRODUCTION DESIGNER: GPD GROUP CHECKED BY: GPD GROUP


RESTROOM PLAN & ELEVATIONS SCALE: AS SHOWN


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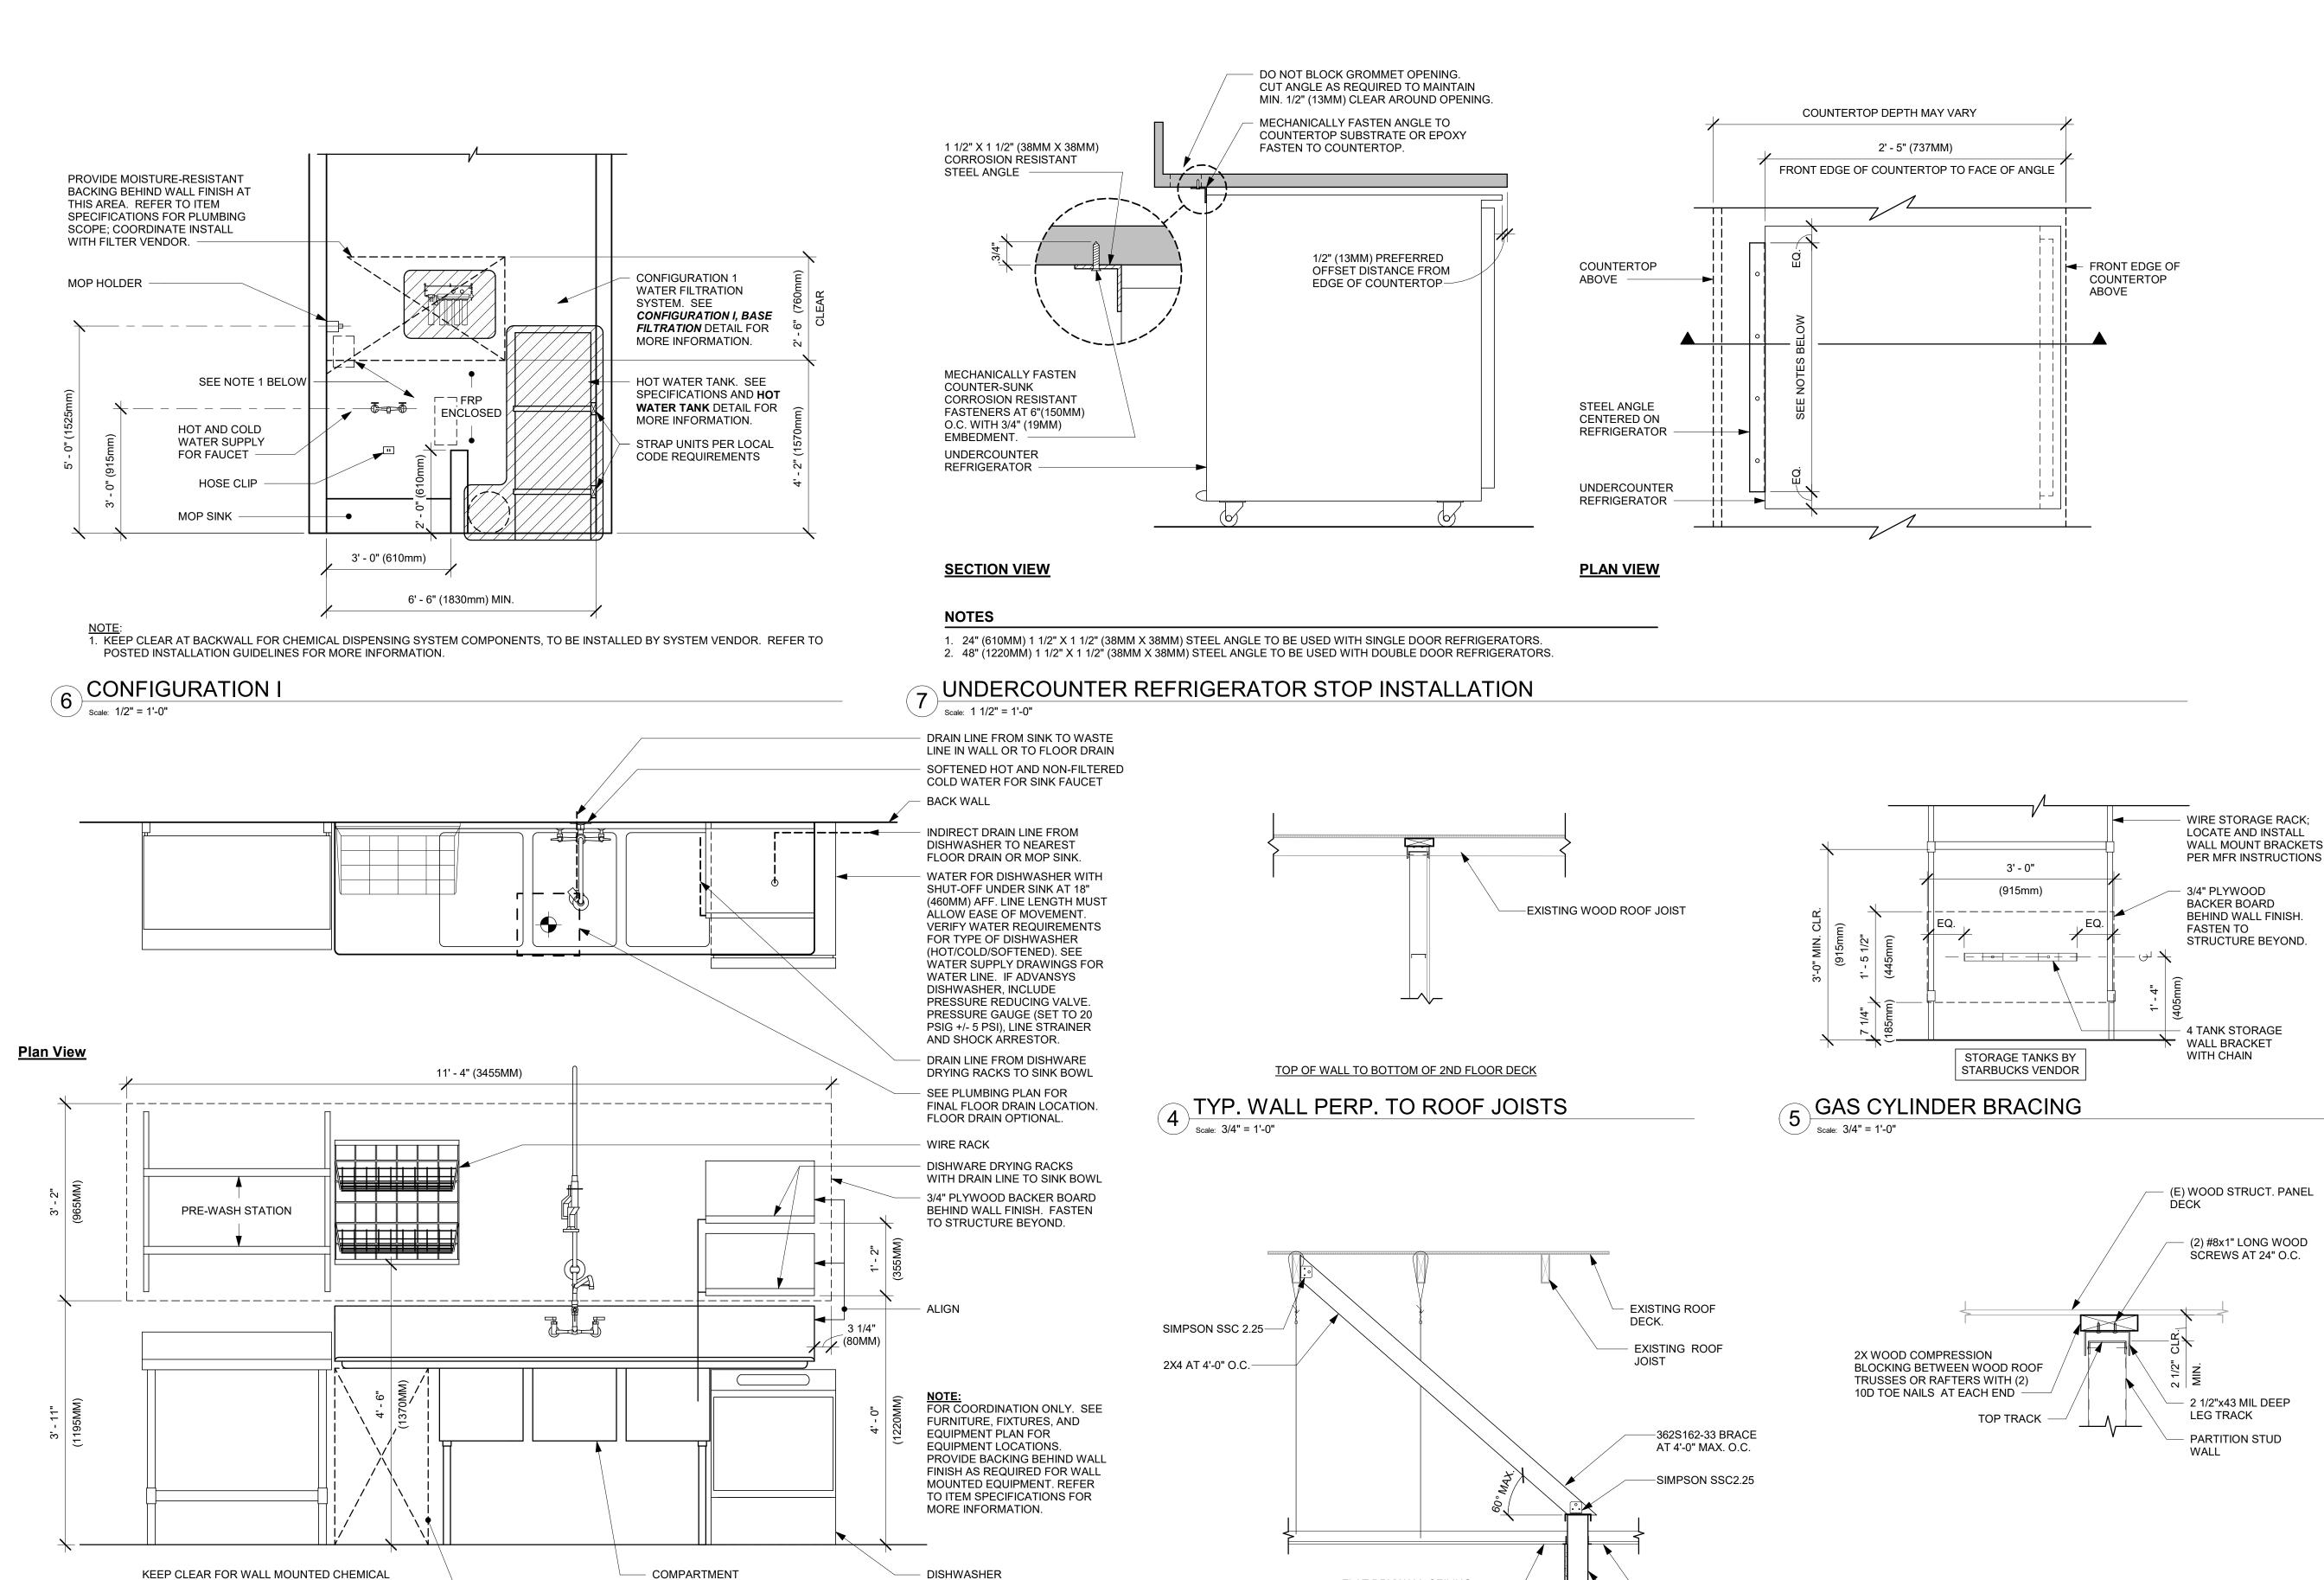
STORE #:

PROJECT #: ISSUE DATE:

1401



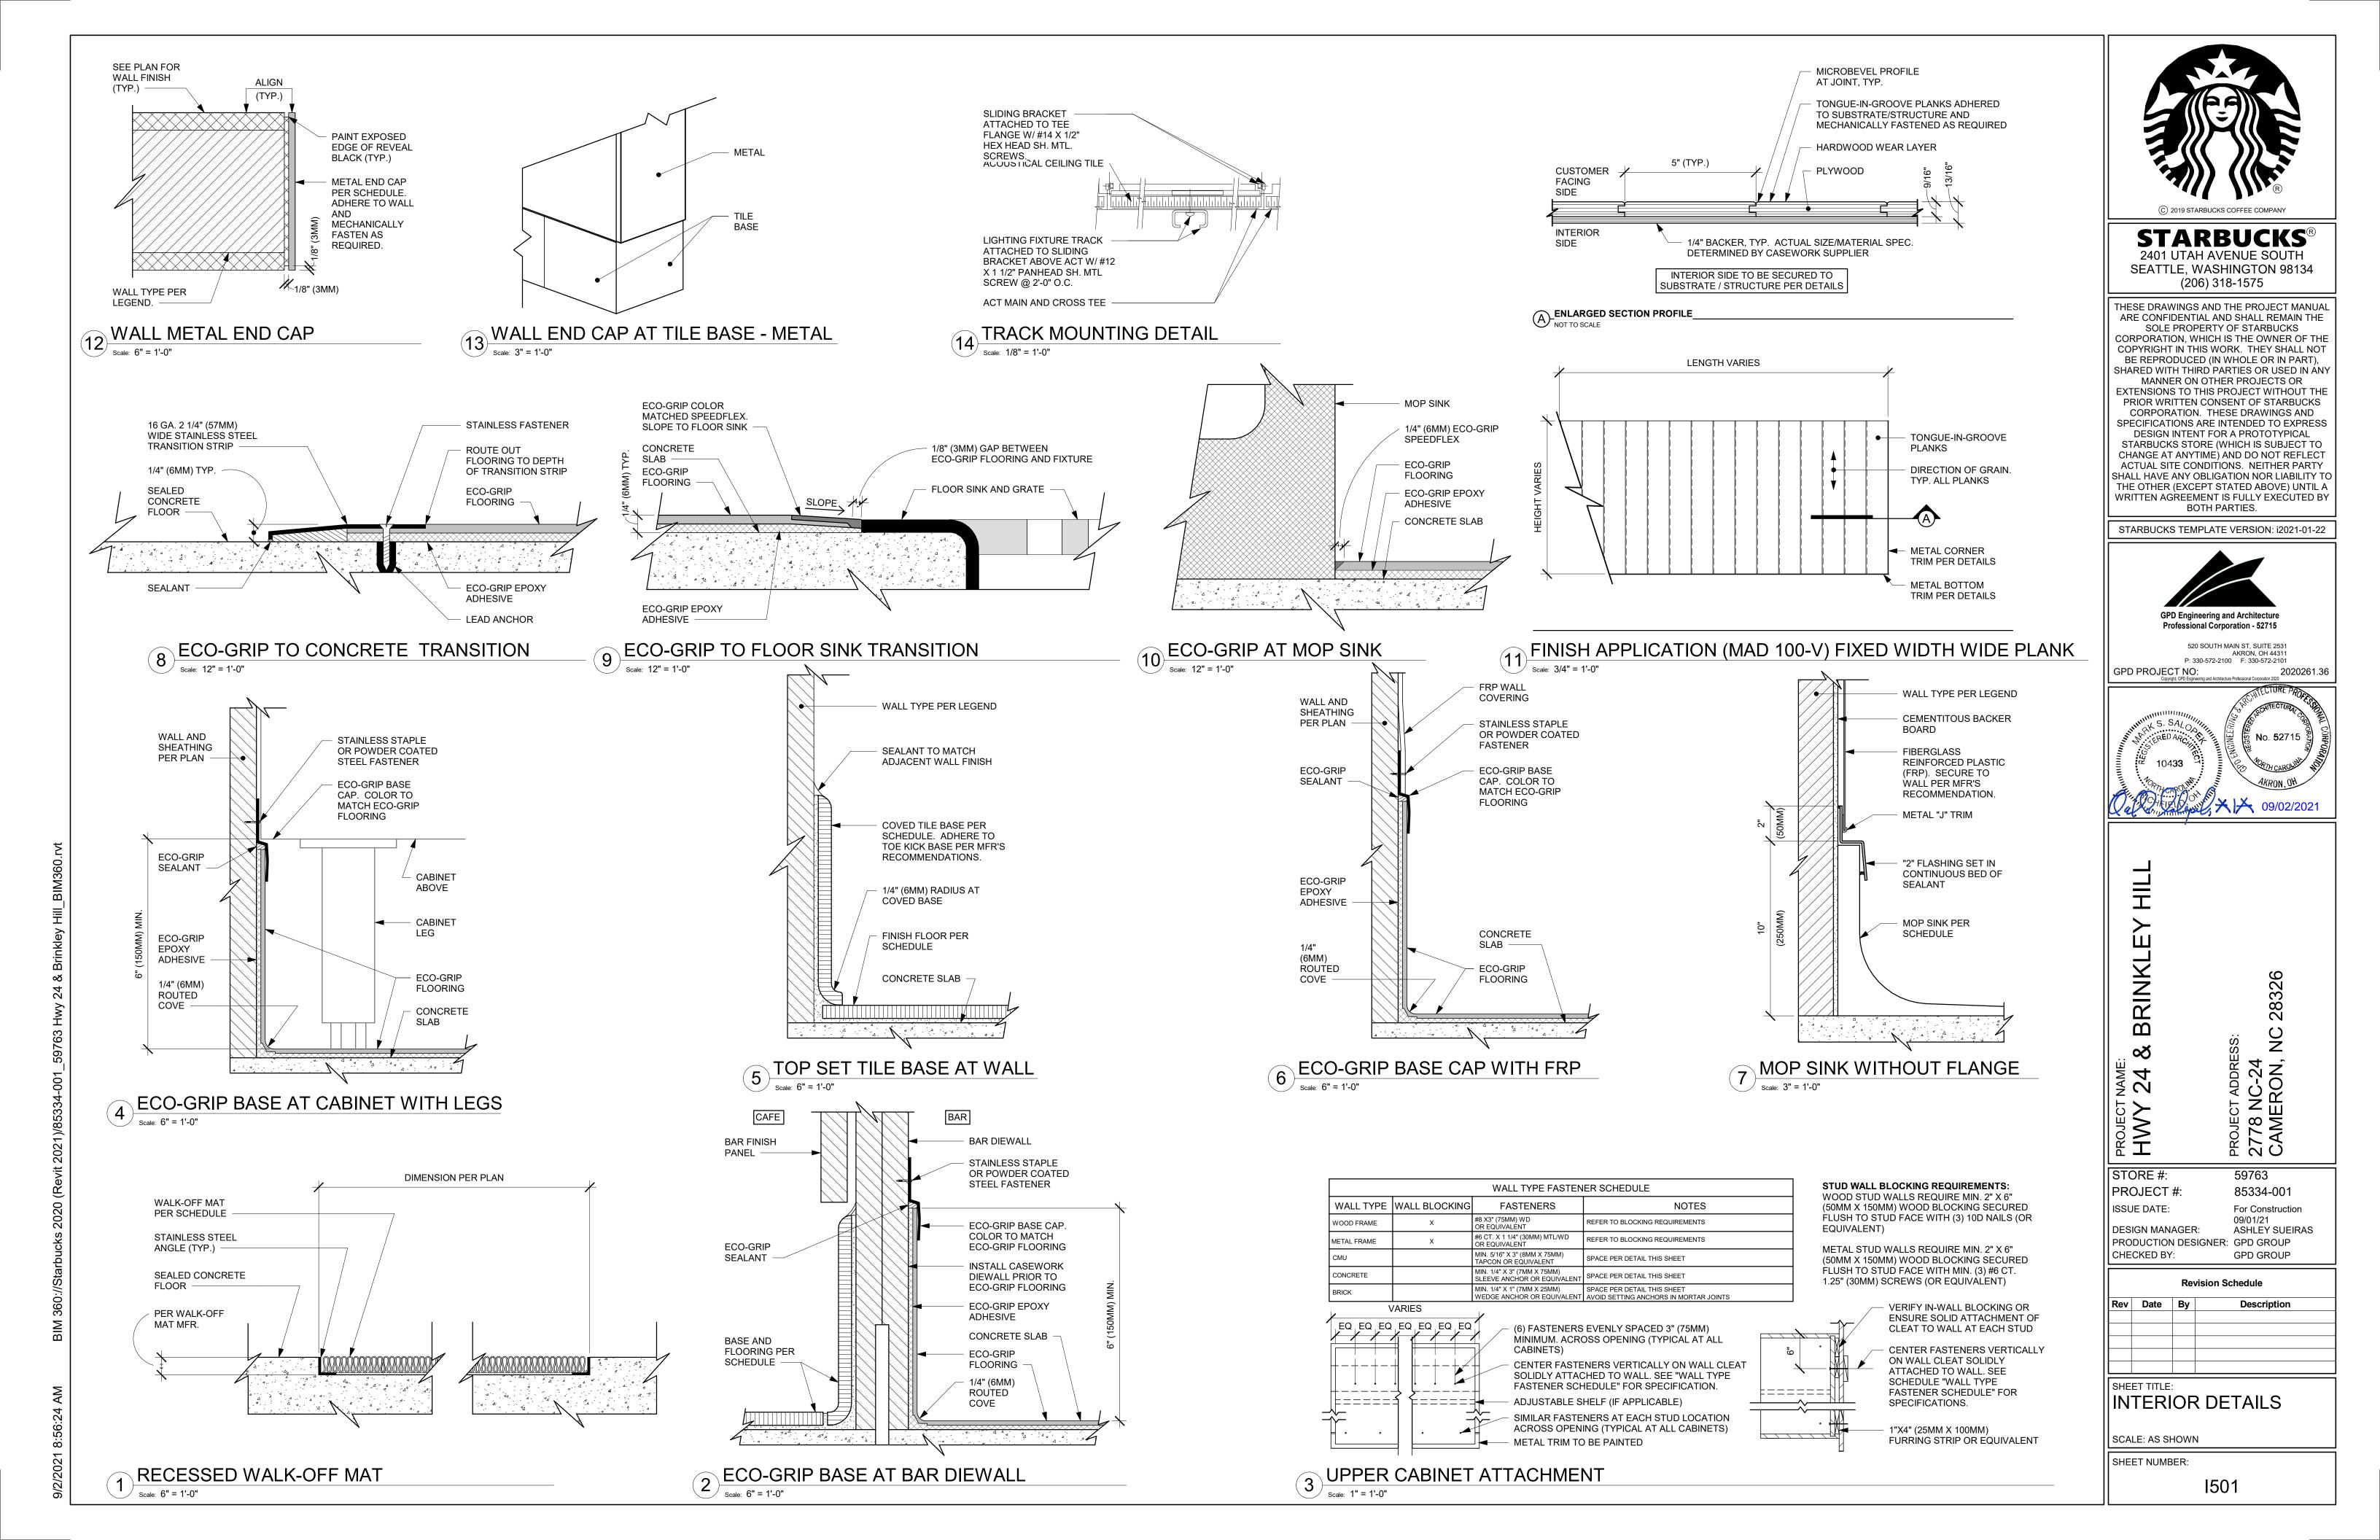

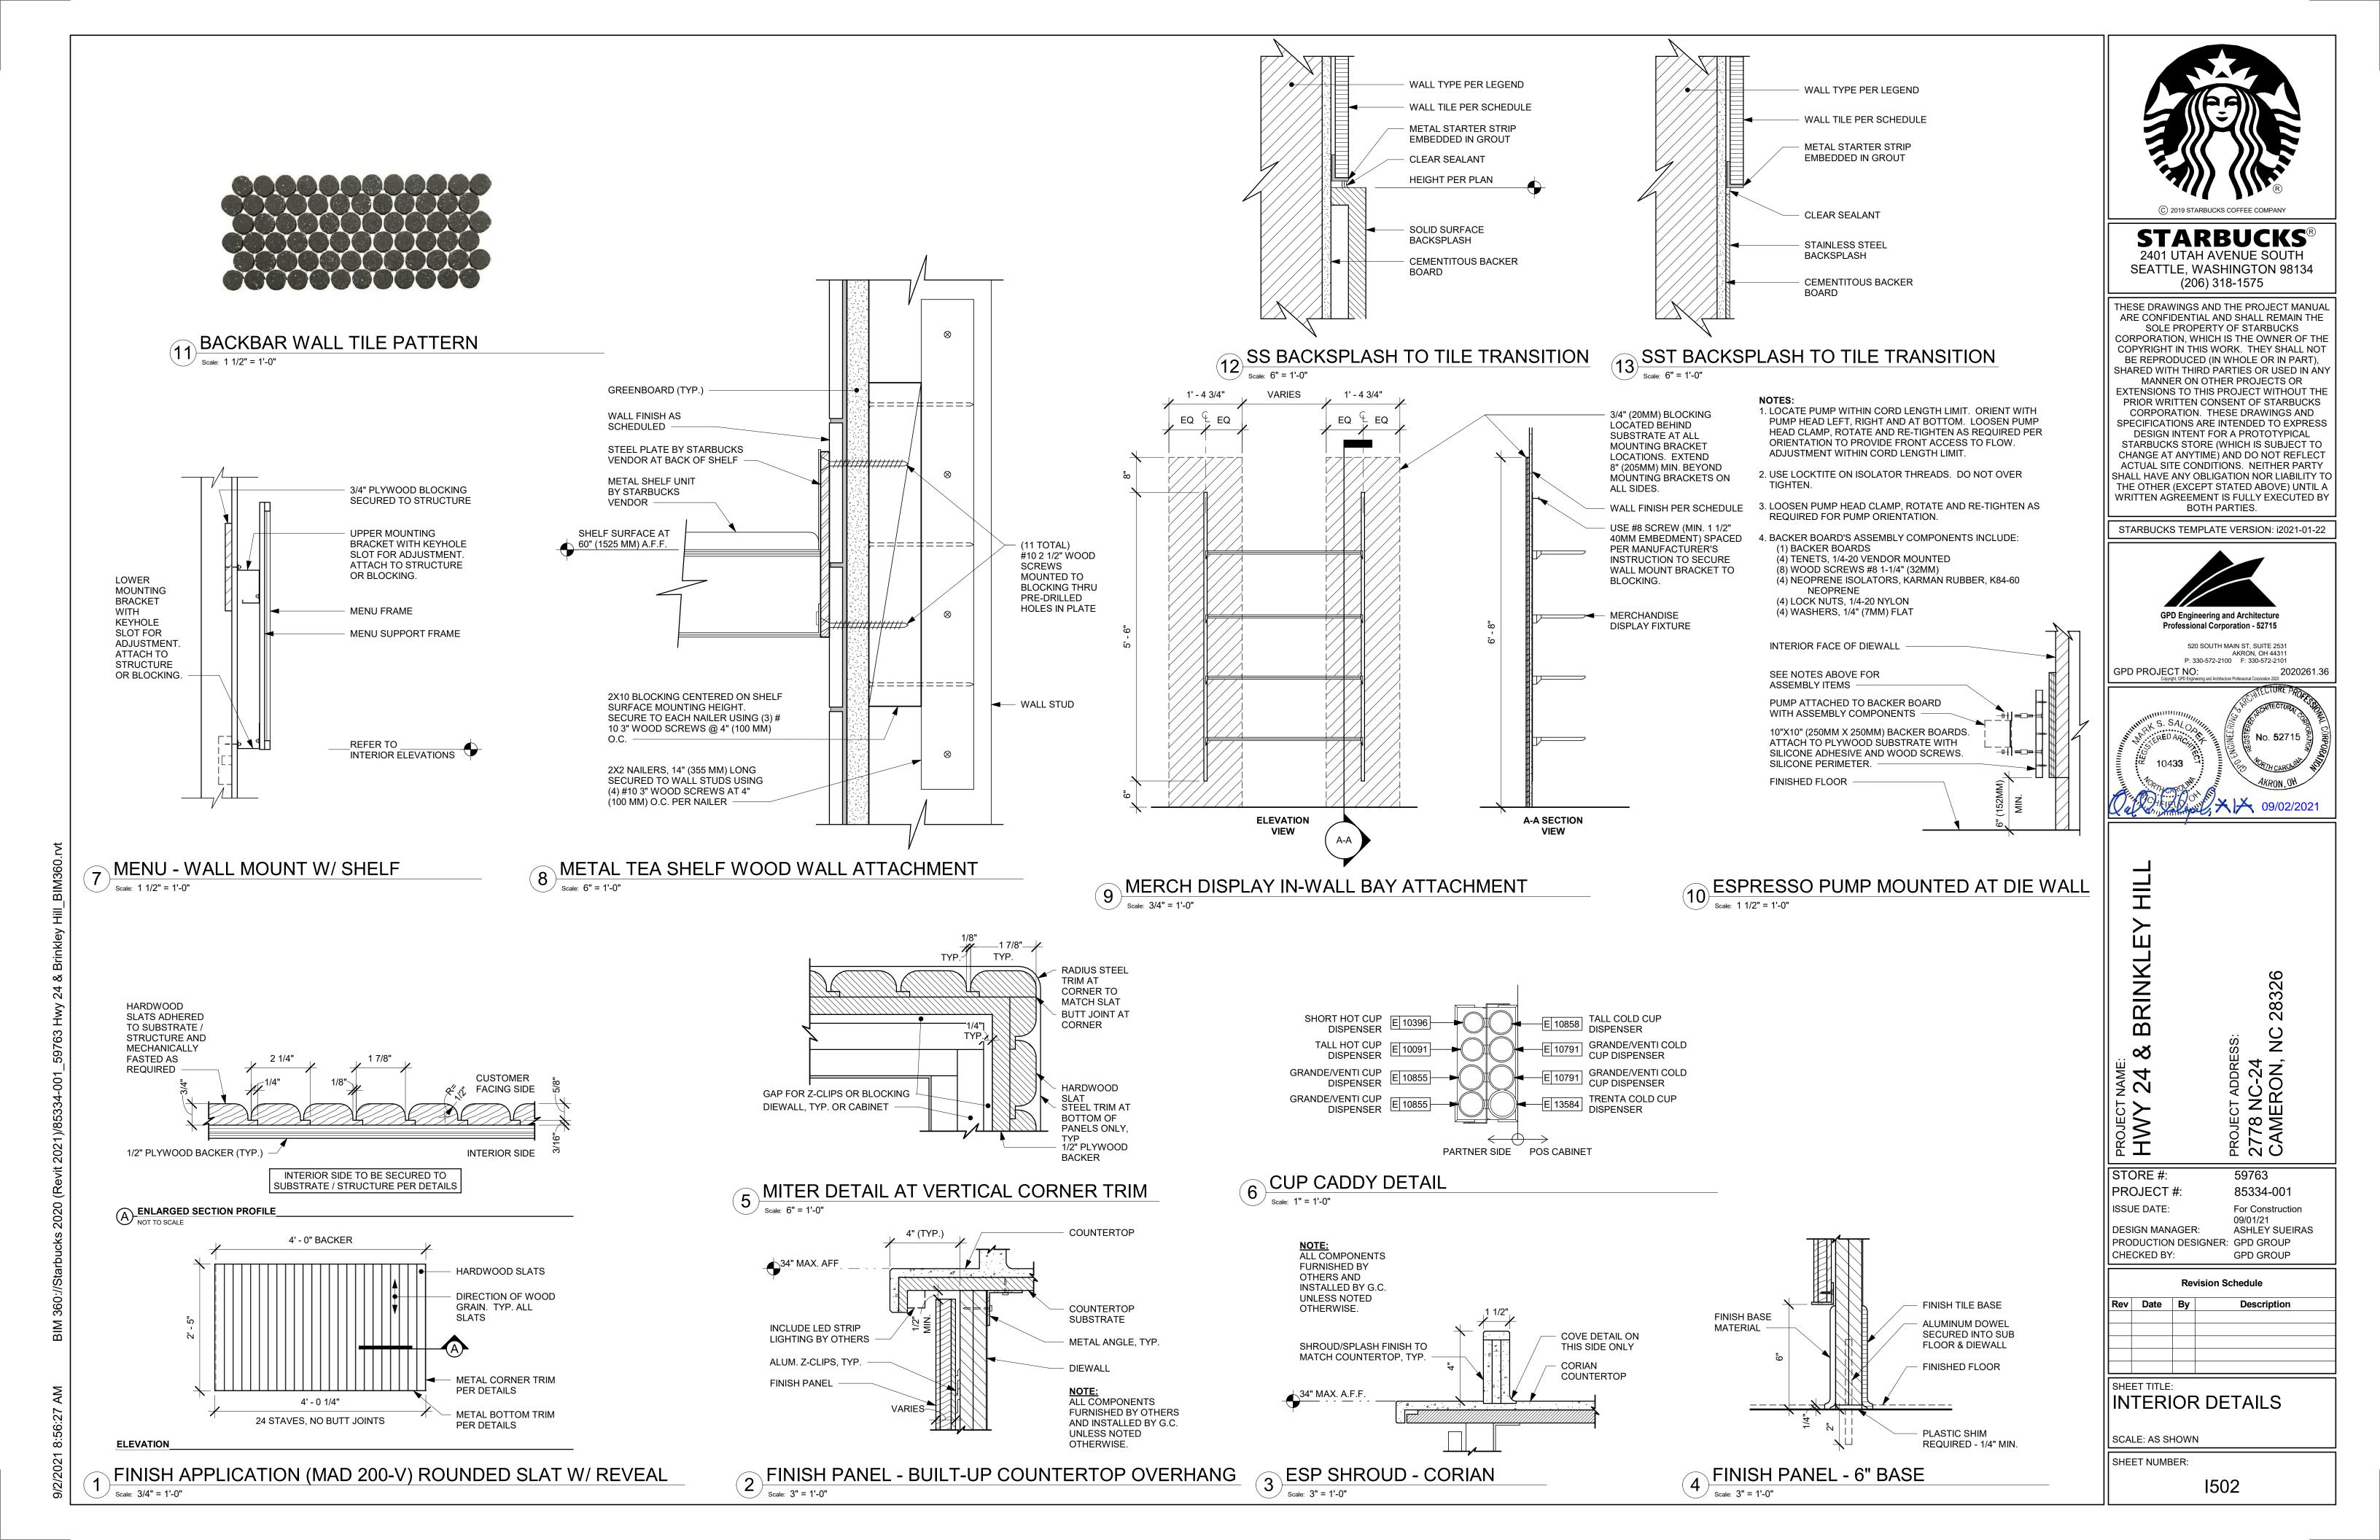

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BRINKL PROJECT ADDRE 2778 NC-24 CAMERON,

STORE #: 59763 PROJECT #: 85334-001 ISSUE DATE: For Construction 09/01/21 DESIGN MANAGER: ASHLEY SUEIRAS

PRODUCTION DESIGNER: GPD GROUP CHECKED BY: GPD GROUP

Revision Schedule

itev Date	,	Description
SHEET TITLE DESIG		DETAILS

SCALE: AS SHOWN

SHEET NUMBER:

1503

TYP. WALL PARALLEL TO AND BELOW TRUSSES

FLAT DRYWALL CEILING

SUSPENSION SYSTEM, SEE PLAN

NOTES AND INTERIORS DRAWINGS

TYPICAL SLIP TRACK CONNECTION

SANITIZING (GENERIC) - PLUMBING

DISPENSING SYSTEM, TO BE INSTALLED BY SYSTEM

VENDOR. PROVIDE BACKING BEHIND WALL FINISH

INSTALLATION GUIDELINES FOR MORE INFORMATION.

FOR EQUIPMENT MOUNTING. REFER TO POSTED

- COMPARTMENT SINK

-SUSP. A.C.T


-PARTITION WALL

RESTRICTIONS AND EXEMPTIONS MAY APPLY. ALL STRUTS AND ALLOWABLE LENGTHS SHOULD BE VERIFIED BY

APPROPRIATE AUTHORITIES.

WALL MOLDINGS SHOULD NOT BE USED AS STRUTS.


4. A STRUCTURAL ENGINEER SHOULD BE CONSULTED FOR LENGTHS GREATER

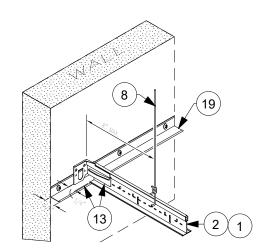


THAN 15'-0"

SEISMIC GRID AT WALL - UNATTACHED Scale: 1 1/2" = 1'-0"


1504

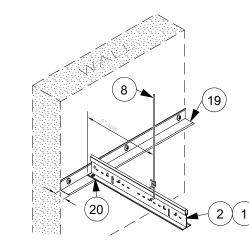


9 SEISMIC GRID AT WALL - ATTACHED

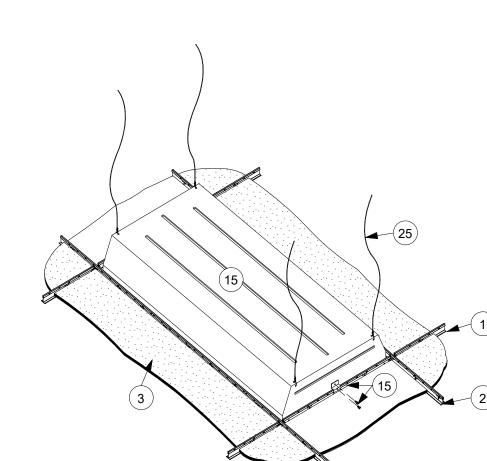

SEISMIC GRID WITH LIGHT

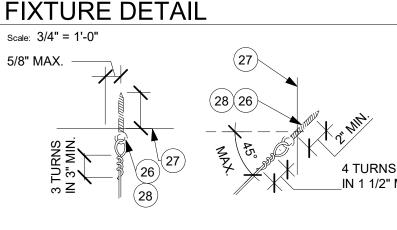

HANGER WIRE ATTACHMENT

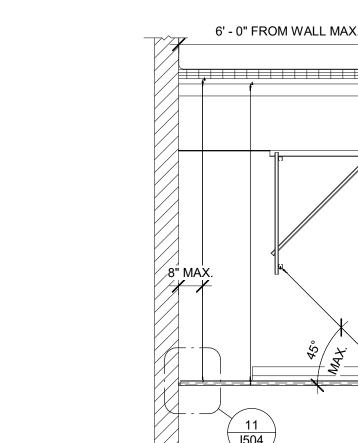

SECTION AT SEISMIC 2x4 CEILING GRID - CBC

1504

2" MAX

12' - 0" O.C. TYP. BOTH DIRECTIONS


4' - 0" O.C. TYP.

BOTH DIRECTIONS

1504

1504


2" MAX.

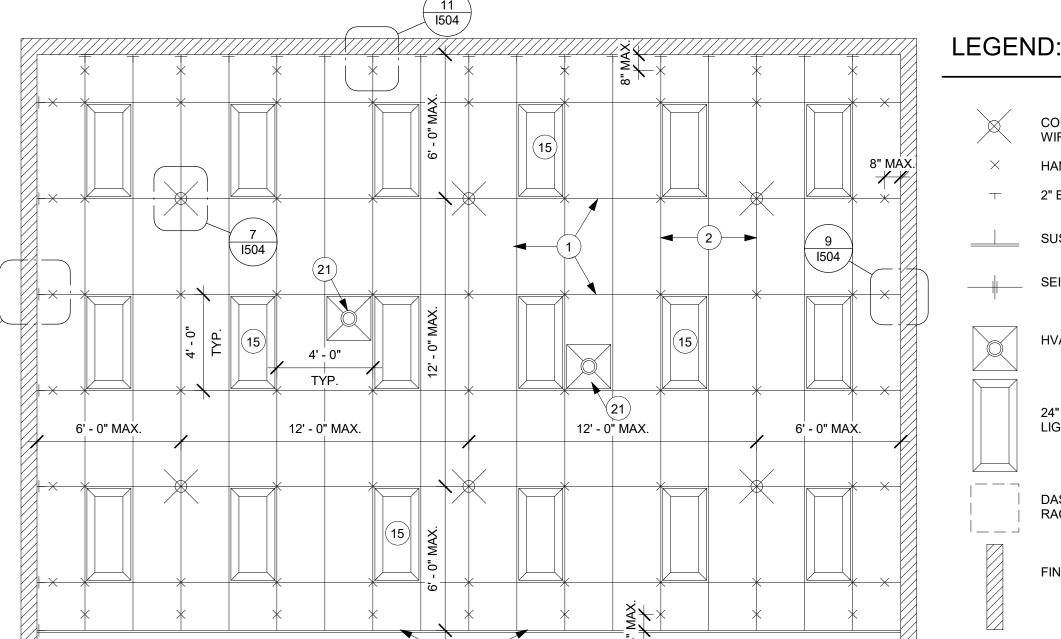


PLAN DETAILS SHOWN TO INDICATE SEISMIC REQUIREMENT COMPLIANCE METHODS ONLY. IT REMAINS THE RESPONSIBILITY OF THE INSTALLING CONTRACTOR TO INSTALL THE COMPLETE SYSTEM IN ACCORDANCE WITH THE SPECIFICATIONS.

6' - 0" MAX. FROM


EDGE OF GRID TRIM

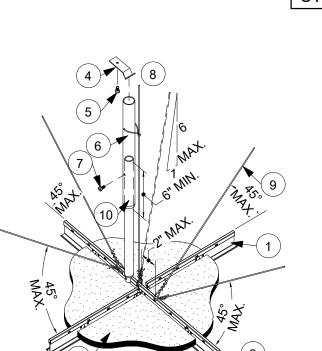

EMT COMMPRESSION STRUT DETAIL

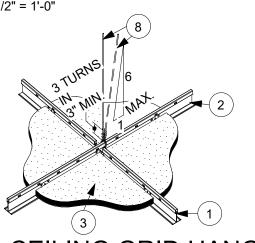

CEILING GRID HANGER WIRE CONNECTION 3

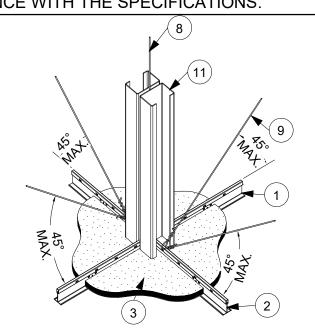

COMPRESSION STRUT AN SPLAY

HANGER AND PERIMETER WIRES

SEISMIC SLIP JOINT

LIGHT FIXTURE

RACEWAY BELOW

FINISHED INTERIOR WALL

HVAC- 24" x 24" AIR DIFFUSER


24" x 48" RECESSED FLUORESCENT

DASHED LINE - FLOOR LINE OF

2" BEAM END RETAINING CLIP (BERC-2"

SUSPENSION GRID EDGING AND TRIM

MTL.STUD COMPRESSION STRUT DETAIL

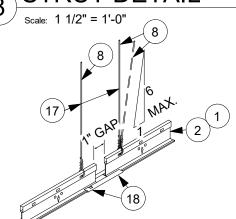

CEILING GRID EXPANSION JOINT DETAIL

SEISMIC CEILING GENERAL NOTES: ICC ESR - 1308

1. REFERENCED SOURCES ARE: INTERNATIONAL BUILDING CODE, AMERICAN SOCIETY OF TESTING MATERIALS (ASTM C 635, ASTM C 636), AMERICAN SOCIETY OF CIVIL ENGINEERS (ASCE 7-08), & CEILING AND INTERIOR SYSTEMS CONSTRUCTION ASSOCIATION (CISCA).

2. PROVIDE SUSPENDED CEILING GRID SYSTEMS FROM A SINGLE SOURCE (MANUFACTURER), DO NOT MIX GRID SYSTEMS.

3. PARTITIONS THAT ARE TIED TO THE CEILING AND ALL PARTITIONS GREATER THAT 6'-0" IN HEIGHT SHALL BE LATERALLY BRACED TO THE STRUCTURE. WALL BRACING SHALL BE INDEPENDENT OF THE CEILING SPLAY BRACING SYSTEM.

4. GENERALLY, SUSPENDED CEILING AREAS UNDER 1,000 SQUARE FOOT DO NOT REQUIRE HORIZONTAL RESTRAINT WIRE AND/OR RIGID BRACING. CONSULT RULING AUTHORITIES AND LOCAL CODES FOR MINIMUM CEILING AREA REQUIREMENTS.

5. PROVIDE SUSPENDED CEILINGS EXCEEDING 2,500 SQUARE FEET IN AREA WITH "SEISMIC SEPARATION JOINTS" TO BREAK THE CEILING INTO INDEPENDENT UNITS LESS THAN 2,500 SQUARE FEET IN AREA THAT WILL ACT FAVORABLY IN A SEISMIC EVENT, RE: 1/I504.

PROJECT MANUAL "SECTION 095113 - ACOUSTICAL PANEL CEILINGS" FOR SPECIFICATIONS.

6. ALL MAIN BEAMS (MAIN TEE RUNNERS) SHALL BE HEAVY-DUTY OR APPROVED EQUAL. INSTALL AT MAXIMUM OF 4'-0" APART, RE:

7. ALL CROSS BEAMS (CROSS TEES) SHALL BE HEAVY-DUTY OR APPROVED EQUAL AND SHALL BE CAPABLE OF CARRYING THE DESIGN LOAD WITHOUT EXCEEDING DEFLECTION EQUAL TO 1/360 OF ITS SPAN, RE: PROJECT MANUAL "SECTION 095113 - ACOUSTICAL PANEL CEILINGS" FOR SPECIFICATIONS.

8. CHANGES IN CEILING PLANES REQUIRE POSITIVE BRACING AT TRANSITION.

9. ALL SEISMIC HANGER AND SPLAY WIRE SHALL BE 10 GAUGE GALVANIZED SOFT ANNEALED MILD STEEL OR CODE APPROVED EQUAL ALL VERTICAL PERIMETER AND INTERMEDIATE HANGER WIRE SHALL BE 12 GAUGE GALVANIZED SOFT ANNEALED MILD STEEL OR CODE APPROVED EQUAL. HANGER AND PERIMETER WIRE SHALL BE INSTALLED VERTICALLY AT NO MORE THAN 10° FROM PLUMB (1 IN 6). ALL VERTICAL HANGER WIRE TIES SHALL BE "TWIST-TIE" IN NATURE WITH (3) TIGHT TURNS AROUND ITSELF IN 3" OF LENGTH. ALL SPLAY WIRE TIES SHALL BE "TWIST-TIE" IN NATURE WITH (4) TIGHT TURNS AROUND ITSELF IN 1-1/2" OF LENGTH, RE: 1/I504.

10. ALL HANGERS AND RUNNERS SHALL BE ACCURATELY LEVELED AND SPACED IN ACCORDANCE WITH MANUFACTURER'S RECOMMENDATIONS.

11. PROVIDE LATERAL FORCE BRACING (VERTICAL COMPRESSION STRUTS AND SPLAY WIRES) AT 12'-0" MAXIMUM ON CENTER IN ALL DIRECTIONS AND 6'-0" MAXIMUM FROM FINISHED GRID EDGES AND WALLS, RE: 7& 8/I504. SEE ADJACENT "SEISMIC POST SCHEDULE" FOR COMPRESSION STRUT SIZES.

12. SEISMIC SPLAY WIRES SHALL BE (4) WIRES ATTACHED TO THE MAIN BEAM (RUNNER). WIRES SHALL BE ARRAYED 90° FROM EACH OTHER AND AT AN ANGLE NOT EXCEEDING 45° FROM THE PLANE OF THE CEILING. SPLAY WIRES SHALL BE INSTALLED WITHIN 2" OF THE CONNECTION OF THE VERTICAL STRUT TO SUSPENDED CEILING. SPLAY WIRES SHALL BE ATTACHED TO THE CEILING GRID AND STRUCTURE ABOVE IN SUCH A MANNER AS TO SUPPORT A DESIGN LOAD OF NOT LESS THAN 200 POUNDS OR THE ACTUAL DESIGN LOAD, WITH A SAFETY FACTOR OF 2, WHICHEVER IS GREATER, RE: 7/I504 AND 8/I504.

13. ATTACH HANGER WIRES ALONG MAIN RUNNERS AT 48" O.C. WITH MAIN RUNNERS PARALLEL TO EACH OTHER AT NO MORE THAN 48" APART, CREATING 48" HANGER WIRE ARRAY IN TWO DIRECTIONS.

14. TERMINAL ENDS OF EACH MAIN RUNNER AND CROSS TEE SHALL BE SUPPORTED WITHIN 8" OF EACH WALL OR FINISHED GRID EDGE WITH A PERIMETER WIRE.

15. PROVIDE ARMSTRONG 7/8" X 7/8" WALL ANGLE MOLDING IN CONJUNCTION WITH ARMSTRONG BERC-2 SEISMIC WALL CLIPS TO SUPPORT TERMINAL ENDS OF MAIN TEES AND CROSS TEES AT WALLS. CEILING GRIDS SHALL BE POSITIVELY ATTACHED TO WALL MOLDING WITH COLOR MATCHING POP RIVETS ON ADJACENT WALLS AND FREE TO SLIDE WITH A 3/4" GAP ON THE OPPOSING WALLS. USE "BERC-2 SEISMIC CLIPS BY ARMSTRONG" TO PROVIDE APPROVED SLIP-JOINT. REFER TO ICC EVALUATION SERVICE REPORT: ERS-1308*, SECTION 4.4.3.

16. LIGHT FIXTURES AND MECHANICAL DEVICES SHALL BE POSITIVELY ATTACHED TO THE SUSPENDED CEILING SYSTEM AND CAPABLE OF RESISTING 100% OF THE FIXTURE WEIGHT IN ANY DIRECTION, RE: 5 & 6/I504

17. FOR CEILINGS WITHOUT RIGID BRACING, SPRINKLER HEAD PENETRATIONS SHALL HAVE A (2) INCH OVERSIZED RING, SLEEVE OR ADAPTER THROUGH THE CEILING TILE TO ALLOW FREE MOVEMENT OF AT LEAST (1) INCH IN ALL HORIZONTAL DIRECTIONS

18. NO SUSPENDED CEILING ASSEMBLY WITHIN THE PROPOSED RENOVATION SPACE SHALL INVOLVE A SUSPENSION LENGTH GREATER THAN 66".

SEISMIC CEILING KEY NOTES

1. HEAVY-DUTY T-BAR GRID CROSS TEE. PROVIDE CROSS TEES | 16. PROVIDE BRACING AS NECESSARY TO MAINTAIN HANGER AND AND MAIN TEES WITH THE SAME PROFILES WHERE "OPEN" GRID IS INSTALLED. SEE SPECS.

2. HEAVY-DUTY T-BAR GRID MAIN RUNNER, SEE SPECS.

3. GYPSUM BOARD CEILING.

4. PROVIDE MTL. TOP CLIP TO FASTEN COMPRESSION STRUT POST TO ROOF STRUCTURE PER ICC REPORT 1308.

5.PROVIDE FASTENERS AS APPROVED BY ICC REPORT 1308.

6.PROVIDE SPRING CLIP AROUND VERTICAL HANGER WIRE AS

7. APPLY TENSION TO COMPRESSION STRUT AND SECURE WITH # 10 X 1" SELF-TAPPING STL. SCREW OR CODE-APPROVED EQUAL.

8. INSTALL VERTICAL HANGER WIRE AT INTERSECTION OF MAIN AND CROSS TEE. VERTICAL SHALL BE DEFINED AS ± 10° (1 IN 6) FROM PLUMB, RE: 3/I504.

9. PROVIDE (4) SPLAY WIRES ATTACHED TO MAIN RUNNER NOT MORE THAN 2" FROM THE INTERSECTION OF MAIN RUNNER AND

10. TELESCOPING ELECTRICAL METALLIC TUBING (EMT) AS COMPRESSION STRUT, RE: "SEISMIC POST SCHEDULE" BELOW.

11. BACK-TO-BACK C-STUD AS ALTERNATIVE METHOD FOR COMPRESSION STRUT SYSTEM, RE: "SEISMIC POST SCHEDULE" BELOW. POSITIVELY ATTACH POSTS TO GRID AND STRUCTURE ABOVE WITH APPROVED FASTENERS.

12. PROVIDE VERTICAL "PERIMETER" SUSPENSION WIRE WITHIN 8" OF THE ENDS OF MAIN RUNNERS AND CROSS TEES ALIKE TERMINATE AT WALLS AND FINISH WITH EDGE TRIM.

13. PROVIDE 3/4" GAP BETWEEN WALL ANGLE AND GRID T-BAR END AT WALLS THAT REQUIRE SLIP-JOINT (UNATTACHED) CONDITION. INSTALL 2" BEAM END RETAINING CLIP (BERC-2) TO PROVIDE SLIP CONDITION.

14. ROOF STRUCTURE AND JOISTS FOR REFERENCE ONLY AS TYPE OF CONSTRUCTION MAY VARY. CONNECT TO STRUCTURE ABOVE USING METHODS AS APPROVED BY LOCAL CODES AND

15. ATTACH LIGHT FIXTURES TO SUSPENSION GRID WITH CODE-APPROVED CLIPS AND FASTENERS ON TWO OPPOSITE SIDES OF THE FIXTURE TO THE GRID MAIN RUNNERS. PROVIDE TWO DIAGONALLY OPPOSED HANGER WIRES AT CORNERS OF LIGHT FIXTURE TO THE STRUCTURE ABOVE. WIRES MAY BE SLACK, RE:

SPLAY WIRE ALIGNMENT, RE: 12/I504.

17. CONNECT HANGER WIRES AT NOT MORE THE 3" FROM OPEN ENDS OF T-BAR GRID.

18. PROVIDE 4" T-BAR CAP SLEEVE AS SLIP-JOINT. CRIMP ONE SIDE OF SPLICE CAP TO ALLOW MOVEMENT ON OPPOSITE END ONLY.

19. 7/8" X 7/8" MTL. WALL ANGLE SCREWED TO WALL WITH APPROVED FASTENERS, SEE SPECS.

20. PROVIDE COLOR MATCHING POP RIVETS TO FASTEN TERMINAL ENDS OF MAIN RUNNER AND CROSS TEES TO WALL ANGLES

REQUIRING ATTACHMENT AND GRID ENDS TERMINATING IN TRIM 21. ATTACH HVAC - DIFFUSERS TO SUSPENSION GRID WITH CODE-

APPROVED CLIPS AND FASTENERS ON TWO OPPOSITE SIDES OF THE FIXTURE TO THE GRID MAIN RUNNERS. PROVIDE TWO DIAGONALLY OPPOSED HANGER WIRES AT CORNERS OF DIFFUSER TO THE STRUCTURE ABOVE. WIRES MAY BE SLACK.

22. PROVIDE SEISMIC SEPARATION JOINTS AS REQUIRED FOR CEILING AREAS IN EXCESS OF 2,500 SQUARE FEET. "REFLECTED CEILING PLAN" FOR SEPARATION LAYOUTS AND 4/1504.

23. PROVIDE 6" EDGE TRIM AT OUTSIDE EDGE OF CEILING GRID IN GOLF, RE: 2/I504 AND SEE SPECS.

24. INSTALL ARMSTRONG AXIOM T-BAR CONNECTION CLIP AT EACH GRID END. FASTEN CLIP TO GRID ENDS WITH #6 X 7/16" FRAMING SCREWS, RE: 2/I504.

25. SLACK WIRE AT DIAGONALLY OPPOSING CORNERS OF FIXTURES

26. (1)-1/4" DIAMETER CLOSED EYE SCREW WITH 2" MIN. EMBEDMENT.

27. EXISTING ROOF WOOD BEAMS. CONTRACTOR TO VERIFY LOCATION.

28. HANGER AND OR BRACING WIRE ANCHORS TO TEH STRUCTURE SHALL BE INSTALLED IN SUCH A MANNER THAT THE DIRECTION OF THE ANCHOR ALIGNS AS CLOSELY AS POSSIBLE WITH THE DIRECTION OF THE WIRE.

29. PROVIDE COLOR MATCHING 7/8" FLANGE X 1 3/4" HIGH X 9/16" FLANGE "C" CHANNEL TO TRIM OUTSIDE EDGE OF GRID, SEE SPECS. PROVIDE COLOR MATCHING POP RIVETS TO FASTEN MAIN RUNNER AND CROSS TEES TO CHANNEL.



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BOTH PARTIES.



520 SOUTH MAIN ST. SUITE 2531 AKRON, OH 44311 P: 330-572-2100 F: 330-572-2101

GPD PROJECT NO:

PROJECT 2778 CAMI

STORE #: PROJECT #: ISSUE DATE:

DESIGN MANAGER: ASHLEY SUEIRAS PRODUCTION DESIGNER: GPD GROUP CHECKED BY:

GPD GROUP

Revision Schedule Description

59763

85334-001

For Construction

DESIGN DETAILS

SCALE: AS SHOWN

SHEET NUMBER:

1504

Scale: 3" = 1'-0"

SECTION AT CEILING GRID END TRIM

6 DETAIL

Scale: 3/4" = 1'-0"

Scale: 1 1/2" = 1'-0"

TYPICAL CEILING GRID LAYOUT

SEISMIC GRID WITH AIR DIFFUSER

Scale: 1 1/2" = 1'-0"

Scale: 1 1/2" = 1'-0"

DESIGN ID	COUNT	DESCRIPTION	FURN. BY	INST. BY	COMMENTS
COOLING	000.11	DEGGIAI HON	TOTAL BY	iito:: D1	
10267	6	FRIDGE UNDERCOUNTER 1 DOOR - 27IN 685MM	SB	GC	
10970	1	FRIDGE REACH IN 1 DOOR LH - 29IN 735MM	SB	GC	
11083	2	FRIDGE REACH IN 2 DOOR - 51X35IN 1295X890MM	SB	GC	
12618	2	FRIDGE UNDERCOUNTER 1 DOOR WITH SHELF -	SB	GC	
		27IN 685MM			
13682	2	FREEZER REACH IN 2 DOOR - 54IN 1370MM	SB	GC	
20010	1	FRIDGE NITRO 2 TAP JT NITCOM LH	SB	GC	KIT INCLUDES UNDERCOUNTER FRIDGE, FONT, TRAY, AND TUBING
 EQUIPMENT	-				FRIDGE, FONT, TRAT, AND TOBING
10312	4	BREWER SOFT HEAT WARMING STAND SINGLE	SB	GC	
10746	1	BREWER DUAL SOFT HEAT	SB	GC	
10808	<u>·</u> 1	GRINDER DITTING KR1203	SB	GC	
10856	6	BREWER SERVER SOFT HEAT	SB	GC	
12508	2	BLENDER QUIET MODEL ON COUNTER	SB	GC	
15186	1	DISHWASHER HOT LOW STEAM	SB	GC	
17564	1	BLENDER PITCHER RINSER WITH SENSOR	SB	GC	
19559	1	NITROGEN GENERATOR ELEMENT	SB	GC	
19742	2	ESPRESSO MACHINE MASTRENA II	SB	GC	
20032	2	OVEN EIKON E2S - BLACK	SB	GC	
FOOD CASE					
16238	1	FOOD CASE - ZEPHYR - 66IN 1675MM	SB	GC	
ICE					
10344	1	ICE - BIN DROP IN 90LB 40KG	SB	GC	
18029	1	ICE - BIN B110	SB	GC	
18846	1	ICE - MACHINE CIM1446HR SERIES REMOTE	SB	GC	
40070	2	COOLED	CD.	00	
19278	2	ICE - BIN DROP IN 45LB 20KG HORIZONTAL	SB	GC	
OTHER 10091	1	CUP DISPENSER TALL HOT VERTICAL	SB	GC	
10091	2	RESTROOM TOILET PAPER HOLDER	SB	GC	
10172	2	RESTROOM SEAT COVER DISPENSER	SB	GC	
10172	2	HAND DRYER SURFACE MOUNTED	SB	GC	
10384	2	DIAPER CHANGING STATION HORIZONTAL	SB	GC	
10396		CUP DISPENSER SHORT HOT VERTICAL	SB	GC	
10467	<u>·</u> 1	FILE CABINET 2 DRAWER	SB	GC	
10501	1	FIRE EXTINGUISHER	GC	GC	
10641	2	RESTROOM TRASH SANITARY NAPKIN WALL MOUNTED	GC	GC	
10769	2	RESTROOM GRAB BAR VERTICAL - 18IN 455MM	SB	GC	
10791	2	CUP DISPENSER GRANDE VENTI COLD VERTICAL	SB	GC	
10829	3	CORNER GUARD - 1.25IN 30MM - PEWTER	SB	GC	
10855	2	CUP DISPENSER GRANDE VENTI HOT VERTICAL	SB	GC	
10858	1	CUP DISPENSER TALL COLD VERTICAL	SB	GC	
10859	2	RESTROOM GRAB BAR - 48IN 1220MM	SB	GC	
10862	2	RESTROOM GRAB BAR - 36IN 915MM	SB	GC	
10947	1	SOAP DISPENSER WALL MOUNTED	SB	GC	
10977	1	PAPER TOWEL DISPENSER FULL SIZE -	SB	GC	
10992	1	TRANSLUCENT GRAY PAPER TOWEL DISPENSER HALF SIZE -	SB	GC	
10992	ı	TRANSLUCENT GRAY	36	GC	
11115	3	SOAP DISPENSER SINK MOUNTED	SB	GC	
13330	1	MOBILE CUP DISPENSER CADDY	SB	GC	
13584	1	CUP DISPENSER TRENTA COLD VERTICAL	SB	GC	
19495	1	NITRO 2 TAP HANDLE AND BADGE KIT	SB	GC	
20079	1	NITRO 2 TAP BADGE MOUNT BACKBAR LH	SB	GC	
20080	1	NITRO 2 TAP BADGE MOUNT BACKBAR RH	SB	GC	
21988	2	HAND DRYER BACK PANEL	SB	GC	
STORAGE					
10222	2	WIRE SHELF GRID AT SINK	SB	GC	
10416	9	WORKROOM SHELVING - 36IN 915MM	SB	GC	
10462	9	WORKROOM SHELVING POSTS	SB	GC	
10698	1	MOP RACK WITH 3 HOLDERS	SB	GC	
15699	1	PARTNER WORK CENTER	SB	GC	
17255	1	PASTRY TRAY CART - 60IN 1525MM	SB	GC	
17064	4	PASTRY TRAY CART - 60IN 1525MM	CD.	CC	
17264	1	ROLLING PASTRY TRAY THAW RACK - 20X26IN 510X660MM	SB	GC	
			1	1	Í
17639	1	WORKROOM CART - 24IN 610MM	SB	GC	

DESIGN ID	SIGN ID COUNT DESCRIPTION		FURN. BY	INST. BY	COMMENTS
AUDIO VISU	AL			'	
10005	1	MUSIC SYSTEM	SB	GC	
10010	1	DT ORDER MONITOR	SB	SB	
10012	1	DT COMMUNICATION SYSTEM	SB	SB	
10013	5	DT QUEUE CAMERA	SB	SB	
10015	3	SPEAKER RECESSED - WHITE	SB	GC	
10017	2	SPEAKER SURFACE MOUNTED	SB	GC	
12336	1	DT TIMER SYSTEM	SB	SB	
14676	1	DT POS MONITOR ARM DOUBLE SURFACE MOUNTED	SB	SB	
19339	1	AMPLIFIER - 40W	SB	GC	
DATA			<u>'</u>		
10002	1	COMPUTER MANAGER WORKSTATION	SB	SB	
10007	1	PRINTER MANAGER WORKSTATION	SB	SB	
20294	4	IOT MODULE	SB	SB	
POINT OF S	ALE		<u>'</u>	'	
10008	2	POS - REGISTER WITH COMPACT CASH DRAWER	SB	SB	
10014	4	POS PRINTER	SB	SB	
10022	1	MONEY COUNTER	SB	SB	
10029	6	POS BANK	SB	GC	
10075	4	CUP LABELER	SB	SB	
14677	1	POS - DT TENDERING REGISTER	SB	SB	PART OF RETAIL IT EQUIPMENT PACKAGE
14678	1	POS - DT EXPEDITOR	SB	SB	PART OF RETAIL IT EQUIPMENT PACKAGE
SECURITY		•	1	1	
10024	1	SAFE LH - 20X18X26IN 510X455X660MM	SB	SB	
10028	1	SAFE BASE	SB	SB	

CASEWORK FINISH SCHEDULE						
ENGINE ZONE	MATERIAL DESCRIPTION	FINISH CODE	COMMENTS			
COMPOSITE - BRUSHED DARK	GREY					
COUNTERTOPS - BACKBAR	COMPOSITE - BRUSHED DARK GREY	CP0057				
COMPOSITE - WHITE WITH VEI		CF 0037				
COMPOSITE - WHITE WITH VEI	COMPOSITE - WHITE WITH VEINING	CP0002				
COUNTERTOPS - ESPRESSO	COMPOSITE - WHITE WITH VEINING	CP0002				
COUNTERTOPS - ESPRESSO	COMPOSITE - WHITE WITH VEINING	CP0002				
COUNTERTOPS - SHROUD	COMPOSITE - WHITE WITH VEINING	CP0002				
GLASS - CLEAR	COMPOSITE - WHITE WITH VEHINING	CF 0002				
GLAGG - GLLAIN	GLASS - CLEAR					
METAL - ALUMINUM - BRUSHEI						
METAL - ALOMINOM - BROSHE	METAL - ALUMINUM - BRUSHED	SF-1				
METAL - FLAT BLACK POWDER		31 - 1				
WETAL - FLAT BLACK FOWDER	METAL - FLAT BLACK POWDERCOAT	MTL-6				
CABINETS - DOOR PULL	METAL - FLAT BLACK POWDERCOAT	MTL-6				
	METAL - FLAT BLACK POWDERCOAT	MTL-6				
ICE BIN	WETAL - FLAT BLACK POWDERCOAT	IVII L-O				
COUNTERTOPS - SHROUD (POS)	METAL - FLAT BLACK POWDERCOAT	MTL-6				
METAL - HOT ROLLED STEEL						
	METAL - HOT ROLLED STEEL	MT0011				
METAL - STAINLESS STEEL - B	RUSHED					
	METAL - STAINLESS STEEL - BRUSHED	#4 BRUSHED 16GA				
CABINETS - CABINET LEG	METAL - STAINLESS STEEL - BRUSHED	#4 BRUSHED 16GA				
CABINETS - UNDERCOUNTER ICE BIN	METAL - STAINLESS STEEL - BRUSHED	#4 BRUSHED 16GA				
COUNTERTOPS - HAND SINK	METAL - STAINLESS STEEL - BRUSHED	#4 BRUSHED 16GA				
PLAM - MOTTLED BLACK						
	PLAM - MOTTLED BLACK	PL0019				
CABINETS - DT POS CUBBY	PLAM - MOTTLED BLACK	PL0019				
	PLAM - MOTTLED BLACK	PL0019				
PLASTIC - BLUE	, a.m. ma.reaa aaran					
	PLASTIC - BLUE					
PLASTIC - BRIGHT GREEN						
	PLASTIC - BRIGHT GREEN					
PLASTIC - GREY	,					
	PLASTIC - GREY					
PLASTIC - WHITE - TRANSPARI						
	PLASTIC - WHITE - TRANSPARENT					
WOOD - BLACK	1					
	WOOD - BLACK	WD0035				
WOOD - BLACK - ROUNDED SL						
FINISH PANELS - FRONTBAR	WOOD - BLACK - ROUNDED SLAT - VERTICAL	WD0035 MAD200-V				
WOOD - WHITE OAK						
	WOOD - WHITE OAK	WD0073				
WALL CLADDING	WOOD - WHITE OAK	WD0073				
WOOD - WHITE OAK - PLANK -						
TOOL WHILE ON WELL HAND	WOOD - WHITE OAK - PLANK - HORIZONTAL	WD0073 MAD100-H				
WOOD - WHITE OAK - PLANK -		11 DOO! O WII ND 100-11				
TOOL WITH ONE I LAWY	WOOD - WHITE OAK - PLANK - VERTICAL	MAD100-V WD0073				
	WITTE ON TENNIN- VERTIONE	15 155 V VV D5015				

DESIGN ID	COUNT	DESCRIPTION	FURN. BY	INST. BY	COMMENTS
BANQUETTE				1	
X0001	6	BANQUETTE - ORION - WHITE OAK AND DEEP GREEN NATURAL WD0073 F0230	SB	GC	
CHAIR			•		
17417	1	CHAIR - CAFE BENT PLY PADDLE BACK - DARK WARM BROWN WD0001	SB	GC	
17852	16	CHAIR - CAFE ANGLED BACK WITH WOVEN SEAT - BLACK AND BROWN ROPE MT0028 F0194	SB	GC	
20087	6	CHAIR - LOUNGE PYRAMID - BLACK AND BROWN ROPE MT0028 F0194	SB	GC	
20282	8	CHAIR - LOUNGE HENRY - CARAMEL BROWN NATURAL F0008	SB	GC	
21358	8	CHAIR - CAFE PEGGY - BLACK WD0035	SB	GC	
21461	4	CHAIR - CAFE ASHER UPHOLSTERED - WHITE OAK AND CHARCOAL GREY NATURAL WD0073 F0188	SB	GC	
DESK					
10123	1	DESK - MANAGERS WORKSTATION - 60X30X30IN 1525X760X760MM	SB	GC	
10605	1	DESK - MANAGERS WORKSTATION KEYBOARD TRAY	SB	GC	
16505	1	DESK - MANAGERS WORKSTATION SHELVES - 36IN 915MM	SB	GC	
MIRROR			•		
14350	2	MIRROR - RESTROOM ANGLED- 18X36IN 455X915MM	SB	GC	
OTHER				-	
10756	2	COAT HOOK 1 PRONG SQUARE - 2IN 50MM - SST	SB	GC	
10820	1	COAT HOOK STRIP - 46IN 1170MM	SB	GC	
TABLE					
17340	6	TABLE - CAFE METAL PEDESTAL BASE SQUARE - 24IN 610MM - BLACK MT0028	SB	GC	
17341	2	TABLE - ACCESSIBLE METAL WITH TAPERED LEGS - 36X24IN 915X610MM - BLACK MT0028	SB	GC	
17644	10	TABLE - TOP ROUND - 24IN 610MM - WHITE OAK WD0073	SB	GC	
18468	4	TABLE - BASE CAFE T LEG - HOT ROLLED STEEL MT0011	SB	GC	
18696	3	TABLE - OCCASIONAL COCKTAIL CAMERON - GREEN GREY MT0041			
19719	4	TABLE - BASE OCCASIONAL COCKTAIL ESSENTIAL - FLAT BLACK MT0028	SB	GC	
21477	1	TABLE - BASE COMMUNITY CAFE HEIGHT POST LEG 102IN 2590MM - FLAT BLACK MT0028	SB	GC	
21800	2	TABLE - TOP ACCESSIBLE ROUND EDGE OBLONG - 48X24IN 1220X610MM - WHITE OAK WD0073	SB	GC	
21809	1	TABLE - TOP COMMUNITY ACCESSIBLE ROUND EDGE OBLONG - 138IN 3505MM - WHITE OAK WD0073	SB	GC	
WINDOW TR	REATMENT				
10620	14	ROLLER SHADE - CHOCOLATE TRANSLUCENT F0048 - 14PC OPEN	SB	GC	

DESIGN ID	COUNT	DESCRIPTION	FURN. BY		COMMENTS
X8001	2	CUSTOM SCREEN	SB	GC	FINISHES : MT0028 - FRAME. WD0073 - 1X4 SLATS
X8002	1	WOOD CLADDING AT CAFE	SB	GC	MAD100 WD0073 (FULL HEIGHT PLANKS)
X8003 X8004	1	WOOD CLADDING AT REVESTIBILIE	SB SB	GC GC	MAD100 WD0073 (FULL HEIGHT PLANKS) MAD100 WD0073 (FULL HEIGHT PLANKS)
X8004 X8005	2	WOOD CLADDING AT RR VESTIBULE FULL HEIGHT L-BRACKET TRIM TO TERMINATE	SB	GC	MT0028
		WOOD			
X8006	1	WOOD SLATS SYSTEM AROUND THE MERCH WALL	SB	GC	WOOD SLATS FINISH: WD0073. BACK PANEL FINISH: WD035 VENEER
X8007	1	WOOD SLATS SYSTEM AROUND BACKBAR WALL	SB	GC	WOOD SLATS FINISH: WD0073.
X8008	1	CUSTOM COUNTERTOP	SB	GC	CP0002
ABINET				1	
17573	1	CABINET - BACKBAR COUNTER SUPPORT PANEL - 3IN 75MM	SB	GC	
17574	2	CABINET - BACKBAR SINK OR ICE - 15IN 380MM	SB	GC	
17575	1	CABINET - BACKBAR SINK OR ICE - 20IN 510MM	SB	GC	
17580	2	CABINET - CBE TEA SHELF - 29IN 735MM - FLAT BLACK MT0028	SB	GC	
17581	1	CABINET - CBE DRY INCLUSION SHELF - 23IN	SB	GC	
		585MM - FLAT BLACK MT0028			
17740	5	CABINET - BACKBAR - 30IN 760MM	SB	GC	
17741 17743	8 1	CABINET - BACKBAR 15IN 380MM CABINET - DT POS - 30IN 760MM	SB SB	GC GC	
17744	1	CABINET - FRONTBAR POS BRIDGE - 22IN 560MM	SB	GC	
17745	2	CABINET - BACKBAR DRAWER - 15IN 380MM	SB	GC	
17747	5	CABINET - BACKBAR TRASH - 15IN 380MM	SB	GC	
17896	1	CABINET - BACKBAR CUBBY - 15IN 380MM	SB	GC	
18122 19281	2	CABINET - BACKBAR SINK OR ICE - 16IN 405MM CABINET - ESPRESSO ICE BIN STAINLESS - 20IN	SB SB	GC GC	
13201	2	510MM	OB		
21190	1	CABINET - FRONTBAR TRASH - 15IN 380MM	SB	GC	
21191	1	CABINET - FRONTBAR DRAWER - 15IN 380MM	SB	GC	
21192 21193	2 1	CABINET - FRONTBAR POS - 30IN 760MM CABINET - ESPRESSO CUBBY WITH OPEN BACK -	SB SB	GC GC	
_ 1130		18IN 455MM			
X17742	1	CABINET - DT POS UPPER CUBBY - 32IN 815MM	SB	GC	
AFE		CONDINENT OART TURE BROS	CD	00	
20131	1	CONDIMENT CART THREE DROP - WHITE OAK AND WHITE WD0073 CP0002	SB	GC	
20372	1	WALL BAY ON STANDARD 1 UNIT - 36IN 915MM -	SB	GC	
20275	•	WHITE OAK WD0073	0.0	00	
20373	1	WALL BAY ON STANDARD 2 UNIT - LH - 54IN 1370MM - WHITE OAK WD0073	SB	GC	
OUNTERTO	DP	TOTOMINI TITLE OF IK TYPOOTO			
17807	1	COUNTERTOP - BACKBAR - 15IN 380MM	SB	GC	
17809	1	COUNTERTOP - HAND SINK WITH LOW SPLASH	SB	GC	
17824	1	STAINLESS - 15IN 380MM COUNTERTOP - DT POS - LF - VARIABLE LENGTH	SB	GC	
19712	1	COUNTERTOP - WARMING - LF - 90IN 2285MM	SB	GC	
20061	1	COUNTERTOP - ESPRESSO METRO - RF - 139IN	SB	GC	
2222		3530MM	0.0		
20063 21762	<u>1</u> 1	COUNTERTOP - FRONTBAR CAP - 139IN 3530MM COUNTERTOP - CBE WITH RINSE SINK - RF -	SB SB	GC GC	W/ 10" BACKSPLASH
21702	'	127IN 3225MM	OD	00	W 10 BACKOT LAGIT
X17821	2	CUSTOM COUNTERTOP - FRONTBAR - 15IN	SB	GC	W/ FRONT TRAY
V17001	1	380MM	CD	CC	WALLER EDON'T MOSING
X17821 X17828	<u>1</u> 1	CUSTOM COUNTERTOP - FRONTBAR - 36IN COUNTERTOP - BACKSPLASH - VARIABLE	SB SB	GC GC	W/ 6" FRONT NOSING W/ 10" BACKSPLASH
X17020	'	LENGTH	OB		W 10 BACKOT EACH
X17830	1	CUSTOM COUNTERTOP - POS - 82IN 2085MM	SB	GC	W/ FRONT TRAY
X18722	1	CUSTOM COUNTERTOP - BREW WITH TRASH DROP - LF - 105IN 2665MM	SB	GC	W/ 10" BACKSPLASH
X18877	1	CUSTOM COUNTERTOP - HANDOFF CORNER	SB	GC	W/6" FRONT NOSING
		ROUNDED			
X19565	1	CUSTOM COUNTERTOP - FRONTBAR - 45IN	SB	GC	W/6" FRONT NOSING
X20050	1	CUSTOM COUNTERTOP - BACKBAR NITRO - LH -	SB	GC	W/ NO BACKSPLASH
712000		30IN 760MM			
X20271	1	CUSTOM COUNTERTOP - FRONTBAR MOP	SB	GC	W/ 6" FRONT NOSING
 EWALL		PLANAR - 60IN 1525MM			
17831	1	DIEWALL - POS - 82IN 2085MM	SB	GC	
18859	1	DIEWALL - 45IN 1145MM	SB	GC	
18865	1	DIEWALL - 60IN 1525MM	SB	GC	
X17822	2	CUSTOM DIEWALL - 18IN	SB	GC	
X17822 X18878	<u>1</u> 1	CUSTOM DIEWALL - 36IN CUSTOM DIEWALL - CORNER ROUNDED	SB SB	GC GC	W/6" FRONT NOSING
X20064	1	CUSTOM DIEWALL - CORNER ROUNDED CUSTOM DIEWALL - ESPRESSO - 139IN 3530MM	SB	GC	W/ EXTENDED DEPTH 8"
IT KIT	<u> </u>				· · · · · · · · · · · · · · · · · · ·
17894	3	FIT KIT - CABINET FILLER PANEL	SB	GC	
X17895	3	CUSTOM FIT KIT - BACKBAR COUNTERTOP	SB	GC	W/ 10" BACKSPLASH
THER 11155	2	ESPRESSO MACHINE PUMP MOUNT - 10X10IN	SB	GC	
11100	۷	255X255MM	00		
17829	1	FRENCH CLEAT - VARIABLE LENGTH	SB	GC	LENGTH: 2'-8"
18145	4	COUNTERTOP SUPPORT LEG	SB	GC	
20067 20633	1	SNEEZE GUARD - 139IN 3530MM COUNTERTOP SUPPORT LEG SLIM	SB SB	GC GC	
X20066	<u>2</u> 1	SHROUD - 139IN 3530MM	SB	GC	4IN SHROUD
X20067	1	POS SHROUD - METAL	SB	GC	5555
X90002	1	POS LONG IMPULSE TRAY	SB	GC	CUSTOM WD0073 LONG TRAY FOR SMALLER BOXE
V00000	2	DOC IMPLIESE TRAV	CD	00	ONLY
X90003	6	POS IMPULSE TRAY	SB	GC	CUSTOM WD0073 TRAY W/ METAL MT0028 BOTTOM PANEL AND METAL MT0028 MAGNETIC DIVIDERS.
X94002	1	2" SQUARE MENU BOARD FRAME.	SB	GC	FINISH: WD0073 WITH MITERED CORNERS.
ANEL		100			
17832	1	PANEL - 82IN 2085MM	SB	GC	
18717	1	PANEL - 60IN 1525MM	SB	GC	
18885 20065	<u>1</u> 1	PANEL - END CAP - RF PANEL - 139IN 3530MM	SB SB	GC GC	
X17823	2	CUSTOM PANEL - 18IN	SB	GC	
X17823	1	CUSTOM PANEL - 18IN CUSTOM PANEL - 36IN	SB	GC	
	1	CUSTOM PANEL - CORNER ROUNDED	SB	GC	W/ 6" FRONT NOSING
X18879	1	CUSTOM PANEL - CUSTOMER BAR - LF - 45IN	SB	GC	
		1145MM			
X19566				100	CLOUGH ATC DEFED TO INTEDIOD ELEVATIONS AND
X19566 .ATS	205	1"V 1" CI ATC	CD	11212	
X19566 _ATS	365	1"X 1" SLATS	SB	GC	
X19566 LATS	365	1"X 1" SLATS	SB	GC	DETAILS, GC TO VERIFY PRIOR TO PROCUREMENT AND INSTALLATION, GC TO PROVIDE BLOCKING AS
X19566 LATS X93466					DETAILS, GC TO VERIFY PRIOR TO PROCUREMENT AND INSTALLATION, GC TO PROVIDE BLOCKING AS NECESSARY
X18879 X19566 LATS X93466	365	1"X 1" SLATS 1"X 1" SLATS	SB SB	GC	6'-6" SLATS, REFER TO INTERIOR ELEVATIONS AND DETAILS, GC TO VERIFY PRIOR TO PROCUREMENT AND INSTALLATION, GC TO PROVIDE BLOCKING AS NECESSARY FULL HEIGHT SLATS, REFER TO INTERIOR ELEVATIONS AND DETAILS, GC TO VERIFY PRIOR



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STARBUCKS TEMPLATE VERSION: i2021-01-22



520 SOUTH MAIN ST, SUITE 2531 AKRON, OH 44311 P: 330-572-2100 F: 330-572-2101



59763

STORE #: PROJECT #: ISSUE DATE:

85334-001 For Construction 09/01/21 ASHLEY SUEIRAS

DESIGN MANAGER: PRODUCTION DESIGNER: GPD GROUP CHECKED BY: GPD GROUP

Revision Schedule

Rev	Date	Ву	Description
	•		

CASEWORK AND FF&E SCHEDULES SCALE: AS SHOWN

SHEET NUMBER:

1601

	WALL BASE SCHEDULE - "B"						
DESIGN ID	LENGTH	DESCRIPTION	FURN. BY	INST. BY	COMMENTS		
TILE BASE							
11403	168' - 2"	TILE BASE - BLACK - 6X12IN 150X305MM	SB	GC	GROUT GR0008: MAPEI 10 - BLACK; LATICRETE 45 - RAVEN; PRETOKOLL - P.FLEX PRETO		
19795	379' - 2 1/2"	POLYVINYL FLOOR TILE - ECOGRIP - PEWTER	GC	GC			
X51001	52' - 7 1/2"	SCHLUTER COVE BASE (TILE-TO-TILE)	GC	GC	LOCATED IN RESTROOMS. SATIN NICKEL. GC TO FIELD VERIFY TOTAL LENGTH PRIOR TO ORDERING		

		GRAPHICS AND ARTWORK SCH			
DESIGN ID	COUNT	DESCRIPTION	FURN. BY	INST. BY	COMMENTS
GRAPHICS -	ARTWOR				
16908	1	ART - JENNIFER AMENT - STAR	SB	GC	DESIGNER TO SPECIFY OPTIONS - FORMAT, FINISHES ETC. THIS IMAGE CANNOT BE CROPPED OR RESIZED
X9001	1	ARTWORK - 1	SB	GC	REFER TO INTERIOR ELEVATION. CONFIRM WITH VENDOR.
X9002	1	ARTWORK - 2 S		GC	REFER TO INTERIOR ELEVATION. CONFIRM WITH VENDOR.
X9003	1	ARTWORK - 3	SB	GC	REFER TO INTERIOR ELEVATION. CONFIRM WITH VENDOR.
X9004	1	ARTWORK - 4	SB	GC	REFER TO INTERIOR ELEVATION. CONFIRM WITH VENDOR.
X9005	1	ARTWORK - 5	SB	GC	REFER TO INTERIOR ELEVATION. CONFIRM WITH VENDOR.
X9006	1	ARTWORK - 6	SB	GC	REFER TO INTERIOR ELEVATION. CONFIRM WITH VENDOR.
X9007	1	ARTWORK - 7	SB	GC	REFER TO INTERIOR ELEVATION. CONFIRM WITH VENDOR.
X9008	1	ARTWORK - 8	SB	GC	REFER TO INTERIOR ELEVATION. CONFIRM WITH VENDOR.
X9009	1	1 ARTWORK - 9		GC	REFER TO INTERIOR ELEVATION. CONFIRM WITH VENDOR.
X9010	1	ARTWORK - 10		GC	REFER TO INTERIOR ELEVATION. CONFIRM WITH VENDOR.
X9011	X9011 1 ARTWORK - 11		SB	GC	REFER TO INTERIOR ELEVATION. CONFIRM WITH VENDOR.
X9012	1	ARTWORK - 12	SB	GC	REFER TO INTERIOR ELEVATION. CONFIRM WITH VENDOR.
GRAPHICS -	INTERIOR	MENU	•	•	
18984	7	MENU BOARD - UNIVERSAL WALL MOUNT BRACKET	SB	GC	
19551	6	MENU BOARD - FRONT INSERT PANEL WITH SQUARE FRAME - WHITE OAK WD0073	SB	GC	
19552	1	MENU BOARD - DAILY OFFERING CHALKBOARD WITH SQUARE FRAME - WHITE OAK WD0073	SB	GC	
GRAPHICS -	OTHER				
11135	2	RESTROOM SIGN UNISEX ACCESSIBLE	SB	GC	
12693	1	COMMUNITY BOARD MAGNETIC MED WARM BROWN WD0004 - 46X36IN 1170X915MM	SB	GC	

PAINT SCHEDULE					
DESIGN ID	DESCRIPTION	LRV	FURN. BY	INST. BY	COMMENTS
SW7031	SW7031 MEGA GREIGE, OR EQUIVALENT	37	GC	GC	SW USE PRIMER CP-1; NCS - S 3005-Y50R; AKZO NOBEL - 20YY 37/094

FLOOR TREATMENT SCHEDULE - "T"					
DESIGN ID	AREA	DESCRIPTION	FURN. BY	INST. BY	COMMENTS
CONCRETE					
X17860	1197 SF	CONCRETE STAIN - LIGHT GREY	GC	GC	
PLASTIC			•	•	
19795 1085 SF POLYVINYL FLOOR TILE - ECO-GRIP - PEWTER		GC	GC		
WALK OFF	MAT				
19288	36 SF	WALK OFF MAT - HELIX Z1 - BLACK - 12X9IN 305X230MM	SB	GC	

DESIGN ID	AREA	DESCRIPTION	FURN. BY	INST. BY	COMMENTS
OTHER					
11302	439 SF	VCT - WHITE - 2X4FT 61X122CM	GC	GC	
X11302	664 SF	ACT - CIRRUS SECOND LOOK - 6X48	GC	GC	ARMSTRONG - CIRRUS SECOND LOC SCORED TEGULAR MEDIUM TEXTUR III PANEL- SOCRING CREATES 6"X48" LINEAR PLANKS VINYL DESIGN IDX11302, 6"X48 GRID/ACT FOR CAFE -PAINTED SW70



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STARBUCKS TEMPLATE VERSION: i2021-01-22



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P: 330-572-2100 F: 330-572-2101 PD PROJECT NO: 2020

GPD PROJECT NO:

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No. 52715

No. 52715

AKRON, OH

AKRON, OH

OP/02/2021

BRINKLEY HILL

PROJECT ADDRESS:
2778 NC-24
CAMERON, NC 28

STORE #: PROJECT #: ISSUE DATE:

#: 85334-001

For Construction 09/01/21

NAGER: ASHLEY SUEIRAS

DESIGN MANAGER: ASHLEY SUEIF PRODUCTION DESIGNER: GPD GROUP CHECKED BY: GPD GROUP

Revision Schedule

Rev	Date	Ву	Description

SHEET TITLE:
INTERIOR FINISHES
SCHEDULES
SCALE: AS SHOWN

SHEET NUMBER:

1602

BIM 360://Starkusks 2020 (Dewit 2024)/85334 004 50763 Hww 24 & Brinkley Hill 1

DRAWINGS ARE NOT TO BE SCALED.

FOR DIMENSIONS NOT SHOWN, COORDINATE WITH ARCHITECTURAL DRAWINGS

THE CONTRACTOR SHALL CAREFULLY REVIEW THE DRAWINGS TO IDENTIFY THE SCOPE OF WORK REQUIRED. VISIT THE SITE TO RELATE THE SCOPE OF WORK TO EXISTING CONDITIONS, AND DETERMINE THE EXTENT OF WHICH THOSE CONDITIONS AND PHYSICAL SURROUNDINGS WILL IMPACT THE WORK.

EXISTING CONDITIONS AS SHOWN ON THESE PLANS ARE FOR REFERENCE ONLY. THE CONTRACTOR IS REQUIRED TO FIELD VERIFY ALL EXISTING CONDITIONS PRIOR TO

THE CONTRACTOR SHALL ASSUME THE MOST STRINGENT REQUIREMENTS APPLY IN CASE OF CONFLICT AMONG SPECIFICATIONS, STANDARDS, CODES AND DRAWINGS. THE CONTRACTOR SHALL NOTIFY THE ARCHITECT/ENGINEER IMMEDIATELY TO RESOLVE THE CONFLICT.

ANY DEVIATION, MODIFICATION, OR SUBSTITUTION FROM THE BID SET OF STRUCTURAL DRAWINGS SHALL BE SUBMITTED TO THE ARCHITECT AND ENGINEER FOR REVIEW/APPROVAL PRIOR TO ITS USE OR INCLUSION ON THE SHOP DRAWINGS WITHOUT SUCH PRIOR APPROVAL, DEVIATIONS, MODIFICATIONS, OR SUBSTITUTIONS WILL BE REJECTED. COSTS FOR DEMOLITION AND REWORK OF SUCH ITEMS WILL BE BORNE BY THE CONTRACTOR.

THE STRUCTURE IS DESIGNED TO BE SELF-SUPPORTING AND STABLE AFTER THE BUILDING IS FULLY COMPLETED FOR IN-SERVICE LOADS ONLY. THE MEANS, METHODS, PROCEDURES, AND SEQUENCES OF CONSTRUCTION ARE THE SOLE RESPONSIBILITY OF THE CONTRACTOR. THE CONTRACTOR SHALL PROVIDE AND MAINTAIN ALL NECESSARY TEMPORARY SYSTEMS (SHORING, BRACING, GUYS, FALSEWORK, FORMWORK, SHEETING ETC.) TO ENSURE THE INTEGRITY OF THE STRUCTURE AT ALL STAGES OF CONSTRUCTION. ALL WORK SHALL BE PERFORMED WITHOUT DAMAGE TO ADJACENT EXISTING WORK. SHORING SYSTEMS SHALL BE DESIGNED, SIGNED, AND SEALED BY A PROFESSIONAL ENGINEER LICENSED IN THE JURISDICTION WHERE THE PROJECT IS LOCATED.

THE CONTRACTOR IS RESPONSIBLE FOR SITE SAFETY. THE CONTRACTOR AND ALL SUBCONTRACTORS SHALL REVIEW THE STRUCTURAL CONTRACT DOCUMENTS AND SHALL NOTIFY THE STRUCTURAL ENGINEER OF ANY CONFLICTS BETWEEN THOSE DOCUMENTS AND ANY SAFETY REGULATIONS. SUCH REVIEW AND NOTIFICATION SHALL OCCUR PRIOR TO PRODUCTION OF SHOP DRAWINGS.

THE CONTRACTOR SHALL PROTECT ALL WORK, MATERIALS, AND EQUIPMENT FROM DAMAGE AND SHALL PROVIDE PROPER STORAGE FACILITIES FOR MATERIALS AND **EQUIPMENT DURING CONSTRUCTION.**

SITE VISITS PERFORMED BY THE ARCHITECT/ENGINEER DO NOT INCLUDE INSPECTIONS OF MEANS AND METHODS OF CONSTRUCTION PERFORMED BY THE

STRUCTURAL OBSERVATIONS PERFORMED BY THE ARCHITECT/ENGINEER DURING CONSTRUCTION ARE NOT THE CONTINUOUS AND SPECIAL INSPECTION SERVICES AND DO NOT WAIVE THE RESPONSIBILITY FOR THE INSPECTIONS REQUIRED OF THE BUILDING DEPARTMENT INSPECTOR OR THE TESTING AGENCY. ALSO, OBSERVATIONS DO NOT GUARANTEE THE CONTRACTOR'S PERFORMANCE AND SHALL NOT BE CONSIDERED AS SUPERVISION OF CONSTRUCTION.

THE WEIGHT OF CONSTRUCTION MATERIALS AND EQUIPMENT ON THE STRUCTURE SHALL BE LIMITED TO THE SHELL BUILDING DESIGN LOADING CRITERIA UNLESS APPROVED BY THE SHELL BUILDING ENGINEER OF RECORD. ANY EQUIPMENT OR MATERIALS THAT EXCEED THE DESIGN LOADING WILL NOT BE PERMITTED WITHOUT AN ANALYSIS OF THE STRUCTURE BY A PROFESSIONAL ENGINEER LICENSED IN THE STATE OF THE PROJECT. SUBMIT STAMPED CALCULATIONS TO ENGINEER FOR REVIEW. THE RESPONSIBILITY FOR THE ANALYSIS OF ANY ELEVATED SLABS IS THE SOLE RESPONSIBILITY OF THE CONTRACTOR.

GOVERNING BUILDING CODE: 2018 NORTH CAROLINA STATE BUILDING CODE (BASED ON 2015 INTERNATIONAL BUILDING CODE

FLOOR DEAD LOADS 10 PSF SUPERIMPOSED PLUS ACTUAL MATERIAL WEIGHTS FLOOR LIVE LOADS 100 PSF UNO

LIGHT STORAGE 125 PSF

ROOF DEAD LOAD 10 PSF SUPERIMPOSED PLUS ACTUAL MATERIAL WEIGHTS ROOF LIVE LOAD 20 PSF

10 PSF

ROOF SNOW LOADS: 10 PSF GROUND SNOW LOAD (Pg) EXPOSURE FACTOR, Ce 1.0 IMPORTANCE FACTOR, I: THERMAL FACTOR, Ct: FLAT ROOF SNOW LOAD, Pf: 7 PSF MINIMUM SNOW LOAD:

SNOW DRIFT LOAD: SEE DIAGRAMS BELOW

+16, -46 PSF

+16, -33 PSF

LATERAL LOAD DESIGN DATA: WIND DESIGN DATA (ASCE 7-10): BASIC WIND SPEED 118 MPH RISK CATEGORY EXPOSURE CATEGORY

DESIGN PRESSURES COMPONENTS AND CLADDING (h = 15')

TRIB. AREA ROOF ZONE 1 +16, -51 PSF 0-10 SF +16, -30 PSF >10-20 SF +16, -46PSF +16, -30 PSF >20-50 SF +16, -29 PSF +16, -38 PSF +16, -33 PSF >50-100 SF +16, -28 PSF **ROOF ZONE 3** WALL ZONE 4 WALL ZONE 5 +16, -77 PSF +30. -41 PSF 0-10 SF +30 -33 PSF >10-20 SF +16, -64 PSF +29, -32 PSF +29, -38 PSF +27, -34 PSF

SEE DIAGRAM BELOW FOR ZONE DEFINITIONS (a = 3'-0") + INDICATES PRESSURE ACTING TOWARD AN EXTERIOR SURFACE - INDICATES PRESSURE ACTING AWAY FROM AN EXTERIOR SURFACE

Cs = 0.034

V = 0.037W

+27,- 30 PSF

+26, -28 PSF

+26, -32 PSF

SEISMIC DESIGN DATA (ASCE 7-10):

>20-50 SF


>50-100 SF

RISK CATEGORY SEISMIC IMPORTANCE FACTOR IE = 1.0SITE CLASS 0.21 S1 0.09 SDS 0.22 0.15 SEISMIC DESIGN CATEGORY

BASIC LATERAL FORCE RESISTING SYSTEM: LIGHT-FRAMED WALLS WITH WOOD STRUCTURAL PANELS FOR SHEAR RESISTANCE, BOTH OTHOGONAL DIRECTIONS

RESPONSE MODIFICATION FACTOR R: 6.5 BOTH ORTHOGONAL DIRECTIONS SEISMIC RESPONSE COEFFICIENT SEISMIC BASE SHEAR

NONSTRUCTURAL COMPONENTS: Ip = 1.0, z/h=1, U.N.O. COMPONENT 2.5 ALL COMPONENTS U.N.O. MECH EQUIP. 2.5 0.04

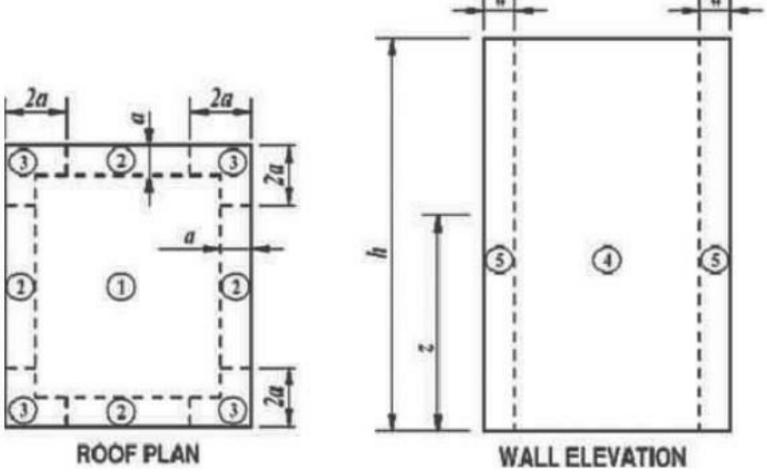

WIND ZONE DIAGRAMS



NOTE: DRIFT LOADS ARE IN ADDITION TO UNIFORM SNOW LOADS

SNOW DRIFT DIAGRAMS

FOUNDATION SYSTEMS:

GENERAL:

PROJECT.

THE CONTRACTOR SHALL STUDY THE GEOTECHNICAL INVESTIGATION REPORT (REFER TO THE "EARTHWORK/SUBSURFACE INVESTIGATION" SECTION UNDER THE GENERAL NOTES") AND VISIT THE SITE PRIOR TO THE START OF ANY WORK. THE CONTRACTOR SHALL VERIFY ANY EXISTING FIELD CONDITION THAT MAY AFFECT THE INSTALLATION OF THE FOUNDATION SYSTEM.

THE CONTRACTOR SHALL EXERCISE GREAT CARE DURING EXCAVATION. UNDERGROUND UTILITY LOCATIONS, IF SHOWN, ARE APPROXIMATE. THE CONTRACTOR SHALL PREDETERMINE UTILITY LOCATIONS AND NOTIFY THE ENGINEER IMMEDIATELY IF DEVIATION FROM PLANS EXIST. THE CONTRACTOR IS RESPONSIBLE FOR THE SAFE SUPPORT OF UTILITIES ACROSS EXCAVATIONS.

SHEETING, SHORING, AND DEWATERING IS THE RESPONSIBILITY OF THE CONTRACTOR.

A SOILS TESTING LABORATORY SHALL BE RETAINED BY THE OWNER TO PROVIDE CONSTRUCTION REVIEW TO ENSURE CONFORMANCE WITH THE CONSTRUCTION DOCUMENTS DURING THE EXCAVATIONS, BACKFILL, AND FOUNDATION PHASES OF THE

CONTINUOUS WATERSTOPS SHALL BE PROVIDED AT ALL HORIZONTAL AND VERTICAL CONSTRUCTION JOINTS IN ALL ELEVATOR PITS AND BASEMENT WALLS.

BOTTOM OF ALL EXTERIOR FOOTINGS/GRADE BEAMS SHALL BEAR A MINIMUM OF 1'-6" BELOW ADJACENT FINAL GRADE FOR FROST PROTECTION.

SPREAD/TRENCH FOOTINGS

BEARING ELEVATIONS ARE ESTIMATED FROM SOIL BORING DATA INDICATED IN THE GEOTECHNICAL SUBSURFACE INVESTIGATION REPORT. DETERMINATION OF FINAL BEARING ELEVATIONS, TOPSOIL AND EXCAVATION STRIPPING DEPTH, INSPECTION OF ALL SUBSOIL EXPOSED DURING STRIPPING, SITE GRADING, EXCAVATION OPERATIONS, APPROVAL OF FILL MATERIALS, DENSITY TESTING OF FILLS TO ENSURE PLACEMENT PER SPECIFICATION REQUIREMENTS, INSPECT FOUNDATION BEARING SURFACES, AND VERIFY ALLOWABLE BEARING PRESSURES ARE THE TESTING LABORATORY'S

ALL FOUNDATIONS ARE TO REST ON FIRM UNDISTURBED SOIL OR COMPACTED FILL FREE FROM ORGANIC MATTER. IF POOR SOIL CONDITIONS ARE ENCOUNTERED AT FOUNDATION DEPTHS SHOWN, NOTIFY OWNER'S REPRESENTATIVE BEFORE PROCEEDING WITH CONSTRUCTION.

FOUNDATIONS HAVE BEEN DESIGNED BASED ON AN ALLOWABLE SOIL BEARING CAPACITY OF 2500 PSF.

NEW FOOTINGS PLACED ADJACENT TO EXISTING FOOTINGS SHALL BEAR AT THE SAME ELEVATION, UNLESS NOTED OTHERWISE.

STEP FOOTINGS AT A RATIO OF ONE (1) VERTICAL TO TWO (2) HORIZONTAL WITH A MAXIMUM VERTICAL STEP OF 2'-0" UNLESS NOTED OTHERWISE.

INUNDATION AND LONG TERM EXPOSURE OF BEARING SURFACES, WHICH WILL RESULT IN DETERIORATION OF BEARING FORMATIONS, SHALL BE PREVENTED. FOOTINGS SHALL BE PLACED IMMEDIATELY FOLLOWING FOOTING EXCAVATIONS AND BEARING SURFACE INSPECTION.

UTILITY LINES SHALL NOT BE PLACED THROUGH OR BELOW FOUNDATIONS WITHOUT THE APPROVAL OF THE ENGINEER OF RECORD.

EARTHWORK/SUBSURFACE INVESTIGATION:

THE CONTRACTOR SHALL REFER TO THE THE GEOTECHNICAL SUBSURFACE INVESTIGATION REPORT AND SPECIFICATIONS FOR ALL REQUIREMENTS RELATED TO EXCAVATION, PREPARATION OF THE SUBGRADE, COMPACTION PROCEDURES, AND FOR ANY OTHER GEOTECHNICAL REQUIREMENTS. WHERE CONFLICTING REQUIREMENTS BETWEEN THE DRAWINGS AND GEOTECHNICAL SUBSURFACE INVESTIGATION REPORT ARE PRESENT. THE MOST STRINGENT REQUIREMENT SHALL BE BID UNLESS OTHERWISE ADDRESSED BY THE ENGINEER OF RECORD IN A FORMAL REQUEST FOR INFORMATION.

THE RECOMMENDATIONS PRESENTED HEREIN ARE IN ACCORDANCE WITH THE SUBSURFACE INVESTIGATION REPORT PREPARED BY:

ECS SOUTHEAST, LLP, DATED FEBRUARY 5, 2021

PROOFROLLING:

PRIOR TO EXCAVATION FOR STRUCTURES, PROOFROLL BUILDING AND PAVEMENT AREAS USING A HEAVILY LOADED DUMP TRUCK OR SIMILARLY HEAVILY LOADED VEHICLE. ALL SOFT, LOOSE OR UNSTABLE AREAS ARE TO BE STABILIZED WITH ADDITIONAL COMPACTION OR UNDERCUT AND REPLACED WITH ENGINEERED FILL

ENGINEERED FILL:

ENGINEERED FILL SHALL BE WELL-GRADED MATERIAL FREE FROM DEBRIS, ORGANIC MATERIAL, FROZEN MATERIALS, BRICK, LIME, CONCRETE AND OTHER MATERIALS THAT WOULD PREVENT ADEQUATE PERFORMANCE. FILL SHALL CONFORM TO ASTM D2487 SOIL CLASSIFICATION GROUPS GW, GP, GM, SW, SP OR SM.

UNLESS OTHERWISE NOTED, THE PROPOSED ENGINEERED FILL MATERIALS ARE TO BE PLACED IN LIFTS NOT EXCEEDING EIGHT (8) INCHES IN LOOSE MEASURED THICKNESS. EACH LIFT IS TO BE COMPACTED A MINIMUM OF 98% MAXIMUM DENSITY BY ASTM D698.

THE EARTHWORK PROGRAM SHALL BE CONDUCTED UNDER THE SUPERVISION OF A SOILS LABORATORY.

THE IN-PLACE DENSITIES ACHIEVED ARE TO BE VERIFIED BY TEST.

BACKFILL

BACKFILL OPERATIONS SHALL BE PERFORMED IN ACCORDANCE WITH THE SPECIFICATIONS AND GEOTECHNICAL SUBSURFACE INVESTIGATION REPORT.

BACKFILL MATERIAL SHALL BE APPROVED BY THE GEOTECHNICAL ENGINEER PRIOR TO INSTALLATION.

PRIOR TO BACKFILL OPERATIONS AGAINST FOUNDATION WALLS, THE WALLS SHALL BE PROPERLY SHORED TO RESIST THE LATERAL FORCE OF THE BACKFILL AND ASSOCIATED EQUIPMENT. LATERAL SHORES MAY BE ELIMINATED WHERE THE FLOOR SLAB CONNECTING TO THE WALLS HAS ACHIEVED THEIR DESIGN STRENGTH.

WHERE FINAL GRADES ARE APPROXIMATELY EQUAL ON BOTH SIDES OF A WALL, BACKFILL EQUALLY ON BOTH SIDES OF THE WALL IN LIFTS TO MAINTAIN LEVEL ELEVATIONS TO WITHIN 1'-0" AT ANY GIVEN TIME.

CONCRETE

ALL CONCRETE CONSTRUCTION SHALL CONFORM TO ACI 301-10, "STANDARD SPECIFICATION FOR STRUCTURAL CONCRETE" AND ACI 302, 305 AND 306 UNLESS NOTED OTHERWISE.

ALL DETAILING, FABRICATION AND PLACING OF CONCRETE SHALL CONFORM TO ACI 318-14, "BUILDING CODE REQUIREMENTS FOR STRUCTURAL CONCRETE" AND THE LATEST ACI "MANUAL OF STANDARD PRACTICE FOR DETAIL REINFORCED CONCRETE STRUCTURES" UNLESS NOTED OTHERWISE.

SAFETY AND PERFORMANCE OF THE STRUCTURE ARE THE RESPONSIBILITY OF THE CONTRACTOR INSOFAR AS THEY ARE AFFECTED BY THE LOCATION AND DETAILS OF CONSTRUCTION JOINTS. SHOP DRAWINGS OF THE PROPOSED CONSTRUCTION JOINT LOCATIONS AND DETAILS ARE TO BE SUBMITTED TO THE ARCHITECT FOR APPROVAL.

ALL CONCRETE SHALL DEVELOP A MINIMUM COMPRESSIVE STRENGTH IN 28 DAYS AS FOLLOWS:

ALL CONCRETE - 4000 PSI

ALL CONCRETE EXPOSED TO WEATHER SHALL CONTAIN 6% (± 1%) AIR ENTRAINMENT.

REINFORCING BARS SHALL CONFORM TO ASTM A615, GRADE 60.

WELDED WIRE FABRIC REINFORCING SHALL CONFORM TO ASTM A1064 AND BE FURNISHED IN FLAT SHEETS AND INSTALLED ON CHAIRS OR PRECAST CONCRETE BLOCKS.

NO TACK WELDING OF REINFORCING IN THE FIELD IS PERMITTED.

PROVIDE CORNER BARS AT ALL LOCATIONS WHERE REINFORCEMENT CHANGES

PROVIDE STRAIGHT AND DIAGONAL BARS AT EDGES OF ALL OPENINGS.

REINFORCING EMBEDMENT AND LAP SPLICES (INCHES) FOR 4000 PSI CONCRETE

	OTHER		TOP*	
BAR SIZE	ANCHORAGE	SPLICE	ANCHORAGE	SPLICE
#3	15	19	19	24
# 4	19	25	25	33
# 5	24	31	31	41
# 6	29	37	37	49
#7	42	54	54	71
# 8	48	62	62	81
# 9	54	70	70	91
#10	60	78	78	101
#11	66	85	85	111

* HORIZONTAL BARS WITH MORE THAN 12" OF CONCRETE BELOW BAR

CLEAR MINIMUM COVER OF CONCRETE OVER REINFORCING BARS SHALL BE AS

CONCRETE PLACED AGAINST EARTH: CONCRETE EXPOSED TO EARTH OR WEATHER:	3"	
CONCRETE EXPOSED TO EARTH OR WEATHER.		
#6 TO #18 BARS	2"	
#5 BAR OR SMALLER	1 1/2"	
CONCRETE NOT EXPOSED TO EARTH OR WEATHER:		
SLABS & WALLS #11 BAR AND SMALLER	3/4"	
CONCRETE BEAMS, COLUMNS, & PIERS	1 1/2"	

ADHESIVE DOWELLED ANCHORS

REINFORCING, BAR DOWELS, REINFORCING BARS, THREADED RODS, BOLTS ETC. WHICH ARE INDICATED TO BE ADHESIVE DOWELLED INTO CONCRETE OR SOLID MASONRY SHALL BE ACCOMPLISHED USING HIT HY-200 SAFESET ADHESIVE BY HILTI FASTENING SYSTEMS OF TULSA, OK. (ICC REPORT NO. ESR 3013), OR EQUAL.

DRILL, BRUSH, AND CLEAN ALL HOLES, AND INSTALL ALL ANCHORS IN COMPLETE ACCORDANCE WITH MANUFACTURERS PUBLISHED RECOMMENDATIONS, AS WELL AS ALL APPLICABLE BUILDING CODES OR ENGINEERING REPORTS.

PROVIDE THE FOLLOWING MINIMUM ANCHOR EMBEDMENT DEPTHS UNLESS SPECIFICALLY NOTED OTHERWISE ON THE DETAILS:

A. REINFORCING BARS BAR SIZE #3 #4 #5 #6 #7 #8 #9 #10 #11	EMBEDMENT DEPTH 4" 6" 7" 9" 10" 12" 13" 16" 18"
B. BOLTS OR THREADED RODS DIAMETER 3/8" 1/2" 5/8" 3/4" 7/8" 1"	EMBEDMENT DEPTH 5" 7" 8" 10" 12" 13"
C. HILTI HIS INSERTS DIAMETER 3/8" 1/2" 5/8" 3/4"	EMBEDMENT DEPTH 4 1/4" 5" 6 5/8" 8 1/4"

WHEN INSTALLING DRILLED-IN-ANCHORS, USE CARE AND CAUTION TO AVOID CUTTING OR DAMAGING THE EXISTING REINFORCING BARS.

STRUCTURAL ABBREVIATIONS: AMERICAN CONCRETE INSTITUTE ACI ALL COMMON SURFACES ACS AISC AMERICAN INSTITUTE OF STEEL CONST AISI AMERICAN IRON AND STEEL INSTITUTE ANSI AMERICAN NATIONAL STANDARDS INSTITUTE ARCH'L ARCHITECTURAL ALTERNATE ASTM AMERICAN SOCIETY FOR TESTING AND MATERIAL **BOTTOM OF** BOT BOTTOM **BEARING** CHANNEL **COLD-FORMED STEEL** CONTROL JOINT CJP **COMPLETE JOINT PENETRATION**

CENTER LINE CLEAR COLUMN

COL CONC CONCRETE CONT CONTINOUS DIAMETER DIAG DIAGONAL **DRAWING** DWG EXISTING **EACH FACE**

ELEVATION EQ **EQUAL EACH WAY** ΕW **FINISH FLOOR** FLR FLOOR

FND **FOUNDATION** FT FOOT FTG FOOTING GAUGE

GENERAL STRUCTURAL NOTES GSN HORIZ HORIZONTAL

INSIDE DIAMETER INFO INFORMATION KIP (1,000 LBS)

KIPS PER SQUARE INCH ANGLE LANDLORD LONG LEG HORIZONTAL

LONG LEG VERTICAL LLV LO MFR MANUFACTURER MAX MAXIMUM MECH **MECHANICAL** MIN MINIMUM MISC **MISCELLANEOUS**

NTS NOT TO SCALE OC ON CENTER OD **OUTSIDE DIAMETER**

OPP **OPPOSITE** PLATE POUNDS PER LINEAR FOOT POUNDS PER SQUARE FOOT PSI POUNDS PER SQUARE INCH REQUIRED

SIMILAR SPEC SPECIFICATION STD STANDARD TOP AND BOTTOM T&B T&G **TONGUE AND GROOVE** TO TOP OF TOP OF CONCRETE TOC TOD TOP OF DECK TOF TOP OF FOOTING

TOL TOP OF LEDGER TOP OF PANEL TOP OF STEEL TOW TOP OF WALL TYP TYPICAL **UNLESS NOTED OTHERWISE** UNO

VERT VERTICAL WIDE FLANGE W/ WITH WITHOUT W/O WSP WOOD STRUCTURAL PANELS WT WELDED WIRE FABRIC WWF

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THE OTHER (EXCEPT STATED ABOVE) UNTIL A

WRITTEN AGREEMENT IS FULLY EXECUTED BY



520 SOUTH MAIN ST. SUITE 2531



778 AM

STORE #: 59763 PROJECT #: 85334-001 ISSUE DATE: For Construction **DESIGN MANAGER:** ASHLEY SUEIRAS

PRODUCTION DESIGNER: GPD GROUP


CHECKED BY: GPD GROUP Revision Schedule

Description

STRUCTURAL GENERAL

NOTES SCALE: AS SHOWN

SHEET NUMBER:

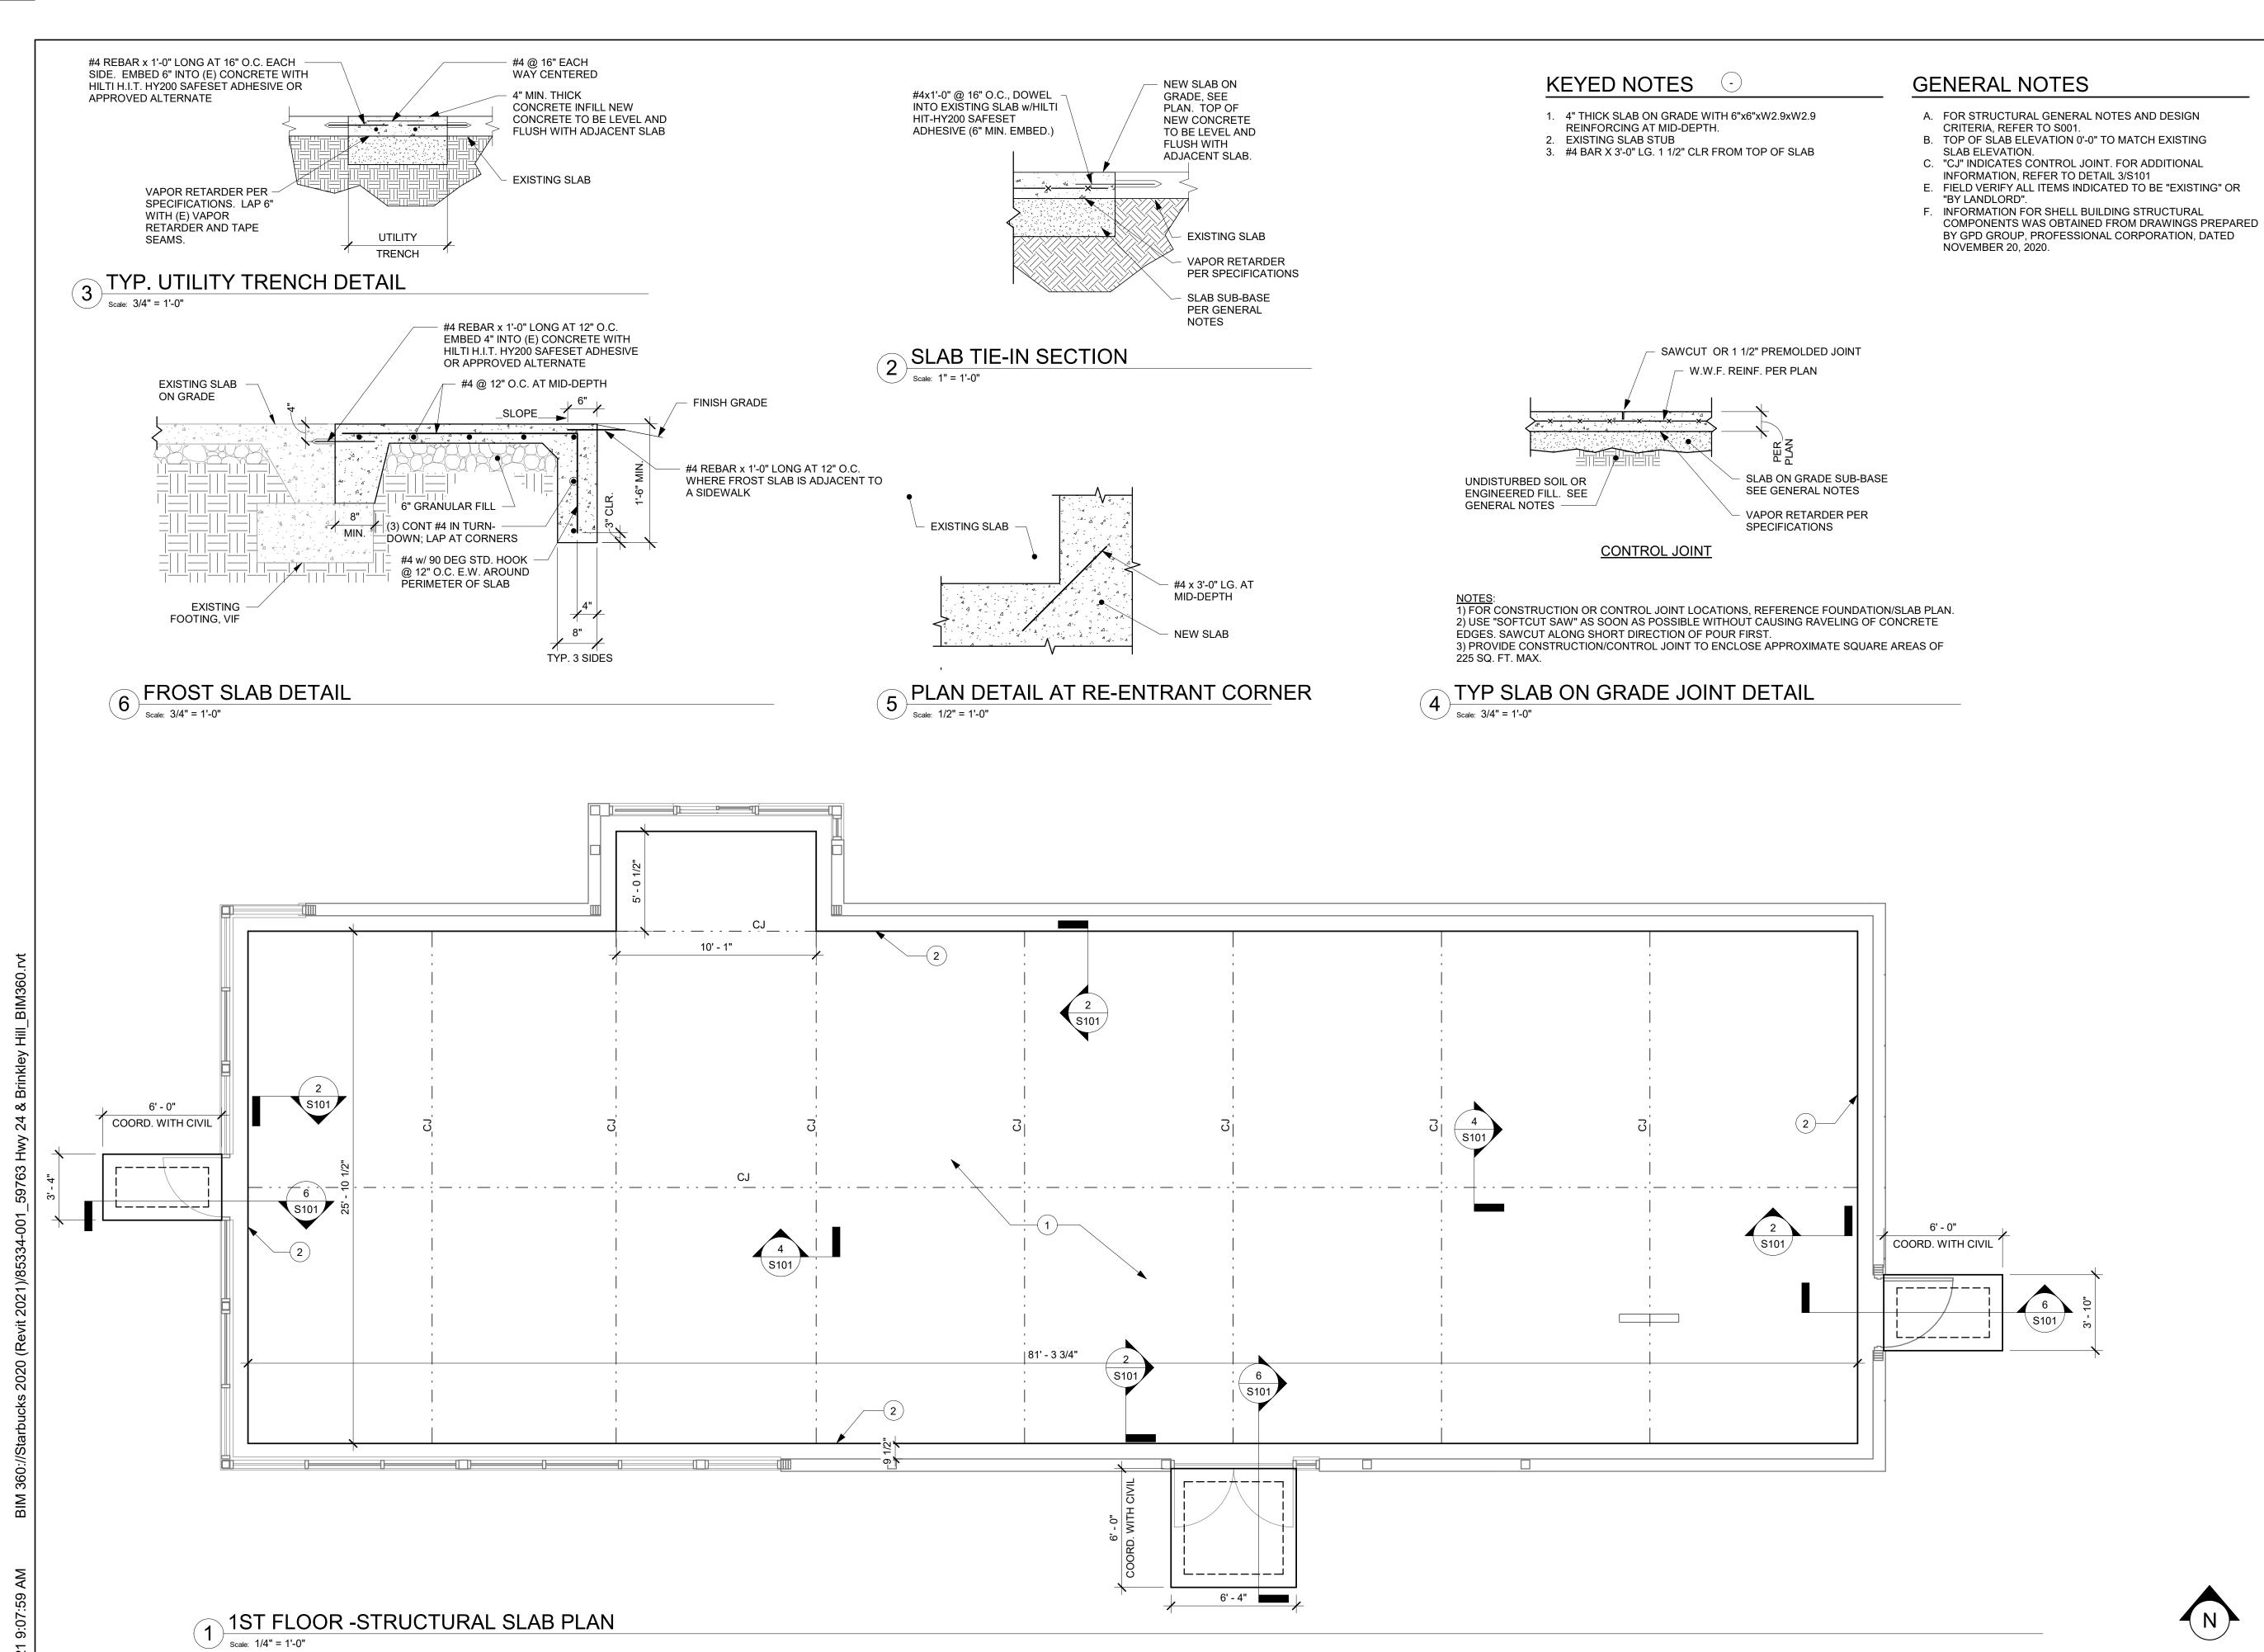



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520 SOUTH MAIN ST, SUITE 2531 AKRON, OH 44311 P: 330-572-2100 F: 330-572-2101 GPD PROJECT NO:

381**36**

85334-001 PROJECT #: ISSUE DATE: For Construction 09/01/21 ASHLEY SUEIRAS **DESIGN MANAGER:**


STORE #:

PRODUCTION DESIGNER: GPD GROUP CHECKED BY: **GPD GROUP**

STRUCTURAL SLAB PLAN SCALE: AS SHOWN

SHEET NUMBER:




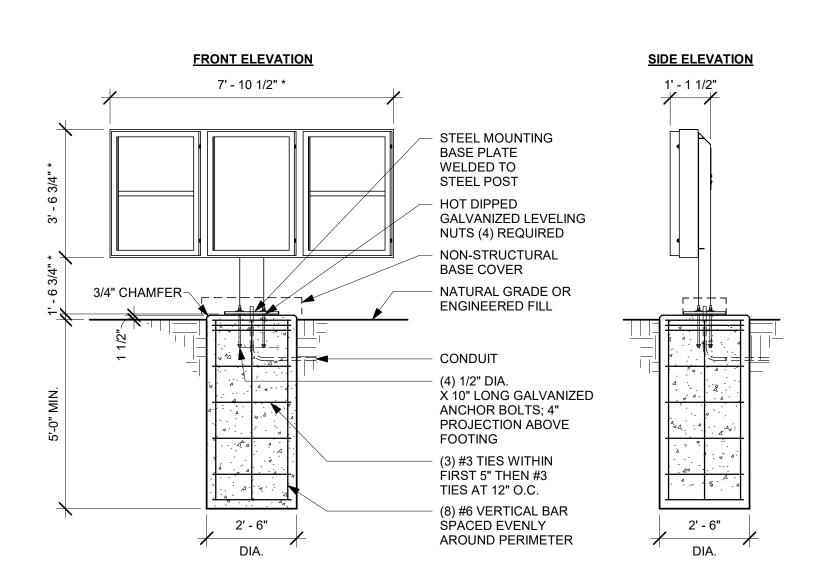


* VERIFY MARKED DIMENSIONS WITH EQUIPMENT SUPPLIER

DT 5-PANEL MENU BOARD GROUND FOOTING


Scale: 3/8" = 1'-0"

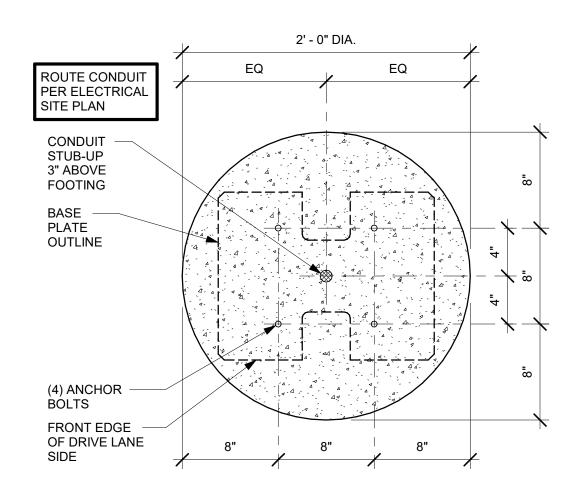

DTE 5-PANEL MENU BOARD BOLT PATTERN (TOP VIEW)

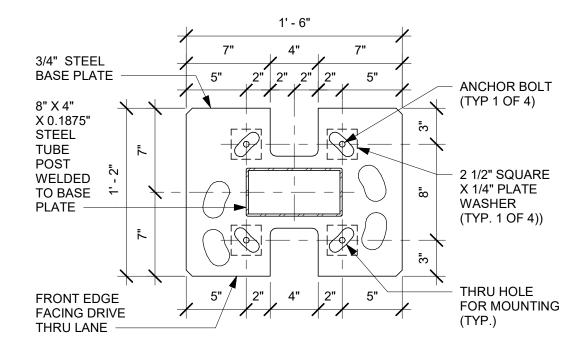

DTE 5-PANEL MENU BOARD BASE PLATE

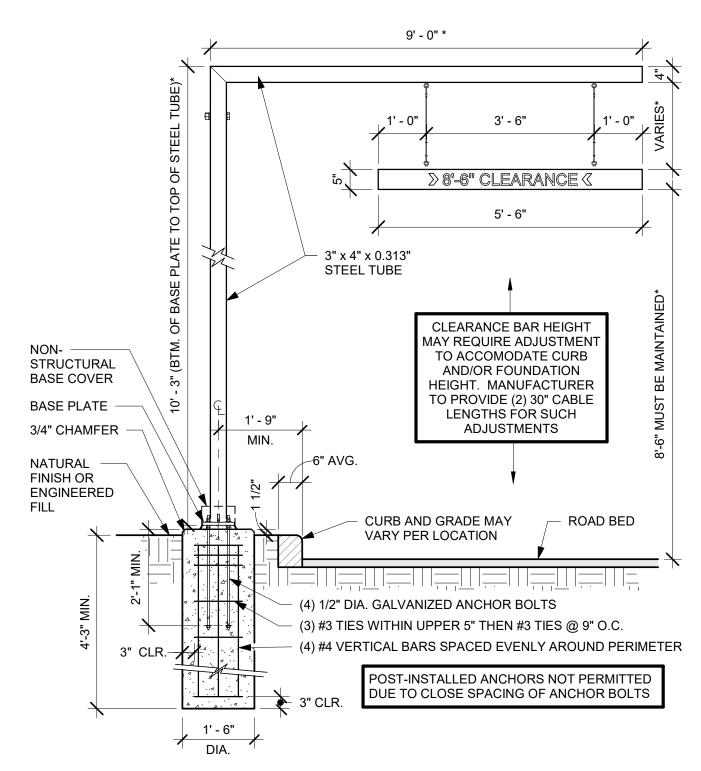


DTE CLEARANCE BAR GROUND FOOTING


FOUNDATIONS AND ANCHOR BOLTS FOR DRIVE THRU EQUIPMENT AND SIGNAGE SHALL BE FURNISHED AND INSTALLED BY GC.

- GC SHALL VERIFY ANCHOR BOLT SIZES WITH EQUIPMENT & SIGNAGE **VENDOR**
- **EQUIPMENT & SIGNAGE VENDOR SHALL SUPPLY ANCHOR BOLT** TEMPLATES AND INSTALL EQUIPMENT & SIGNAGE ON THE COMPLETED FOUNDATIONS.
- PROVIDE 3" MINIMUM CONCRETE COVER TO ALL REINFORCING


DTE CLEARANCE BAR BOLT PATTERN

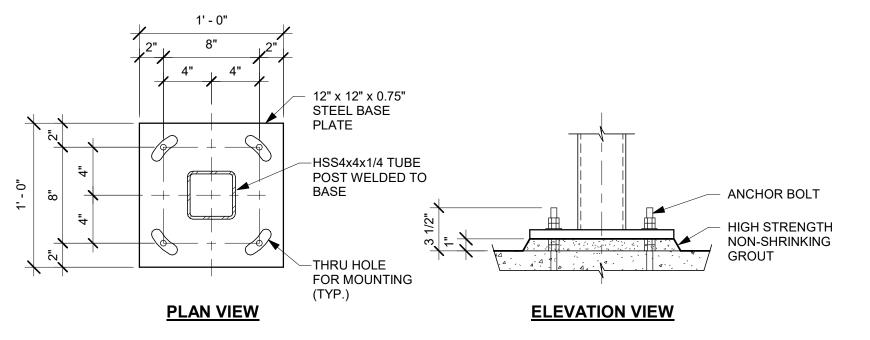

6 DTE CLEARANCE BAR BASE PLATE

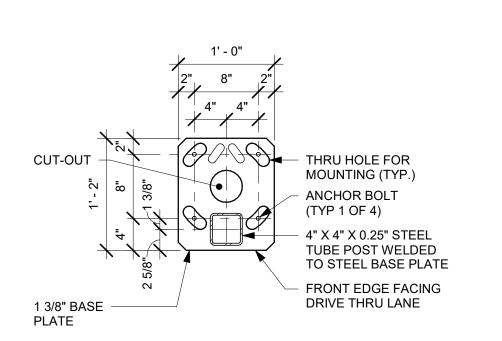

9 DTE DOS CANOPY BASE PLATE

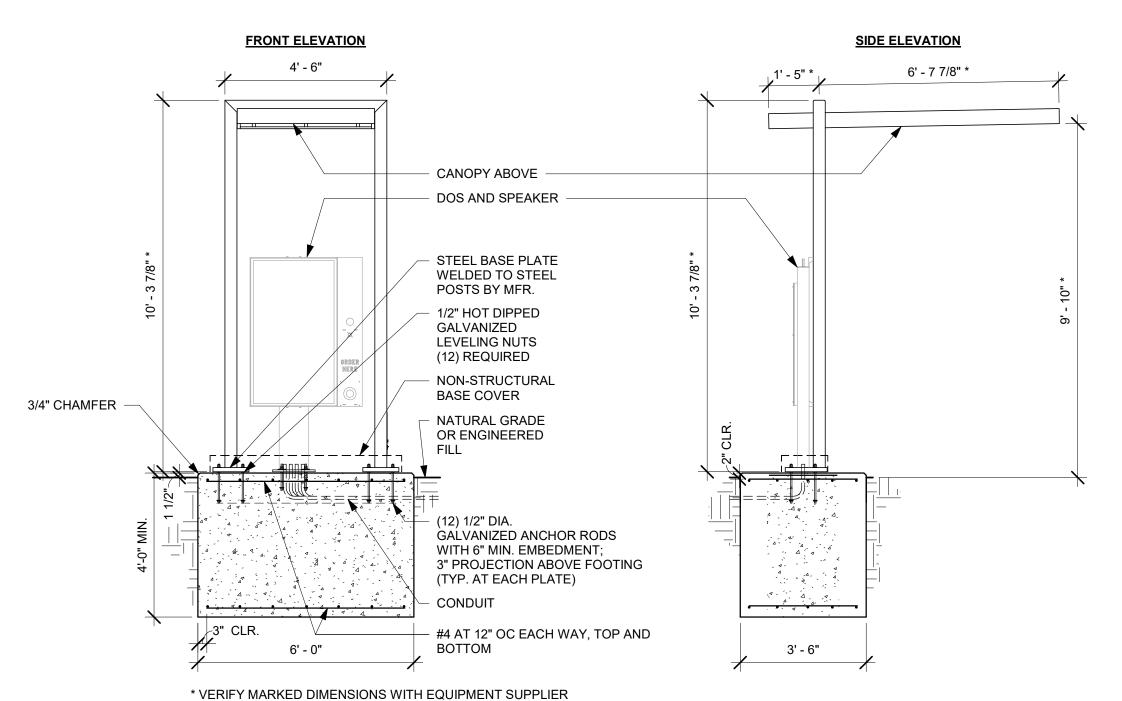

DTE DOS CANOPY GROUND FOOTING

BASE COVER OUTLINE ALL CONDUIT ROUTE CONDUIT PER STUB-UPS TO OUTLINE OF DOS POST BASE PLATE **ELECTRICAL** BE 3" ABOVE SITE PLAN FOOTING ANCHOR BOLT (TYP.): (4) AT EACH CANOPY BASE PLATE (4) AT DOS BASE PLATE EDGE OF CONCRETE FOOTING + **OUTLINE OF CANOPY** BASE PLATE (TYP. 1 OF 2)) DOS STUB-UPS CANOPY LIGHTING STUB-UP

DTE DOS CANOPY BOLT PATTERN (TOP VIEW)



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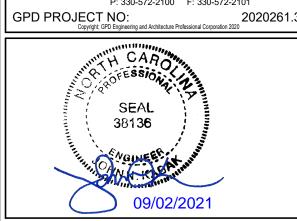
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59763


STORE #: PROJECT #: 85334-001 ISSUE DATE: For Construction


ASHLEY SUEIRAS PRODUCTION DESIGNER: GPD GROUP CHECKED BY: **GPD GROUP**

SITE FOUNDATIONS


SCALE: AS SHOWN

SHEET NUMBER:

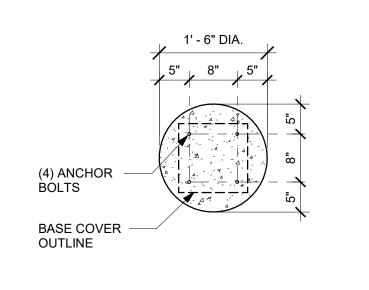


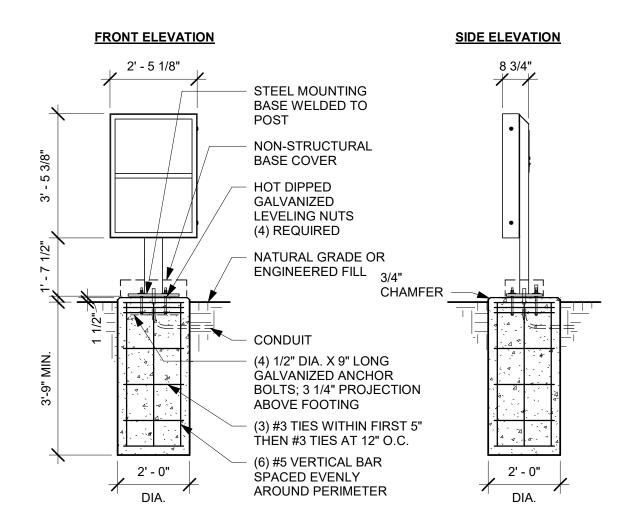

DTE PRE-MENU GROUND FOOTING

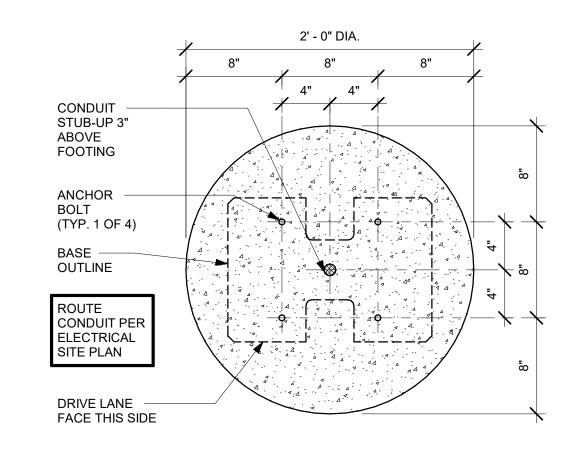


2 DTE PRE-MENU BOLT PATTERN (TOP VIEW) | Scale: 1 1/2" = 1'-0"

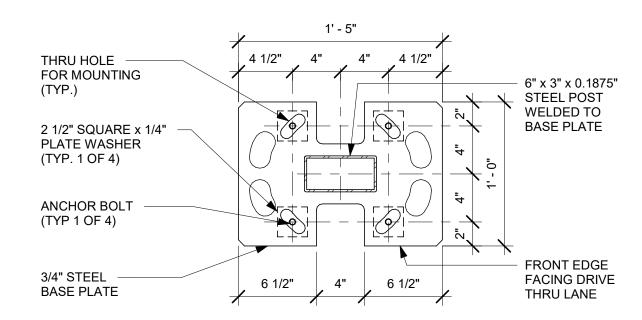


3 DTE PRE-MENU BASE PLATE


Scale: 1 1/2" = 1'-0"

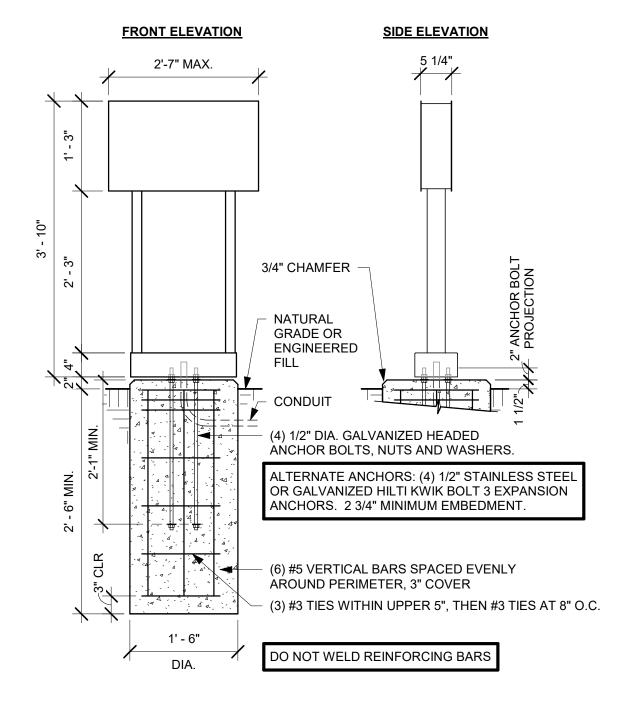

DTE DIRECTIONAL SIGNAGE GROUND FOOTING

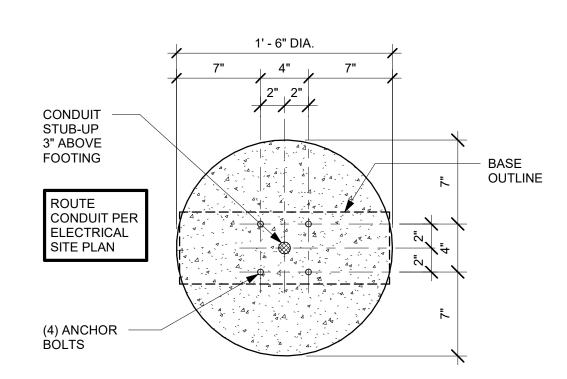

5 DTE DIRECTIONAL SIGNAGE BOLT PATTERN

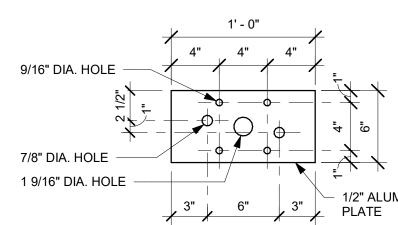

6 DTE DIRECTIONAL SIGNAGE BASE PLATE

NOTES:

- 1. FOUNDATIONS AND ANCHOR BOLTS FOR DRIVE THRU EQUIPMENT AND SIGNAGE SHALL BE FURNISHED AND INSTALLED BY GC.
- 2. GC SHALL VERIFY ANCHOR BOLT SIZES WITH **EQUIPMENT & SIGNAGE VENDOR**
- 3. EQUIPMENT & SIGNAGE VENDOR SHALL SUPPLY **ANCHOR BOLT TEMPLATES AND INSTALL EQUIPMENT & SIGNAGE ON THE COMPLETED** FOUNDATIONS.
- 4. PROVIDE 3" MINIMUM CONCRETE COVER TO ALL REINFORCING STEEL.



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BOTH PARTIES.



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STORE #: PROJECT #: ISSUE DATE:

For Construction ASHLEY SUEIRAS PRODUCTION DESIGNER: GPD GROUP CHECKED BY: GPD GROUP

Revision Schedule

59763

85334-001

Rev	Date	Ву	Description

SITE FOUNDATIONS

SCALE: AS SHOWN

SHEET NUMBER:

CIRCUIT

CKT

ABOVE FINISHED FLOOR

CXA COMMISSIONING AGENT DEG DEGREES

LIGHTS WITHIN DAYLIGHT ZONE DM STARBUCKS DESIGN MANAGER DN DOWN DTL DETAIL

DWG(S) DRAWING(S) EΑ EC **ELECTRICAL CONTRACTOR**

ECP **EQUIPMENT CONTROL PAC** EG **EXHAUST GRILLE** ELEC **ELECTRICAL**

FΜ **EMERGENCY ENERGY MANAGEMENT SYSTEM** EX **EXISTING**

EXT **EXTERIOR** F&I FURNISH & INSTALL FOIC FURNISHED BY OWNER,

INSTALLED BY CONTRACTOR FURNISHED BY OWNER, **INSTALLED BY OWNER**

FLOOR

GROUND

GND

FOOT/FEET GC GENERAL CONTRACTOR **GFCI** GROUND FAULT CIRCUIT INTERRUPTER

HR HOUR HVAC HEATING, VENTILATION, AIR CONDITIONING **HOT WATER**

LCP LIGHTING CONTROL PANEL LANDLORD LS LIGHT SENSOR PHOTOCELL LV

LOW VOLTAGE MAX MAXIMUM MC MECHANICAL CONTRACTOR MDP MAIN DISTRIBUTION PANEL

MECH MECHANICAL MECHANICAL, ELECTRICAL, AND PLUMBING MFG MANUFACTURER

MIN MINIMUM **NIGHTLIGHT**

NOT TO SCALE OCP OVERCURRENT PROTECTION

PASSIVE INFRARED SENSOR

REF REFERENCE REQ('D) REQUIRE(D) REV REVISION SQUARE FEET SHEET SPECS SPECIFICATION(S) STAINLESS STEEL

TEL **TELEPHONE TEMPORARY** TEMP TYP TYPICAL

WH

WP

UC UNDER COUNTER UNO UNLESS NOTED OTHERWISE

WATER HEATER

WEATHER PROOF

ELECTRICAL SYMBOL LEGEND

JUNCTON BOX RECEPTACLE: DUPLEX **SWITCH** RECEPTACLE: DUPLEX -INDIVIDUAL BRANCH CIRCUIT THREE-WAY SWITCH RECEPTACLE: QUAD MOTION (OCCUPANCY) RECEPTACLE: QUAD -SENSOR SWITCH INDIVIDUAL BRANCH CIRCUIT SWITCHBACK RECEPTACLE: HIGH VOLTAGE TELEPHONE RECEPTACLE: FLOOR DUPLEX GROUNDING ELECTRODE **THERMOSTAT** THERMOSTAT SENSOR NIGHTLIGHTING 24HR/DAY DIMMER SWITCH PHOTOELECTRIC CELL RECEPTACLE: DATA SPEAKER RACEWAY CONCEALED WIFI ACCESS POINT IN CEILING OR WALL HASH MARKS INDICATE NUMBER OF WIRES. 360 CAMERA #12 AWG WIRE UNLESS OTHERWISE NOTED. TWO WIRES PLUS CARBON MONOXIDE SENSOR GROUND IF NO HASH MARKS SHOWN. LONG HASH MARK DENOTES CARBON DIOXIDE SENSOR NEUTRAL. **GROUND WIRE NOT** SHOWN.

FIRE ALARM SYSTEM NOTES

IF STARBUCKS IS REQUIRED TO PROVIDE A FIRE ALARM AND/OR FIRE ALARM MONITORING AND/OR PHONE LINES FOR A FIRE ALARM, AS SPECIFIED IN THE LEASE AGREEMENT, THE CONTRACTOR IS TO NOTIFY GNOC IMMEDIATELY THAT FIRE ALARM LINES ARE NEEDED. STARBUCKS PREFERRED FIRE ALARM SERVICE PROVIDER, STANLEY, IS TO BE CONTACTED BY THE CONSTRUCTION MANAGER TO INSTALL FIRE ALARM PANEL AND/OR MONITORING SERVICE AS REQUIRED.

CARBON MONOXIDE (CO) DETECTOR NOTES

COORDINATE INSTALLATION OF CARBON MONOXIDE (CO) DETECTOR DEVICE(S) AND LOW VOLTAGE WIRING WITH STARBUCKS SECURITY VENDOR FOR NEW STORES, RELOCATIONS AND MAJOR RENOVATIONS. VENDOR TO FURNISH AND INSTALL DEVICE(S) IN BOH AND FOH (AS APPLICABLE PER STARBUCKS STANDARDS). GC TO PROVIDE ROUGH-IN

CONTROLS AND OPERATION

THE GENERAL CONTRACTOR SHALL CONTACT **VENSTAR** PRIOR TO THE LAST WEEK OF CONSTRUCTION FOR COMMISSIONING AND COORDINATE REQUIREMENTS WITH STARBUCKS.

FURNISH AND INSTALL RACEWAYS WITH PULL STRINGS AND JUNCTION BOXES FOR THERMOSTAT(S) AND SENSOR(S).

SET RESTROOM OCCUPANCY SENSOR TO 5 MINUTE 'ON' DURATION IN SINGLE OCCUPANT RESTROOM AND TO 5 MINUTE 'ON' DURATION IN MULTI-OCCUPANT RESTROOM UNLESS JURISDICTION REQUIREMENTS STATE OTHERWISE.

COORDINATE WITH DRAWINGS AND LCP VENDOR FOR DEVICE LOCATIONS. VENDOR SHALL COMMISSION CONTROLS.

THE GENERAL CONTRACTOR IS TO COMPLETE FINAL CONNECTION AFTER DATA RACK AND NETWORK INSTALLATION. THE GENERAL CONTRACTOR IS TO CONTACT LCP VENDOR TO VERIFY SYSTEM OPERATION AND TROUBLESHOOT IF REQUIRED.

ENERGY MANAGEMENT SYSTEM (EMS)

THE GENERAL CONTRACTOR SHALL INSTALL **LIGHTING CONTROLS** AND EMS. PRIOR TO LAST WEEK OF CONSTRUCTION, IF NEEDED, FURNISH AND INSTALL TEMPORARY THERMOSTATS AND SENSORS, AND ROUTE ALL LOW VOLTAGE WIRING THROUGH EC PROVIDED CONDUITS (COORDINATE WITH ELECTRICAL).

FURNISH AND INSTALL RACEWAYS WITH PULL STRINGS AND JUNCTION BOXES FOR THERMOSTAT(S) AND SENSOR(S).

SET RESTROOM OCCUPANCY SENSOR TO 5 MINUTE 'ON' DURATION IN SINGLE OCCUPANT RESTROOM AND TO 5 MINUTE 'ON' DURATION IN MULTI-OCCUPANT RESTROOM UNLESS JURISDICTION REQUIREMENTS STATE OTHERWISE.

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SYSTEM COMMISSIONING

CONTRACTOR RESPONSIBILITIES FOR BUILDING COMMISSIONING

CONTRACTOR SHALL PROVIDE SUPPORT AND WORK AS SPECIFIED. NEEDED AND REQUIRED TO CONDUCT AND FACILITATE STARBUCKS STAFF BUILDING COMMISSIONING EFFORTS. THIS WORK WILL BE COMPRISED OF THREE DISTINCT EFFORTS:

- 1) SUPPORT STARBUCKS COMMISSIONING AGENT (CXA) DURING INSTALLATION VERIFICATION AND CORRECT DISCLOSED **DEFICIENCIES**:
- 2) PERFORM TESTING, ADJUSTING, BALANCING AND SYSTEM STARTUP AND SUPPORT FUNCTIONAL PERFORMANCE TESTING BY STARBUCKS CXA:
- 3) CORRECT DEFICIENCIES DISCLOSED BY FUNCTIONAL PERFORMANCE TESTING AND SUBMIT REPORTS. CONTRACTOR SHALL PERFORM AND PROVIDE THE FOLLOWING:
- A. SYSTEMS SUBJECT TO COMMISSIONING MAY INCLUDE, BUT ARE NOT LIMITED TO DOMESTIC HOT WATER GENERATION, HVAC SYSTEMS, ROOFTOP UNITS, EXHAUST FANS, HVAC CONTROLS, LIGHTING CONTROLS AND AIR CURTAINS.
- B. CONTRACTOR SHALL INCLUDE COMMISSIONING ACTIVITIES IN PROJECT SCHEDULE AND SHOW INTERVALS FOR PERFORMANCE OF WORK FOR WHICH CONTRACTOR IS RESPONSIBLE AND INTERVALS FOR WORK PERFORMED BY STARBUCKS CXA. CONTRACTOR SHALL SHOW RESOURCES FOR PERFORMING ALL WORK RELATED TO COMMISSIONING ACTIVITIES ON A LINE ITEM IN THE SCHEDULE OF VALUES.
- C. CONTRACTOR SHALL INSTALL EQUIPMENT IN ACCORDANCE WITH THE MANUFACTURER'S REQUIREMENTS AND ALL CONTRACT DOCUMENTS. ENSURE THAT ALL EQUIPMENT IS INSTALLED TOTALLY COMPLETE. AND ACCESSIBLE TO STARBUCKS CXA FOR INSTALLATION VERIFICATION AND FUNCTIONAL PERFORMANCE TESTING PRIOR TO THE SCHEDULED START OF INSTALLATION VERIFICATION.
- D. INSTALLATION VERIFICATION SHALL BE PERFORMED BY STARBUCKS CXA. CONTRACTOR SHALL SUPPORT STARBUCKS CXA INSTALLATION VERIFICATION EFFORTS AS NECESSARY. PROVIDE ALL ACCESS AND EQUIPMENT NECESSARY FOR STARBUCKS STAFF TO VERIFY THAT THE EQUIPMENT IS INSTALLED CORRECTLY.
- E. CONTRACTOR SHALL BE READILY AVAILABLE DURING INSTALLATION VERIFICATION TO CORRECT ANY DEFICIENCIES OR DEFECTS DISCLOSED BY THE INSTALLATION VERIFICATION PROCESS. CORRECTIONS SHALL BE MADE IN A TIMELY MANNER WITHOUT DISRUPTION OF THE CONSTRUCTION SCHEDULE.
- F. ALL HVAC, EXHAUST FAN, AND AIR CURTAIN EQUIPMENT SHALL BE TESTED, ADJUSTED AND BALANCED BY THE CONTRACTOR'S TESTING, ADJUSTING AND BALANCE AGENT(SEE TESTING, ADJUSTING AND BALANCING) AFTER THE SYSTEM IS VERIFIED TO BE COMPLETE AND CORRECT BY STARBUCKS CXA, IN ACCORDANCE WITH THE REQUIREMENTS OF THESE DOCUMENTS. ALL HVAC CONTROL SYSTEMS SHALL BE TESTED TO ENSURE THAT CONTROL DEVICES, COMPONENTS, EQUIPMENT AND SYSTEMS ARE CALIBRATED, ADJUSTED AND OPERATE IN ACCORDANCE WITH THESE PLANS AND PROJECT MANUAL. SEQUENCES OF OPERATION SHALL BE TESTED TO ENSURE THAT THEY OPERATE IN ACCORDANCE WITH THE CONTRACT REQUIREMENTS. DELIVERABLES: PRELIMINARY, WRITTEN TESTING AND AIR BALANCE REPORT CONFORMING TO THE REQUIREMENTS SPECIFIED HEREIN, DOCUMENTING THE INFORMATION SPECIFIED, ETC. TO THE STARBUCKS CXA IMMEDIATELY UPON COMPLETION OF THE WORK.
- G. CONTRACTOR SHALL INFORM STARBUCKS CXA WHEN **EQUIPMENT IS READY FOR FUNCTIONAL PERFORMANCE** TESTING. ALL EQUIPMENT SHALL BE READY FOR FUNCTIONAL PERFORMANCE TESTING PRIOR TO STARTING TESTING. CONTRACTOR SHALL OPERATE EQUIPMENT FOR STARBUCKS CXA AND VERIFY BY DEMONSTRATION THE CORRECT OPERATION OF EQUIPMENT, RESPONSE OF SENSORS, AND PROPER EXECUTION OF HVAC CONTROL AND LIGHTING SEQUENCES; INCLUDING BUT NOT LIMITED TO, AIR MOVEMENT, TEMPERATURE, SOUND, AND CONTROL RESPONSE. PROVIDE ANY SECURITY ACCESS, HARDWARE, SOFTWARE, OR OTHER SUPPORT AS NEEDED FOR THE STARBUCKS CXA TO EFFICIENTLY WITNESS AND DOCUMENT ALL EQUIPMENT TESTING. STARBUCKS CXA WILL RECORD THE EQUIPMENT OPERATION AND RESPONSE TO TESTING SEQUENCES AND PREPARE A LIST OF ANY DEFICIENCIES DISCLOSED BY THE FUNCTIONAL PERFORMANCE TESTS FOR CORRECTION BY THE CONTRACTOR. EQUIPMENT INCLUDES, BUT IS NOT LIMITED TO, AIR HANDLING UNITS, ROOFTOP AND SPLIT TYPE, CONDENSING UNITS, EXHAUST FANS, LIGHTING CONTROLS, ETC. DELIVERABLES: PROVIDE COMPLETED COPIES OF ALL START UP REPORTS, FILLED OUT ON THE MANUFACTURER'S FORMS, TO THE STARBUCKS CXA.
- H. CONTRACTOR IS RESPONSIBLE FOR CORRECTING ANY ISSUES OR DEFICIENCIES DISCLOSED DURING THE FUNCTIONAL PERFORMANCE TESTING PROCESS. CORRECTIONS SHOULD BE MADE IN A TIMELY MANNER WITHOUT DISRUPTION TO THE SYSTEM AND CONSTRUCTION SCHEDULE.
- CONTRACTOR SHALL BE READILY AVAILABLE FOR ANY RE-TESTING OF EQUIPMENT DEEMED NECESSARY BY STARBUCKS CXA DURING INSTALLATION VERIFICATION AND FUNCTIONAL PERFORMANCE TESTING. CONTRACTOR IS RESPONSIBLE FOR CORRECTING ANY ISSUES OR DEFICIENCIES FOUND IN THE SYSTEM DURING ANY AND ALL RE-TESTING. CORRECTIONS SHOULD BE MADE IN A TIMELY MANNER WITHOUT DISRUPTION TO THE SYSTEM AND CONSTRUCTION SCHEDULE. DELIVERABLES: FINAL BALANCE REPORT, DEFICIENCIES LIST NOTING CORRECTIVE ACTIONS PERFORMED BY CONTRACTOR IN RESPONSE TO INSTALLATION VERIFICATION AND FUNCTIONAL PERFORMANCE TEST RESULTS
- J. CONSTRUCTION AND POST CONSTRUCTION TESTING: ADDITIONAL TESTING MAY BE REQUIRED AND OTHER PROCESSES THAT MAY OCCUR OUT OF SEQUENCE WITH COMMISSIONING SERVICE. CONTRACTOR SHALL CONDUCT, DOCUMENT, SUPPORT AND SCHEDULE THIS TESTING AS DIRECTED BY STARBUCKS CXA.

SECURITY SYSTEM NOTES

STARBUCKS CONTRACTS DIRECTLY WITH SECURITY VENDOR TO SUPPLY AND INSTALL THE SECURITY SYSTEM. CONTRACTOR TO SCHEDULE INSTALLATION OF SECURITY SYSTEM FOR FOUR (4) TIMES;

- MEET TO PLAN SECURITY CABLE PULL WITH SECURITY CABLE INSTALLER PRIOR TO DRYWALL INSTALLATION.
- 2. SECURITY CABLE INSTALLER PULLS SECURITY CABLES, MOUNTS PANEL, KEYPAD AND SENSORS.
- 3. SECURITY EQUIPMENT INSTALL OF CAMERA, NVR AND MONITOR.
- 4. SECURITY MONITORING COMPANY TO BRING SYSTEM ONLINE AND

SECURITY VENDOR REQUIRES A MINIMUM TWO (2) WEEKS LEAD TIME FOR EACH INSTALLATION. SECURITY VENDOR WILL COORDINATE REGIONAL INSTALLERS. ALL ADDITIONAL EXPENSES INCURRED DUE TO THE CONTRACTOR'S FAILURE TO SCHEDULE ACCORDINGLY WILL BE THE RESPONSIBILITY OF THE CONTRACTOR.

TELEPHONE SYSTEM NOTES

TRAIN PARTNERS AFTER POS INSTALL.

IF ADDITIONAL TELEPHONE LINES ARE REQUIRED BEYOND THE STANDARD SINGLE LINE (SUCH AS FOR A FIRE ALARM) THE GENERAL CONTRACTOR SHALL CONTACT THE STARBUCKS CONSTRUCTION MANAGER PRIOR TO BEGINNING CONSTRUCTION TO ORDER THE ADDITIONAL TELEPHONE LINE(S). REPORT ANY TELEPHONE INSTALLATION ISSUES IMMEDIATELY TO THE STARBUCKS CONSTRUCTION MANAGER.

CONFIRM PRIOR TO BEGINNING CONSTRUCTION THAT THERE ARE EXISTING, WORKING TELCO FACILITIES TO THE BUILDING OR THAT LANDLORD HAS FURNISHED AND INSTALLED ONE (1) 2" (51MM) MIN. (ENTRANCE) CONDUIT INCLUDING PULL STRING FROM TELCO STREET FEED LINE TO THE BUILDING AS IDENTIFIED BY THE PHONE COMPANY NOTIFY STARBUCKS CONSTRUCTION MANAGER IMMEDIATELY IF FACILITIES OR CONDUIT AND PULL STRING ARE NOT INSTALLED.

GENERAL CONTRACTOR IS TO ENSURE THAT THERE IS A 2" (51MM) MIN CONDUIT WITH PULL STRING FROM THE DATA RACK TO THE DEMARC (TELCO TO CUSTOMER HAND OFF EQUIPMENT) WHEN THE DEMARC IS MORE THAN 10' FROM THE DATA RACK. DISTANCES LESS THAN 10' WILL NOT REQUIRE CONDUIT.

PROVIDE A 3-POSITION GROUND LUG, GROUNDED WITH #6 AWG GROUND WIRE, IF REQUIRED BY TELEPHONE COMPANY.

ALL TELEPHONE/NETWORK CABLING IS THE SCOPE OF WORK OF THE TELEPHONE/NETWORK CABLING VENDOR.

POS \ DATA LINE NOTES

STARBUCKS CONTRACTS DIRECTLY WITH THE DATA CABLING VENDOR TO SUPPLY AND INSTALL CATEGORY 5e (CAT5e) LAN CABLE AND CONNECTORS FOR THE POINT OF SALE (POS) SYSTEMS. CONTRACTOR TO SCHEDULE INSTALLATION OF DATA CABLING WITH DATA CABLING VENDOR. DATA CABLING VENDOR REQUIRES A LEAD TIME FOR INSTALLATION. DATA CABLING VENDOR WILL COORDINATE REGIONAL INSTALLERS.

AT THE START OF CONSTRUCTION, STARBUCKS CONSTRUCTION MANAGER SCHEDULES DELIVERY OF CASH REGISTER/MANAGER'S WORKSTATION EQUIPMENT AND INSTALLATION BY A POS INSTALL TECHNICIAN FOR ONE (1) MONTH PRIOR TO STORE OPEN. CONTRACTOR TO VERIFY DELIVERY SCHEDULE TWO (2) WEEKS PRIOR TO DELIVERY AND INSTALLATION DATE. EQUIPMENT IS SHIPPED DIRECTLY TO THE STORE. CONTRACTOR TO ACCEPT POS EQUIPMENT DELIVERY. DO NOT REFUSE DELIVERY.

DATA CABLING TECHNICIAN TO PROVIDE ALL CAT5e LAN CABLING AND CONNECTORS FROM ALL DESIGNED AND FUTURE CASH REGISTER LOCATIONS, MANAGER'S WORKSTATION, ALL OTHER NETWORKED EQUIPMENT (CUP LABELERS, CLOVER, BUMP BAR, ETC...) AND WIRELESS ACCESS POINT TO THE DATA RACK AREA. CONTRACTOR IS TO HAVE CONDUIT WITH PULL STRING IN PLACE FOR ALL CABLE RUNS PRIOR TO CABLE INSTALL DATE.

STARBUCKS NEW STORE GROUP IS RESPONSIBLE FOR COORDINATING STARBUCKS POS SYSTEMS DELIVERY AND INSTALLATION WITH THE POS VENDOR. THIS GROUP MAY BE CONTACTED AT: NEWSTORES@STARBUCKS.COM.

COMMUNICATION SYSTEM NOTES

CONFIRM PRIOR TO BEGINNING CONSTRUCTION THAT THE LANDLORD HAS FURNISHED AND INSTALLED ONE (1) ADDITIONAL 2" (51MM) (ENTRANCE) CONDUIT INCLUDING PULL STRING (FOR A TOTAL OF TWO (2)) FROM THE STREET FEED TO THE BUILDING AS IDENTIFIED BY THE INTERNET SERVICE

WIRELESS NETWORK NOTES

CABLING FOR INTERNET SERVICE SHALL BE FURNISHED AND INSTALLED BY THE VENDOR FOR FIBER OR BROADBAND CONNECTIONS. T1 AND ETHERNET EXTENSION CABLING IS PROVIDED BY THE STARBUCKS (TELEPHONE/ NETWORK) CABLING VENDOR. COORDINATE WITH STARBUCKS.

MUSIC SYSTEM NOTES

MOUNT OWNER FURNISHED SPEAKERS WHERE SHOWN ON INTERIOR REFLECTED CEILING PLANS AND IN COORDINATION WITH ALL PLANS. DETAILS AND MANUFACTURER'S INSTALLATION REQUIREMENTS. INSTALL AND CONNECT OWNER FURNISHED WIRING SYSTEM BETWEEN ALL SPEAKERS AND THE OWNER PROVIDED MUSIC SYSTEM. SET WATTAGE TAP ON EACH SPEAKER'S ROTARY SWITCH PER TAP SETTINGS NOTED ON PLANS.

GENERAL ELECTRICAL NOTES

- 1. THE ELECTRICAL CONTRACTOR SHALL COORDINATE ELECTRICAL WORK WITH OTHER TRADES. THE ARCHITECTURAL DRAWINGS SHALL TAKE PRECEDENCE OVER ALL OTHER DRAWINGS. DO NOT SCALE DISTANCES OFF THE ELECTRICAL DRAWINGS; USE ACTUAL BUILDING DIMENSIONS. OVERALL CASEWORK COMPONENT DIMENSIONING ON ELECTRICAL DETAILS ARE SHOWN FOR REFERENCE AND COORDINATION ONLY. SEE PROJECT MANUAL
- 2. ALL ELECTRICAL SYSTEMS SHALL BE TESTED FOR PROPER OPERATION. BALANCE ALL BRANCH CIRCUIT LOADS BETWEEN THE PHASES OF THE SYSTEM WITHIN 10% OF THE HIGHEST PHASE LOAD IN EACH PANEL BOARD.
- 3. THE ELECTRICAL CONTRACTOR SHALL BE RESPONSIBLE FOR DE-ENERGIZING CIRCUITS IN DEMOLITION AREAS TO INSURE A SAFE CONDITION. ELECTRICAL DEVICES AND ASSOCIATED WIRING LOCATED WITHIN THE DEMOLITION AREA THAT WILL NO LONGER BE USED SHALL BE REMOVED AND PROPERLY DISPOSED OF AT CONTRACTORS EXPENSE UNLESS OTHERWISE NOTED.
- 4. THE ELECTRICAL CONTRACTOR SHALL SCHEDULE ALL ELECTRICAL SYSTEM OUTAGES WITH THE GENERAL CONTRACTOR AND LANDLORD AT LEAST 24 HOURS IN ADVANCE. UNLESS APPROVED OTHERWISE ALL OUTAGES SHALL OCCUR BETWEEN 11:00PM AND
- 5. ELECTRICAL CONTRACTOR SHALL FURNISH AND INSTALL ALL NECESSARY CONDUIT AND J-BOXES TO SUPPORT A COMPLETE SECURITY, PHONE, POS AND DATA SYSTEMS. SEE MANAGER WORKSTATION AND BAR POINT OF SALE (POS) POWER/TELECOM/SECURITY DIAGRAM. COORDINATE ALL DEVICE LOCATIONS AND MOUNTING HEIGHTS WITH SECURITY VENDOR PRIOR TO ROUGH-IN. PROVIDE END-TO-END PULL STRINGS IN ALL CONDUITS. LABEL EACH END OF THE PULL STRING WITH CONDUIT SYSTEM ("SECURITY") AND DESTINATION ("CAFÉ", "FRONT BAR", ETC.). PROVIDE INSULATED BUSHINGS ON ALL STUBBED-UP AND EXPOSED CONDUIT ENDS.
- 6. ELECTRICAL CONTRACTOR SHALL COORDINATE WITH THE GENERAL CONTRACTOR TO PATCH AND REPAIR ALL EXISTING WALLS, FLOORS, CEILINGS OR OTHER SURFACES IDENTIFIED TO REMAIN THAT MAY BECOME DAMAGED DURING THE COURSE OF
- 7. EXPOSED/SURFACE MOUNTED CONDUITS SHALL ONLY BE ALLOWED WHERE NECESSARY IN EXPOSED CEILING AREAS. IF CONDUITS NEED TO BE SURFACE MOUNTED TO WALLS, COORDINATE WITH STARBUCKS CONSTRUCTION MANAGER FOR APPROVAL.
- 8. VERIFY LOCATION OF ALL OUTLETS AND SWITCHES WITH ARCHITECTURAL DRAWINGS, INTERIOR DETAILS, FINISH SCHEDULES, GENERAL CONTRACTOR, EQUIPMENT VENDORS, STARBUCKS AND EXISTING SITE CONDITIONS. VERIFY FINAL DOOR HINGE LOCATION PRIOR TO SWITCH INSTALLATION AND ADJUST SWITCH LOCATION IF NEEDED. DO NOT MOUNT RECEPTACLES/SWITCHES IN LOCATIONS THAT WOULD CONFLICT WITH MIRRORS, SEAMS OF WALLS, WAINSCOTS, TILE TRANSITIONS, ETC ...

GENERAL NOTES

THE INTENT OF THE DRAWINGS AND PROJECT MANUAL IS TO PROVIDE A COMPLETE AND FULLY OPERATIONAL ELECTRICAL SYSTEM. THE ELECTRICAL CONTRACTOR SHALL FURNISH AND INSTALL ALL LABOR. MATERIAL, AND EQUIPMENT NECESSARY TO COMPLETE THE ELECTRICAL WORK.

THE ELECTRICAL CONTRACTOR SHALL THOROUGHLY EXAMINE ALL AREAS WHERE EQUIPMENT, CONDUIT, AND WIRING WILL BE INSTALLED AND WILL REPORT ANY CONDITION THAT, IN HIS OPINION, PREVENTS THE PROPER INSTALLATION OF THE ELECTRICAL WORK.

EQUIPMENT AND MATERIALS SHALL CONFORM WITH APPROPRIATE PROVISIONS OF CSA, ULC, NEC, ASTM, UL, ETL, NEMA, ANSI, AS APPLICABLE TO EACH INDIVIDUAL UNIT OR ASSEMBLY.

ALL WORK SHALL BE PERFORMED IN STRICT ACCORDANCE WITH ALL APPLICABLE PROVINCIAL AND LOCAL CODES AND ORDINANCES. IN CASE OF CONFLICT BETWEEN THE DRAWINGS AND SPECIFICATIONS AND THE CODES, THE HIGHEST STANDARD SHALL APPLY. ELECTRICAL CONTRACTOR SHALL SATISFY CODE REQUIREMENTS AS A MINIMUM STANDARD WITHOUT ANY EXTRA COST TO STARBUCKS.

HE ELECTRICAL CONTRACTOR SHALL PROCURE AND PAY FOR ALL PERMITS, FEES, AND INSPECTIONS NECESSARY TO COMPLETE THE ELECTRICAL WORK.

HE ELECTRICAL CONTRACTOR SHALL UNCONDITIONALLY WARRANT ALL WORK TO BE FREE OF DEFECTS IN MATERIAL AND WORKMANSHIP FOR A PERIOD OF ONE (1) YEAR FROM THE DATE OF FINAL ACCEPTANCE BY STARBUCKS AND WILL REPAIR OR REPLACE ANY DEFECTIVE WORK PROMPTLY AND WITHOUT CHARGE AND RESTORE ANY OTHER EXISTING WORK DAMAGED IN THE COURSE OF REPAIRING DEFECTIVE MATERIALS AND WORKMANSHIP.

LANDLORD REQUIREMENTS

PRIOR TO BID: THE CONTRACTOR SHALL COORDINATE WITH LANDLORD / BUILDING OWNER FOR ANY CONSTRUCTION REQUIREMENTS. IF LANDLORD / BUILDING OWNER DOES HAVE REQUIREMENTS, CONTRACTOR SHALL BECOME COMPLETELY FAMILIAR WITH REQUIREMENTS AND ADHERE TO THEM. WHERE LANDLORD / BUILDING OWNER REQUIREMENTS ARE MORE STRINGENT THAN SHOWN IN THESE PLANS (IN THE OPINION OF THE ENGINEER). LANDLORD / BUILDING OWNER REQUIREMENTS SHALL GOVERN.



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STARBUCKS TEMPLATE VERSION: i2021-01-22



520 SOUTH MAIN ST, SUITE 2531 AKRON, OH 44311 P: 330-572-2100 F: 330-572-2101



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STORE #: 59763 PROJECT #: 85334-001 ISSUE DATE: For Construction

DESIGN MANAGER: ASHLEY SUEIRAS PRODUCTION DESIGNER: GPD GROUP CHECKED BY: **GPD GROUP**

Revision Schedule

Rev Date Description

ELECTRICAL NOTES


SCALE: AS SHOWN

SHEET NUMBER:

E001

SITE SCHEDULE - "Y"									
DESIGN ID COUNT DESCRIPTION FURN. BY INST. BY COMMENTS									
EXTERIOR N	ЛENU								
14116	1	MENU BOARD - DT DIGITAL ORDER SCREEN - FLAT BLACK MT0028	SB	GC	FOUNDATIONS BY GC AND CONDUITS BY LL.				
14119	1	5 PANEL MENU BOARD	SB	GC	FOUNDATIONS BY GC AND CONDUITS BY LL.				
15700	1	MENU BOARD - DT DIGITAL ORDER SCREEN CONTROL BOX	SB	GC	FOUNDATIONS BY GC AND CONDUITS BY LL.				
22542	1	MENU BOARD - DT PRE MENU SQUARE FRAME FREESTANDING - 29X61IN 735X1550MM - BLACK	SB	GC					
OTHER			•						
10020	1	DT WINDOW SHELF - 48IN 1205MM - SST	LL	LL	VENDOR: READY ACCESS				
14103	1	BOLLARD NONILLUMINATED	LL	LL	FOUNDATIONS BY LL.				
14163	1	DT ORDER POINT CANOPY FREESTANDING - FLAT BLACK MT0028	SB	GC	FOUNDATIONS BY GC AND CONDUITS BY LL.				
18815	2	BIKE RACKS	LL	LL	FOUNDATIONS BY LL.				
UMBRELLA									
12139	4	UMBRELLA - BASE 95LB 43KG - SILVER MT0021	SB	GC					
20073	4	UMBRELLA - WITHOUT VALANCE - 6FT 183CM - GREEN CANVAS WITH WORDMARK F0056	SB	GC					

EXTERIOR SIGNAGE SCHEDULE - "S"						
DESIGN ID	COUNT	DESCRIPTION	FURN. BY	INST. BY	BULB	COMMENTS
SIGNAGE - [DISK		-			,
13163	3	SIGN - DISK SF ILLUMINATED FLUSH MOUNTED EVOLVED - 48IN 1220MM	SB	GC		
X13162	1	SIGN - DISK SF NON- ILLUMINATED FLUSH MOUNTED EVOLVED - 36IN 915MM	SB	GC		
SIGNAGE - D	RIVE THR	Ú				•
14091	1	SIGN - DT DIRECTIONAL EXIT SIGN ILLUMINATED ARROW SERIES - 46IN 1170MM	SB	GC		FOUNDATIONS BY GC AND CONDUITS BY LL.
14099	3	SIGN - DRIVE THRU ILLUMINATED ARROW SERIES FLUSH MOUNTED - RH - 48IN 1220MM	SB	GC		FOUNDATIONS BY GC AND CONDUITS BY LL.
14106	1	CLEARANCE BAR	SB	GC		FOUNDATIONS BY GC.
14327	3	SIGN - DT DIRECTIONAL ILLUMINATED	SB	GC		FOUNDATIONS BY GC AND CONDUITS BY LL.
SIGNAGE - C	OTHER					
21163	1	SIGN - MOBILE ORDER PICK UP ILLUMINATED BLADE MOUNT	SB	GC		BOTTOM OF SIGN AT 8' - 6" A.F.F. VENDOR : HILTON
21297	2	SIGN - 5 MINUTE PARKING	SB	GC		FOOTING PROVIDED BY AND INSTALLED BY GC
21720	1	SIGN - MOBILE ORDER PICK UP SUSPENSION KIT	SB	GC		
SIGNAGE - V	VORDMAR	K	•			•
18497	1	SIGN - WORDMARK STARBUCKS FLUSH MOUNTED - 18IN 455MM	SB	GC		

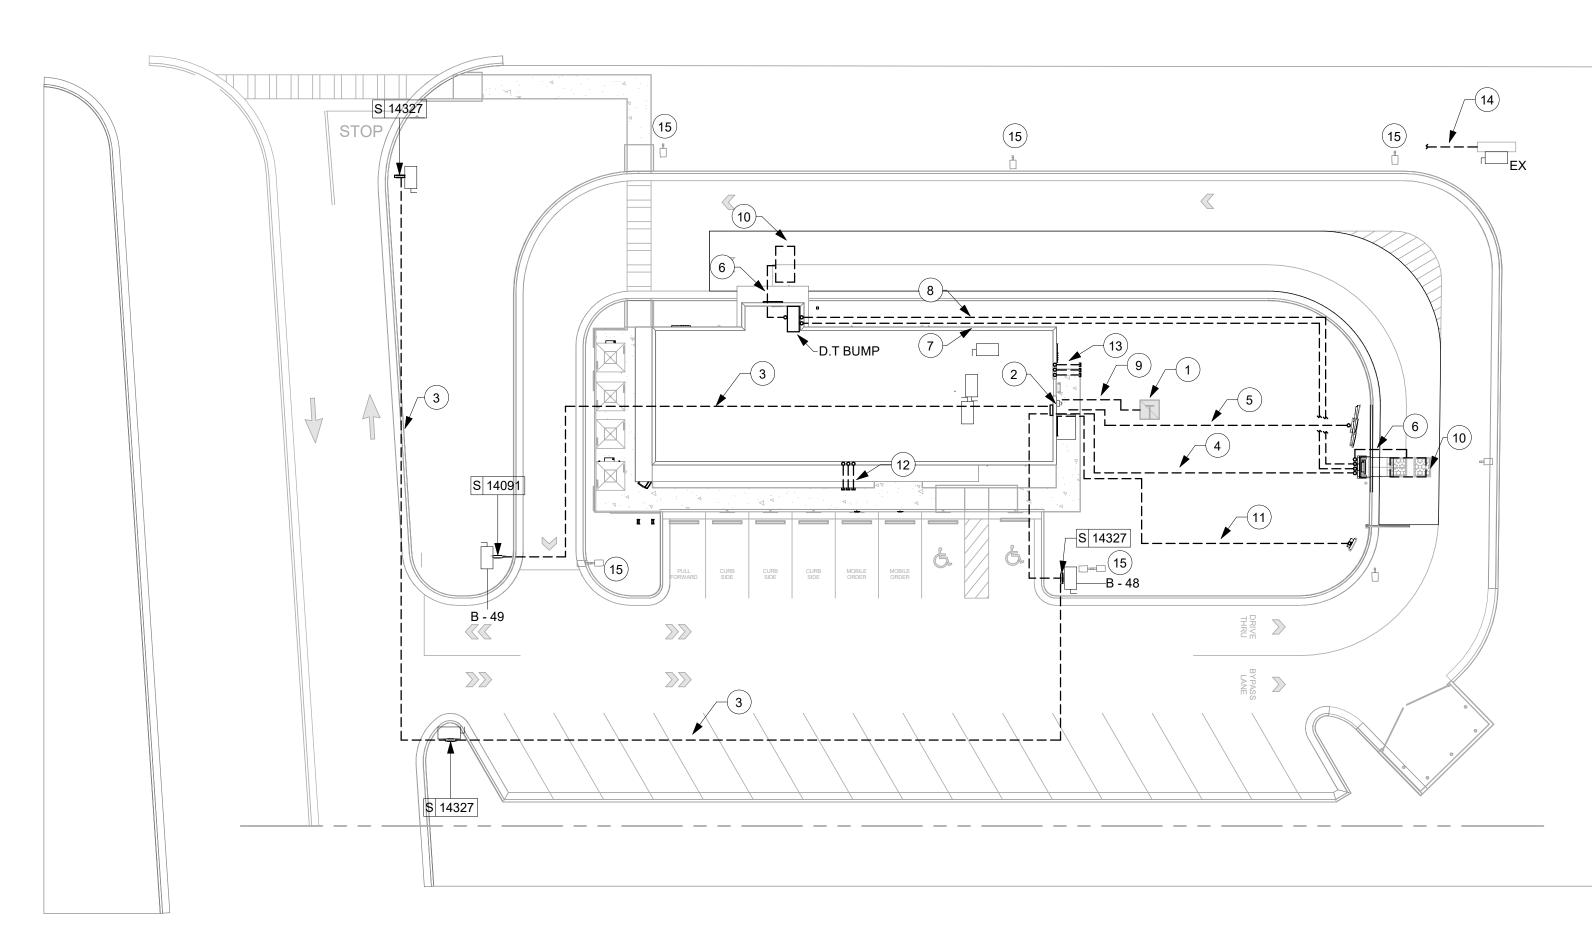

1 Scale: 1" = 20'-0"




KEYED NOTES

- 1. LOCATION OF EXISTING PAD MOUNT TRANSFORMER, BY LL.
- 2. LOCATION OF ELECTRIC METER AND CT CABINET, BY LL.
- 3. 1" CONDUIT FOR DRIVE THROUGH DIRECTIONAL SIGN, BY LL. PROVIDE (2) #10, (1) #10 GND, TO B-48.
- PROVIDE (2) #10, (1) #10 GND, TO B-49. 4. 1" CONDUIT FOR DIGITAL ORDER SCREEN, BY LL.
- 5. 1" CONDUIT FOR MENU BOARD, BY LL. PROVIDE (2) #10, (1) #10 GND, TO B-47.


PROVIDE (2) #10, (1) #10 GND, TO B-46.

- 6. 1" CONDUIT FOR DETECTOR LOOP TO BE RAN UNDERGROUND, BY LL.
- 7. DATA FOR SPEAKER. RUN 1"C UNDERGROUND TO DATA RACK. BY LL.
- 8. AUDIO/VIDEO FOR SPEAKER POST AND DETECTOR LOOP WIRING TO BE RAN THROUGH 1"C, BY LL, UNDERGROUND INTO BUILDING AND THEN ROUTED TO DT POS AREA.
- 9. (2) 3" CONDUITS WITH (4)#3/0 FROM TRANSFORMER TO CT CABINET. SEE SINGLE-LINE DIAGRAM SHEET E601, BY LL.
- 10. DETECTOR LOOP TO BE CENTERED ON DT WINDOW/ ORDER SPEAKER. COORDINATE WITH GC. TO BE 2" BELOW DT LANE PAVEMENT. BY LL.
- 11. 1" CONDUIT FOR PRE-MENU BOARD BY LL. PROVIDE (2) #10, (1) #10 GND, TO B-45.
- 12. (3) 1" SPARE CONDUITS TO RUN THROUGH FOUNDATION WALL TO FRONT OF BUILDING. ALL CONDUITS TO BE TERMINATED ABOVE CEILING. VERIFY LOCATIONS FOR STUB UPS WITH TENANT REPRESENATIVE. BY LL.
- 13. (3) 1" SPARE CONDUITS TO RUN THROUGH FOUNDATION WALL TO REAR OF BUILDING. ALL CONDUITS TO BE TERMINATED ABOVE CEILING. VERIFY LOCATIONS FOR STUB UPS WITH TENANT REPRESENTATIVE. BY LL.
- 14. 1" CONDUIT FOR MONUMENT SIGN BY LL. WIRING BY LL.
- 15. EXISTING SITE LIGHTING AND WIRING BY LL.

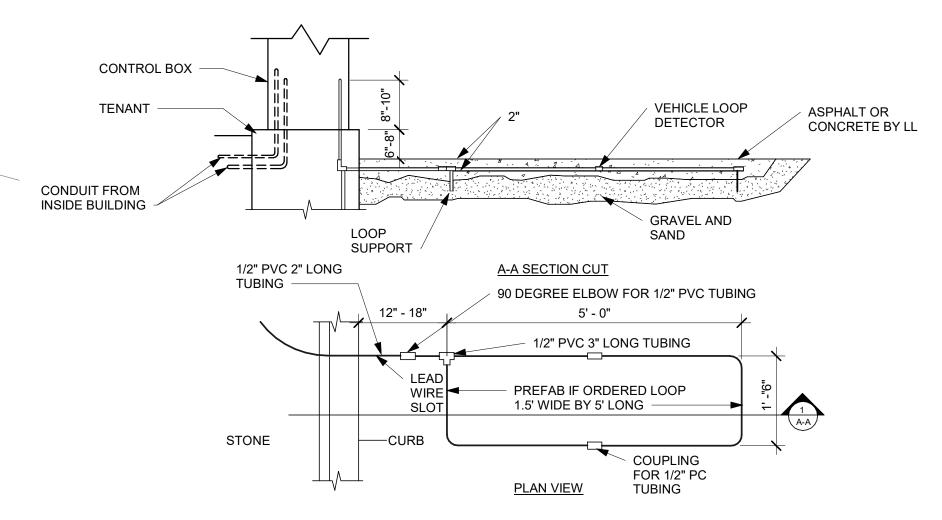

2 DT SENSOR LOOP DETAIL

Scale: NTS

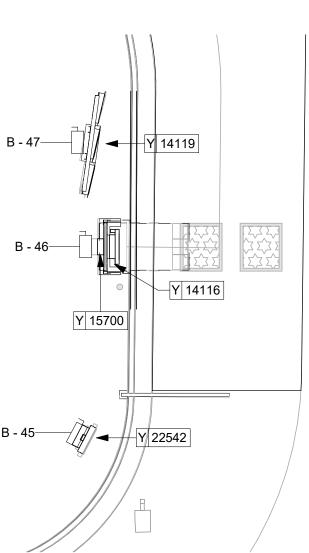

3 ENLARGED ELECTRICAL SITE PLAN

| Scale: 1/8" = 1'-0"

GENERAL NOTES

A. REFER TO DATA DEVICE SCHEDULE FOR LOW VOLTAGE DEVICES.



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STARBUCKS TEMPLATE VERSION: i2021-01-22



520 SOUTH MAIN ST, SUITE 2531 AKRON, OH 44311 P: 330-572-2100 F: 330-572-2101

GPD PROJECT NO: 040102

STORE #: PROJECT #: ISSUE DATE:

59763 85334-001 For Construction 09/01/21 ASHLEY SUEIRAS

PRODUCTION DESIGNER: GPD GROUP CHECKED BY: GPD GROUP

ELECTRICAL SITE PLAN

SCALE: AS SHOWN

SHEET NUMBER:

KITCHEN EQUIPMENT SCHEDULE								
DESIGN ID	DESCRIPTION	VOLTAGE	WATTAGE	CIRCUIT BREAKER SIZE	PANEL	CIRCUIT NUMBER	WIRE SIZE	
10267	1 DOOR UNDERCOUNTER REFRIGERATOR	120V	500	20A	В	1	2#12, 1#12G, 3/4"C	
10267	1 DOOR UNDERCOUNTER REFRIGERATOR	120V	500	20A	В	3	2#12, 1#12G, 3/4"C	
10267	1 DOOR UNDERCOUNTER REFRIGERATOR	120V	500	20A	В	15	2#12, 1#12G, 3/4"C	
10267	1 DOOR UNDERCOUNTER REFRIGERATOR	120V	500	20A	В	34	2#12, 1#12G, 3/4"C	
10267	1 DOOR UNDERCOUNTER REFRIGERATOR	120V	500	20A	В	40	2#12, 1#12G, 3/4"C	
10267	1 DOOR UNDERCOUNTER REFRIGERATOR	120V	500	20A	В	43	2#12, 1#12G, 3/4"C	
10312	BREWER SOFT HEAT WARMING STAND	120V	90	20A	В	16	2#12, 1#12G, 3/4"C	
10312	BREWER SOFT HEAT WARMING STAND	120V	90	20A	В	16	2#12, 1#12G, 3/4"C	
10312	BREWER SOFT HEAT WARMING STAND	120V	90	20A	В	16	2#12, 1#12G, 3/4"C	
10312	BREWER SOFT HEAT WARMING STAND	120V	90	20A	В	16	2#12, 1#12G, 3/4"C	
10746	DUAL BREWER SOFT HEAT	208V	8200	50A	В	18,20	3#6, 1#10G, 3/4"C	
10808	GRINDER	120V	1400	20A	В	19	2#12, 1#12G, 3/4C	
10970	1 DOOR REACH-IN REFRIGERATOR	120V	1200	20A	Α	39	2#12, 1#12G, 3/4C	
11083	2 DOOR REACH-IN REFRIGERATOR	120V	1200	20A	Α	35	2#12, 1#12G, 3/4"C	
11083	2 DOOR REACH-IN REFRIGERATOR	120V	1200	20A	Α	37	2#12, 1#12G, 3/4"C	
20032	EIKON WARMING OVEN	208V	6000	30A	В	24,26	2#10, 1#10G, 3/4"C	
20032	EIKON WARMING OVEN	208V	6000	30A	В	25,27	2#10, 1#10G, 3/4"C	
12508	ON-COUNTER BLENDER	120V	1800	20A	В	4	2#12, 1#12G, 3/4"C	
12508	ON-COUNTER BLENDER	120V	1800	20A	В	5	2#12, 1#12G, 3/4"C	
12618	1 DOOR UNDERCOUNTER REFRIGERATOR	120V	500	20A	В	23	2#12, 1#12G, 3/4"C	
12618	1 DOOR UNDERCOUNTER REFRIGERATOR	120V	500	20A	В	28	2#12, 1#12G, 3/4"C	
13682	2 DOOR REACH-IN FREEZER	120V	1160	20A	Α	40	2#12, 1#12G, 3/4"C	
13682	2 DOOR REACH-IN FREEZER	120V	1160	20A	Α	41	2#12, 1#12G, 3/4"C	
15186	DISHWASHER	208V	6344	40A	Α	31,33	3#8, 1#10G, 3/4"C	
16238	ZEPHYR FOOD CASE	208V	1000	20A	В	29,31	2#12, 1#12G, 3/4"C	
18846	ICE MACHINE	208V	3600	30A	Α	36,38	2#10, 1#100G, 3/4"C	
19559	NITROGEN GENERATOR	120V	500	20A	В	7	2#12, 1#12G, 3/4"C	
19742	MASTRENA ESPRESSO MACHINE	208V	5800	50A	В	39,41	2#6, 1#10G, 3/4"C	
19742	MASTRENA ESPRESSO MACHINE	208V	5800	50A	В	35,37	2#6, 1#10G, 3/4"C	
20010	NITRO COOLER	120V	500	20A	В	8	2#12, 1#12G, 3/4"C	

KEYED NOTES

- 1. SHOW WINDOW RECEPTACLE TO BE MOUNTED ABOVE WINDOWS.
- 2. EXTERIOR SIGNAGE. COORDINATE WITH SIGNAGE VENDOR/MANUFACTURER FOR CONNECTION AND POWER REQUIREMENTS. SEE ARCH PLANS FOR LOCATION. PROVIDE ALL PENETRATIONS AND CONNECTIONS, CONCEAL FROM VIEW. E.C. SHALL PROVIDE DISCONNECT SWITCH IF NOT PROVIDED PER CODE.
- 3. DUCT SMOKE DETECTOR. COORDINATE WITH MECHANICAL FOR QUANTITY AND HVAC INTERLOCK SHUT DOWN.
- 4. GFCI AND WP RECEPTACLE AT 18" AFF.
- 5. EXHAUST FAN. FAN TO RUN CONTINUOUSLY DURING OCCUPIED MODE. RUN THROUGH RESTROOM LIGHTING CONTROLS. COORDINATE WITH MECHANICAL.
- 6. FLOOR BOX (HUBBEL #S1CCFB OR EQUAL) WITH FLUSH FLOOR BOX COVER FOR WIRE MOLD AT COMMUNITY TABLE AND BANQUETTE. ROUTE FLEX CONDUIT TO CONNECTION POINT. SEE ARCH. DETAILS FOR LOCATION.
- 7. DT AIR CURTAIN BY LL.
- 8. DISH WASHER. E.C. SHALL PROVIDE 14-50R RECEPTACLE AND CORD @18" AFF.

- 9. MOUNT REFRIG./FREEZER RECEPTACLE AT 84" AFF.
- 10. ICE MACHINE WITH REMOTE CONDENSER (ON ROOF) COORDINATE WITH MANUFACTURER SPECS FOR REQUIREMENTS AND CONNECTION. PROVIDE A RECEPTACLE AT 72" AFF.
- 11. CO2 SENSOR AND ALARM. COORDINATE WITH MECHANICAL FOR POWER REQUIREMENTS.
- 12. THEROMSTAT AND SENSOR. PROVIDE JUNCTION BOX FOR CONNECTION.
- 13. TAMPER RESISTANT CONVENIENCE OUTLET AT 18"
- 14. POWER FOR WATER HEATER/FILTRATION SYSTEM. PROVIDE POWER FOR RECIRCULATION PUMP IN CEILING AS NEEDED AND TOGGLE SWITCH FOR DISCONNECTION MEANS. SEE INTERIOR DETAILS FOR MORE INFORMATION.
- 15. POWER AND DATA FOR FUTURE MENU BOARDS. RUN SIX ETHERNET CABLES ABOVE CEILING TO DATA RACK. PROVIDE 120V, 20A CIRCUIT FOR POWER. SEE BACKBAR MENU DETAIL FOR MORE INFORMATION.
- 16. POWER FOR RESTROOM HAND DRYERS. COORDINATE WITH MANUFACTURER SPECIFICATIONS AND INTERIOR ELEVATIONS.
- 17. POWER FOR BANQUETTE SEATING. COORDINATE WIRE REQUIREMENTS WITH MANUFACTURER.
- 18. 1" UNDERGROUND SCHED. 40PVC CONDUIT. ROUTE TO WALL AND TO ABOVE CEILING. CONDUIT AND WIRING TO BE PROVIDED BY E.C.
- 19. CO SENSOR AND ALARM. COORDINATE WITH MECHANICAL FOR POWER REQUIREMENTS.


GENERAL NOTES

- A. REFER TO ELECTRICAL DETAIL SHEETS FOR EXACT LOCATIONS AND MOUNTING HEIGHTS OF ELECTRICAL DEVICES.
- B. THE ELECTRICAL CONTRACTOR IS RESPONSIBLE FOR CONFIRMING ALL VOLTAGE REQUIREMENTS ON ALL **EQUIPMENT AND PROVIDING BUCK-BOOST** TRANSFORMERS AS MAY BE NEEDED FOR CODE. ALL ARE NOT NECESSARILY INDICATED.
- C. ELECTRICAL CONTRACTOR SHALL COORDINATE WITH PLUMBING AND HEATING, VENTILATING, AND AIR CONDITIONING (HVAC) CONTRACTORS FOR ANY ADDITIONAL EQUIPMENT NEEDING POWER.
- D. ANY EQUIPMENT NOTED AS 'FUTURE' SHALL BE PROVIDED WITH APPROPRIATE RECEPTACLES AND WIRING TO ENABLE FUTURE OPERATION.
- E. GROUND FAULT CIRCUIT INTERRUPTER (GFCI) BREAKERS (NOT RECEPTACLES) SHALL BE UTILIZED WHERE REQUIRED BY CODE AND AT ANY FLOOR BOXES. PROVIDE DEDICATED NEUTRAL WIRE FOR ALL THESE CIRCUITS.
- F. EQUIPMENT REQUIRES CONNECTION TO THE BUILDING ELECTRICAL SYSTEM. FURNISH AND INSTALL ALL NECESSARY CONDUIT, WIRE, CONNECTIONS, RECEPTACLES AND OVERCURRENT PROTECTION NECESSARY TO ENSURE THE EQUIPMENT FUNCTIONS PROPERLY AND COMPLIES WITH ALL APPLICABLE LOCAL AND NATIONAL CODES. COORDINATE EQUIPMENT REQUIREMENTS WITH MANUFACTURER CUT SHEET PRIOR TO ROUGH-IN.
- G. ALL FRONT BAR J-BOXES AND OUTLETS SHALL BE SURFACE MOUNTED. PROVIDE CONDUITS AS NEEDED AND ONE (1) ADDITIONAL SPARE CONDUIT BETWEEN ALL J-BOXES FOR FUTURE ELECTRICAL REQUIREMENTS. ALL J-BOXES SHALL BE POSITIONED TO AVOID OBSTRUCTION OF ANY EQUIPMENT SUCH AS REFRIGERATORS AND DISHWASHERS.
- H. REFERENCE LANDLORD WORK LETTER FOR DIVISION OF ELECTRICAL SCOPE OF WORK AND COORDINATE WITH STARBUCKS CONSTRUCTION MANAGER.

ELECTRICAL SCOPE OF WORK SUMMARY

THE FOLLOWING SCOPE OF WORK IS BASED ON THE LANDLORD'S WORK LETTER EXHIBIT C. THIS SCOPE OF WORK IS NOT INTENDED TO INDICATE THE FULL SCOPE, BUT ONLY A BROAD SUMMARY. THE GENERAL CONTRACTOR SHALL REFERENCE THE COMPLETE WORK LETTER FOR A MORE DETAILED DESCRIPTION OF WORK BY BOTH PARTIES. ANY QUESTIONS REGARDING SCOPE SHALL BE BROUGHT TO STARBUCKS ATTENTION FOR CLARIFICATION. RESPONSIBILITY INDICATED BELOW MEANS FURNISHED, PERMITTED AND INSTALLED BY THE PARTY INDICATED

WORK DESCRIPTION	RESPO	NSIBILITY		
WORK DESCRIPTION	LANDLORD	STARBUCKS		
MAIN BUILDING SERVICE AND POWER METER	Х			
ELECTRICAL PANELS AND FEEDERS		Х		
TEMPORARY POWER	Х			
ELECTRICAL PANEL BREAKERS		Х		
ABOVE FLOOR BRANCH CIRCUIT DISTRIBUTION		Х		
UNDER-FLOOR / SLAB POWER CONDUITS IN BUILDING (WIRING BY STARBUCKS)	Х			
UNDERGROUND SITE CONDUITS FOR DT, SIGNS, MENU BOARD, DETECTOR LOOP & DCB (WIRING CABLING BY STARBUCKS)	Х			
SITE LIGHTING	Х			
EXTERIOR BUILDING & PATIO LIGHTING	Х			
DATA & PHONE SERVICE, DMARC & (2) 2" CONDUITS TO STARBUCKS SPACE	Х			
DT WINDOW POWER	Х			
DT WINDOW EXTERIOR LIGHTS (2 EACH)	Х			
FIRE ALARM SYSTEM	Х			

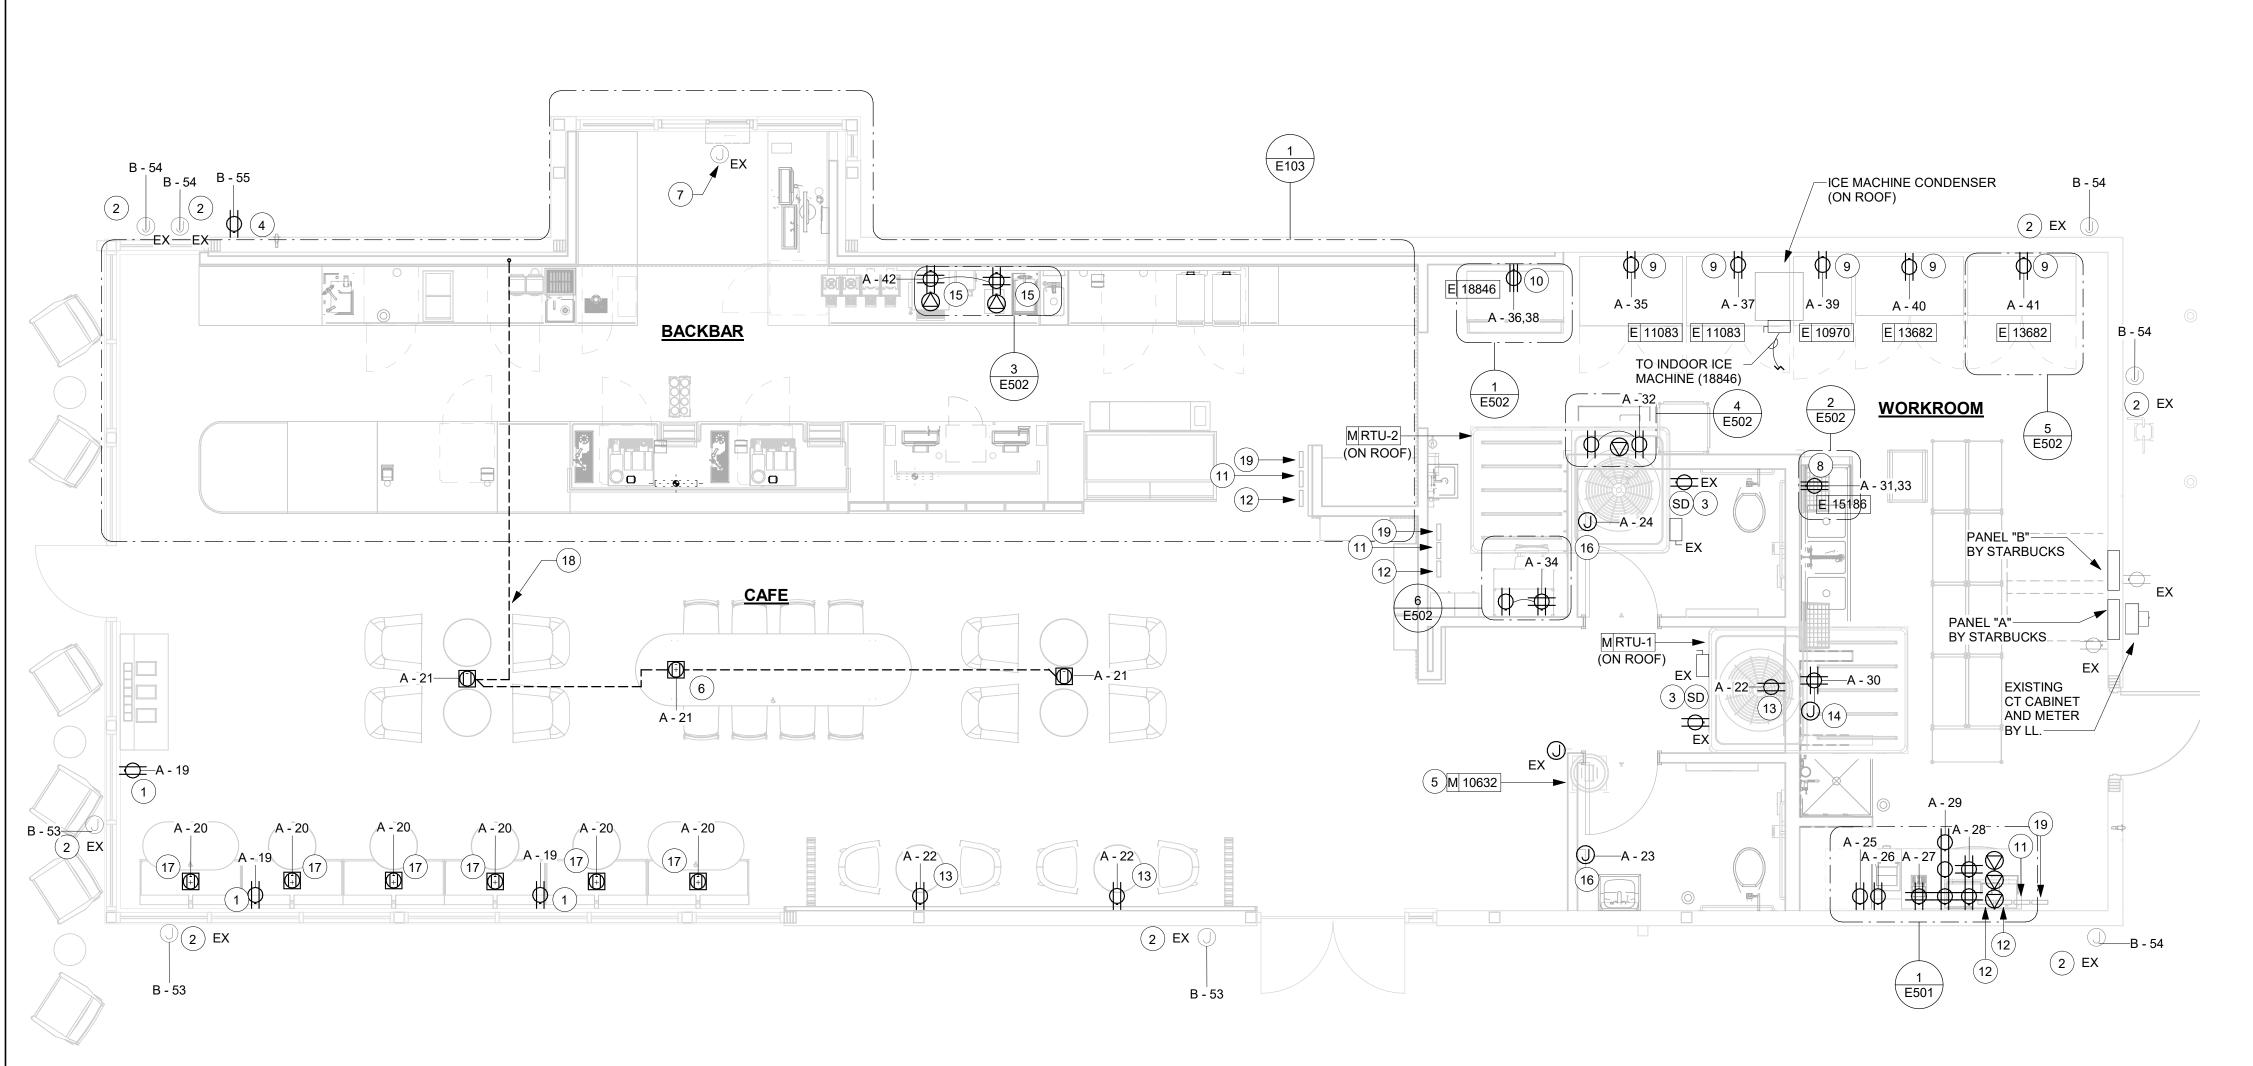



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STARBUCKS TEMPLATE VERSION: i2021-01-22



520 SOUTH MAIN ST, SUITE 2531

AKRON, OH 44311 P: 330-572-2100 F: 330-572-2101

GPD PROJECT NO: 2020261.36 040102

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STORE #: 59763 85334-001 PROJECT #: ISSUE DATE: For Construction

ASHLEY SUEIRAS PRODUCTION DESIGNER: GPD GROUP CHECKED BY: **GPD GROUP**


SHEET TITLE: POWER PLAN

SCALE: AS SHOWN

SHEET NUMBER:


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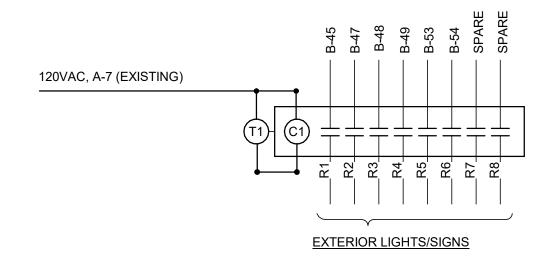
ELECTRICAL POWER PLAN



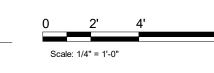


Scale: 1/4" = 1'-0"



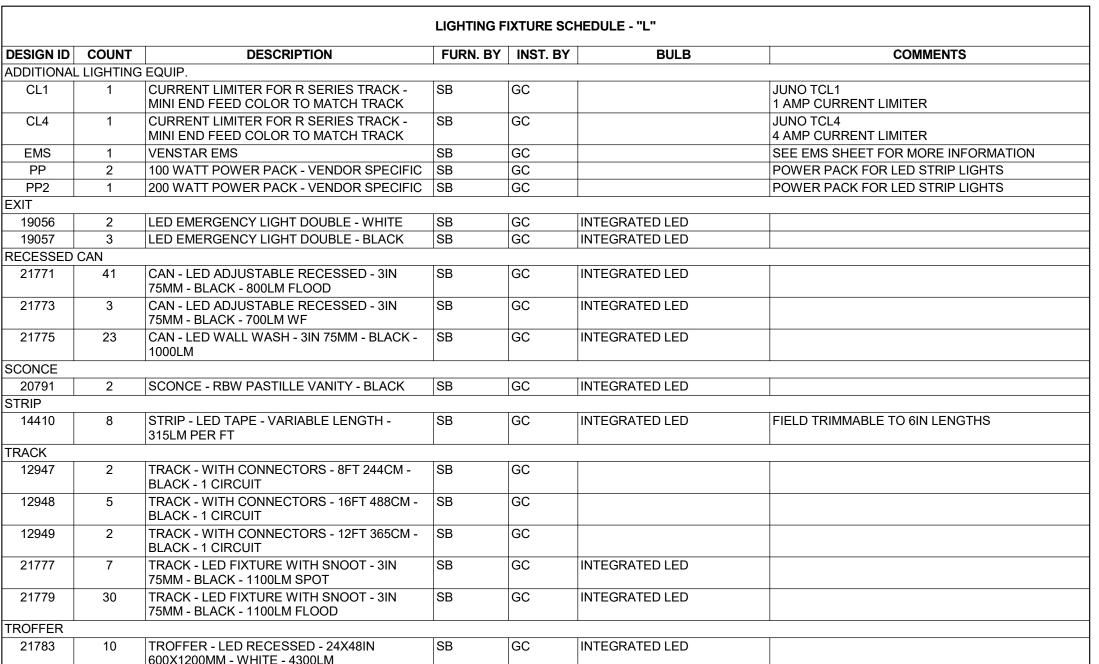

T1 - TORK #7200Z - ASTRONOMIC TIMECLOCK CONTROL: PROGRAM TO TURN ON AT 4:50 AM & OFF AT 1:00 AM (COORDINATE TIMES WITH STARBUCKS) & WITH ASTRONOMIC CONTROL TO TURN SIGNAGE OFF DURING DAYLIGHT AND ON AT DUSK.

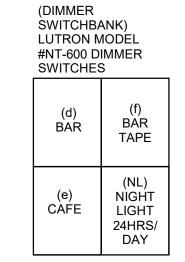

KEYED NOTES

- 1. SURFACE-MOUNT TRACK DIRECTLY TO SOFFIT.
- 2. LOCATION OF SWITCHBANK. SEE DETAIL THIS SHEET FOR MORE INFORMATION.
- 3. ALL EMERGENCY LIGHTS TO BE WIRED AHEAD OF ANY CONTROLS.
- 4. LOCATION OF VENSTAR EMS SYSTEM. ALL LIGHTING CIRCUITS TO RUN THROUGH EMS LCP. E.C. SHALL COORDINATE INSTALLATION REQUIREMENTS WITH VENSTAR SPECIFICATIONS.
- 5. EXISTING LIGHTING BY LL.
- 6. ASTRONOMIC TIME CLOCK. SEE DETAIL THIS SHEET FOR MORE INFORMATION. VERIFY IN FIELD.
- 7. POWER PACK FOR COVE LED LIGHTING. E.C. SHALL COORDINATE WITH MANUFACTURER SPECIFICATIONS FOR INSTALLATION REQUIREMENTS. VERIFY LOCATION IN FIELD.
- 8. MOP SIGN TO BE POWERED AND CONTROLLED WITH BAR LIGHTING CIRCUIT.

GENERAL NOTES

- A. ALL FIXTURES IN WORK ROOM, BACK AND FRONT LINE. ABOVE CONDIMENT CART, AND ANY OTHER AREAS WHERE EXPOSED FOOD, CLEAN EQUIPMENT OR UTENSILS. OR UNWRAPPED SINGLE SERVICE ITEMS WILL BE EXPOSED, SHALL HAVE SHATTERPROOF LAMPS IF THE FIXTURE IS NOT LENSED. ARCHITECT OF RECORD TO INCLUDE APPROPRIATE LAMPS / FIXTURES ON DRAWINGS AND SCHEDULES, AND COMPLY WITH ANY ADDITIONAL JURISDICTIONAL LIGHTING REQUIREMENT.
- B. PROVIDE GROMMET AT ALL CEILING PENETRATIONS FOR FIXTURES/SUPPORTS.
- C. CENTER EMERGENCY/EXIT LIGHTS ABOVE DOORS. UNLESS OTHERWISE NOTED.
- D. ADJUST FOCUS OF ALL TRACK AND RECESSED DIRECTIONAL LIGHTING TO FULLY ILLUMINATE ALL ARTWORK, MENU BOARDS, AND MERCHANDISE BAYS. COORDINATE AIMING WITH OWNER.
- E. IF PENDANT CYLINDERS SUSPENDED LENGTH EXCEEDS 48" (1220MM) FROM CEILING, REPLACE WITH SURFACE MOUNTED CYLINDER CANS AND SUSPEND WITH GENERAL CONTRACTOR SUPPLIED CONDUIT AND J-BOX TO INDICATED HEIGHT.

EGRESS LIGHTING NOTES

1) AISLES AND UNENCLOSED EGRESS STAIRWAYS IN ROOMS AND SPACES THAT REQUIRE TWO OR MORE

AND EXIT PASSAGEWAYS IN BUILDINGS REQUIRED TO HAVE TWO OR MORE EXITS.

THE LEVEL OF EXIT DISCHARGE UNTIL EXIT DISCHARGE IS ACCOMPLISHED FOR BUILDINGS REQUIRED TO HAVE TWO OR MORE EXITS.

PERMITTED IN SECTION 1027.1 IN BUILDINGS REQUIRED TO HAVE TWO OR MORE EXITS.

1008.1.6 EXIT DISCHARGE DOORWAYS IN BUILDING REQUIRED TO HAVE TWO OR MORE EXITS.

E. EMERGENCY LIGHTING FACILITIES SHALL BE ARRANGED TO PROVIDE INITIAL ILLUMINATION THAT IS AT LEAST AN AVERAGE OF 1 FOOT CANDLE (11 LUX) AND A MINIMUM AT ANY POINT OF 0.1 FOOT CANDLE (1 LUX) MEASURED ALONG THE PATH OF EGRESS AT FLOOR LEVEL. A MAXIMUM TO MINIMUM ILLUMINATION UNIFORMITY




- A. EXIT SIGNS SHALL BE INTERNALLY ILLUMINATED, LISTED AND LABELED IN ACCORDANCE WITH UL 924 AND INSTALLED IN ACCORDANCE WITH THE MANUFACTURER'S INSTRUCTIONS.
- B. ANYTIME A BUILDING OR A PORTION OF A BUILDING IS OCCUPIED, THE MEANS OF EGRESS SERVING THE OCCUPIED PORTION SHALL BE ILLUMINATED AT AN INTENSITY OF NOT LESS THAN 1 FOOT CANDLE (11 LUX) AT THE WALKING SURFACE LEVEL. (1006)
- ILLUMINATION SHALL BE PROVIDED BY THE PREMISE'S ELECTRICAL SUPPLY, IN THE EVENT OF POWER SUPPLY FAILURE, ILLUMINATION SHALL BE AUTOMATICALLY PROVIDED FROM AN EMERGENCY SYSTEM FOR THE FOLLOWING AREAS. (1006.3):

3) EXTERIOR EGRESS COMPONENTS AT OTHER THAN

4) INTERIOR EXIT DISCHARGE ELEMENTS, AS

5) EXTERIOR LANDINGS. AS REQUIRED BY SECTION

- D. THE EMERGENCY POWER SYSTEM SHALL ALSO BE CONNECTED TO AN EMERGENCY ELECTRICAL SYSTEM WHICH IS TO PROVIDE CONTINUED ILLUMINATION FOR A DURATION OF NOT LESS THAN 1 1/2 HOUR IN CASE OF PRIMARY POWER LOSS. CONTINUED ILLUMINATION IS TO BE PROVIDED FROM STORAGE BATTERIES, UNIT EQUIPMENT OR AN ON-SITE GENERATOR AND THE INSTALLATION OF THE EMERGENCY POWER SYSTEM SHALL BE INSTALLED IN ACCORDANCE WITH THE

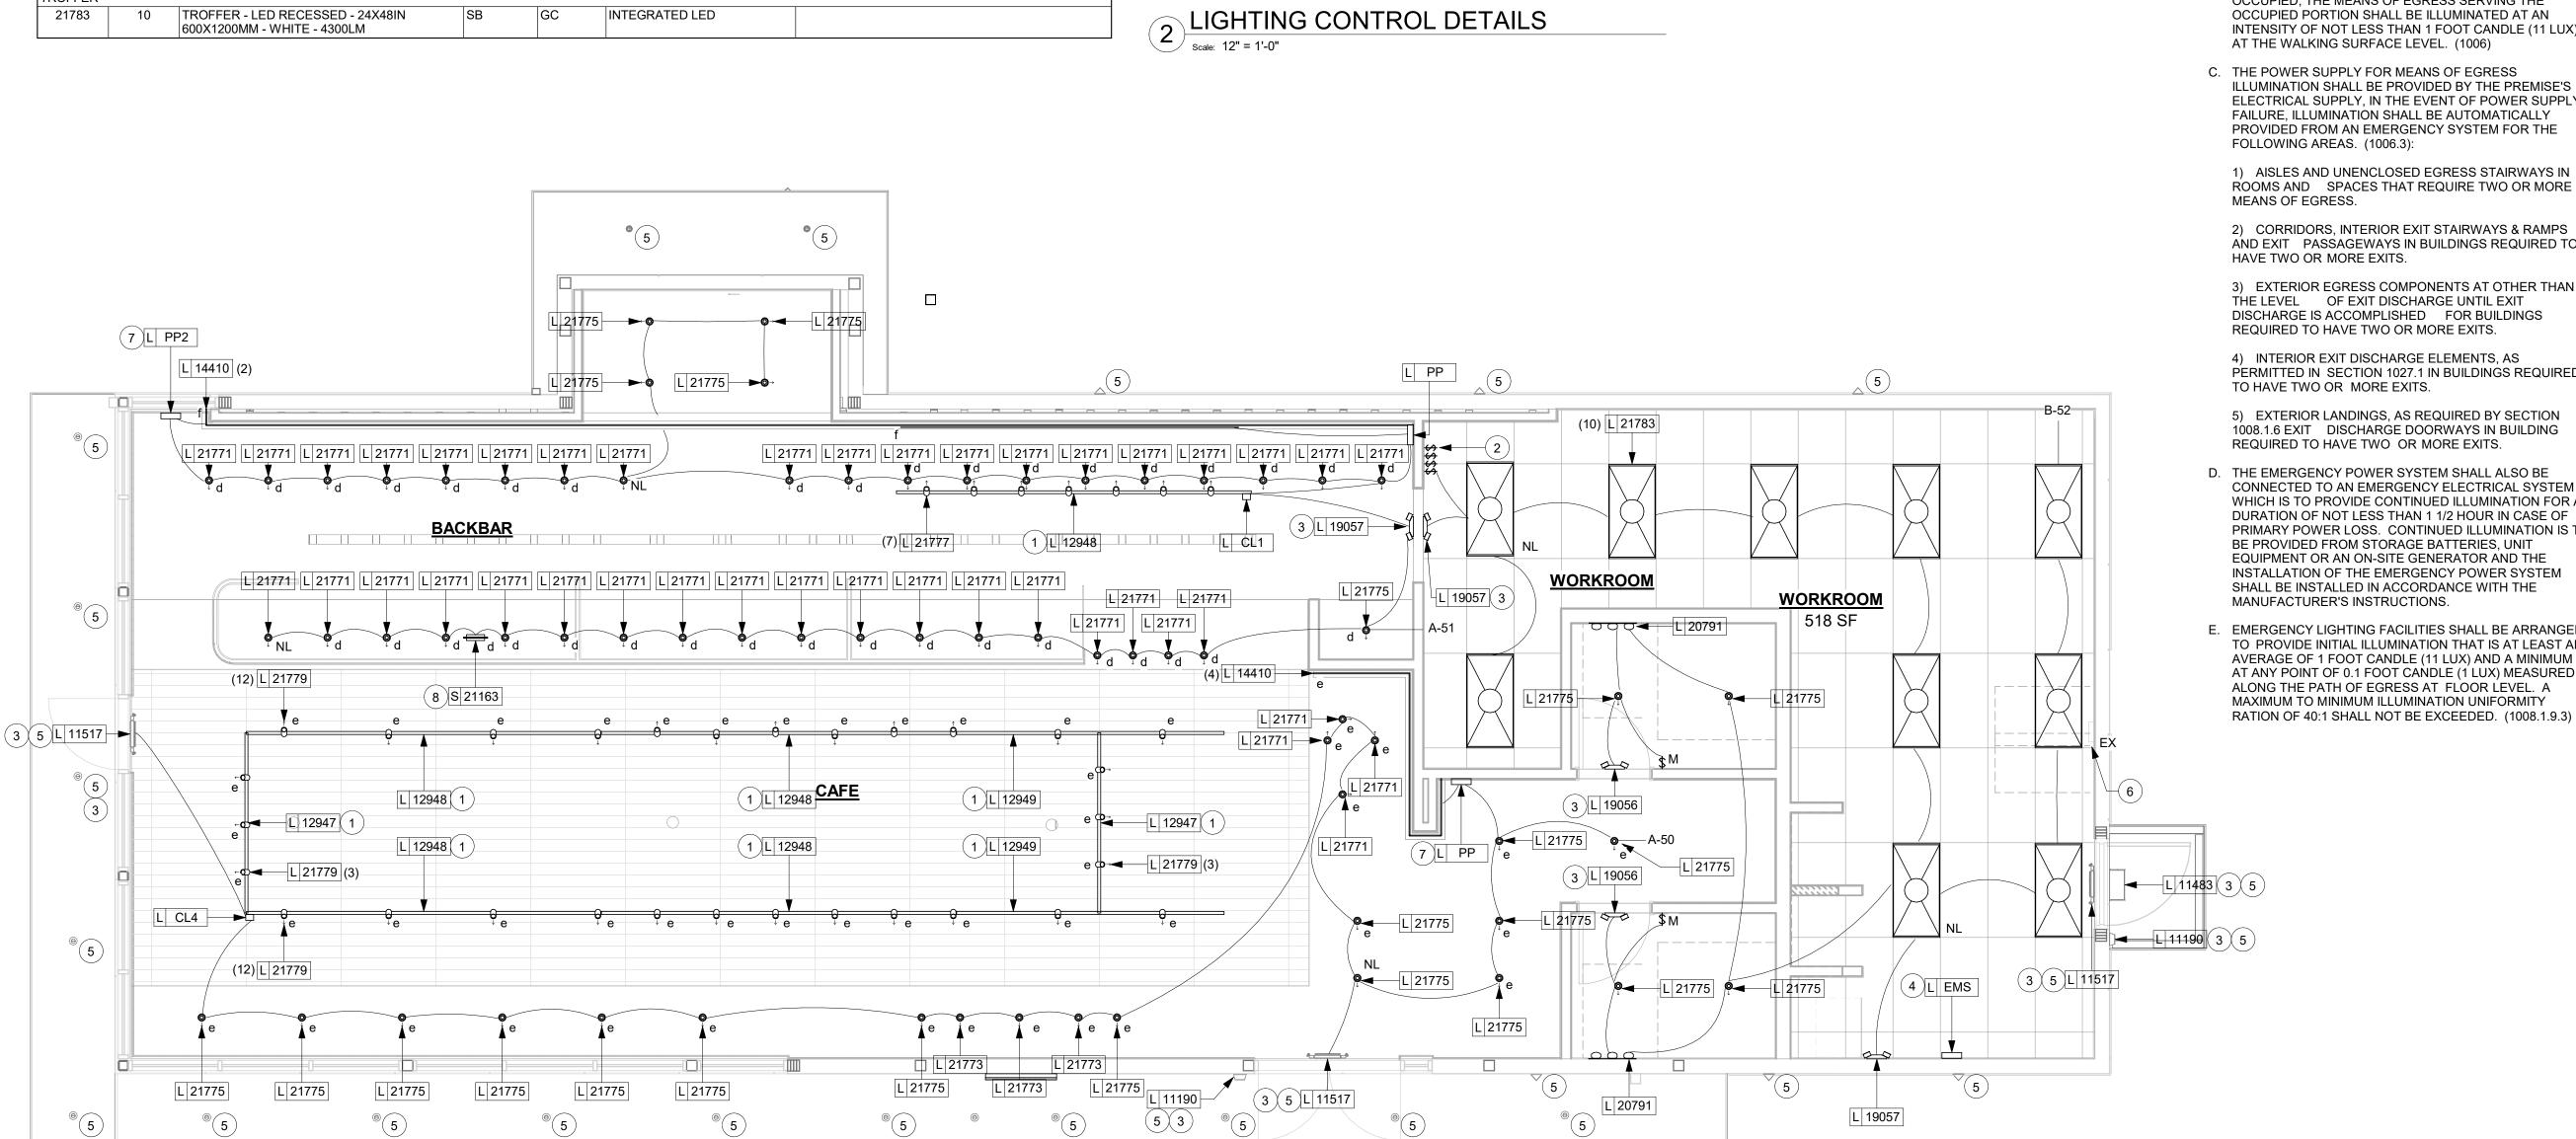

REFLECTED CEILING PLAN



Revision Schedule

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STARBUCKS TEMPLATE VERSION: i2021-01-22

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GPD PROJECT NO:

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PROJECT #:

DESIGN MANAGER:

520 SOUTH MAIN ST, SUITE 2531

2020261.36

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PROJECT 2778 CAMI

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For Construction

GPD GROUP

ASHLEY SUEIRAS

AKRON, OH 44311 P: 330-572-2100 F: 330-572-2101

LIGHTING PLAN

SCALE: AS SHOWN SHEET NUMBER:

KEYED NOTES

- NEMA 6-30R RECEPTACLE AT 26" AFF FOR WARMING OVENS.
- 2. RECEPTACLE AT 26" AFF FOR UNDERCOUNTER REFRIGERATOR.
- 3. RECEPTACLE AT 26" AFF FOR CUP LABELER/GENERAL
- 4. RECEPTACLE AT 26" AFF FOR GRINDER AND SCALE.
- 5. NEMA 6-50R RECEPTACLE AT 26" AFF FOR TWIN BREWER.
- 6. RECEPTACLE AT 26" AFF FOR BREWER WARMERS.
- 7. RECEPTACLE AT 26" AFF FOR INSTA HOT TAP.
- 8. RECEPTACLE AT 26" AFF FOR FUTURE/GENERAL USE.
- 9. RECEPTACLE AT 26" AFF FOR TICKET PRINTER.
- 10. RECEPTACLE AT 26" AFF FOR BLENDERS.
- 11. RECEPTACLE AT 26" AFF FOR NITRO FRIDGE AND GENERATOR.
- 12. RECEPTACLE AT 26" AFF FOR RINSE SINK.
- 13. LOCATION OF STUB UP PENETRATION AREA.14. 6-50R RECEPTACLE AT 26" AFF FOR ESPRESSO MACHINE.
- 15. RECEPTACLE AT 26" AFF FOR UNDERCOUNTER REFRIGERATOR/HOT TAP
- 16. RECEPTACLE AT 18" AFF FOR POS.
- 17. POWER FOR CASE/FOOD LIGHT.
- 18. RECEPTACLES/DATA AT VARYING HEIGHTS SEE ELEVATION DETAIL E-501.
- 19. DATA AT 26" AFF. (TYP)
- 20. DATA AT 18" AFF.
- 21. RECEPTACLES FOR CAFE TO BE BLACK. RECEPTACLES FOR WORKROOM TO BE WHITE WITH STAINLESS STEEL COVER PLATES.

GENERAL NOTES

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 BREAKERS (NOT RECEPTACLES) SHALL BE UTILIZED
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- G. ALL FRONT BAR J-BOXES AND OUTLETS SHALL BE SURFACE MOUNTED. PROVIDE CONDUITS AS NEEDED BETWEEN ALL J-BOXES FOR ELECTRICAL REQUIREMENTS. ALL J-BOXES SHALL BE POSITIONED TO AVOID OBSTRUCTION OF ANY EQUIPMENT SUCH AS REFRIGERATORS AND DISHWASHERS.



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P: 330-572-2100 F: 330-572-2101 ROJECT NO: 202



DDRESS:

STORE #:

PROJECT #: 85334-001

ISSUE DATE: For Construction 09/01/21

DESIGN MANAGER: ASHLEY SUEIRA

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DESIGN MANAGER: ASHLEY SUEIRAS PRODUCTION DESIGNER: GPD GROUP CHECKED BY: GPD GROUP

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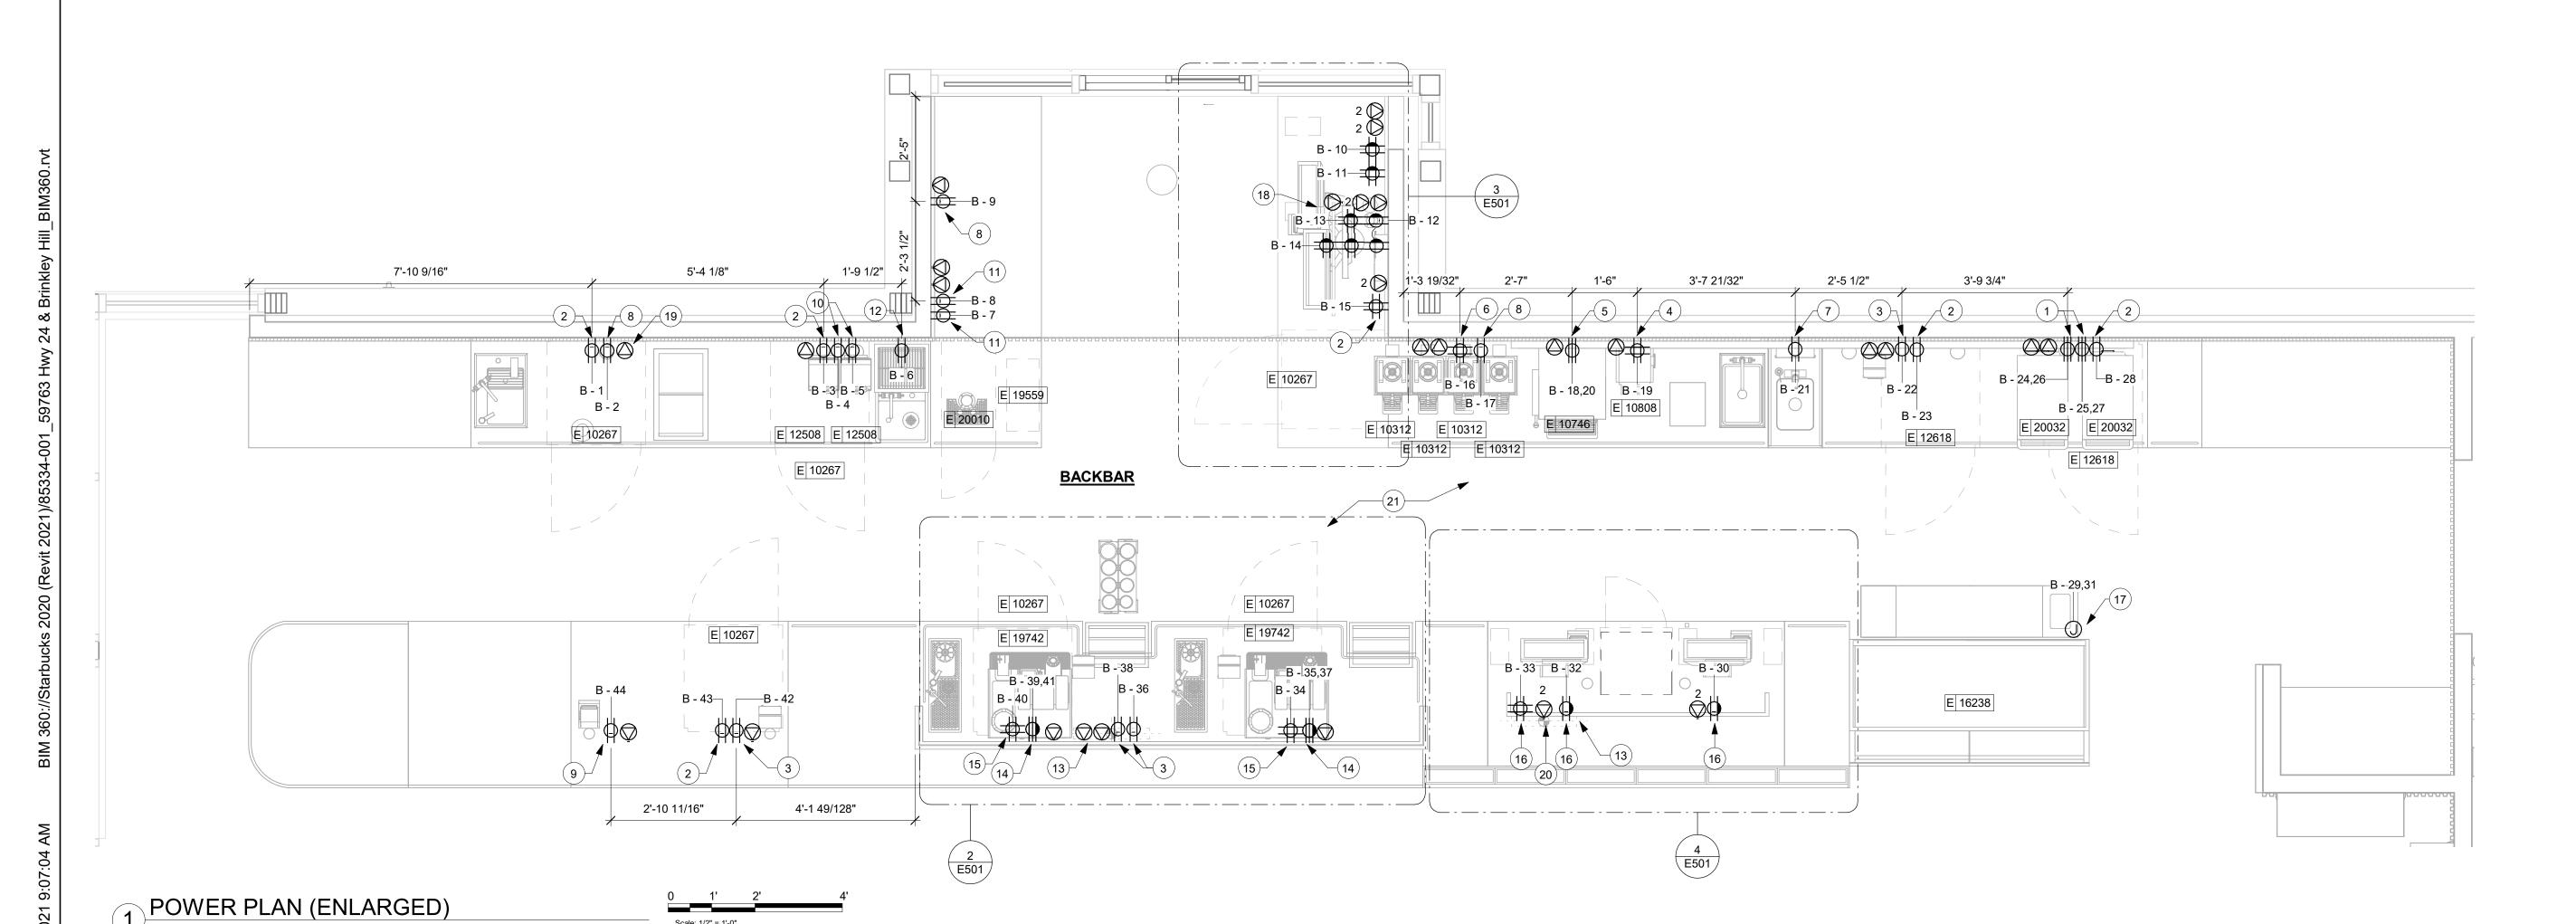
Rev Date By Description

SHEET TITLE:

ENLARGED ELECTRICAL PLACEMENT PLAN

SCALE: AS SHOWN

SHEET NUMBER:



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DATA DEVICE SCHEDULE - "A"						
DESIGN ID	COUNT	DESCRIPTION	FURN. BY	INST. BY	COMMENTS	
AUDIO VISU	AL			•		
10005	1	MUSIC SYSTEM	SB	GC		
10010	1	DT ORDER MONITOR	SB	SB		
10012	1	DT COMMUNICATION SYSTEM	SB	SB		
10013	5	DT QUEUE CAMERA	SB	SB		
10015	3	SPEAKER RECESSED - WHITE	SB	GC		
10017	2	SPEAKER SURFACE MOUNTED	SB	GC		
12336	1	DT TIMER SYSTEM	SB	SB		
14676	1	DT POS MONITOR ARM DOUBLE SURFACE MOUNTED	SB	SB		
19339	1	AMPLIFIER - 40W	SB	GC		
DATA				'		
10002	1	COMPUTER MANAGER WORKSTATION	SB	SB		
10007	1	PRINTER MANAGER WORKSTATION	SB	SB		
20294	4	IOT MODULE	SB	SB		
POINT OF S	ALE			•		
10008	2	POS - REGISTER WITH COMPACT CASH DRAWER	SB	SB		
10014	4	POS PRINTER	SB	SB		
10022	1	MONEY COUNTER	SB	SB		
10029	6	POS BANK	SB	GC		
10075	4	CUP LABELER	SB	SB		
14677	1	POS - DT TENDERING REGISTER	SB	SB	PART OF RETAIL IT EQUIPMENT PACKAGE	
14678	1	POS - DT EXPEDITOR	SB	SB	PART OF RETAIL IT EQUIPMENT PACKAGE	
SECURITY		-1		1	,	
10024	1	SAFE LH - 20X18X26IN 510X455X660MM	SB	SB		
10028	1	SAFE BASE	SB	SB		

WORKSTATION. A 10010 A 10012 A 10014 -A 20294 A 10029 A 20294 A 10029 A 12336 A 14676 A 14677 A 14678 BACKBAR (2)A 10017 $| \begin{picture}(20,0) \put(0,0){\line(1,0){11}} \put(0$ WORKROOM (11) 8 A 10075 8 A 10075 A 10008 A 10008 A 10014 A 10014 A 10029 A 10029 A 10014 8 A 10075 A 20294 A 10029 A 10029 1 A 10015 A 10005 A 19339 - 3 S - 12 5 14 (4)

KEYED NOTES

SOUND SYSTEM

- 1. RECESSED SPEAKER: COLOR TO BE BLACK OR PAINT TO MATCH ADJACENT FINISH.
- 2. WALL MOUNT SPEAKERS: MOUNT AT 12' (3660MM) A.F.F. OR AS CEILING HEIGHT PERMITS. COLOR TO BE BLACK OR PAINT TO MATCH ADJACENT FINISH.
- 3. AMPLIFIER: LOCATE ON SHELVING ABOVE MANAGER'S WORKSTATION.

DATA & PHONE

- 4. DEMARC 1 & 2 CABLES: TERMINATE AND LABEL BOTH ENDS TO JACKS IN SMB (SURFACE MOUNT BOX). EXTEND CABLES TO DEMARCATION POINT OR IF NOT DEMARC PRESENT, COIL 10' (3050MM) SERVICE LOOP ABOVE CEILING FOR FUTURE CONNECTION.
- 5. PATCH PANEL (DATA RACK): CHECK INSTALL GUIDE FOR SPECIFICS ON CABLING AND LOCATION.
- 6. DRIVE THRU CABLE (SHIELDED 20 GA 4 CONDUCTOR): MICROPHONE AND SPEAKER CABLES - CABLES SERVICE LOOPED IN DATA BOX ABOVE HIGHEST SHELF OR ABOVE CEILING AND RUN FROM THIS LOCATION TO DT LANE OUTSIDE OF BUILDING (SEE SITE PLAN FOR MORE INFORMATION).
- 7. DRIVE THRU CABLES (CAT6 BURIAL GRADE): CABLES FOR DIGITAL ORDER SCREEN, CAMERA AND SPARE LOCATED BELOW COUNTER AND RUN FROM THIS LOCATION TO DRIVE THRU LANE OUTSIDE OF BUILDING. SEE SITE PLAN FOR MORE INFORMATION.

8. CUP LABELERS.

SECURITY

- 9. SECURITY CAMERA: CEILING MOUNT TYPICAL IN OPEN CEILING CONDITION. LOCATE B.O. CAMERA AT SAME HEIGHT AS STORE LIGHTING.
- 10. DRIVE THRU CAMERA: LOCATE 6' (1830MM) TO 8' (2440MM) FROM WINDOW WITH CLEAR VIEW OF CUSTOMER AND DT POS.
- 11. PIR MOTION DETECTOR REQUIRED PER STORE: (1) BEHIND BAR NEAR POS (1) CENTRALLY LOCATED IN CAFE (1) AT MANAGER'S WORKSTATION (1) CENTRALLY LOCATED IN BOH
- 12. ALARM KEYPAD: LOCATED WITHIN 10' (3050MM) OF EMPLOYEE ENTRANCE, MOUNTED AT 3'-6" (1070MM)
- 13. DOOR POSITION SWITCH: LOCATE (1) AT EACH DOOR
- 14. LOCATE SECURITY HEAD UNIT AT MANAGER'S

GENERAL NOTES

MUSIC SYSTEM

- A. THE GENERAL CONTRACTOR SHALL INSTALL SPEAKERS AND WIRING PER VENDOR'S DRAWINGS.
- B. THE GENERAL CONTRACTOR SHALL INSTALL THE MUSIC SYSTEM, CONNECT WIRING AND TEST..
- C. SPEAKER PLACEMENT: LOCATE (1) PER 250 S.F. (23 S.M.) OF CAFE SPACE AT 14' (4270MM) MIN. TO 18' (5490MM) MAX. O.C.
- D. SPEAKER PAINTING: SPEAKER GRILLS CAN BE PAINTED. NOTE: ALL GRILL HOLES SHALL REMAIN OPEN.

LOW VOLTAGE CABLING

- E. G.C. TO PROVIDE PATHWAYS FOR ALL DATA AND LOW VOLTAGE CABLING DEVICES. CONDUITS CONTAINING MULTIPLE CABLES SHALL BE UPSIZED FOR FUTURE CAPACITY (1" (25MM) TYPICAL).
- F. PROVIDE LABELED END-TO-END PULL STRINGS RATED TO 25 LBS (11.33 KG) IN ALL CONDUITS.
- G. CONDUIT BEND RADIUS SHALL BE A MINIMUM OF 5X THE CONDUIT'S INTERNAL DIAMETER.
- H. TERMINATE CONDUITS THAT EXTEND THROUGH SLAB AT A MINIMUM OF 3" (76MM).
- I. FLEX CONDUIT IS GENERALLY UNACCEPTABLE FOR USE AS A COMMUNICATIONS CONDUIT **EXCEPT** AT SEISMIC JOINTS.
- J. ALL SUB-SLAB CONDUITS SHALL BE INSTALLED IN A MANNER THAT PREVENTS WATER INFILTRATION OF THE CONDUIT. IT IS THE GENERAL CONTRACTOR'S RESPONSIBILITY TO ENSURE RAIN WATER OR CONSTRUCTION WATER IS PREVENTED FORM ENTERING AND/OR REMOVED FROM CONDUIT PRIOR TO PLACEMENT OF CABLES.
- K. ALL PULL BOXES SHALL BE SIZED AND INSTALLED PER ANSI/TIA/EIA-569-A. PULL BOXES FOR UNDERGROUND CONDUITS ARE NOT PERMITTED UNLESS OTHERWISE

BROADBAND CABLE

MAIN POINT OF ENTRY: GENERAL CONTRACTOR TO PROVIDE 2" (50MM) MINIMUM CONDUIT PATH FROM THE BUILDING'S MAIN POINT OF ENTRY (MPOE) TO THE CEILING ABOVE THE MANAGER'S WORKSTATION. THE INTERNET SERVICE PROVIDER (ISP) WILL DESIGNATE THE START AND END LOCATIONS FOR

THE CONDUIT AND ANY BACKBOARD, GROUNDING AND

<u>SECURITY</u>

POWER REQUIREMENTS.

- M. ENTRY CAMERA: CAPTURE ENTIRE DOORWAY AND CUSTOMER TOP OF HEAD TO KNEES. PROVIDE (1) CAMERA AT EACH POINT OF ENTRY.
- N. POS CAMERA: PRIMARY OBJECTIVE IS CUSTOMER. SECONDARY IS POS. IDEAL PLACEMENT IS TO CAPTURE BOTH.
- O. SAFE CAMERA: POSITION TO VIEW FROM HANDLE SIDE OF DOOR. POS CAMERA CAN BE USED WHEN SAFE IS LOCATED BELOW TERMINALS.
- P. DRIVE THRU CAMERA: PRIMARY OBJECT IS CUSTOMER. SECONDARY IS POS. IDEAL PLACEMENT IS TO CAPTURE BOTH.
- Q. BOH CAMERA: CAPTURE CASH HANDLING AREA.
- R. CARBON MONOXIDE: PROVIDE (1) MINIMUM CARBON MONOXIDE (CO) DETECTOR LOCATED IN THE BACK OF HOUSE. PROVIDE SECOND DETECTOR IN CAFE AREA IF SPACE INCLUDES A FIREPLACE.

LOW VOLTAGE **ELECTRICAL SYMBOLS LEGEND**

- (CO) CARBON MONOXIDE DETECTOR
- WIRELESS DOOR POSITION SWITCH

WIRELESS PIR MOTION SENSOR

- SECURITY KEY PAD
- LEC LOCAL EXCHANGE CARRIER (DEMARCATION POINT)
- WI-FI ACCESS POINT

DATA PORT RECEPTACLE KEY

+ [HEIGHT A.F.F.]
PORT NAME





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BOTH PARTIES.



520 SOUTH MAIN ST, SUITE 2531 AKRON, OH 44311 P: 330-572-2100 F: 330-572-2101

GPD PROJECT NO:



 \pm BRINKL PROJECT ADDRES 2778 NC-24 CAMERON,

28326

S

59763

85334-001

STORE #: PROJECT #: ISSUE DATE: **DESIGN MANAGER:**

For Construction ASHLEY SUEIRAS PRODUCTION DESIGNER: GPD GROUP CHECKED BY: GPD GROUP

Rev Date By Description

DATA DEVICE PLAN


SCALE: AS SHOWN

SHEET NUMBER:

E104

DATA DEVICE PLAN Scale: 1/4" = 1'-0"

2 A 10017

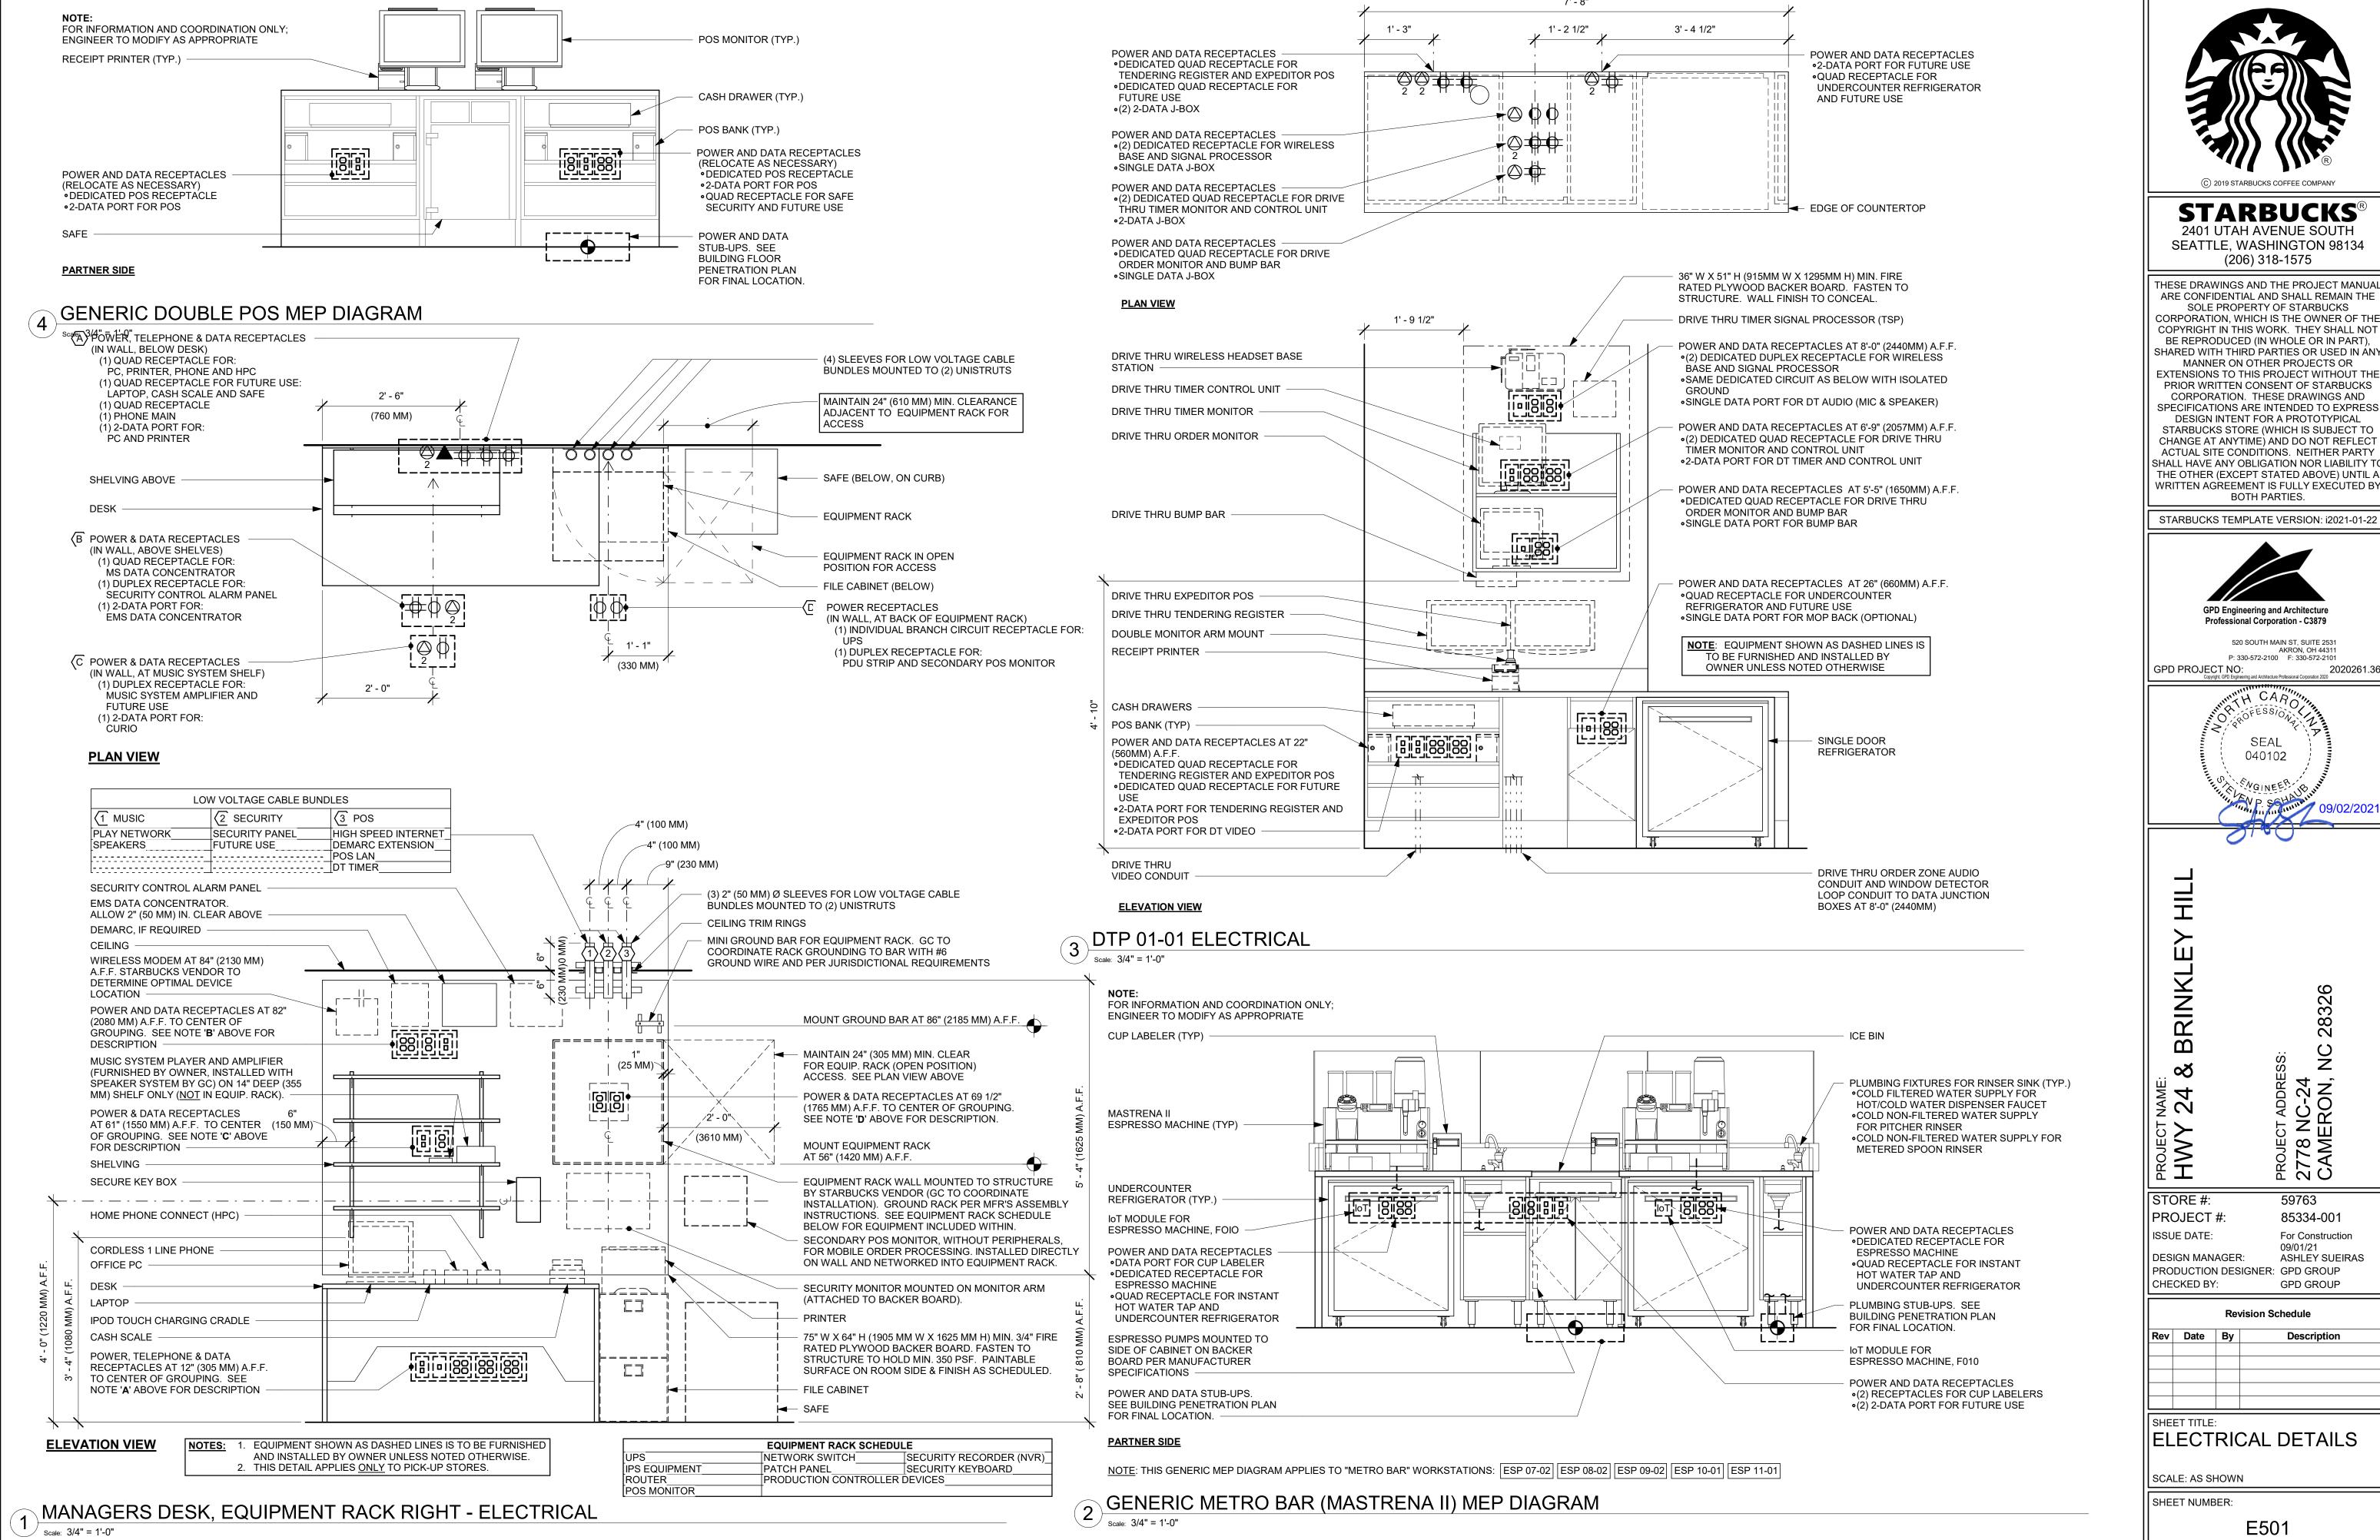


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GPD PROJECT NO:



STORE #: 59763 85334-001 PROJECT #: ISSUE DATE: For Construction DESIGN MANAGER: ASHLEY SUEIRAS

PRODUCTION DESIGNER: GPD GROUP CHECKED BY: GPD GROUP

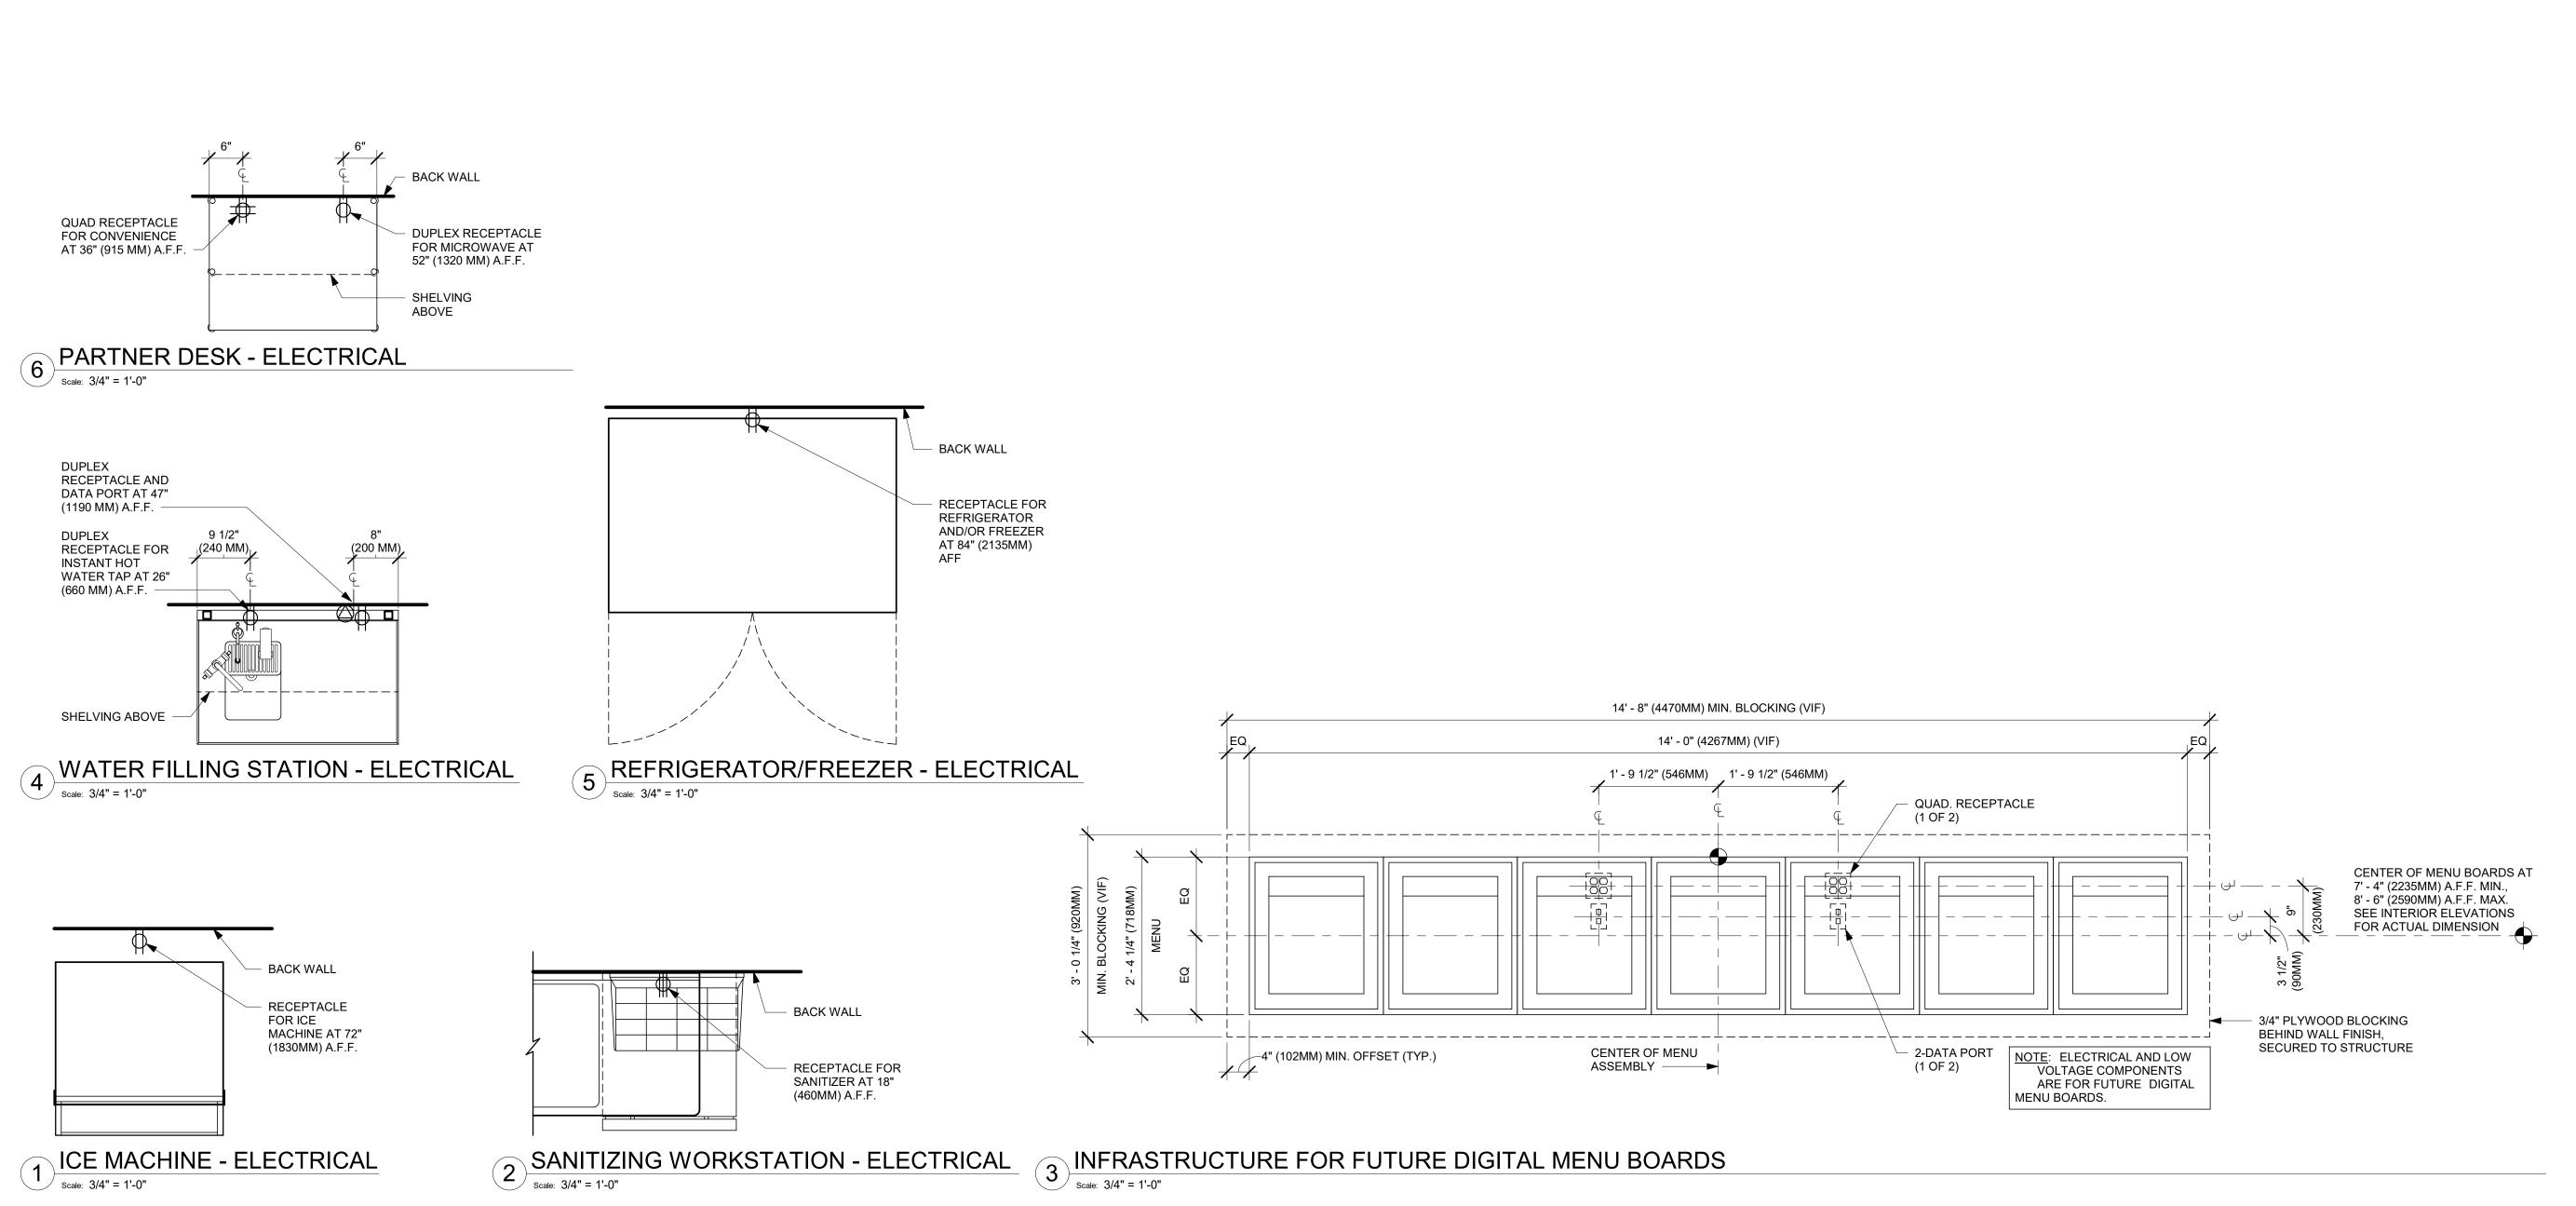Revision Schedule

Description

ELECTRICAL DETAILS


SCALE: AS SHOWN

SHEET NUMBER:




TO NETWORK Venstar EMS - No Lighting Control - Data Concentrator

Scale: N.T.S

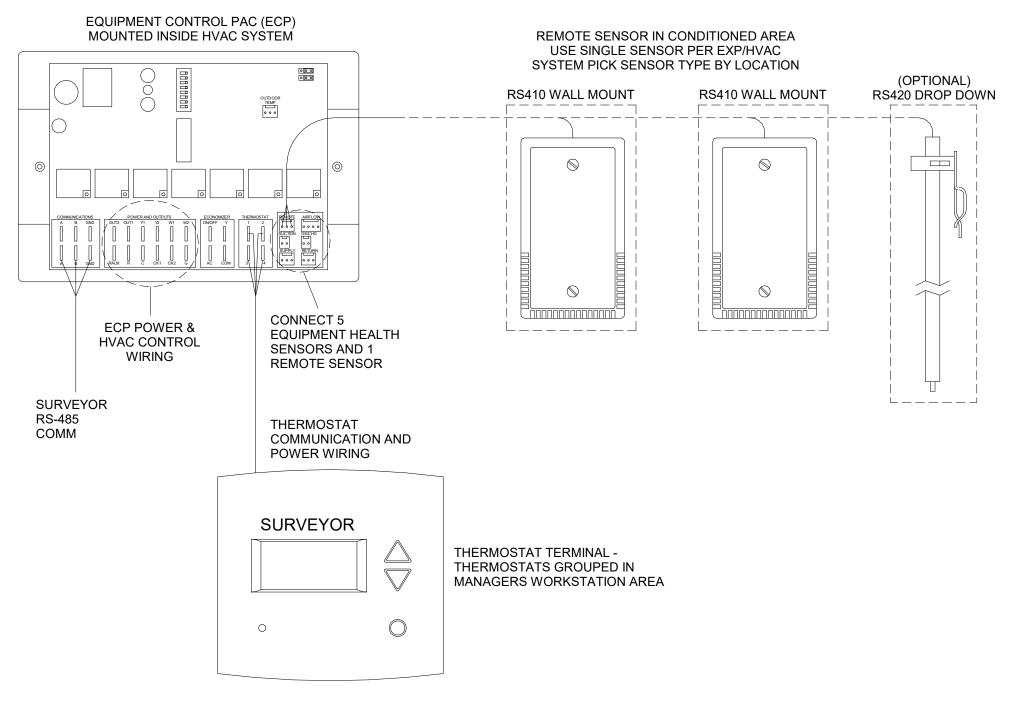


- 1. OUTDOOR TEMPERATURE SENSOR CONNECTED TO ONE ECP ONLY PER LOCATION.
- FACE NORTH WHEN POSSIBLE. 2. SEE GENERAL NOTES 7 AND 8 FOR REMOTE SENSOR MOUNTING LOCATION DETAILS.
- Venstar EMS No Lighting Control HVAC Controls

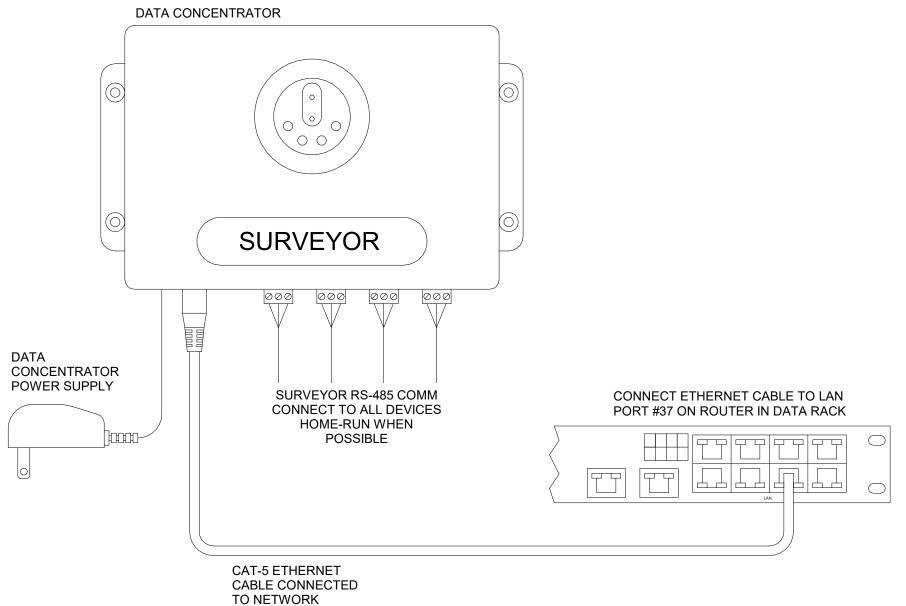

GENERAL NOTES

- 1. SURVEYOR ENERGY MANAGEMENT SYSTEM HARDWARE IS SUPPLIED BY STARBUCKS.
- 2. DRAWING FOR GENERAL INFORMATION, DESIGN INTENT, AND COORDINATION ONLY.
- 3. LOCAL BUILDING CODES TAKE PRECEDENCE OVER THIS DOCUMENT.
- 4. NOT ALL WIRING IS SHOWN ON THIS DRAWING. FOR CLARITY, ONLY ONE EXAMPLE OF EACH TYPE OF DEVICE IS SHOWN.
- 5. REFER TO THE SURVEYOR INSTALLATION INSTRUCTIONS FOR EACH COMPONENT FOR DETAILED WIRING AND ADDITIONAL CRITICAL INFORMATION.
- 6. CAUTION! INSTALLATION REQUIRES THE REMOVAL OF SAFETY COVERS AND EXPOSE THE INSTALLER TO HIGH VOLTAGE AND ELECTRICAL HAZARDS. USE OF A LICENSED ELECTRICIAN IS REQUIRED. FOLLOW ALL APPROPRIATE SAFETY PRECAUTIONS. ADDITIONAL SAFETY INFORMATION IS IN THE SURVEYOR INSTALLATION MANUALS.
- 7. WALL MOUNTED REMOTE SENSOR IS MOUNTED ON WALL 4 TO 5 FT AFF. AVOID AREAS WITH DIRECT AIRFLOW FROM SUPPLY REGISTERS.
- 8. USE A DROP DOWN SENSOR IF A WALL MOUNT SENSOR CANNOT BE INSTALLED DUE TO SPACE CONSTRAINTS (SEE NOTE 7 FOR REQUIREMENTS). THE SENSOR CLIPS TO THE T-BAR GRID AND ADJUSTED SO THE BOTTOM OF THE SENSOR IS 8 TO 9 FT AFF. ALLOW 2 FT OF CLEARANCE FROM METRO SHELVING AND AVOID AREAS WITH DIRECT AIRFLOW FROM SUPPLY REGISTERS.
- 9. FOR SURVEYOR EMS TECHNICAL SUPPORT AND SYSTEM COMMISSIONING, CONTACT SURVEYOR TECHNICAL SUPPORT, (855) 647-7660, OPTION 1 OR EMAIL INSTALLSUPPORT@VENSTAR.COM. HOURS 6:00 AM TO 8:00 PM PACIFIC, MON-FRI.

	SURVEYOR EMS COMPONENTS								
	VENSTAR PART	SBUX ITEM#	<u>DESCRIPTION</u>	<u>QUANTITY</u>					
	DC400	011029485	DATA CONCENTRATOR	1					
	OTS400	011029487	OUTDOOR TEMPERATURE SENSOR	1					
	ECP400	011029489	EQUIPMENT CONTROL PAC	1 PER HVAC					
	CT414	011029490	COMMUNICATING THERMOSTAT	1 PER HVAC					
	SP400	011029491	SENSOR PAC	1 PER HVAC					
	RS410	011029492	WALL MOUNT REMOTE SENSOR	1 PER FOH HVAC					
OPTIONAL - \	RS420	011050767	NARROW DROP DOWN SENSOR	1 PER BOH HVAC					

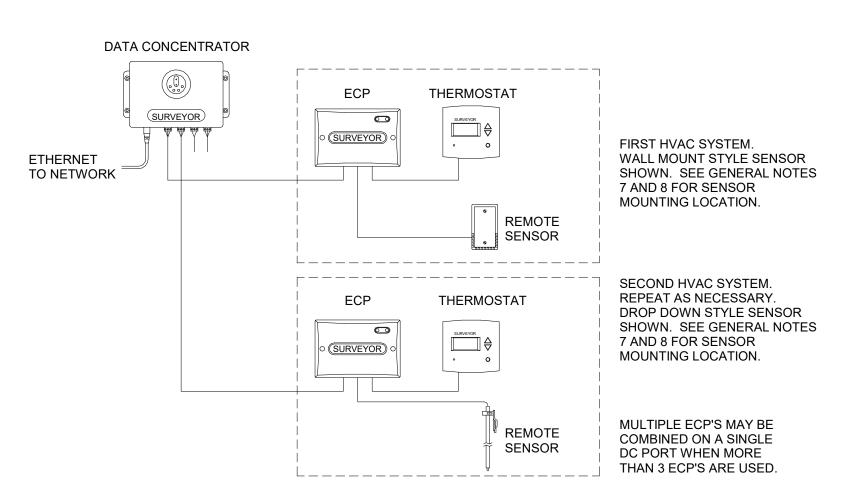

Venstar EMS - No Lighting Control - Basic Low Voltage Wire Runs

Scale: N.T.S



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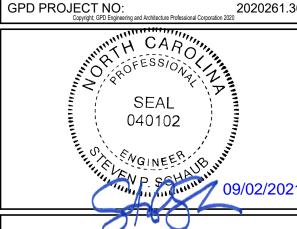
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520 SOUTH MAIN ST, SUITE 2531 AKRON, OH 44311 P: 330-572-2100 F: 330-572-2101



PROJECT ADDRE 2778 NC-24 CAMERON,

STORE #: 59763 PROJECT #: 85334-001 ISSUE DATE: For Construction

ASHLEY SUEIRAS **DESIGN MANAGER:** PRODUCTION DESIGNER: GPD GROUP CHECKED BY: GPD GROUP

GENERAL ELECTRICAL -EMS, NO LIGHTING

SCALE: AS SHOWN SHEET NUMBER:

Location: WORKROOM 41 Supply From: CT CAB/METER Mounting: RECESSED Enclosure: NEMA-1

Volts: 120/208 Phases: 3 Wires: 4

A.I.C. Rating: 42K (SEE NOTE) Mains Type: MCB Mains Rating: 400 A MCB Rating: 400 A

PANEL WITH FEED-THRU LUGS TO SERVE FUTURE PANEL

NOTES	СКТ	Load Name	Trip	Poles		A	i i	В		С	Poles	Trip	Load Name	СКТ	NOTES
	1	EXISTING AIR CURTAIN	20 A	1	3 VA	154 VA					1	20 A	EXISTING CANOPY LIGHTS	2	
	3	EXISTING EF-1	20 A	1			180 VA	262 VA			1	20 A	EXISTING EXTERIOR BLDG. LIGHTS	4	
	5	EXISTING EMERGENCY LIGHTS	20 A	1					30 VA	120 VA	1	20 A	EXISTING INTERIOR LIGHTS	6	
	7	EXISTING TIME CLOCK	20 A	1	200 VA	450 VA					1	20 A	EXISTING PARKING LOT LIGHTING	8	
	9	EXISTING PARKING LOT LIGHTING	20 A	1			360 VA	360 VA			1	20 A	EXISTING RTU- RECEPTACLES	10	
	11	EXISTING RECEPTACLES	20 A	1					360 VA	5760	3	60 A	EXISTING RTU-2	12	
	13	EXISTING RTU-1	60 A	3	5760	5760								14	
	15						5760	5760						16	
	17								5760	180 VA	1	20 A	EXISTING MONUMENT SIGN	18	
	19	SHOW WINDOW RECEPS	20 A	1	540 VA	1080					1	20 A	FLOOR BOX BANQUETTE (6)	20	
	21	FLOOR BOX BANQUETTE/CONV. (3)	20 A	1			540 VA	540 VA			1	20 A	CAFE RECEPS	22	
	23	HAND DRYER	20 A	1					180 VA	180 VA	1	20 A	HAND DRYER	24	
	25	UPS MANAGERS DESK	20 A	1	180 VA	180 VA					1	20 A	PDU STRIP MANAGERS DESK	26	
	27	RECEPS MANAGERS DESK	20 A	1			1080	540 VA			1	20 A	DATA / CONTROLS MANAGERS DESK	28	
	29	MUSIC SYSTEM MANAGERS DESK	20 A	1					180 VA	540 VA	1	20 A	WATER FILTRATION / HEATER	30	
Α	31	15186 - DISHWASHER	40 A	2	3172	360 VA					1	20 A	WATER FILLING STATION	32	Α
	33						3172	540 VA			1	20 A	RECEPS PARTNERS DESK	34	
Α	35	11083 - 2 DOOR REACH-IN REFRIG.	20 A	1					1200	1800	2	30 A	18846 - ICE MACHINE	36	В
Α	37	11083 - 2 DOOR REACH-IN REFRIG.	20 A	1	1200	1800								38	
Α	39	10970 - 1 DOOR REACH-IN REFRIG.	20 A	1			1200	1160			1	20 A	13682 - 2 DOOR REACH IN FREEZER	40	Α
Α	41	13682 - 2DOOR REACH IN FREEZER	20 A	1					1160	720 VA	1	20 A	FUTURE MENU BOARDS	42	
			Tot	al Load:	2083	39 VA	2145	4 VA	1817	70 VA					

Load Classification	Connected Load	Demand Factor	Estimated Demand	Panel	Totals
Power	5260 VA	100.00%	5260 VA		
Kitchen Equipment	9944 VA	65.00%	6464 VA	Total Conn. Load:	60463 VA
Receptacle	8040 VA	100.00%	8040 VA	Total Est. Demand:	56983 VA
				Total Conn. Current:	168 A
				Total Est. Demand Current:	158 A

182 A

151 A

PANEL WILL CONTAIN GFCI BREAKERS. ENSURE MANUFACTURE CAN PROVIDE GFCI BREAKERS OVER 20A, INCLUDING 120V AND 208V LOADS. GFCI RELAYS ARE NOT PERMITTED. CONTRACTOR SHALL COORDINATE WITH UTILITY COMPANY AND SHALL CALCULATE SHORT CIRCUIT FAULT CURRENT AND ARC FLASH AND PROVIDE LABELS ON ELECTRICAL EQUIPMENT PER N.E.C. AND LOCAL JURISDICTION. CONTRACTOR SHALL PROVIDE EQUIPMENT RATED FOR FAULT CURRENT.

Total Amps: 177 A

PANEL SCHEDULE NOTES

A. GROUND FAULT CIRCUIT INTERRUPTER (GFCI) BREAKERS (5mA) SHALL BE UTILIZED WHERE REQUIRED BY CODE. PROVIDE DEDICATED NEUTRAL WIRE FOR ALL OF THESE CIRCUITS AND IN ACCORDANCE WITH N.E.C.

B. GROUND FAULT CIRCUIT INTERRUPTER (GFCI) BREAKERS (5mA) SHALL BE UTILIZED WHERE REQUIRED BY CODE. INSTALL PER MANUFACTURER'S INSTRUCTIONS.

PANEL A TOTALS	PANEL B TOTALS	PANEL A AND B TOTALS
TOTAL CONN. LOAD: 60463 VA TOTA EST. DEMAND: 56983 VA TOTAL CONN. CURRENT: 168 A TOTAL EST. DEMAND CURRENT: 158 A	TOTAL CONN. LOAD: 56633 VA TOTA EST. DEMAND: 43627 VA TOTAL CONN. CURRENT: 157 A TOTAL EST. DEMAND CURRENT: 121 A	TOTAL CONN. LOAD: 117096 VA TOTA EST. DEMAND: 100610 VA TOTAL CONN. CURRENT: 325 A TOTAL EST. DEMAND CURRENT: 279 A

Branch Panel: B (BY STARBUCKS)

Location: WORKROOM 41 Supply From: PANEL 'A' Mounting: Recessed Enclosure: NEMA 1

Volts: 120/208 Phases: 3 Wires: 4


A.I.C. Rating: Mains Type: MLO Mains Rating: 400 A MCB Rating:

NOTES			Trip	Poles			ı	В	(Poles	Trip	Load Name		NOTES
Α		10267 - U.C REFRIGERATOR	20 A	1	500 VA	180 VA					1	20 A	RECEPS FUTURE USE	2	Α
Α		10267 - U.C REFRIGERATOR	20 A	1			500 VA	1800			1	20 A	12508 - BLENDER	4	Α
Α		12508 - BLENDER	20 A	1					1800	180 VA	1	20 A	RECEPS RINSE SINK	6	Α
Α	7	19559 - NITRO GENERATOR	20 A	1	500 VA	500 VA					1		20010 - NITRO COOLER	8	Α
Α		RECEPS FUTURE USE	20 A	1			180 VA	360 VA			1		DT POS FUTURE USE	10	Α
Α	11	DT POS TENDERING REGISTER	20 A	1					360 VA	360 VA	1	20 A	WIRELESS BASE / PROCESSOR	12	Α
Α	13	DT TIMER / CONTROL UNIT	20 A	1	720 VA	360 VA					1	20 A	DT ORDER MONITOR / BUMP BAR	14	Α
Α	15	10267 - U.C REFRIGERATOR	20 A	1			1000	360 VA			1	20 A	10312 - BREWER WARMING STAND (4)	16	Α
Α	17	RECEPS FUTURE USE	20 A	1					180 VA	4100	2	50 A	10746 - DUAL BREWER SOFT HEAT	18	В
Α	19	10808 - GRINDER	20 A	1	1400	4100								20	
Α	21	RECEPS INSTA HOT	20 A	1			1920	180 VA			1	20 A	CUP LABELER	22	Α
Α	23	12618 - U.C REFRIGERATOR	20 A	1					500 VA	3000	2	30 A	20032 - EIKON WARMING OVEN	24	В
В	25	20032 - EIKON WARMING OVEN	30 A	2	3000	3000								26	
	27						3000	500 VA			1	20 A	12618 - U.C REFRIGERATOR.	28	Α
	29	16238 - ZEPHYR FOOD CASE	20 A	2					500 VA	180 VA	1	20 A	RECEPS POS	30	Α
	31				500 VA	180 VA					1	20 A	RECEPS POS	32	Α
Α	33	RECEPS POS	20 A	1			360 VA	1000			1	20 A	10267 - U.C REFRIGERATOR	34	Α
В	35	19742 - MASTRENA ESPRESSO	50 A	2					2900	180 VA	1	20 A	CUP LABELER	36	Α
	37				2900	180 VA					1	20 A	CUP LABELER	38	Α
В	39	19742 - MASTRENA ESPRESSO	50 A	2			2900	1000			1	20 A	10267 - U.C REFRIGERATOR	40	Α
	41								2900	180 VA	1	20 A	CUP LABELER	42	Α
Α	43	10267 - UC REFRIGERATOR	20 A	1	500 VA	180 VA					1	20 A	TICKET PRINTER	44	Α
	45	PRE-MENU BOARD	20 A	1			200 VA	200 VA			1	20 A	DIGITAL ORDER SCREEN	46	
	47	MENU BOARD	20 A	1					200 VA	540 VA	1	20 A	DIRECTIONAL SIGNAGE	48	
	49	DIRECTIONAL SIGNAGE	20 A	1	180 VA	870 VA					1	20 A	CAFE LIGHTING	50	
	51	BACKBAR LIGHTING	20 A	1			1170	573 VA			1	20 A	WORKROOM LIGHTING	52	
	53	EXTERIOR SIGNAGE	20 A	1					540 VA	900 VA	1	20 A	EXTERIOR SIGNAGE	54	
	55	PATIO RECEPT.	20 A	1	180 VA	0 VA					1	20 A	Spare	56	Α
Α	57	Spare	20 A	1			0 VA	0 VA			1	20 A	Spare	58	Α
Α	59	Spare	20 A	1					0 VA	0 VA	1	20 A	Spare	60	Α
Α	61	Spare	20 A	1	0 VA	0 VA					1	20 A	Spare	62	
		Spare	20 A	1			0 VA	0 VA			1	20 A	Spare	64	
	65	Spare	20 A	1					0 VA	0 VA	1	20 A	Spare	66	
			Tot	al Load:	1993	0 VA	1720	3 VA	1950	0 VA					-
			Tota	l Amps:	169	9 A	14	3 A	16	5 A	1				

Load Classification	Connected Load	Demand Factor	Estimated Demand	Panel	Totals
Power	10260 VA	100.00%	10260 VA		
Kitchen Equipment	37160 VA	65.00%	24154 VA	Total Conn. Load:	56633 VA
Receptacle	6600 VA	100.00%	6600 VA	Total Est. Demand:	43627 VA
				Total Conn. Current:	157 A
				Total Est. Demand Current:	121 A

Legend:

1. CONTRACTOR SHALL COORDINATE WITH UTILITY COMPANY AND SHALL CALCULATE SHORT CIRCUIT FAULT CURRENT AND ARC FLASH AND PROVIDE LABELS ON ELECTRICAL EQUIPMENT PER N.E.C. AND LOCAL JURISDICTION. CONTRACTORS SHALL PROVIDE EQUIPMENT RATED FOR FAULT CURRENT.

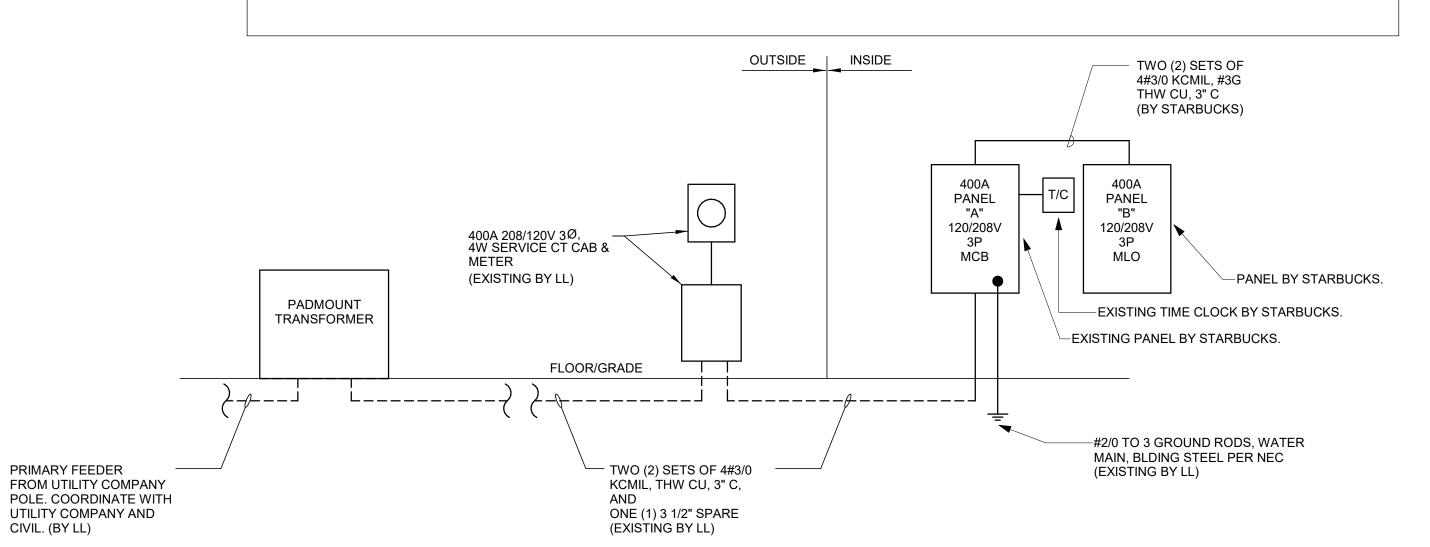

- NOTES:

 1. CONTRACTOR SHALL COORDINATE WITH UTILITY COMPANY AND CALCULATE SHORT CIRCUIT FAULT CURRENT AND ARC FLASH AND PROVIDE LABELS ON ELECTRICAL EQUIPMENT PER N.E.C. AND LOCAL JURISDICTION. CONTRACTOR SHALL PROVIDE EQUIPMENT RATED FOR
- AVAILABLE FAULT CURRENT. 2. CONTRACTOR SHALL COORDINATE WITH POWER COMPANY & PROVIDE CT CABINET & METER BASE PER POWER COMPANY REQUIREMENTS. 3. ALL TRENCHING, BACKFILL, SITE RESTORATION AND WARNING TAPE
- DETEDTABLE BY CONTRACTOR. VERIFY DEPTHS OF CONDUITS COMPLY WITH NEC, POWER COMPANY JURISDICTION. 4. CONTRACTOR SHALL PROVIDE AN OUTDOOR DISCONNECT SWITCH IF
- LOCAL JURISDICTION OR POWER COMPANY REQUIRES ONE. 5. CONTRACTOR SHALL PROVIDE PANELS WITH FEED THRU LUGS.

1 SINGLE-LINE DIAGRAM

CIVIL. (BY LL)



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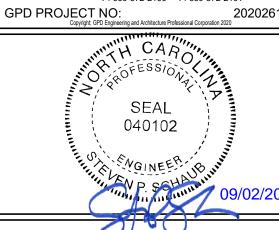
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NAME 24

S PROJECT 2778 CAME

59763

85334-001

GPD GROUP

STORE #: PROJECT #: ISSUE DATE:

CHECKED BY:

For Construction 09/01/21 DESIGN MANAGER: **ASHLEY SUEIRAS** PRODUCTION DESIGNER: GPD GROUP

Revision Schedule

Description

ELECTRICAL PANEL SCHEDULES

SCALE: AS SHOWN SHEET NUMBER:

CO2 CARBON DIOXIDE CD **CEILING DIFFUSER** CLG CEILING CONSTRUCTION CONST CXA COMMISSIONING AGENT

DEG DEGREES DM STARBUCKS DESIGN MANAGER DN DOWN

ABOVE FINISHED FLOOR

AUTHORITIES HAVING JURISDICTION

DTL DETAIL DRAWING(S)

EΑ EACH

ELECTRICAL CONTRACTOR ECP **EQUIPMENT CONTROL PAC** EG EXHAUST GRILLE ELEC ELECTRICAL **EMERGENCY**

ENERGY MANAGEMENT SYSTEM EXIST EXISTING

EXT **EXTERIOR**

F&I **FURNISH & INSTALL** FOIC **FURNISHED BY OWNER** INSTALLED BY CONTRACTOR FOIO FURNISHED BY OWNER. **INSTALLED BY OWNER**

FLOOR FOOT/FEET

GAS PIPING

GENERAL CONTRACTOR HOUR

HEATING, VENTILATION, AIR CONDITIONING

I.D INSIDE DIAMETER INDOOR AIR QUALITY IAQ

LCP LIGHTING CONTROL PANEL LANDLORD LV LOW VOLTAGE

MAX MAXIMUM

HVAC

MECHANICAL CONTRACTOR MECH MECHANICAL MEP MECHANICAL, ELECTRICAL AND PLUMBING

MFG MANUFACTURER MIN MINIMUM

NOT TO SCALE

O.D. **OUTSIDE DIMENSION** OSA OUTSIDE AIR

REF REFERENCE REQ'D REQUIRED REV REVISION ROOFTOP

SQUARE FEET SHEET **SPECS** SPECIFICATION(S) STAINLESS STEEL

TEMP TEMPORARY TYP TYPICAL

UNLESS NOTED OTHERWISE UNDER COUNTER

WATER HEATER WSHP WATER SOURCE HEAT PUMP

MECHANICAL SYMBOL LEGEND

DUCT HEATER TYPICAL SUPPLY DUCT UP/DN MANUAL VOLUME TYPICAL RETURN OR DAMPER EXHAUST DUCT UP/DN BACK DRAFT DAMPER TURNING VANES SMOKE DETECTOR EF-1 **EQUIPMENT DESIGNATION** COMBINATION SMOKE AND FIRE THERMOSTAT DAMPER SPIN-IN TAKE-OFF THERMOSTAT SENSOR AND VOLUME


DAMPER UNDERCUT DOOR CONNECT TO EXISTING

INDICATES UNLINED 12" X 8" O.D. SHEETMETAL 1ST FIGURE = SIDE SHOWN 12 X 8 2ND FIGURE = SIDE NOT SHOWN INDICATED 14" X 10" (355mm X 255mm) O.D. 12 X 8 SHEETMETAL W/ 1" (25mm) SOUNDLINER (U.N.O), 12" X 8" (305mm X 205mm I.D. NET FLEXIBLE DUCT CONNECTION

FLEXIBLE DUCT

SUPPLY AIR ARROW

RETURN AIR ARROW

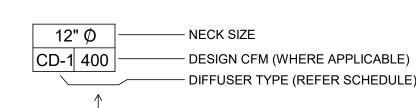

CEILING DIFFUSER (FLOW ARROWS SHOWN ONLY IF AIR FLOW NOT

SYMMETRICAL) CEILING RETURN / EXHAUST GRILLE

CONTROLS AND OPERATION NOTES

THE GENERAL CONTRACTOR SHALL FURNISH AND INSTALL THE FOLLOWING COMPONENTS:

THE MECHANICAL CONTRACTOR SHALL PROVIDE ALL CONTROL WIRING IN CONDUIT NECESSARY FOR THE COMPLETE AND PROPER OPERATING TEMPERATURE CONTROL SYSTEM INCLUDING ALL MODES OF OPERATION AND INTERLOCK.

RESTROOM EXHAUST FAN(S) TO BE OPERATED IN CONJUNCTION WITH STORE HOURS UNLESS OTHERWISE NOTED OR APPROVED OR AS REQUIRED BY JURISDICTION (COORDINATE WITH ELECTRICAL).

PERMANENT THERMOSTAT(S) AND REMOTE SENSOR(S) SHALL BE FURNISHED AND INSTALLED. ONE THERMOSTAT AND SENSOR IS PROVIDED FOR EACH UNIT. MOUNT THERMOSTAT(S) AND SENSOR(S) IN LOCATION & HEIGHT AS INDICATED ON DRAWINGS. MECHANICAL CONTRACTOR TO PROVIDE THERMOSTAT IDENTIFICATION LABELS PER SPECIFICATION REQUIREMENTS. REFER TO THERMOSTAT SETUP INSTRUCTIONS BELOW FOR ADDITIONAL REQUIREMENTS.

THERMOSTAT SETUP INSTRUCTIONS

PROVIDE THE FOLLOWING SETUP AND PROGRAMMING:

1. CONFIGURE AS FOLLOWS: A. DEGREES "F" DISPLAY

> B. 12 HOUR CLOCK C. CONTINUOUS FAN OPERATION IN OCCUPIED

MODE D. DISABLE KEYBOARD PROGRAMMING

2. SET TIME AND DATE

3. SET TO DISPLAY CURRENT TEMPERATURE. 4. SET OCCUPIED START TIME AT 30 MIN. BEFORE OPENING. SET UNOCCUPIED START TIME AT 30 MIN. AFTER CLOSING. VERIFY HOURS WITH STORE MANAGER OR CONSTRUCTION MANAGER.

5. SET POINTS SHALL BE AS FOLLOWS OR AS APPROPRIATE FOR CLIMATE: A. OCCUPIED (5° F DEADBAND) (3° C DEADBAND)

HEATING: 70° F (21° C) II. COOLING: 75° F (24° C) B. UNOCCUPIED

I. HEATING: 60° F (15° C) II. COOLING: 78° F (25° C)

6. SET TWO (2) HOUR OCCUPIED OVERRIDE FUNCTION TO PROVIDE THE FOLLOWING SET POINT OVERRIDES: A. HEATING: +2° F (1° C) B COOLING: -2° F (1° C)

DEMAND CONTROL VENTILATION (DCV) THE CO2 SENSOR SHALL MODULATE THE AIR HANDLING UNIT OUTSIDE

AIR DAMPER TO MAINTAIN 1000 PPM C02 OR LESS OCCUPIED MODE: 1. FAN SHALL RUN CONTINUOUSLY WHILE BRINGING IN MINIMUM DCV OUTSIDE AIR AS INDICATED IN SCHEDULE.

AIR DAMPER SHALL BE OPEN TO THE CALCULATED DCV MINIMUM OUTSIDE AIR. 3. IF C02 SENSOR SETPOINT IS EXCEEDED, OUTSIDE AIR DAMPER SHALL MODULATE TO MAINTAIN 1000 PPM NOT TO EXCEED THE CALCULATED DESIGN MINIMUM OUTSIDE AIR. 4. UPON C02 PPM FALLING BELOW THE SETPOINT OF 1000

PPM, THE AIR DAMPER SHALL RETURN TO DCV MINIMUM

2. IF C02 SENSOR SET POINT IS BELOW THE SETPOINT, THE

OUTSIDE AIR. 5. THE ECONOMIZER SHALL HAVE PRIORITY OVER THE DCV CONTROLS, OUTSIDE AIR MAY EXCEED DCV MINIMUM AND DESIGN MINIMUM WHEN AIR CONDITIONS ARE

APPROPRIATE TO DO SO.

UNOCCUPIED MODE

1. FAN SHALL CYCLE WITH HEATING AND OUTSIDE AIR DAMPER CLOSED. OUTSIDE DAMPER SHALL NOT BE CYCLED WITH C02 PPM SETPOINT.

SYSTEM COMMISSIONING

CONTRACTOR RESPONSIBILITIES FOR BUILDING COMMISSIONING

CONTRACTOR SHALL PROVIDE SUPPORT AND WORK AS SPECIFIED, NEEDED AND REQUIRED TO CONDUCT AND FACILITATE STARBUCKS STAFF BUILDING COMMISSIONING EFFORTS. THIS WORK WILL BE COMPRISED OF THREE DISTINCT EFFORTS: 1. SUPPORT STARBUCKS COMMISSIONING AGENT (CXA) DURING

INSTALLATION VERIFICATION AND CORRECT DISCLOSED DEFICIENCIES. 2. PERFORM TESTING, ADJUSTING, BALANCING AND SYSTEM

STARTUP AND SUPPORT FUNCTIONAL PERFORMANCE TESTING BY STARBUCKS CXA;

3. CORRECT DEFICIENCIES DISCLOSED BY FUNCTIONAL PERFORMANCE TESTING AND SUBMIT REPORTS.

CONTRACTOR SHALL PERFORM AND PROVIDE THE FOLLOWING:

A. SYSTEMS SUBJECT TO COMMISSIONING MAY INCLUDE. BUT ARE NOT LIMITED TO DOMESTIC HOT WATER GENERATION, HVAC SYSTEMS, ROOFTOP UNITS, EXHAUST FANS, HVAC CONTROLS, LIGHTING CONTROLS AND AIR CURTAINS.

B. CONTRACTOR SHALL PROVIDE WRITTEN RESPONSES TO ALL CXA'S REVIEWS AND COMMENTS. RESPONSES SHALL BE PROVIDED IN A TIMELY MANNER.

C. CONTRACTOR SHALL INCLUDE COMMISSIONING ACTIVITIES IN PROJECT SCHEDULE AND SHOW INTERVALS FOR PERFORMANCE OF WORK FOR WHICH CONTRACTOR IS RESPONSIBLE AND INTERVALS FOR WORK PERFORMED BY STARBUCKS CXA. CONTRACTOR SHALL SHOW RESOURCES FOR PERFORMING ALL WORK RELATED TO COMMISSIONING ACTIVITIES ON A LINE ITEM IN THE SCHEDULE OF VALUES.

D. CONTRACTOR SHALL INSTALL EQUIPMENT IN ACCORDANCE WITH THE MANUFACTURER'S REQUIREMENTS AND ALL CONTRACT DOCUMENTS. ENSURE THAT ALL EQUIPMENT IS INSTALLED. TOTALLY COMPLETE AND ACCESSIBLE TO STARBUCKS CXA FOR INSTALLATION VERIFICATION AND FUNCTIONAL PERFORMANCE TESTING PRIOR TO THE SCHEDULED START OF INSTALLATION

E. CONTRACTOR SHALL COMPLETE MANUFACTURER'S STARTUP PROCEDURES PRIOR TO COMMISSIONING COORDINATION WITH

F. CONTRACTOR SHALL BE READILY AVAILABLE DURING INSTALLATION VERIFICATION TO CORRECT ANY DEFICIENCIES OR DEFECTS IS CLOSED BY THE INSTALLATION VERIFICATION PROCESS. CORRECTIONS SHALL BE MADE IN A TIMELY MANNER WITHOUT DISRUPTION OF THE CONSTRUCTION SCHEDULE.

G. ALL HVAC EXHAUST FAN AND AIR CURTAIN EQUIPMENT SHALL BE TESTED, ADJUSTED AND BALANCED BY THE CONTRACTOR'S TESTING, ADJUSTING AND BALANCE AGENT (SEE TESTING ADJUSTING AND BALANCING) AFTER THE SYSTEM IS VERIFIED TO BE COMPLETE AND CORRECT BY STARBUCKS CXA, IN ACCORDANCE WITH THE REQUIREMENTS OF THESE DOCUMENTS. ALL HVAC CONTROL SYSTEMS SHALL BE TESTED TO ENSURE THAT CONTROL DEVICES, COMPONENTS, EQUIPMENT AND SYSTEMS ARE CALIBRATED. ADJUSTED AND OPERATE IN ACCORDANCE WITH THESE PLANS AND SPECIFICATIONS. SEQUENCES OF OPERATION SHALL BE TESTED TO ENSURE THAT THEY OPERATE IN ACCORDANCE WITH THE CONTRACT REQUIREMENTS. DELIVERABLES: PRELIMINARY, WRITTEN TESTING AND AIR BALANCE REPORT CONFORMING TO THE REQUIREMENTS SPECIFIED HEREIN, DOCUMENTING THE INFORMATION SPECIFIED, ETC... TO THE STARBUCKS CXA IMMEDIATELY UPON COMPLETION OF THE WORK.

H. PROVIDE A LIST OF ALL FACTORY AND FIELD SETTINGS THAT HAVE BEEN PROGRAMMED INTO THE EQUIPMENT (SUCH AS SETPOINTS, SCHEDULES, DIP SWITCH SETTINGS, CONDENSER AND EVAPORATOR OPERATING PRESSURE/TEMPERATURE

I. CONTRACTOR SHALL INFORM STARBUCKS CXA WHEN EQUIPMENT IS READY FOR FUNCTIONAL PERFORMANCE TESTING. ALL EQUIPMENT SHALL BE READY FOR FUNCTIONAL PERFORMANCE TESTING PRIOR TO STARTING TESTING. THIS INCLUDES REHEARSING ALL FUNCTIONAL PERFORMANCE TESTS BEFORE DEMONSTRATING TO THE CXA. CONTRACTOR SHALL OPERATE EQUIPMENT FOR STARBUCKS CXA AND VERIFY BY DEMONSTRATING THE CORRECT OPERATION OF EQUIPMENT, SENSOR CALIBRATION, RESPONSE OF ACTUATORS AND PROPER EXECUTION OF HVAC CONTROL AND LIGHTING SEQUENCES, INCLUDING BUT NOT LIMITED TO AIR MOVEMENT, TEMPERATURE, SOUND AND CONTROL RESPONSE. PROVIDE ANY SECURITY ACCESS, HARDWARE, SOFTWARE OR OTHER SUPPORT AS NEEDED FOR THE STARBUCKS CXA TO EFFICIENTLY WITNESS AND DOCUMENT ALL EQUIPMENT TESTING. STARBUCKS CXA WILL RECORD THE EQUIPMENT OPERATION AND RESPONSE TO TESTING SEQUENCES AND PREPARE A LIST OF ANY DEFICIENCIES DISCLOSED BY THE FUNCTIONAL PERFORMANCE TESTS FOR CORRECTION BY THE CONTRACTOR. EQUIPMENT INCLUDES, BUT IS NOT LIMITED TO, AIR HANDLING UNITS, ROOFTOP AND SPLIT TYPE, CONDENSING UNITS, EXHAUST FANS, LIGHTING CONTROLS. ETC... DELIVERABLES: PROVIDE COMPLETED COPIES OF ALL START UP REPORTS, FILLED OUT ON THE MANUFACTURER'S FORMS, TO THE STARBUCKS CXA.

J. CONTRACTOR IS RESPONSIBLE FOR CORRECTING ANY ISSUES OR DEFICIENCIES DISCLOSED DURING THE FUNCTIONAL PERFORMANCE TESTING PROCESS. CORRECTIONS SHOULD BE MADE IN A TIMELY MANNER WITHOUT DISRUPTION TO THE SYSTEM AND CONSTRUCTION SCHEDULE.

K. CONTRACTOR SHALL BE READILY AVAILABLE FOR ANY RE-TESTING OF EQUIPMENT DEEMED NECESSARY BY STARBUCKS CXA DURING INSTALLATION VERIFICATION AND FUNCTIONAL PERFORMANCE TESTING. CONTRACTOR IS RESPONSIBLE FOR CORRECTING ANY ISSUES OR DEFICIENCIES FOUND IN THE SYSTEM DURING ANY AND ALL RE-TESTING. CORRECTIONS SHOULD BE MADE IN A TIMELY MANNER WITHOUT DISRUPTION TO THE SYSTEM AND CONSTRUCTION SCHEDULE. DELIVERABLES: FINAL BALANCE REPORT, DEFICIENCIES LIST NOTING CORRECTIVE ACTIONS PERFORMED BY CONTRACTOR IN RESPONSE TO INSTALLATION VERIFICATION AND FUNCTIONAL PERFORMANCE TEST RESULTS.

L. CONSTRUCTION AND POST CONSTRUCTION TESTING: ADDITIONAL TESTING MAY BE REQUIRED BY LEED AND OTHER PROCESSES THAT MAY OCCUR OUT OF SEQUENCE WITH COMMISSIONING SERVICE. CONTRACTOR SHALL CONDUCT. DOCUMENT, SUPPORT AND SCHEDULE THIS TESTING AS DIRECTED BY STARBUCKS CXA.

SYSTEM COMMISSIONING (continued)

M. CONTRACTOR SHALL PROVIDE A TRAINING PLAN FOR EACH TRADE (MECHANICAL, ELECTRICAL, PLUMBING) FOR THE CXA'S APPROVAL. THE TRAINING PLAN SHALL OUTLINE ALL THE TOPICS THAT ARE TO BE COVERED ALONG WITH THE TIME DURATION FOR EACH TOPIC. IT SHALL ALSO INCLUDE THE INSTRUCTOR'S NAME, QUALIFICATIONS AND COMPANY LOGO.

N. THE CONTRACTOR IS RESPONSIBLE FOR RECORDING ATTENDANCE FOR EACH TRAINING SESSION. COPIES OF THESE SHALL BE SUBMITTED TO THE CXA.

O. CONTRACTOR SHALL SUBMIT O&M MANUALS FOR ALL PIECES OF EQUIPMENT AT LEAST 6 WEEKS IN ADVANCE OF THE TRAINING

HVAC EQUIPMENT AND MATERIALS

IF OPERATING HVAC DURING CONSTRUCTION, PROVIDE THREE (3) SETS OF 2" (51MM) MERV6 PLEATED DISPOSABLE FILTERS (OR HIGHER RATING IF REQUIRED BY LEED). USE ONE SET UNTIL COMPLETION OF CONSTRUCTION. INSTALL ONE SET AT COMPLETION OF CONSTRUCTION (PRIOR TO TAB) AND DELIVER ONE SET OF MERV13 FILTERS TO STARBUCKS LABELED TO DENOTE THEIR RESPECTIVE AIR HANDLING UNIT.

BRACING AND ANCHORING

ALL MECHANICAL EQUIPMENT, FIXED OR FLEXIBLY MOUNTED, SHALL BE BRACED OR ANCHORED TO COMPLY WITH LOCAL CODES.

DUCTWORK AND ACCESSORIES

SHEET METAL DUCTWORK

ASSEMBLE AND INSTALL DUCTWORK IN ACCORDANCE WITH RECOGNIZED INDUSTRY PRACTICE FOR ACHIEVING AIR TIGHT (5% LEAKAGE) AND NOISELESS (NO OBJECTIONABLE NOISE) SYSTEMS. NO VARIATION OF DUCT CONFIGURATION OR SIZES WILL BE PERMITTED EXCEPT BY PERMISSION FROM THE ENGINEER

PROVIDE CONVENIENTLY LOCATED ACCESS DOORS OF AMPLE SIZE AND QUANTITY FOR SERVICING THE DAMPERS. PROVIDE MOTORIZED DAMPERS AT ALL INTAKE & EXHAUST BUILDING OPENINGS. COORDINATE WITH OTHER TRADES FOR ACCESS PANELS, POWER AND FIRE ALARM INTERFACES. SEE PROJECT MANUAL.

ACOUSTICAL DUCT LINER
UNLESS OTHERWISE INDICATED ON THE PLANS, PROVIDE 1" (25MM) ACOUSTICAL DUCT LINER IN SUPPLY AND RETURN DUCTWORK WITHIN 10'-0" (305CM) OF THE DISCHARGE AND INTAKE OF AIR HANDLING UNITS. INCREASE DUCT SIZE INDICATED ON PLANS AS NEEDED TO ACCOMMODATE LINER. LINER TO BE PROVIDED AND FASTENED TO DUCT WITH MECHANICAL LINER FASTENERS IN ACCORDANCE WITH SMACNA AND PROJECT MANUAL.

FLEXIBLE DUCT WORK SHALL ONLY BE INSTALLED AS SHOWN IN PLAN AND NOT ABOVE HARD LID CEILINGS. FLEXIBLE DUCTWORK SHALL NOT EXCEED 5'-0" (152CM) IN LENGTH AND TWO 45° ELBOWS. IT SHALL BE PULLED TAUT AND APPROPRIATELY FASTENED TO RIGID BRANCH DUCT & DIFFUSER. BENDS SHALL BE MINIMIZED AND WHERE NEEDED BE A FULL RADIUS BEND. SUPPORT BANDS SHALL BE INSTALLED SO AS TO NOT CRIMP FLEX DUCT. FLEXIBLE DUCTWORK SHALL MEET REQUIREMENTS.

TESTING, ADJUSTING, BALANCING

INDEPENDENT AIR BALANCE CONTRACTOR OR QUALIFIED MECHANICAL CONTRACTOR SHALL BE QUALIFIED BY NEBB OR AABC STANDARDS. BALANCER SHALL ACCURATELY BALANCE THE SUPPLY, RETURN AND OUTSIDE AIR. EXHAUST FAN(S), HYDRONIC (WHERE APPLICABLE) AND EXHAUST FAN(S) SYSTEMS TO PROVIDE AIR AND WATER QUANTITIES WITHIN 10% PLUS MINUS OF THE VALUES INDICATED ON THE DRAWINGS AND IN THE SPECIFICATIONS UNLESS MANUFACTURER REQUIRES TIGHTER TOLERANCES. OPERATE AUTOMATIC CONTROLS SYSTEMS AND VERIFY SETPOINTS FOR THERMOSTATS, C02 SENSORS, DCV, EMS AND ECONOMIZER/OUTSIDE AIR DAMPER. SEE CONTROLS AND OPERATION NOTES AND HVAC SCHEDULES AND NOTES FOR DETAILS. IF DEFICIENCIES OR SITE CONDITIONS PREVENT COMPLETE AND PROPER BALANCING, DO NOT COMPLETE WORK AND SUBMIT A REQUEST FOR INFORMATION TO GET COMPLETE INFORMATION PRIOR TO COMPLETING WORK. SUBMIT THREE (3) COPIES OF THE BALANCE REPORT TO THE ENGINEER. CONSTRUCTION MANAGER AND COMMISSIONING AGENT FOR APPROVAL. THE BALANCE REPORT SHALL INCLUDE NEBB OR AABC CREDENTIALS, EQUIPMENT/INSTRUMENT LIST WIT THE MOST RECENT CALIBRATION DATE AND BALANCE REPORTS FOR ALL HVAC AND EXHAUST SYSTEMS. T&B REPORT SHOULD MATCH NEBB OR AABC STANDARD REPORTS INCLUDING UNIT TEST DATA WITH TEMPERATURES, PRESSURES AND STATIC PRESSURE PROFILES. INCLUDE A COPY OF THE BALANCE REPORT AS APPROVED BY THE ENGINEER WITH APPLICATION FOR FINAL CONTRACT PAYMENT.

IAQ MANAGEMENT PLAN

DURING CONSTRUCTION, CONTRACTOR SHALL COMPLY WITH CHAPTER 3 OF SMACNA'S IAQ GUIDELINES FOR OCCUPIED BUILDINGS UNDER CONSTRUCTION. CONTRACTOR SHALL PERFORM AND SUBMIT ALL INFORMATION AS REQUIRED. IF HVAC SYSTEM IS TO BE USED DURING CONSTRUCTION, INSTALL MERV 8 FILTERS AT EACH RETURN AIR GRILL AND COMPLY WITH SMACNA'S GUIDELINES.

ENERGY MANAGEMENT SYSTEM (EMS)

THE GENERAL CONTRACTOR SHALL INSTALL (OR DEMO AND REINSTALL FOR RENOVATIONS) THE VENSTAR SURVEYOR EMS SYSTEMS PRIOR TO THE LAST WEEK OF CONSTRUCTION. MECHANICAL CONTRACTOR TO INSTALL ONE PERMANENT THERMOSTAT AND REMOTE SENSOR PER HVAC UNIT, AS PROVIDED BY VENSTAR. LOCATE AND MOUNT THERMOSTAT(S) AND SENSOR(S) PER THE DRAWINGS. INSTALL THERMOSTAT IDENTIFICATION LABELS PER VENSTAR SPECIFICATIONS.

MECHANICAL CONTRACTOR TO COMPLETE FINAL CONNECTIONS FROM SURVEYOR DATA CONCENTRATOR TO STORE ROUTER PRIOR TO CONTACTING VENSTAR (818-812-9812). VENSTAR TO PROGRAM THE HVAC AND/OR LIGHTING CONTROLS WITH STANDARD STARBUCKS SETTINGS. FOR ASSISTANCE WITH OR TROUBLESHOOTING OF THE SURVEYOR CONTROLS, CONTACT VENSTAR.

GENERAL MECHANICAL NOTES

- 1. MECHANICAL CONTRACTOR SHALL COORDINATE WITH THE GENERAL CONTRACTOR TO PATCH AND REPAIR ALL EXISTING WALLS, FLOORS, CEILINGS OR OTHER SURFACES IDENTIFIED TO REMAIN THAT MAY BECOME DAMAGED DURING THE COURSE OF WORK
- 2. DRAWINGS ARE DIAGRAMMATIC AND INDICATE GENERAL INTENT OR ARRANGEMENT OF SYSTEM(S). FURNISH & INSTALL ALL COMPONENTS NEEDED WHETHER INDICATED OR NOT TO PROVIDE A COMPLETE AND OPERATING SYSTEM.
- 3. CONTRACTOR TO VERIFY ALL DIMENSIONS, INCLUDING CLEARANCES REQUIRED BY OTHER TRADES, AND NOTIFY STARBUCKS CONSTRUCTION MANAGER OF ANY DISCREPANCIES PRIOR TO PROCEEDING WITH THE WORK. ALL DIMENSIONS ARE TO THE FACE OF THE FINISHED SURFACE UNLESS NOTED OTHERWISE. ALL DIMENSIONS TO BE TAKEN FROM ACTUAL BUILDING DIMENSIONS.
- 4. THE MECHANICAL CONTRACTOR SHALL COORDINATE HVAC WORK WITH OTHER TRADES. THE ARCHITECTURAL DRAWINGS AND PROJECT MANUAL SHALL TAKE PRECEDENCE OVER ALL OTHER DRAWINGS. SEE ARCHITECTURAL DRAWINGS AND PROJECT MANUAL FOR DIMENSIONED DIFFUSER LOCATIONS AND MOUNTING HEIGHTS WHERE EXPOSED.
- 5. NEW DUCTWORK AND EQUIPMENT SHALL NOT BE INSTALLED WHERE IT OBSTRUCTS ANY EXISTING OR NEW AREAS THAT REQUIRE ACCESS.
- 6. INSULATE DUCTWORK PER CODE AND SPEC. REQUIREMENTS. COORDINATE CLEARANCE REQUIREMENTS FOR ADDED
- 7. ALL IS NEW UNLESS NOTED OTHERWISE.

GENERAL NOTES

THE INTENT OF THE PROJECT MANUAL AND THE DRAWINGS IS TO PROVIDE A COMPLETE AND FULLY OPERATIONAL MECHANICAL SYSTEM. THE MECHANICAL CONTRACTOR SHALL FURNISH ALL LABOR, MATERIAL, AND EQUIPMENT NECESSARY TO COMPLETE THE MECHANICAL WORK

THE MECHANICAL CONTRACTOR SHALL THOROUGHLY EXAMINE ALL AREAS WHERE EQUIPMENT, DUCTWORK, AND PIPING WILL BE INSTALLED AND WILL REPORT ANY CONDITION THAT, IN HIS OPINION, PREVENTS THE PROPER INSTALLATION OF THE MECHANICAL WORK.

PENETRATIONS

WHERE PIPES AND DUCTS PENETRATE WALL, SEAL OPENINGS TO PREVENT AIR TRANSFER BETWEEN SPACES. USE FIRE RATED SEALANTS ON ALL FIRE SEPARATION PENETRATIONS, INCLUDING FLOORS, SEAL AROUND ALL PIPES AND DUCTS PENETRATING FIRE SEPARATIONS WITH NON-COMBUSTIBLE PACKING RETAINED BY METAL COLLARS. THE ASSEMBLY SHALL BE APPROVED BY STATE FIRE MARSHALL

EQUIPMENT AND MATERIALS SHALL CONFORM WITH THE APPROPRIATE PROVISIONS OF CSA, ULC, ARL, ASME, ASTM, UL, NEMA, ANSI, SMACNA, ASHRAE, NFPA, AS APPLICABLE TO EACH INDIVIDUAL UNIT OR ASSEMBLY.

ALL WORK SHALL BE PERFORMED IN STRICT ACCORDANCE WITH ALL APPLICABLE PROVINCIAL AND LOCAL CODES AND ORDINANCES. IN CASE OF CONFLICT BETWEEN THE DRAWINGS AND PROJECT MANUAL AND THE CODES AND ORDINANCES. USE WHICHEVER IS MORE STRINGENT. THE MECHANICAL CONTRACTOR SHALL SATISFY CODE REQUIREMENTS AS A

THE MECHANICAL CONTRACTOR SHALL PROCURE AND PAY FOR ALL PERMITS. FEES, AND INSPECTIONS NECESSARY TO COMPLETE THE MECHANICAL WORK.

MINIMUM STANDARD WITHOUT ANY EXTRA COST TO STARBUCKS.

THE MECHANICAL CONTRACTOR SHALL UNCONDITIONALLY WARRANT ALL WORK TO BE FREE OF DEFECTS IN MATERIAL AND WORKMANSHIP FOR A PERIOD OF ONE (1) YEAR FROM THE DATE OF FINAL ACCEPTANCE BY STARBUCKS AND WILL REPAIR OR REPLACE ANY DEFECTIVE WORK PROMPTLY AND WITHOUT CHARGE AND RESTORE ANY OTHER EXISTING WORK DAMAGED IN THE COURSE OF REPAIRING DEFECTIVE MATERIALS AND WORKMANSHIP.

LANDLORD REQUIREMENTS

PRIOR TO BID: THE GENERAL CONTRACTOR SHALL COORDINATE WITH LANDLORD / BUILDING OWNER FOR ANY CONSTRUCTION REQUIREMENTS. IF LANDLORD / BUILDING OWNER DOES HAVE REQUIREMENTS. CONTRACTOR SHALL BECOME COMPLETELY FAMILIAR WITH REQUIREMENTS AND ADHERE TO THEM. WHERE LANDLORD / BUILDING OWNER REQUIREMENTS ARE MORE STRINGENT THAN SHOWN IN THESE PLANS (IN THE OPINION OF THE ENGINEER). LANDLORD / BUILDING OWNER REQUIREMENTS SHALL GOVERN.



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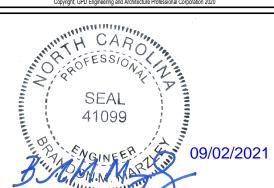
THE OTHER (EXCEPT STATED ABOVE) UNTIL A

WRITTEN AGREEMENT IS FULLY EXECUTED BY

BOTH PARTIES.



520 SOUTH MAIN ST, SUITE 2531 AKRON, OH 44311 P: 330-572-2100 F: 330-572-2101 GPD PROJECT NO: 2020261.36



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For Construction

STORE #: PROJECT #: ISSUE DATE: **DESIGN MANAGER:**

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09/01/21 ASHLEY SUEIRAS PRODUCTION DESIGNER: GPD GROUP CHECKED BY: GPD GROUP

Revision Schedule

Description

MECHANICAL NOTES

SCALE: AS SHOWN SHEET NUMBER:

M001

MECHANICAL SCOPE OF WORK SUMMARY

THE FOLLOWING SCOPE OF WORK IS BASED ON THE LANDLORD'S WORK LETTER EXHIBIT C. THIS SCOPE OF WORK IS NOT INTENDED TO INDICATE THE FULL SCOPE, BUT ONLY A BROAD SUMMARY. THE GENERAL CONTRACTOR SHALL REFERENCE THE COMPLETE WORK LETTER FOR A MORE DETAILED DESCRIPTION OF WORK BY BOTH PARTIES. ANY QUESTIONS REGARDING SCOPE SHALL BE BROUGHT TO STARBUCKS ATTENTION FOR CLARIFICATION. RESPONSIBILITY INDICATED BELOW MEANS FURNISHED, PERMITTED AND INSTALLED BY THE PARTY INDICATED.

WORK DESCRIPTION	RESPO	NSIBILITY
WORK DESCRIPTION	LANDLORD	STARBUCKS
HVAC UNIT AND CURB ADAPTER	Х	
STRUCTURAL CURB	Х	
HVAC UNIT ECONOMIZERS AND RELIEF	x	
SMOKE DETECTORS IN DUCTWORK AND INTERLOCK		х
THERMOSTATS AND CONTROLS		Х
EMS CONTROLS		X
MOTORIZED DAMPERS FOR BACKDRAFT	х	
EXHAUST FAN, CURB AND MOTORIZED DAMPER	х	
DUCTWORK 12" OR LARGER		Х
DUCTWORK 10" OR SMALLER		Х
MOTORIZED DAMPERS FOR CONNECTIONS	х	
GAS SERVICE AND METER	Х	
GAS PIPING TO SPACE	X	
GAS PIPING TO HOT WATER TANK		Х
GAS PIPING TO HVAC UNITS		Х
LOUVERS FOR INTAKES, EXHAUST AND PRESSURE RELIEF	х	

KEYED NOTES

- 1. ROUTE 32"x18" SUPPLY AND 32"x18" RETURN DUCT UP THROUGH ROOF AND CONNECT TO RTU-1. TRANSITION TO FULL SIZE CONNECTIONS AT UNIT, PROVIDE WITH FLEXIBLE DUCT CONNECTION TO UNIT. REFER TO SHEET M102 FOR FURTHER INFORMATION. COORDINATE EXACT LOCATION PRIOR TO START OF ANY WORK. ENSURE SUPPLY AND RETURN DUCTS PENETRATE ROOF BETWEEN TRUSSES AND THE OUTSIDE AIR INTAKE IS LOCATED 10FT FROM ANY VENT.
- 2. ROUTE 32"x18" SUPPLY AND RETURN DUCT UP THROUGH ROOF AND CONNECT TO RTU-2. TRANSITION TO FULL SIZE CONNECTIONS AT UNIT, PROVIDE WITH FLEXIBLE DUCT CONNECTION TO UNIT. REFER TO SHEET M102 FOR FURTHER INFORMATION. COORDINATE EXACT LOCATION PRIOR TO START OF ANY WORK. ENSURE SUPPLY AND RETURN DUCTS PENETRATE ROOF BETWEEN TRUSSES AND THE OUTSIDE AIR INTAKE IS LOCATED 10FT FROM ANY VENT.
- 3. ROUTE 10"x10" EXHAUST DUCT UP THROUGH ROOF AND CONNECT TO EXHAUST FAN. TRANSITION TO FULL SIZE CONNECTIONS AT UNIT. REFER TO SHEET M102 FOR FURTHER INFORMATION. EXHAUST FAN SHALL RUN CONTINUOUSLY WHEN STORE IS OCCUPIED AND SHALL TURN OFF WHEN STORE IS NOT OCCUPIED. EXHAUST FAN CONTROL SHALL BE ACCOMPLISHED WITH LCP. COORDINATE WITH ELECTRICAL, SEE SCHEDULE FOR SIZE.
- 4. WALL MOUNTED THERMOSTAT FOR RTU-1, AND RTU-2 AT 48" A.F.F. THERMOSTAT SHALL BE 7-DAY PROGRAMMABLE WITH NIGHT SETBACK AND A MINIMUM 5 DEGREE DEADBAND. CONFIRM HEIGHT COMPLIES WITH BARRIER FREE, AND ALL OTHER LOCAL REQUIREMENTS. MULTIPLE THERMOSTATS SHALL BE STACKED IN A VERTICAL CONFIGURATION WITH A MINIMUM OF 8" CLEARANCE BELOW EACH THERMOSTAT. LABEL EACH THERMOSTAT TO THEIR RESPECTIVE UNIT. THERMOSTATS AND ALL ASSOCIATED EQUIPMENT SHALL BE INSTALLED BY GENERAL CONTRACTOR.

- 5. REMOTE TEMPERATURE SENSOR AT 60" A.F.F ON WALL.
- 6. MANUAL BALANCING DAMPER (TYPICAL). DAMPERS SHALL NOT BE INSTALLED AT THE GRILLE/NECK UNLESS SHOWN.
- 7. CO2 SENSOR LOCATED AT 60" A.F.F. ON WALL. INTERLOCK WITH RESPECTIVE HVAC UNIT AND SEE M001 FOR FURTHER INFORMATION. COORDINATE CONTROLS WITH HVAC UNIT AND PROVIDE ADDITIONAL CONTROL COMPONENTS AS MAY BE NEEDED FOR A COMPLETE AND OPERATIONAL SYSTEM.
- 8. CO2 ALARM SHALL BE MOUNTED AT 48" A.F.F. NEXT TO MANAGER'S STATION, COORDINATE WITH ELECTRICAL FOR POWER RECEPTACLE.
- 9. PROVIDE AND INSTALL DUCT MOUNTED SMOKE DETECTOR IN RETURN AIR PLENUM. INTERLOCK SMOKE DETECTOR WITH RESPECTIVE RTU TO SHUT DOWN UNIT UPON DETECTION OF SMOKE. COORDINATE WITH ELECTRICAL AND SEE POWER SHEETS FOR FURTHER REQUIREMENTS AND REMOTE ANNUNCIATOR. INTERCONNECT WITH CENTRAL SYSTEM IF APPLICABLE. (SEE DETAIL).
- 10. TURN RETURN DUCT IN JOIST SPACE WITH 90° ELBOW.
- 11. VENT TO WATER HEATER. LOCATE A CODE MINIMUM DISTANCE AWAY FOR OUTSIDE AIR INTAKES AND PARAPET ON ROOF. OFFSET AS NEEDED. IF ADDITIONAL SEPARATION IS NEEDED, EXTEND FLUE TO 3 FT ABOVE INTAKE OR PER AHJ.
- 12. ROUTE 1" GAS PIPING DOWN FROM CEILING SPACE AND CONNECT TO WATER HEATER. PROVIDE AND INSTALL GAS SHUT-OFF VALVE AND 6" DIRT LEG, AND UNION PRIOR TO FINAL CONNECTION. SEE SHEET M102 FOR MORE INFORMATION.

GENERAL NOTES

13. CARBON MONOXIDE SENSOR LOCATED AT 60" A.F.F. ON WALL.

COMPONENTS AS MAY BE NEEDED FOR A COMPLETE AND

14. CARBON MONOXIDE ALARM SHALL BE MOUNTED AT 48" A.F.F.

FURTHER INFORMATION. COORDINATE CONTROLS WITH

HVAC UNIT AND PROVIDE ADDITIONAL CONTROL

NEXT TO MANAGER'S STATION, COORDINATE WITH

16. YOUNG REGULATOR MODEL 5020CC DAMPER AND 270-275

SHALL BE FASTENED TO THE INSIDE OF LINEAR SLOT

REMOTE CABLE OPERATOR. REMOTE CABLE OPERATOR

DIFFUSER PLENUM WITHIN AIRSTREAM. REMOTE CABLE SHALL BE ACCESSIBLE FROM DIFFUSER SLOT. PROVIDE

YOUNG REGULATOR MODEL 030 WRENCH TO OPERATE

ELECTRICAL FOR POWER RECEPTACLE.

ASSOCIATED DAMPER.SEE DETAIL M501

15. DUCT SHALL BE MOUNTED AS HIGH AS POSSIBLE.

OPERATIONAL SYSTEM.

INTERLOCK. WITH RESPECTIVE HVAC UNIT AND SEE M001 FOR

- A. SEE ARCHITECTURAL SHEETS FOR PAINTING AND COLORS OF ALL EXPOSED DUCTWORK, DIFFUSERS AND GRILLES.
- B. SEE ARCHITECTURAL SHEETS FOR DIMENSIONED DIFFUSER & EXPOSED DUCT LOCATIONS.
- C. DIFFUSERS AND RETURN GRILLES SHALL BE CENTERED IN CEILING TILE, UNLESS OTHERWISE NOTED.
- D. REFERENCE LANDLORD WORK LETTER FOR DIVISION OF MECHANICAL SCOPE OF WORK AND COORDINATE WITH STARBUCKS CONSTRUCTION MANAGER.



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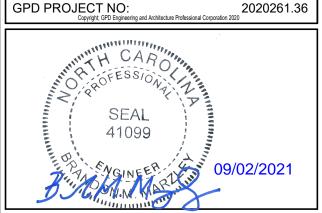
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STARBUCKS TEMPLATE VERSION: i2021-01-22

BOTH PARTIES.



520 SOUTH MAIN ST, SUITE 2531 AKRON, OH 44311 P: 330-572-2100 F: 330-572-2101



24 & BKINKLEY HIL

STORE #:
PROJECT #:
ISSUE DATE:

59763 85334-001 For Construction 09/01/21 ER: ASHLEY SUEIRAS

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PRODUCTION DESIGNER: GPD GROUP CHECKED BY: GPD GROUP


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Rev Date By Description


MECHANICAL DESIGN PLAN


SCALE: AS SHOWN
SHEET NUMBER:

M101

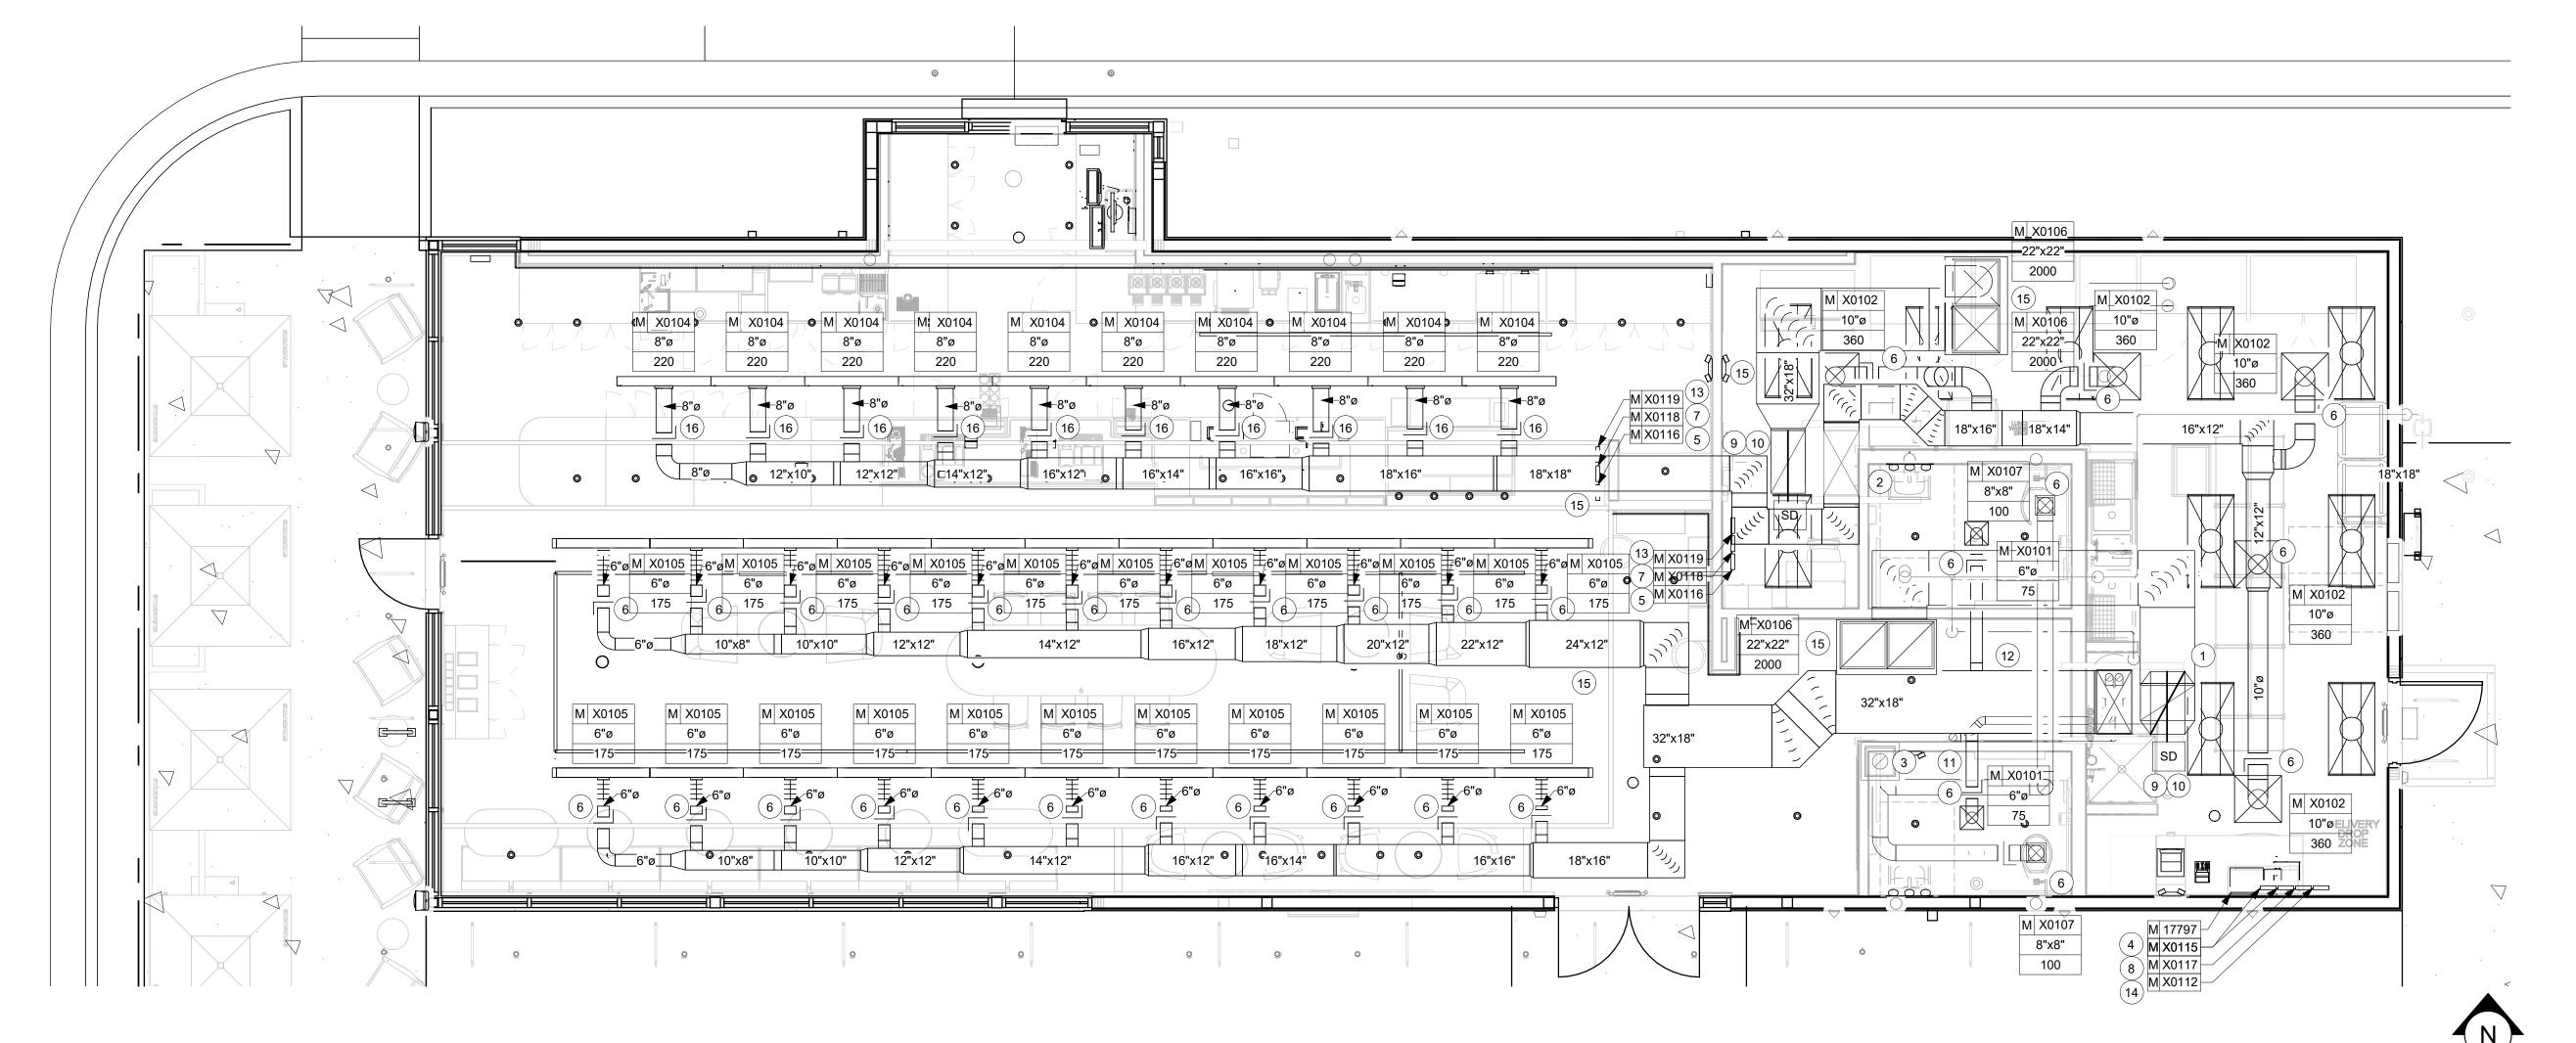

1ST FLOOR - MECHANICAL ROOF PLAN
Scale: 1/4" = 1'-0"

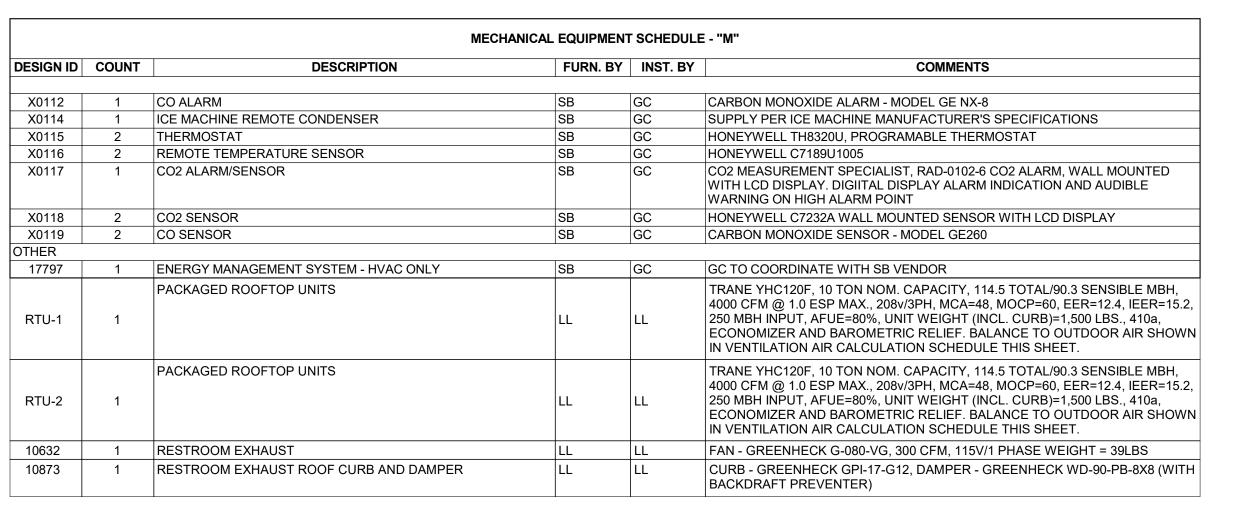

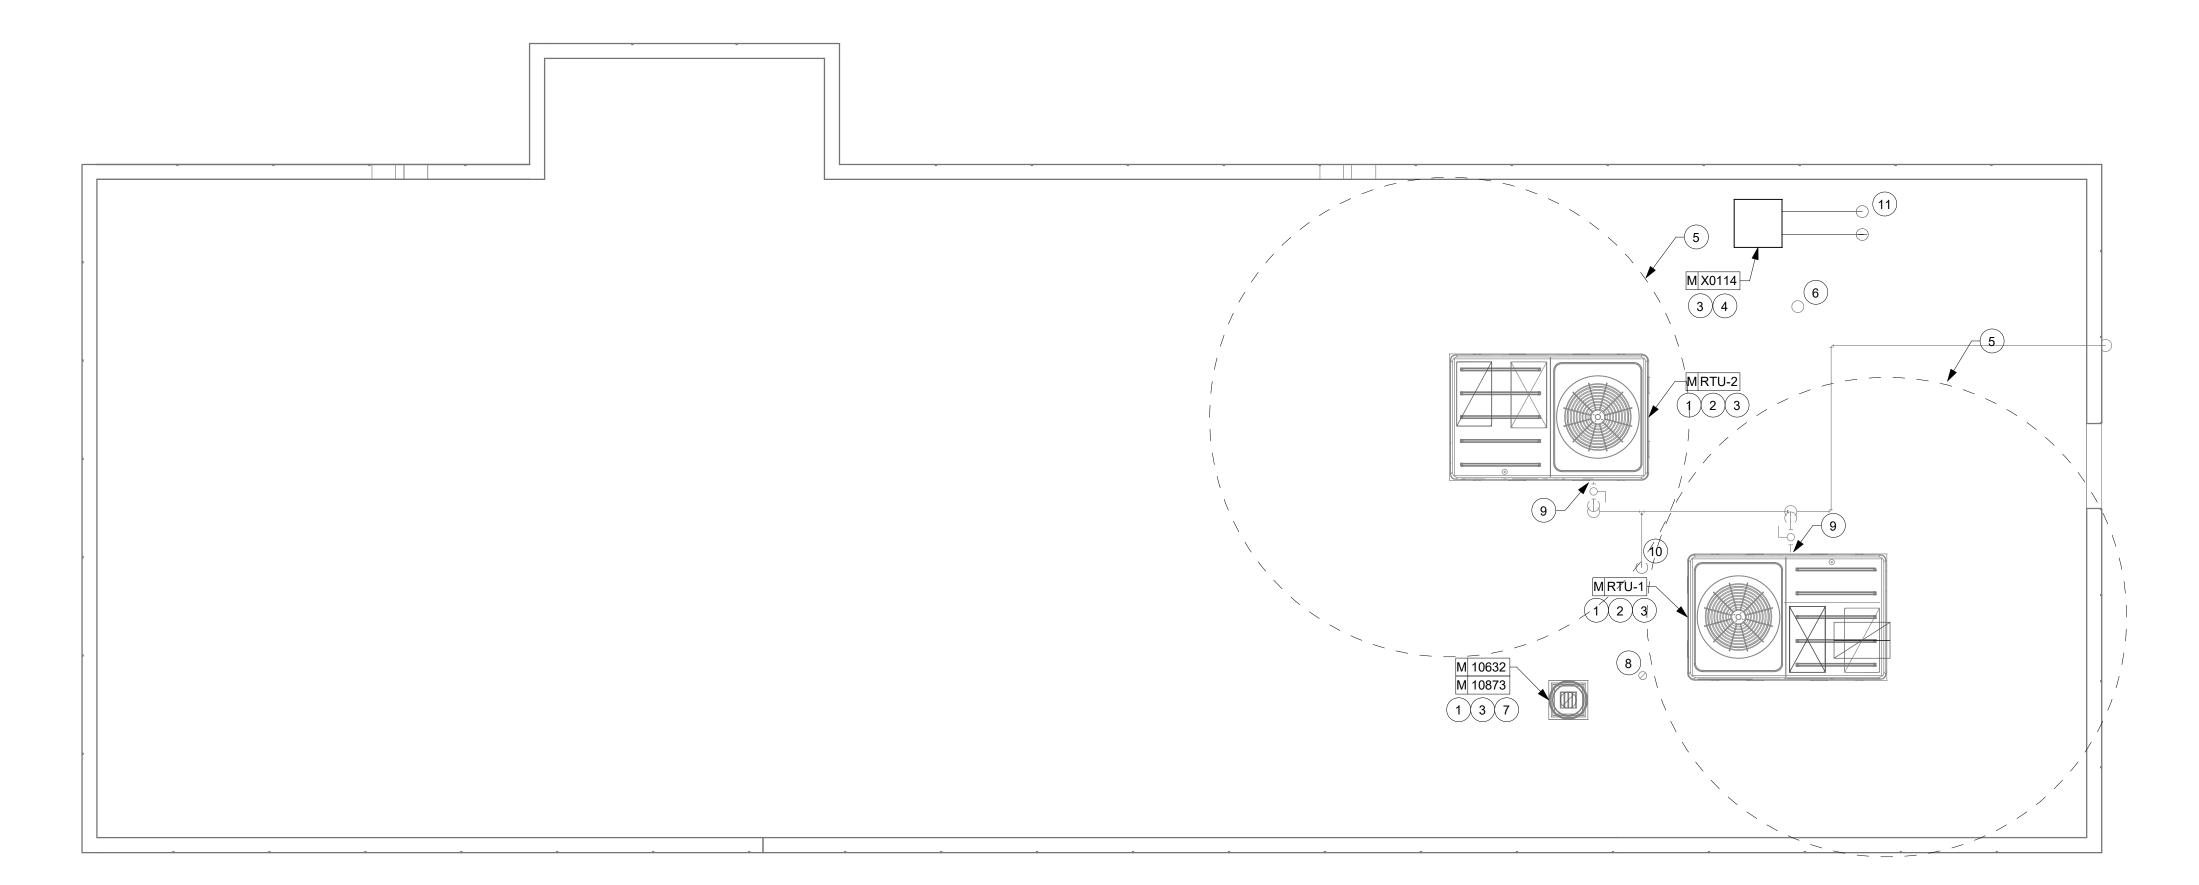

KEYED NOTES

- COORDINATE WITH ELECTRICAL CONTRACTOR FOR POWER CONNECTION TO ALL MECHANICAL EQUIPMENT.
- 2. ROOFTOP AC UNIT PROVIDED AND INSTALLED BY LANDLORD, VERIFY EXACT LOCATION PRIOR TO START OF ANY WORK. VERIFY THAT OUTSIDE AIR INTAKE IS LOCATED A MINIMUM OF 10'-0" FROM ANY VENT OR EXHAUST OPENINGS.
- 3. REFER TO DETAILS ON SHEET M501 FOR FURTHER INFORMATION.
- 4. ICE MACHINE: CONTRACTOR SHALL PROVIDE AND INSTALL PRECHARGED REFRIGERANT LINES FROM ICE MACHINE TO REMOTE CONDENSER, SIZED PER MANUFACTURER'S REQUIREMENTS. COORDINATE WITH G.C. FOR EXACT LOCATION AND SUPPORT OF CONDENSER. REFER TO DETAILS ON SHEET M501 FURTHER INFORMATION. ROOF PENETRATIONS SHALL BE PROVIDED BY LANDLORD'S ROOFING CONTRACTOR. ALL ROOF PENETRATIONS SHALL BE MADE WEATHER TIGHT BY LANDLORD'S ROOFING CONTRACTOR. COORDINATE WITH LANDLORD'S ROOFING CONTRACTOR.
- 5. 10'-0" CLEARANCE FOR OUTSIDE AIR INTAKE.
- 6. 3" VENT THROUGH ROOF. REFER TO PLUMBING PLANS FOR CONTINUATION. ROOF PENETRATIONS SHALL BE PROVIDED BY LANDLORD'S ROOFING CONTRACTOR. LANDLORD'S ROOFING CONTRACTOR SHALL MAKE ALL PENETRATIONS WEATHER TIGHT.
- 7. ROOFTOP EXHAUST FAN PROVIDED AND INSTALLED BY LANDLORD, VERIFY EXACT LOCATION PRIOR TO START OF ANY WORK. ROOF CURB SHALL BE INSTALLED AND MADE WEATHER TIGHT BY LANDLORD'S ROOFING CONTRACTOR. VERIFY THAT DISCHARGE IS LOCATED A MINIMUM OF 10'-0" FROM ANY OUTDOOR INTAKES.
- 8. VENT FOR WATER HEATER. ROOF PENETRATIONS SHALL BE MADE BY LANDLORD'S ROOFING CONTRACTOR. ALL ROOF PENETRATIONS SHALL BE MADE WEATHER TIGHT BY LANDLORD'S ROOFING CONTRACTOR. COORDINATE WITH LANDLORD'S ROOFING CONTRACTOR.
- CONTRACTOR SHALL CONNECT 1" GAS LINE TO ROOFTOP UNIT, CONTRACTOR SHALL PROVIDE GAS SHUT-OFF VALVE, 6" DIRT LEG, AND UNION PRIOR TO FINAL CONNECTION.
- 10. 1" GAS PIPING DOWN THRU ROOF FOR WATER HEATER. SEE SHEET M101 FOR MORE INFORMATION. ROOF PENETRATIONS SHALL BE BY LANDLORD'S ROOFING CONTRACTOR. ALL ROOF PENETRATIONS SHALL BE MADE WEATHER TIGHT BY LANDLORD'S ROOFING CONTRACTOR. COORDINATE WITH LANDLORD'S ROOFING CONTRACTOR.
- 11. REFRIGERATION PIPING FROM ICE MACHINE CONDENSING UNIT. EXTEND REFRIGERATION PIPING AS SHOWN DOWN THRU ROOF FOR CONNECTION TO ICE MACHINE PER MANUFACTURER RECOMMENDATIONS. REFRIGERATION LINES TO BE INSTALLED BY STARBUCKS GENERAL CONTRACTOR.



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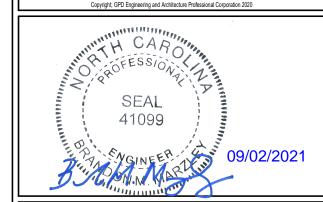
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520 SOUTH MAIN ST, SUITE 2531 AKRON, OH 44311 P: 330-572-2100 F: 330-572-2101 GPD PROJECT NO: 20



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PROJECT ADDRESS: 2778 NC-24

| STORE #: 59763 |
| PROJECT #: 85334-001 |
| ISSUE DATE: For Construction 09/01/21 |
| DESIGN MANAGER: ASHLEY SLIER

DESIGN MANAGER: 09/01/21
ASHLEY SUEIRAS
PRODUCTION DESIGNER: GPD GROUP
CHECKED BY: GPD GROUP

Revision Schedule

Rev	Date	Ву	Description


SHEET TITLE:
MECHANICAL ROOF
PLAN


SCALE: AS SHOWN
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мвек: М102


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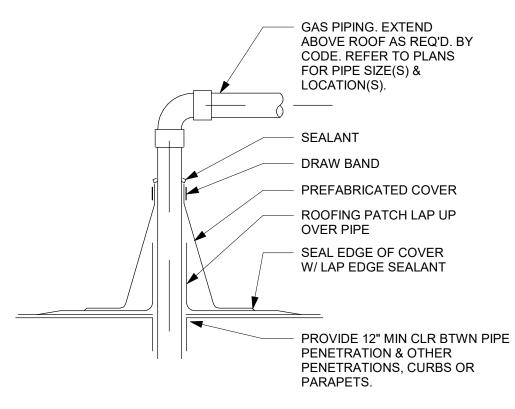





2 LAY-IN CLG DIFFUSER DETAIL Scale: NTS

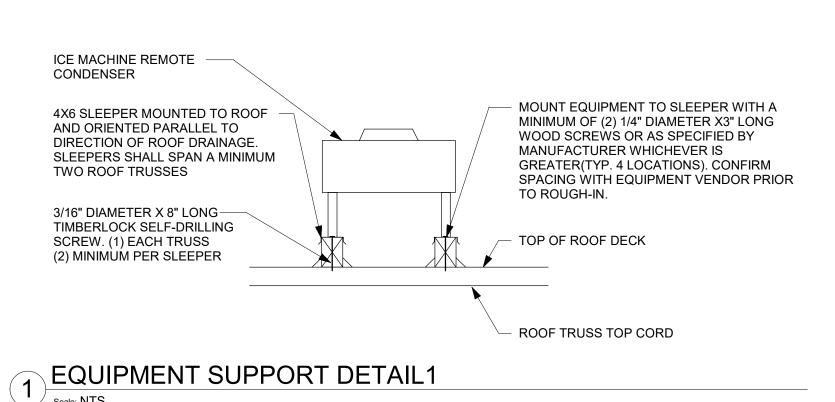

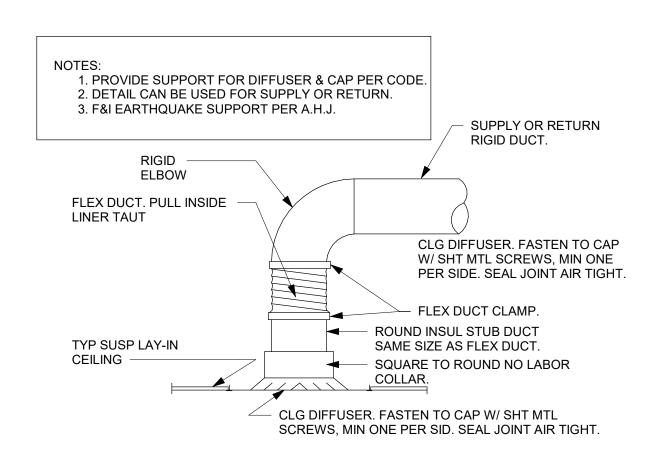
3 PIPE SUPPORT DETAIL

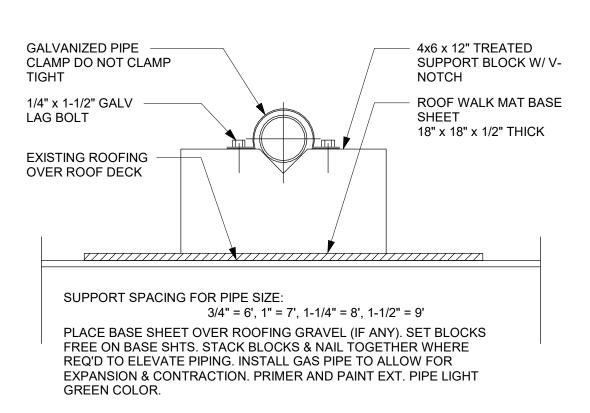


4 PIPE/ROOF PENETRATION DETAIL

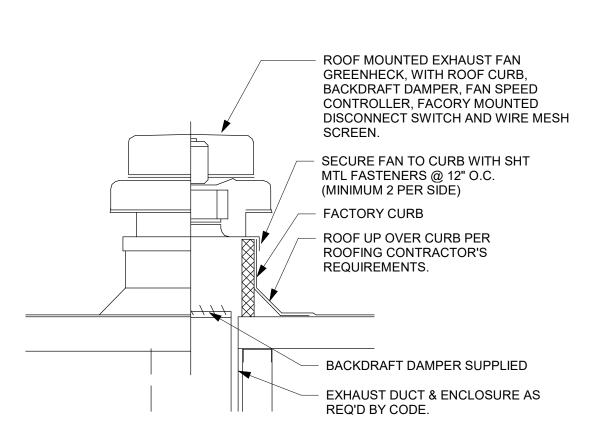

5 ROOF EXHAUST FAN

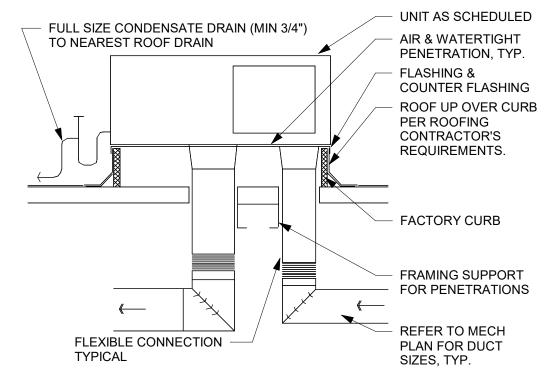

ROOFTOP AIR HANDLING UNIT DETAIL

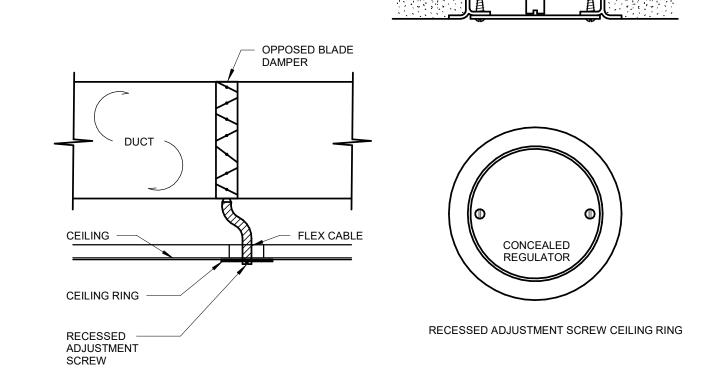

FLEX CABLE -

3/8" CRS DAMPER ROD PRESS FIT

REMOTELY ADJUSTABLE BALANCING DAMPER DETAIL

NOTES:

1. THIS DETAIL APPLIES TO ALL BRANCH RUNOUTS ABOVE HARD CEILINGS.



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SEAL 41099

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PROJECT ADDRE 2778 NC-24 CAMERON,

STORE #: 59763 PROJECT #: 85334-001 ISSUE DATE: For Construction 09/01/21 **ASHLEY SUEIRAS** DESIGN MANAGER:

PRODUCTION DESIGNER: GPD GROUP CHECKED BY: GPD GROUP

Rev Date By Description

Revision Schedule

MECHANICAL DETAILS

SCALE: AS SHOWN

SHEET NUMBER:

M501

HVAC SCHEDULE							
Design ID	COUNT	DESCRIPTION	FURN. BY	INST. BY	COMMENTS		
X0101	2	SUPPLY DIFFUSER	GC	GC	TITUS TDC 6"Ø NECK 12"x12" FACE		
X0102	5	SUPPLY DIFFUSER	GC	GC	TITUS TDC 10"Ø NECK 24"x24" FACE		
X0104	10	SUPPLY DIFFUSER	GC	GC	TITUS FL-15, 1.5" SLOT, 1 SLOT, 8"Ø INLET, 4 FT LONG, BORDER TYPE 11		
X0105	22	SUPPLY DIFFUSER	GC	GC	TITUS FL-15, 1.5" SLOT, 1 SLOT, 6"Ø INLET, 4 FT LONG, BORDER TYPE 11		
X0106	4	RETURN GRILLE	GC	GC	TITUS 350RL 22"x22" NECK, 24"x24" FACE		
X0107	2	EXHAUST GRILLE	GC	GC	TITUS 350RL 8"x8" NECK, 10"x10" FACE		

MARK	AREA SERVED	OCCUPANCY CATEGORY	ZONE AREA (Az)	OCCUPANCY DENISTY (P/1000 SF)	ZONE POPULATION (Pz)	OUTDOOR AIR CFM PER PERSON (Rp)	OUTDOOR AIR CFM PER SF (Ra)	ZONE AIR EFFECTIVENESS (Ez)	MINIMUM OUTDOOR AIR (CFM)	
RTU-1	BAR	BAR - KITCHEN	624	STAFF COUNT	7	7.5	0.12	0.8	160	
	WORKROOM	OFFICE / STORAGE	522	STAFF COUNT	2	5	0.18	0.8	130	-
								TOTAL	290	_
MARK	AREA SERVED	OCCUPANCY CATEGORY	ZONE AREA (Az)	OCCUPANCY DENISTY (P/1000 SF)	ZONE POPULATION (Pz)	OUTDOOR AIR CFM PER PERSON (Rp)	OUTDOOR AIR CFM PER SF (Ra)	ZONE AIR EFFECTIVENESS (Ez)	MINIMUM OUTDOOR AIR (CFM)	MAXIMUM DC\ OUTDOOR AIF (CFM)
RTU-1	SEATING	FAST FOOD - DINING	1009	SEAT COUNT	34	7.5	0.18	0.8	546	
	RESTROOMS	FAST FOOD - DINING	107	SEAT COUNT	0	7.5	0.18	0.8	24	
								TOTAL	570	600

NOTES: 1. SEATING ZONE POPULATION IS BASED UPON SEAT COUNT WITH NO DIVERSITY.
2. HVAC UNITS SHALL BE BALANCED TO PROVIDE THE MINIMUM DCV OUTDOOR AIR QUANTITIES INDICATED.

3. ADDITIONAL VENTILATION IS REQUIRED FOR (1) WARMING OVEN AND (1) DISHWASHER.

4. MAXIMUM DCV VENTILATION AIR SHOWN SHALL BE CONTROLLED BY CO2 SENSOR (SEE OTHER CONTROL NOTES).

RESTROOM EXHAUST CALCULATION (BASED ON THE 2018 NORTH CAROLINA MECHANICAL CODE)							
MARK	AREA SERVED	NUMBER OF WATER CLOSETS / URINALS	CFM PER WC / UR	TOTAL MINIMUM EXHAUST CFM	PROPOSED EXHAUST CFM		
RTU-1	RESTROOMS	2	75	150	160		

APPROXIMATE GAS REQUIREMENTS: SYSTEM IS SIZED FROM LOW PRESSURE GAS (10" W.C. AT 0.3" W.C. PRESSURE DROP) OVERALL SYSTEM LENGTH OF 125'

> HWH = 200.0 MBHRTU-1 = 150.0 MBH RTU-2 = 150.0 MBH

TOTAL = 500.0 MBH



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520 SOUTH MAIN ST, SUITE 2531 AKRON, OH 44311 P: 330-572-2100 F: 330-572-2101 GPD PROJECT NO:



PROJECT ADDRES 2778 NC-24 CAMERON,

STORE #: 59763 85334-001 PROJECT #: ISSUE DATE: For Construction 09/01/21 ASHLEY SUEIRAS DESIGN MANAGER:

PRODUCTION DESIGNER: GPD GROUP CHECKED BY: GPD GROUP

Revision	Schedule

SHEET TITLE: MECHANICAL SCHEDULES SCALE: AS SHOWN

SHEET NUMBER:

M601

APPROX

BLDG

CLG

CXA

DEG

DN

DTL

EΑ

ELEC

EMER

EXIST

EXT

FD

FS

F&I

FOIO

FLR

FT

GC

HW

HS

HWS

LV

MAX

MDP

MEP

MFG

PC

PS

REF

REV

TEL

TEMP

TMV

UC

UNO

WCO

REQ'D

MECH

DWG(S)

CONST

AUTHORITIES HAVING JURISDICTION

ABOVE FINISHED FLOOR

DOMESTIC COLD WATER

COMMISSIONING AGENT

ELECTRICAL CONTRACTOR

APPROXIMATE

CONSTRUCTION

BUILDING

CEILING

DEGREES

DRAWING(S)

ELECTRICAL

EXISTING

EXTERIOR

FLOOR

FOOT/FEET

FLOOR CLEANOUT

GREASE WASTE

CONDITIONING

HOT WATER SUPPLY

HOT WATER RETURN

MECHANICAL CONTRACTOR

MECHANICAL, ELECTRICAL, AND PLUMBING

MAIN DISTRIBUTION PANEL

PLUMBING CONTRACTOR

POINT OF CONNECTION

HOT WATER

HANDSINK

LANDLORD

MAXIMUM

MOP SINK

NIGHTLIGHT

PRFP SINK

REFERENCE

REQUIRED

SQUARE FEET

TELEPHONE

TEMPORARY

TYPICAL

VENT

SPECIFICATION(S)

STAINLESS STEEL

UNDER COUNTER

SANITARY WASTE

WALL CLEANOUT

WATER HEATER

WEATHER PROOF

TEMPERATURE MIXING VALVE

UNLESS NOTED OTHERWISE

TEMPERED HOT WATER

REVISION

NOT TO SCALE

LOW VOLTAGE

MECHANICAL

MANUFACTURER MINIMUM

EMERGENCY

FLOOR DRAIN

FLOOR SINK

FURNISH & INSTALL

FURNISHED BY OWNER

FURNISHED BY OWNER

INSTALLED BY OWNER

GENERAL CONTRACTOR

GROUND FAULT CIRCUIT INTERRUPTER

HEATING, VENTILATION, AND AIR

INSTALLED BY CONTRACTOR

DOWN

DETAIL

S OR W SANITARY OR WASTE PIPING ABOVE SLAB

SANITARY OR WASTE PIPING BELOW SLAB **VENT PIPING** GW **GREASE WASTE** CD CONDENSATE DRAIN **COLD WATER PIPING** HOT WATER PIPING CWF CWN ____CWN____

COLD WATER FILTERED COLD WATER NANO FILTERED COLD WATER SOFTENED ----CWS-----TW TEMPERED WATER _____TW ____ RO _____RO____ REVERSE OSMOSIS WATER **GAS PIPING**

RD REFRIGERANT DISCHARGE PIPING RS REFRIGERANT SUCTION PIPING

BALL VALVE GV GATE VALVE CH. V CHECK VALVE

WCO

FCO

FS

RELIEF VALVE

SHOCK ABSORBER

WALL CLEANOUT

FLOOR CLEANOUT

FLOOR SINK

WATER METER

CONNECT TO EXISTING

HOSE BIBB

STRAINER

D. INSTALLATION VERIFICATION SHALL BE PERFORMED BY CXA INSTALLATION VERIFICATION EFFORTS AS NECESSARY. PROVIDE ALL ACCESS AND EQUIPMENT NECESSARY FOR STARBUCKS STAFF TO VERIFY THAT THE EQUIPMENT IS

DEFECTS DISCLOSED BY THE INSTALLATION VERIFICATION

G. CONTRACTOR SHALL INFORM STARBUCKS CXA WHEN EQUIPMENT IS READY FOR FUNCTIONAL PERFORMANCE TESTING, ALL EQUIPMENT SHALL BE READY FOR FUNCTIONAL PERFORMANCE TESTING PRIOR TO STARTING TESTING. CONTRACTOR SHALL OPERATE EQUIPMENT FOR STARBUCKS OF EQUIPMENT, RESPONSE OF SENSORS, AND PROPER EXECUTION OF HVAC CONTROL AND LIGHTING SEQUENCES: SOUND, AND CONTROL RESPONSE. PROVIDE ANY SECURIT ACCESS, HARDWARE, SOFTWARE, OR OTHER SUPPORT AS NEEDED FOR THE STARBUCKS CXA TO EFFICIENTLY WITNESS AND DOCUMENT ALL EQUIPMENT TESTING. STARBUCKS CXA TESTING SEQUENCES AND PREPARE A LIST OF ANY TESTS FOR CORRECTION BY THE CONTRACTOR. EQUIPMENT INCLUDES, BUT IS NOT LIMITED TO, AIR HANDLING UNITS. COPIES OF ALL START UP REPORTS, FILLED OUT ON THE MANUFACTURER'S FORMS, TO THE STARBUCKS CXA.

OR DEFICIENCIES DISCLOSED DURING THE FUNCTIONAL MADE IN A TIMELY MANNER WITHOUT DISRUPTION TO THE SYSTEM AND CONSTRUCTION SCHEDULE.

TESTING OF EQUIPMENT DEEMED NECESSARY BY STARBUCKS CXA DURING INSTALLATION VERIFICATION AND FUNCTIONAL PERFORMANCE TESTING. CONTRACTOR IS RESPONSIBLE FOR CORRECTING ANY ISSUES OR DEFICIENCIES FOUND IN THE SYSTEM DURING ANY AND ALL RE-TESTING. CORRECTIONS SHOULD BE MADE IN A TIMELY MANNER WITHOUT DISRUPTION TO THE SYSTEM AND CONSTRUCTION SCHEDULE. DELIVERABLES: FINAL BALANCE REPORT, DEFICIENCIES LIST NOTING CORRECTIVE ACTIONS PERFORMED BY CONTRACTOR IN RESPONSE TO INSTALLATION VERIFICATION AND FUNCTIONAL

J. CONSTRUCTION AND POST CONSTRUCTION TESTING: PROCESSES THAT MAY OCCUR OUT OF SEQUENCE WITH COMMISSIONING SERVICE. CONTRACTOR SHALL CONDUCT, DOCUMENT, SUPPORT AND SCHEDULE THIS TESTING AS DIRECTED BY STARBUCKS CXA

SYSTEM COMMISSIONING

CONTRACTOR RESPONSIBILITIES FOR BUILDING COMMISSIONING

CONTRACTOR SHALL PROVIDE SUPPORT AND WORK AS SPECIFIED. NEEDED AND REQUIRED TO CONDUCT AND FACILITATE STARBUCKS STAFF BUILDING COMMISSIONING EFFORTS. THIS WORK WILL BE COMPRISED OF THREE DISTINCT EFFORTS:

1) SUPPORT STARBUCKS COMMISSIONING AGENT (CXA) DURING INSTALLATION VERIFICATION AND CORRECT DISCLOSED

2) PERFORM TESTING, ADJUSTING, BALANCING AND SYSTEM STARTUP AND SUPPORT FUNCTIONAL PERFORMANCE TESTING BY STARBUCKS

3) CORRECT DEFICIENCIES DISCLOSED BY FUNCTIONAL PERFORMANCE TESTING AND SUBMIT REPORTS. CONTRACTOR SHALL PERFORM AND PROVIDE THE FOLLOWING:

A. SYSTEMS SUBJECT TO COMMISSIONING MAY INCLUDE. BUT ARE NOT LIMITED TO, DOMESTIC HOT WATER GENERATION.

B. CONTRACTOR SHALL INCLUDE COMMISSIONING ACTIVITIES IN PROJECT SCHEDULE AND SHOW INTERVALS FOR PERFORMANCE OF WORK FOR WHICH CONTRACTOR IS RESPONSIBLE AND INTERVALS FOR WORK PERFORMED BY STARBUCKS CXA. CONTRACTOR SHALL SHOW RESOURCES FOR PERFORMING ALL WORK RELATED TO COMMISSIONING ACTIVITIES ON A LINE ITEM IN THE SCHEDULE OF VALUES.

C. CONTRACTOR SHALL INSTALL EQUIPMENT IN ACCORDANCE WITH THE MANUFACTURER'S REQUIREMENTS AND ALL CONTRACT DOCUMENTS. ENSURE THAT ALL EQUIPMENT IS INSTALLED TOTALLY COMPLETE, AND ACCESSIBLE TO STARBUCKS CXA FOR INSTALLATION VERIFICATION AND FUNCTIONAL PERFORMANCE TESTING PRIOR TO THE SCHEDULED START OF INSTALLATION VERIFICATION.

STARBUCKS CXA. CONTRACTOR SHALL SUPPORT STARBUCKS INSTALLED CORRECTLY.

E. CONTRACTOR SHALL BE READILY AVAILABLE DURING INSTALLATION VERIFICATION TO CORRECT ANY DEFICIENCIES OR PROCESS. CORRECTIONS SHALL BE MADE IN A TIMELY MANNER WITHOUT DISRUPTION OF THE CONSTRUCTION SCHEDULE.

F. ALL DOMESTIC WATER HEATING, RECIRCULATING, FILTER AND SOFTENING EQUIPMENT SHALL BE TESTED AND/OR ADJUSTED AND BALANCED BY THE CONTRACTOR'S TESTING, ADJUSTING AND BALANCE AGENT (SEE TESTING ADJUSTING AND BALANCING) OR THE MANUFACTURER'S CERTIFIED STARTUP REPRESENTATIVE AFTER THE SYSTEM IS VERIFIED TO BE COMPLETE AND CORRECT BY STARBUCKS CXA IN ACCORDANCE WITH THE REQUIREMENTS OF THESE DOCUMENTS. SEQUENCES OF OPERATION SHALL BE TESTED TO ENSURE THAT THEY OPERATE IN ACCORDANCE WITH THE CONTRACT REQUIREMENTS. DELIVERABLES: PRELIMINARY, WRITTEN FUNCTIONAL PERFORMANCE REPORT CONFORMING TO THE REQUIREMENTS SPECIFIED HEREIN, DOCUMENTING THE INFORMATION SPECIFIED, ETC. TO THE STARBUCKS CXA IMMEDIATELY UPON COMPLETION OF THE WORK.

CXA AND VERIFY BY DEMONSTRATION THE CORRECT OPERATION INCLUDING BUT NOT LIMITED TO, AIR MOVEMENT, TEMPERATURE, WILL RECORD THE EQUIPMENT OPERATION AND RESPONSE TO DEFICIENCIES DISCLOSED BY THE FUNCTIONAL PERFORMANCE ROOFTOP AND SPLIT TYPE, CONDENSING UNITS, EXHAUST FANS, LIGHTING CONTROLS, ETC. DELIVERABLES: PROVIDE COMPLETED

H. CONTRACTOR IS RESPONSIBLE FOR CORRECTING ANY ISSUES PERFORMANCE TESTING PROCESS, CORRECTIONS SHOULD BE

I. CONTRACTOR SHALL BE READILY AVAILABLE FOR ANY RE-PERFORMANCE TEST RESULTS.

ADDITIONAL TESTING MAY BE REQUIRED BY LEED AND OTHER

VALVES

INSTALL VALVES FOR EACH FIXTURE AND ITEM OF EQUIPMENT. PROVIDE BRAIDED STAINLESS STEEL HOSE (UNLESS OTHERWISE NOTED) BETWEEN VALVE AND EQUIPMENT IN ACCORDANCE WITH MANUFACTURER'S SPECIFICATIONS. LOCATE SHUT-OFF VALVES ADJACENT TO EQUIPMENT FOR EASY ACCESS SUCH THAT VALVES CAN BE REACHED WITHOUT MOVING EQUIPMENT. SHUT OFF VALVES TO BE BALL TYPE. VALVES SHALL BE LISTED/APPROVED FOR USE PER AUTHORITIES HAVING JURISDICTION (AHJ) AND CODE REQUIREMENTS. PROVIDE VALVE IDENTIFICATION PER THE PROJECT MANUAL FOR MAIN WATER SERVICE SHUT-OFF AND ANY OTHER VALVES WHICH ARE NOT CLEARLY EVIDENT WHAT THEY SERVE.

PLUMBING FIXTURES

SIZE WATER HEATER PER STARBUCKS STANDARD AND PER AUTHORITIES HAVING JURISDICTION (AHJ), WHICHEVER IS MORE STRINGENT. PROVIDE INSTALLATION COMPLETE WITH FITTINGS AS SHOWN IN THE DRAWINGS. SET HOT WATER TEMPERATURE AT 140° F OR ADJUST AS REQUIRED BY AHJ. PROVIDE THERMOMETER ON HOT WATER PIPE LEAVING WATER HEATER.

STARBUCKS WATER FILTRATION VENDOR WILL PROVIDE FILTRATION SYSTEM. CONTRACTOR SHALL CONFIRM WITH STARBUCKS CONSTRUCTION MANAGER WHETHER VENDOR OR PLUMBING CONTRACTOR IS TO INSTALL FILTRATION SYSTEM. PROVIDE AND COORDINATE INSTALLATION COMPLETE WITH ALL PIPING, FITTINGS, AND EQUIPMENT AS INDICATED ON THE DRAWINGS.

THE PLUMBING CONTRACTOR SHALL MAKE ALL FINAL CONNECTIONS TO EQUIPMENT INCLUDING REQUIRED MATERIAL SUCH AS PIPING, VALVES, FILTERS, TRAPS, CHECKS VALVES, VACUUM BREAKERS, AND FLEXIBLE AND

REFER TO SCHEDULES ON DRAWINGS FOR A DESCRIPTION OF LISTED ITEMS AND FURNISH ANY AND ALL PLUMBING FIXTURES LISTED AS "GC". ANY DISCREPANCIES ABOUT WHO IS TO PROVIDE PLUMBING FIXTURES IN THE SCHEDULE SHALL BE BROUGHT TO STARBUCKS ATTENTION FOR CLARIFICATION. INSTALL ALL FIXTURES LISTED REGARDLESS OF WHO SUPPLIES.

G.C. TO FURNISH AND INSTALL POWER CORD FOR DISHWASHER PER JURISDICTIONAL REQUIREMENTS. IF EQUIPMENT IS SPECIFIED AS HOBART ADVANSYS, THE UNIT IS TO BE PLUMBED WITH COLD, NON-FILTERED WATER. IF THE WATER FILTRATION SYSTEM IS A PENTAIR CONFIGURATION II OR III, THEN THE COLD, NON-FILTERED WATER MUST ALSO BE SOFTENED.

INSULATION

PROVIDE THERMAL INSULATION PER THE SPECIFICATIONS.

FURNISH AND INSTALL SPECIFIED NO SCALD SAFETY COVERS WITH INSULATED FOAM LINER AND TAMPER PROOF STRAP AT ALL EXPOSED ADA SINK P-TRAPS AND WATER SUPPLIES AND AS REQUIRED BY JURISDICTION

CONDENSATE DRAINAGE PIPING

THE PLUMBING CONTRACTOR SHALL PROVIDE CONDENSATE DRAINS FOR AIR HANDLING UNITS AND STARBUCKS EQUIPMENT (REFER TO COPPER TUBING WITH WROUGHT COPPER SWEAT FITTINGS JOINED WITH 50/50 SOLDER.

ALL PIPES SHALL BE TESTED BY AN APPROVED METHOD BEFORE THEY BACKFILLED OR CONCEALED. AFTER TESTING IS COMPLETE, THE

PLUMBING CONTRACTOR SHALL DISINFECT THE POTABLE WATER SYSTEM AS REQUIRED BY LOCAL AUTHORITY. TEST WATER PURITY ACCORDING TO LOCAL REQUIREMENTS AND SUBMIT CERTIFIED TEST RESULTS TO ENGINEER FOR REVIEW AND APPROVAL

CARBONATION

IF APPLICABLE TO PROJECT SCOPE FOR CBE STATION, STARBUCKS CARBONATION VENDOR WILL PROVIDE AND INSTALL EQUIPMENT, CO2 TANKS AND FITTINGS. STARBUCKS SHALL PROVIDE AND CONTRACTOR SHALL INSTALL CO2 TANK MOUNTING BRACKET, PROTECTIVE SHELVING UNIT AND CO2 GAS TUBING AS SHOWN ON DRAWINGS AND PER MANUFACTURER'S INSTRUCTIONS. MAXIMUM TUBING LENGTH INCLUDING COILED ENDS IS 100 FT (30 M) AND MAXIMUM BEND IS TO 3 INCH (75 MM) MINIMUM RADIUS. ROUTE CO2 TUBING PREFERABLY THROUGH WALL AND/OR CEILING CAVITIES. WITHOUT KINKS AND SO AS TO NOT TOUCH ANY HOT SURFACE (BALLAST, STEAM PIPE, ETC.) OR RUB AGAINST A SHARP EDGE THAT MAY ABRADE OR CUT TUBING. ALL HOLES MUST BE SEALED WITH A GROMMET OR ESCUTCHEON. TUBING IS TO BE SECURED TO APPROPRIATE PERMANENT SURFACES TO KEEP IT OFF THE FLOOR OR CABINET BOTTOMS AND AWAY FROM OTHER EQUIPMENT. LABEL BOTH ENDS OF TUBING AND REGULARLY AT TEN (10) FOOT INTERVALS ALONG ROUTE AS "CO2."

NITROGENATION

STARBUCKS NITROGENATION VENDOR WILL PROVIDE AND INSTALL EQUIPMENT AND FITTINGS IF APPLICABLE TO PROJECT SCOPE FOR NITRO STATION. GENERAL CONTRACTOR SHALL COORDINATE NITRO SYSTEM INSTALLATION WITH STARBUCKS VENDOR.

GENERAL PLUMBING NOTES

- 1. PLUMBING CONTRACTOR SHALL COORDINATE WITH THE GENERAL CONTRACTOR TO PATCH AND REPAIR ALL EXISTING WALLS, FLOORS. CEILINGS OR OTHER SURFACES IDENTIFIED TO REMAIN THAT MAY BECOME DAMAGED DURING THE COURSE OF WORK.
- 2. EXPOSED/SURFACE MOUNTED PIPING IS ONLY ALLOWED IN THE BAR AREA UNDER COUNTERTOPS, WHERE IT DOES NOT OBSTRUCT CABINETS/DEVICES AND WHERE APPROVED BY STARBUCKS CONSTRUCTION MANAGER. IF ROUTED THROUGH CABINETS, IT SHALL BE ROUTED TO MAXIMIZE STORAGE SPACE AND BE PROTECTED FROM DAMAGE.
- 3. DRAWINGS ARE DIAGRAMMATIC AND INDICATE GENERAL INTENT OR ARRANGEMENT OF SYSTEM(S). FURNISH AND INSTALL ALL COMPONENTS NEEDED WHETHER INDICATED OR NOT TO PROVIDE A COMPLETE AND OPERATING SYSTEM. OVERALL CASEWORK COMPONENT DIMENSIONING ON PLUMBING DETAILS ARE SHOWN FOR REFERENCE AND COORDINATION ONLY.
- 4. CONTRACTOR TO VERIFY ALL DIMENSIONS, INCLUDING CLEARANCES REQUIRED BY OTHER TRADES, AND NOTIFY STARBUCKS CONSTRUCTION MANAGER OF ANY DISCREPANCIES PRIOR TO PROCEEDING WITH THE WORK. ALL DIMENSIONS ARE TO THE FACE OF THE FINISHED SURFACE UNLESS NOTED OTHERWISE. ALL DIMENSIONS TO BE TAKEN FROM ACTUAL BUILDING DIMENSIONS
- THE PLUMBING CONTRACTOR SHALL COORDINATE PLUMBING WORK WITH OTHER TRADES. THE ARCHITECTURAL DRAWINGS AND SPECIFICATIONS SHALL TAKE PRECEDENCE OVER ALL OTHER DRAWINGS. SEE ARCHITECTURAL DRAWINGS FOR FIXTURES IN CASEWORK AND PLUMBING DETAILS. SEE THE PROJECT MANUAL FOR PLUMBING SPECIFICATION SECTIONS.
- 6. ALL PIPING AND/OR PLUMBING DEVICES SHALL BE SUPPORTED FROM STRUCTURE (NOT FROM HVAC DUCTS OR OTHER PIPES/CONDUITS).
- 7. WHEN BUNDLING SEVERAL INDIRECT WASTE LINES TO DRAIN INTO FLOOR SINK, A UNISTRUT IS REQUIRED FOR SECURING AND BRACING ALL LINES ABOVE THE DRAIN.
- FURNISH AND INSTALL ALL NEEDED DRAIN LINES PER CODE (NOT ALL SHOWN). INSTALL DRAINS AT 2% SLOPE WHERE POSSIBLE WITHOUT DIPS OR SAGS. ALL INDIRECT DRAINS SHALL RUN SEPARATELY FROM EACH OTHER TO INDIRECT DRAIN RECEPTOR AND SHALL TERMINATE WITH AN AIR GAP PER CODE.
- 9. FURNISH AND INSTALL WALL CLEANOUTS AT ALL SINKS AND AS NEEDED PER CODE (NOT ALL SHOWN).
- 10. INSULATE ICE BIN DRAINAGE PIPES PER THE REQUIREMENTS IN THE PROJECT MANUAL.

GENERAL NOTES

THE INTENT OF THE PROJECT MANUAL AND THE DRAWINGS IS TO PROVIDE A COMPLETE AND FULLY OPERATIONAL PLUMBING SYSTEM. THE CONTRACTOR SHALL FURNISH ALL LABOR, MATERIAL, AND EQUIPMENT RELATED TO THE INSTALLATION OF THE PLUMBING WORK.

HE CONTRACTOR SHALL THOROUGHLY EXAMINE ALL AREAS WHERE FIXTURES, EQUIPMENT, AND PIPING WILL BE INSTALLED AND WILL REPORT ANY CONDITION THAT PREVENTS THE PROPER INSTALLATION OF THE PLUMBING WORK.

EQUIPMENT AND MATERIALS SHALL CONFORM WITH THE APPROPRIATE PROVISIONS OF LISTING STANDARD IN EFFECT AS APPLICABLE TO EACH INDIVIDUAL UNIT OR ASSEMBLY.

ALL WORK SHALL BE PERFORMED IN STRICT ACCORDANCE WITH ALL APPLICABLE PROVINCIAL AND LOCAL CODES AND ORDINANCES. IN CASE OF CONFLICT BETWEEN THE DRAWINGS AND SPECIFICATIONS AND THE CODES AND ORDINANCES, THE HIGHEST STANDARD SHALL APPLY. THE CONTRACTOR SHALL SATISFY CODE REQUIREMENTS AS A MINIMUM STANDARD WITHOUT ANY EXTRA COST TO STARBUCKS.

THE CONTRACTOR SHALL PROCURE AND PAY FOR ALL PERMITS. FEES. AND INSPECTIONS NECESSARY TO COMPLETE THE PLUMBING WORK.

HE CONTRACTOR SHALL UNCONDITIONALLY WARRANT ALL WORK TO BE FREE OF DEFECTS IN MATERIAL AND WORKMANSHIP FOR A PERIOD OF ONE (1) YEAR FROM THE DATE OF FINAL ACCEPTANCE BY STARBUCKS AND WILL REPAIR OR REPLACE ANY DEFECTIVE WORK PROMPTLY AND WITHOUT CHARGE AND RESTORE ANY OTHER EXISTING WORK DAMAGED IN THE COURSE OF REPAIRING DEFECTIVE MATERIALS AND WORKMANSHIP

LANDLORD REQUIREMENTS

PRIOR TO BID: THE CONTRACTOR SHALL COORDINATE WITH LANDLORD / BUILDING OWNER FOR ANY CONSTRUCTION REQUIREMENTS. CONTRACTOR SHALL BECOME COMPLETELY FAMILIAR WITH REQUIREMENTS AND ADHERE TO THEM. WHERE LANDLORD / BUILDING OWNER REQUIREMENTS ARE MORE STRINGENT THAN SHOWN IN THESE PLANS. LANDLORD / BUILDING OWNER REQUIREMENTS SHALL GOVERN.



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STARBUCKS STORE (WHICH IS SUBJECT TO CHANGE AT ANYTIME) AND DO NOT REFLECT ACTUAL SITE CONDITIONS. NEITHER PARTY SHALL HAVE ANY OBLIGATION NOR LIABILITY TO THE OTHER (EXCEPT STATED ABOVE) UNTIL A WRITTEN AGREEMENT IS FULLY EXECUTED BY BOTH PARTIES.

STARBUCKS TEMPLATE VERSION: i2021-01-22



520 SOUTH MAIN ST, SUITE 2531 AKRON, OH 44311 P: 330-572-2100 F: 330-572-2101 GPD PROJECT NO:



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STORE #: 59763 PROJECT #: 85334-001 ISSUE DATE: For Construction **DESIGN MANAGER: ASHLEY SUEIRAS** PRODUCTION DESIGNER: GPD GROUP

Revision Schedule

GPD GROUP

Description

PLUMBING NOTES

SCALE: AS SHOWN

CHECKED BY:

SHEET NUMBER:

WORK DESCRIPTION	RESPO	NSIBILITY
WORK DESCRIPTION	LANDLORD	STARBUCKS
WATER SERVICE AND METER	х	
BOOSTER PUMP FOR WATER SERVICE	х	
BELOW FLOOR / SLAB WASTE, VENT AND WATER PIPES	х	
ABOVE FLOOR / SLAB WASTE, VENT AND WATER PIPES	х	
PLUMBING VENT(S) THROUGH ROOF	х	
EXTERIOR HOSE BIBB(S)	Х	
BASE COVERAGE SPRINKLER SYSTEM	х	
SPRINKLER SYSTEM MODIFICATIONS FOR TENANT BUILDOUT	х	

KEYED NOTES

- 1. WATER HEATER:
 ROUTE 1" COLD AND HOT WATER FROM WATER
 HEATER, UP IN CEILING SPACE. WATER HEATER
 INSTALLATION SHALL BE INCOMPLIANCE WITH
 APPLICABLE CODES AND ORDINANCES, REFER TO
 WATER HEATER DETAIL.
- 2. MOP SINK:
 ROUTE 1/2" HOT AND COLD DOWN IN WALL AND
 CONNECT TO MOP SINK FAUCET. PROVIDE
 APPROVED BACKFLOW PREVENTION DEVICE ON
 SERVICE FAUCET AS REQUIRED. CAULK AND SEAL
 BACK OF SINK TO WALL.
- 3. WATER FILTER:
 ROUTE 3/4" COLD WATER DOWN IN WALL AND
 CONNECT TOWATER FILTER, EXTEND 3/4" FILTERED
 COLD WATER FROM WATER FILTER UP IN WALL TO
 CEILING SPACE. PLUMBING CONTRACTOR TO
 FOLLOW MANUFACTURERS INSTALLATION
 INSTRUCTIONS AND ACTIVATION PROCEDURES FOR
 FILTERS. INSTALL ASSEMBLY ON WALL, REFER TO
 WATER FILTER DETAIL.
- 4. 3-COMPARTMENT SINK: ROUTE 1/2" HOT AND COLD WATER DOWN IN WALL AND CONNECT TO FAUCET AND OVERHEAD SPRAY. CAULK AND SEAL BACK OF SINK TO WALL.
- 5. SANITIZER:
 ROUTE 3/4" COLD WATER DOWN IN WALL AND STUB
 OUT AT 18" A.F.F. PROVIDE WITH SHUT-OFF VALVE
 WITH 3/4" MALE HOSE-END FITTING. SHUT-OFF TO
 INCLUDE PRESSURE REDUCING VALVE, PRESSURE
 GAUGE (SET @ 20 PSIG, +/- 5 PSIG). LINE STRAINER,
 AND SHOCK ARRESTOR IN ALL CONNECT SANITIZER
 TO HW SUPPLY WITH 72" LONG BRAIDED STAINLESS
 STEEL HOSE. PROVIDE AND INSTALL ANY ADDITIONAL
 PIPING AND DEVICES AS REQUIRED FOR COMPLETE
 INSTALLATION.
- 6. ICE MACHINE:
 ROUTE 1/2" FILTERED COLD WATER DOWN IN WALL
 AND CONNECT TO ICE MACHINE, PROVIDE WITH
 REQUIRED BACKFLOW PREVENTION DEVICE.
 CONTRACTOR SHALL SUPPLY AND INSTALL 3/8"
 BRAIDED STAINLESS STEEL SUPPLY FROM SHUT-OFF
 TO MACHINE.

- 7. HAND SINK/LAVATORY:
 ROUTE 1/2" HOT AND COLD WATER DOWN IN WALL
 AND CONNECT TO HAND SINK/LAVATORY,
 CONTRACTOR TO PROVIDE AND INSTALL
 THERMOSTATIC MIXING VALVE BELOW FIXTURE AND
 SET TO 110°F. MIXING VALVE SHALL BE ASSE 1070
 COMPLIANT. REPLACE AERATOR PROVIDED WITH
 FAUCET WITH 0.5 GPM VANDAL RESISTANT FLOW
 CONTROL AERATOR. CAULK AND SEAL BACK OF SINK
 TO WALL.
- 8. COFFEE BREWER:
 ROUTE 1/2" FILTERED COLD WATER DOWN IN WALL.
 CONTRACTOR SHALL PROVIDE AND INSTALL SHUTOFF VALVE IN CABINET AT 24" A.F.F. CONTRACTOR
 SHALL SUPPLY AND INSTALL 3/8" BRAIDED STAINLESS
 STEEL SUPPLY LINE FROM SHUT-OFF VALVE TO
 MACHINE.
- 9. ESPRESSO MACHINE:
 ROUTE 1/2" FILTERED COLD WATER IN CASEWORK
 AND CONNECT TO ESPRESSO MACHINE. PROVIDE
 AND INSTALL BRAIDED STAINLESS STEEL HOSE
 FROM SHUT-OFF VALVE TO PUMP AND FROM PUMP
 TO ESPRESSO MACHINE'S WATER INLET.
- 10. DIPPER WELL, HOT TAP, WATER TOWER, AND PITCHER RINSER:
 ROUTE 1/2" COLD, AND FILTERED COLD WATER IN CASEWORK. EXTEND 1/2" FILTERED COLD WATER UP IN CASEWORK AND CONNECT TO DIPPER WELL. EXTEND 3/8" FILTERED WATER UP IN CASEWORK AND CONNECT TO HOT WATER DISPENSER, CONTRACTOR SHALL REDUCE WATER SUPPLY LINE TO 1/4" AT UNIT. EXTEND 3/8" FILTERED COLD WATER UP IN CASEWORK AND CONNECT TO WATER TOWER FAUCET. EXTEND 1/2" AND COLD WATER UP IN CASEWORK AND CONNECT TO PITCHER RINSER FAUCET (2 HANDLE). REFER TO ESP SINK PIPING
- 11. WATER CLOSET:
 ROUTE 1" COLD WATER DOWN IN WALL AND
 CONNECT TO WATER CLOSET. PROVIDE WITH
 WATER HAMMER ARRESTOR IN SUPPLY LINE.
 CONTRACTOR SHALL CHOOSE RIGHT/LEFT HAND
 ORIENTATION TO BE ADA COMPLIANT PRIOR TO
 ORDERING.

DETAIL.

- 12. ROUTE 3/4" COLD, AND FILTERED COLD WATER UP FROM BELOW GRADE THRU SLAB, PROVIDE WITH BALL SHUT-OFF VALVE AT FLOOR PENETRATION. PIPING SHALL BE ROUTED CONCEALED BELOW COUNTER AND TIGHT TO BAR WALL (COORDINATE WITH G.C.).
- 13. WORK SINK:
 ROUTE 1/2" HOT AND COLD WATER DOWN IN WALL
 AND CONNECT TO WORK SINK.
- 14. PITCHER RINSER FAUCET:
 ROUTE 1/2" HOT AND COLD WATER UP IN WALL.
 CONNECT 1/2" CW TO PITCHER RINSER FAUCET (1
 HANDLE). EXTEND IN CASEWORK AND 1/2" HW AND
 CW CONNECT TO SINK FAUCET. CONTRACTOR SHALL
 PROVIDE AND INSTALL AN APPROVED BACKFLOW
 PREVENTER
- 15. ROUTE 3/4" COLD, AND FILTERED COLD WATER DOWN IN WALL AND EXTEND BELOW SLAB TO BAR AREA.
- 16. LAVATORY:
 ROUTE 1/2" HOT AND COLD WATER DOWN IN WALL
 AND CONNECT TO HAND SINK/LAVATORY,
 CONTRACTOR TO PROVIDE AND INSTALL
 THERMOSTATIC MIXING VALVE BELOW FIXTURE AND
 SET TO 100°F. MIXING VALVE SHALL BE ASSE 1070
 COMPLIANT. REPLACE AERATOR PROVIDED WITH
 FAUCET WITH 0.5 GPM VANDAL RESISTANT FLOW
 CONTROL AERATOR. CAULK AND SEAL BACK OF SINK
 TO WALL
- 17. ROUTE 1-1/2" COLD WATER LINE UP IN CEILING SPACE.18. REPLACE AFRATOR PROVIDED WITH FALICET WITH
- 18. REPLACE AERATOR PROVIDED WITH FAUCET WITH 0.5 GPM VANDAL RESISTANT FLOW CONTROL AERATOR.
- 19. MAGIC SINK:
 ROUTE 1/2" COLD, HOT, AND FILTERED COLD WATER
 IN WALL. EXTEND 1/2" FILTERED COLD WATER IN
 CASEWORK AND CONNECT TO HOT WATER
 DISPENSER, CONTRACTOR SHALL REDUCE WATER
 SUPPLY LINE TO 1/4" AT UNIT. EXTEND 1/2" FILTERED
 COLD WATER IN CASEWORK AND CONNECT TO
 WATER TOWER FAUCET. ROUTE 1/2" COLD AND HOT
 WATER IN CASEWORK AND CONNECT TO
 LABORATORY FAUCET. REFER TO DETAIL 6/502 FOR
 MORE INFORMATION.

20. PIPING SHALL BE BELOW FLOOR.

- 21. ROUTE 1/2" HW, CW AND FCW DOWN IN WALL AND CONNECT TOWATER FILLING STATION. CONTRACTOR SHALL PROVIDED AND INSTALL APPROVED BACKFLOW PREVENTER.
- 22. HOSE BIB. FIELD VERIFY EXACT LOCATION.
- 23. ROUTE 1/2" HWR FROM CEILING SPACE AND CONNECT TO WATER HEATER. SEE DETAIL ON P502 FOR MORE INFORMATION.

GENERAL NOTES

- A. FURNISH AND INSTALL A COMPLETE AND OPERATING SYSTEM. ALL ITEMS ARE NOT NECESSARILY SHOWN.
- B. PLUMBING CONTRACTOR RESPONSIBLE FOR SITE INVESTIGATION PRIOR TO START OF WORK TO REVEAL FULL SCOPE OF WORK.
- C. ALL PLUMBING LINES TO BE ROUTED SUCH THAT THEY ARE NOT VISIBLE TO CUSTOMERS EXCEPT WHERE FIRST APPROVED BY STARBUCKS AT EXPOSED CEILING AREAS.
- D. REFER TO MANUFACTURER SPECIFICATIONS FOR LOCATION OF CONNECTIONS UNLESS OTHERWISE NOTED.
- E. DIMENSIONS ARE TO FINISH FACE UNLESS OTHERWISE NOTED.
- F. REFER TO DETAIL SHEETS FOR PLUMBING FITTINGS LOCATED IN CASEWORK.
- G. COLD WATER SUPPLY LINES INSIDE CASEWORK AND BAR AREA TO BE COVERED WITH 1/2" (10MM) THICK SELF SEALING, SECTIONAL CLOSED-CELL FOAM INSULATION. REFER TO SPECIFICATIONS FOR HOT WATER SUPPLY LINE INSULATION REQUIREMENTS.
- H. INSULATE ALL PIPING INCLUDING PIPES AT BAR AND IN CASEWORK PER THE REQUIREMENTS LISTED IN THE PROJECT MANUAL.
- I. GENERAL CONTRACTOR SHALL CONTACT WATER FILTRATION SUPPLIER TO COORDINATE SOW AND SCHEDULE PRIOR TO INSTALLATION OF WATER FILTRATION SYSTEM.

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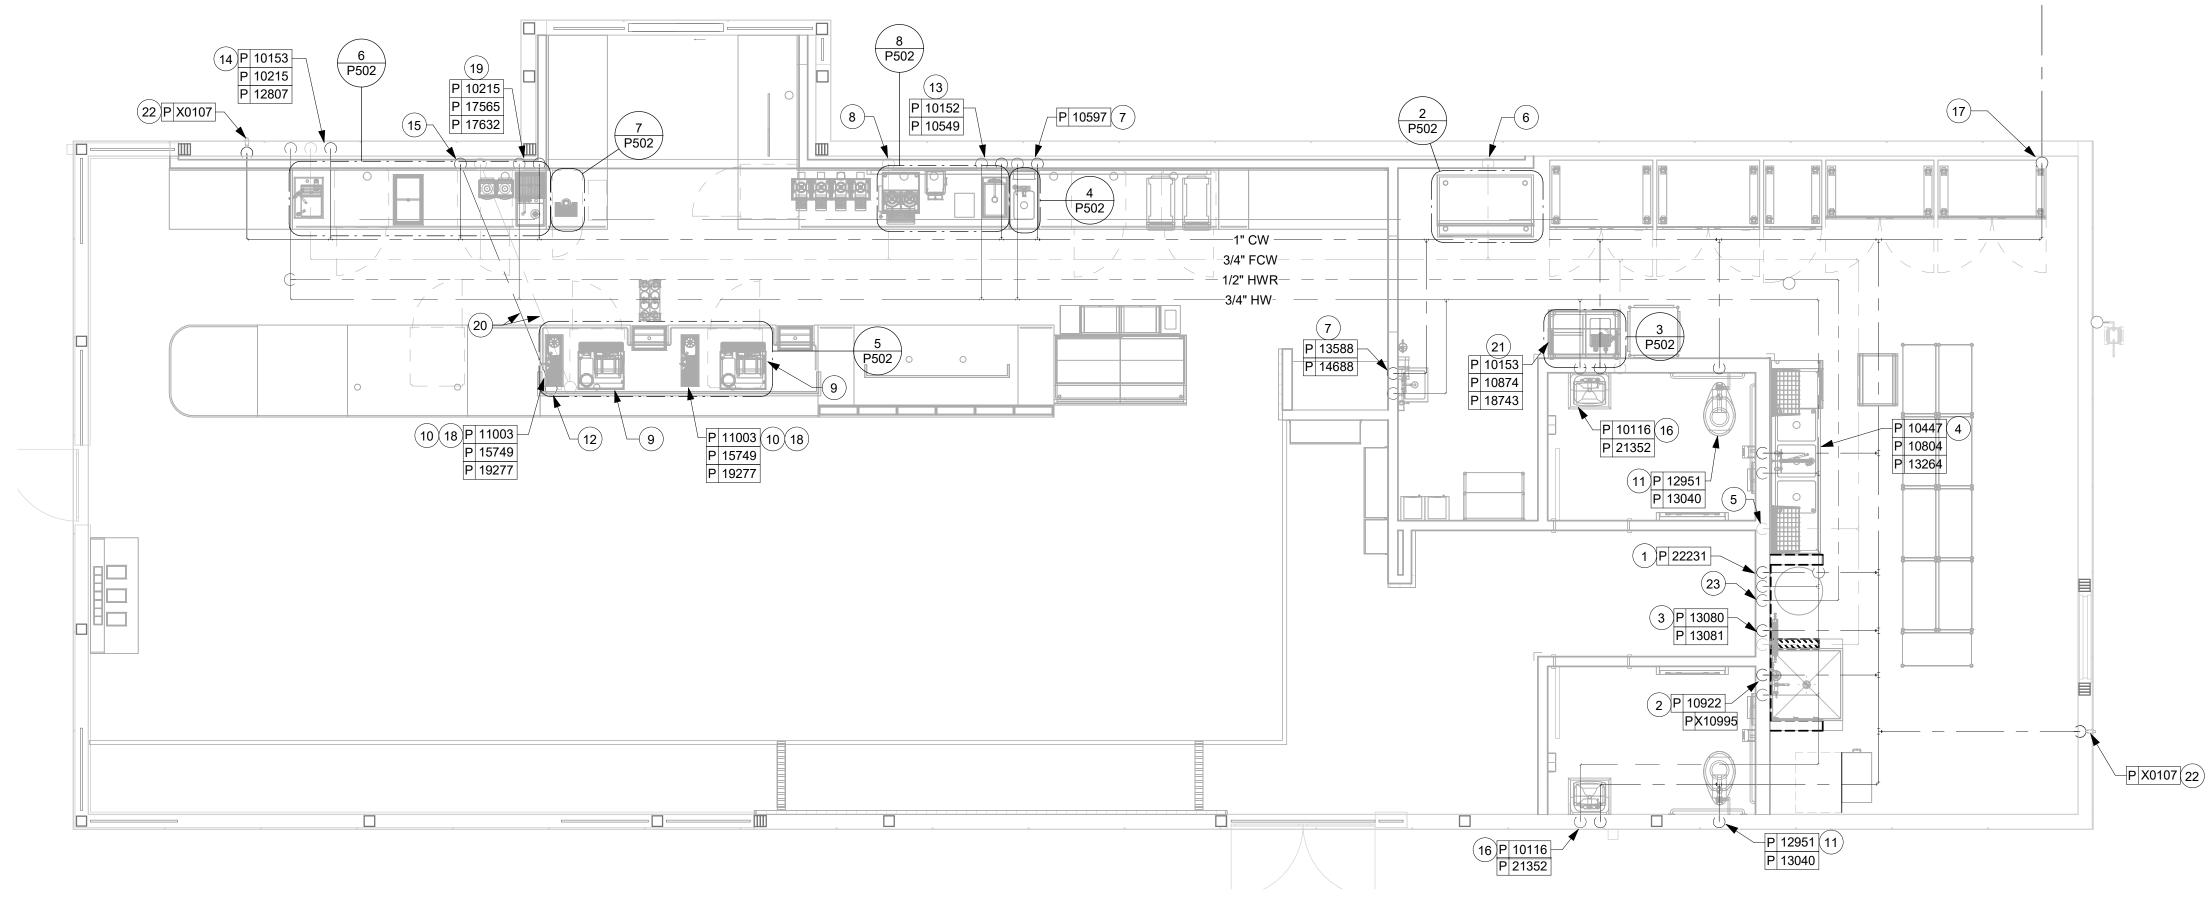
DESIGN MANAGER: ASHLEY SUEIRAS
PRODUCTION DESIGNER: GPD GROUP
CHECKED BY: GPD GROUP

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Rev Date By Description

SHEET TITLE:
PLUMBING SUPPLY
PLAN

SCALE: AS SHOWN
SHEET NUMBER:



 ESPRESSO SINK: ROUTE 1-1/2" INDIRECT WASTE PIPING IN CASEWORK TO NEW FLOOR SINK, FIELD VERIFY EXACT LOCATION.

3. ICE BIN:
ROUTE 1-1/2" INDIRECT WASTE PIPING FROM ICE BIN IN
CASEWORK TO FLOOR SINK, FIELD VERIFY EXACT
LOCATION.

4. HAND SINK:
ROUTE 2" GREASE WASTE PIPING BELOW AND EXTEND
UP IN WALL, TRANSITION TO 1-1/2" GREASE WASTE
PIPING AND CONNECT TO SINK. EXTEND 1-1/2" VENT
PIPING UP IN WALL TO CEILING SPACE.

5. WORK SINK:
ROUTE 1-1/2" INDIRECT WASTE PIPING IN CASEWORK TO
NEW FLOOR SINK. FIELD VERIFY EXACT LOCATION WITH
APPROVED AIR GAP.

6. CONTRACTOR SHALL ROUTE 4" VENT THRU ROOF. ROOF PENETRATION SHALL BE MADE BY LANDLORD'S ROOFING CONTRACTOR. LANDLORD'S ROOFING CONTRACTOR SHALL MAKE ROOF PENETRATION WEATHER TIGHT. VENT THRU ROOF SHALL BE A MINIMUM OF 12'-0" FROM ANY OUTDOOR AIR INTAKES.

7. ROUTE 1" INDIRECT WASTE PIPING FROM CBS DRAIN BOARD TO FLOOR SINK. FIELD VERIFY EXACT LOCATION.

8. ROUTE 1-1/2" INDIRECT WASTE PIPING FROM PITCHER RINSER SINK TO FLOOR SINK. FIELD VERIFY EXACT LOCATION.

9. ROUTE INSULATED INDIRECT DRAIN PIPING BEHIND UNDERCOUNTER REFRIGERATOR, TIGHT TO WALL. CONTRACTOR SHALL PROVIDE AND INSTALL BUMPER GUARDS AS REQUIRED.

10. ROUTE WASTE PIPING FROM ESPRESSO MACHINE DRAIN TRAY TO FLOOR SINK. COORDINATE EXACT REQUIREMENTS WITH EQUIPMENT MANUFACTURE'S RECOMMENDATIONS.

11. WATER HEATER:
ROUTE 3/4" PRESSURE RELIEF TO MOP SINK. ROUTE 1"
INDIRECT DRAIN FROM WATER HEATER DRAIN PAN TO
MOP SINK. ROUTE CONDENSATE DRAIN FROM WATER
HEATER TO MOP SINK.

12. MOP SINK:
ROUTE 3" GREASE WASTE UP AND CONNECT TP MOP
SINK, EXTEND 2" VENT UP IN WALL TO CEILING SPACE.

13. WATER CLOSET:
ROUTE 4" SANITARY WASTE UP AND CONNECT TO
WATER CLOSET, EXTEND 2" VENT UP IN WALL TO
CEILING SPACE.

14. LAVATORY:
ROUTE 2" SANITARY WASTE PIPING BELOW SLAB AND
EXTEND UP IN WALL, TRANSITION TO 1-1/2" SANITARY
WASTE PIPING AND CONNECT TO LAVATORY. EXTEND 11/2" VENT PIPING UP IN WALL TO CEILING SPACE.
CONTRACTOR SHALL PROVIDE AND INSTALL PIPE
PROTECTOR FOR P-TRAP AND SUPPLIER, TRUEBRO
LAVGUARD 2 OR EQUAL.

15. 3-COMPARTMENT SINK: SINK SHALL DISCHARGE TO GREASE INTERCEPTOR. ROUTE WASTE PIPING FROM SINK TO FLOOR SINK THROUGH MINIMUM 2" AIR GAP.

16. SANITIZER:

ROUTE 1-1/2" INDIRECT DRAIN TO CLOSET FLOOR SINK.

17. ICE MACHINE:
ROUTE (2) 3/4" INSULATED INDIRECT DRAINS TO FLOOR
SINK. DO NOT INTERCONNECT DRAINS.

18. FLOOR SINK:
ROUTE 3" GREASE WASTE UP AND CONNECT TO FLOOR
SINK, EXTEND 1-1/2" VENT UP IN WALL TO CEILING
SPACE.

19. FLOOR CLEANOUT: CLEANOUT SHALL BE INSTALLED FLUSH WITH FINISHED FLOOR.

20. NOT USED.

21. ROUTE 1" INDIRECT DRAIN FROM NITRO DRIP TRAY TO FLOOR SINK WITH APPROVED AIR GAP.

22. CONNECT TO EXISTING 4" GREASE WASTE/SANITARY WASTE PIPING BELOW GRADE. FIELD VERIFY EXACT LOCATION, SIZE, DEPTH OF INVERT, AND DIRECTION OF FLOW PRIOR TO START OF ANY WORK.

23. FLOOR SINK:
ROUTE 4" GREASE WASTE UP AND CONNECT TO FLOOR SINK.

24. FLOOR DRAIN: ROUTE 3" SANITARY WASTE UP IN WALL AND C

ROUTE 3" SANITARY WASTE UP IN WALL AND CONNECT TO FLOOR DRAIN, EXTEND 1-1/2" VENT UP IN WALL TO CEILING SPACE.

25. MAGIC SINK:
ROUTE 1-1/2" INDIRECT WASTE PIPING IN CASEWORK TO
NEW FLOOR SINK WITH APPROVED AIR GAP, FIELD
VERIFY EXACT LOCATION.

26. ROUTE INDIRECT DRAIN FROM WATER FILLING STATION TO FLOOR SINK WITH APPROVED AIR GAP.

GENERAL NOTES

A. SEE PLUMBING SPECIFICATIONS FOR FURTHER REQUIREMENTS.

B. ALL PLUMBING LINES TO BE ROUTED SUCH THAT THEY ARE NOT VISIBLE TO CUSTOMERS EXCEPT WHERE FIRST APPROVED BY STARBUCKS AT EXPOSED CEILING AREAS.

C. REFER TO MANUFACTURER SPECIFICATIONS FOR LOCATION OF CONNECTIONS UNLESS OTHERWISE NOTED.

 D. COORDINATE WITH ELECTRICAL CONTRACTOR FOR POWER CONNECTION TO ALL PLUMBING EQUIPMENT.

E. DIMENSIONS ARE TO FINISH FACE UNLESS OTHERWISE NOTED.

F. REFER TO DETAIL SHEETS FOR PLUMBING FITTINGS LOCATED IN CASEWORK.

G. WHEN BUILDING SEVERAL INDIRECT WASTE LINES TO DRAIN INTO A FLOOR SINK, A UNISTRUT IS REQUIRED FOR SECURING AND BRACING ALL LINES ABOVE THE DRAIN

H. FURNISH & INSTALL ALL NEEDED INDIRECT DRAINS PER CODE (NOT ALL SHOWN). INSTALL DRAINS AT 2% SLOPE WHERE POSSIBLE WITHOUT DIPS OR SAGS. ALL INDIRECT DRAINS SHALL RUN SEPARATELY FROM EACH OTHER TO INDIRECT DRAIN RECEPTOR AND SHALL TERMINATE WITH AN AIR GAP PER CODE.

I. FURNISH & INSTALL WALL CLEANOUTS AT ALL SINKS, AS NEEDED, AND PER CODE (NOT ALL SHOWN).

J. INSULATE ICE BIN DRAINAGE PIPES PER THE REQUIREMENTS ON THE PLUMBING SPECIFICATION SHEET.

K. STACK TEST ON DRAINS AND VENTS SHALL BE PROVIDED AT TIME OF UNDERGROUND AND ROUGH IN INSPECTIONS.

L. ANY PVC DRAIN AND VENT PIPING SHALL BE SCHEDULE 40 PVC ASTM 2665. NO CELLULAR CORE PVC OR ABS PIPE ALLOWED.

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STARBUCKS TEMPLATE VERSION: i2021-01-22



520 SOUTH MAIN ST, SUITE 2531 AKRON, OH 44311 P: 330-572-2100 F: 330-572-2101 GPD PROJECT NO: 20

SEAL 41099

E. & BRINKLEY HIL

PROJECT ADDRESS:

2778 NC-24

59763

85334-001

STORE #:
PROJECT #:
ISSUE DATE:
DESIGN MANAGER:

ISSUE DATE:

DESIGN MANAGER:

PRODUCTION DESIGNER:

CHECKED BY:


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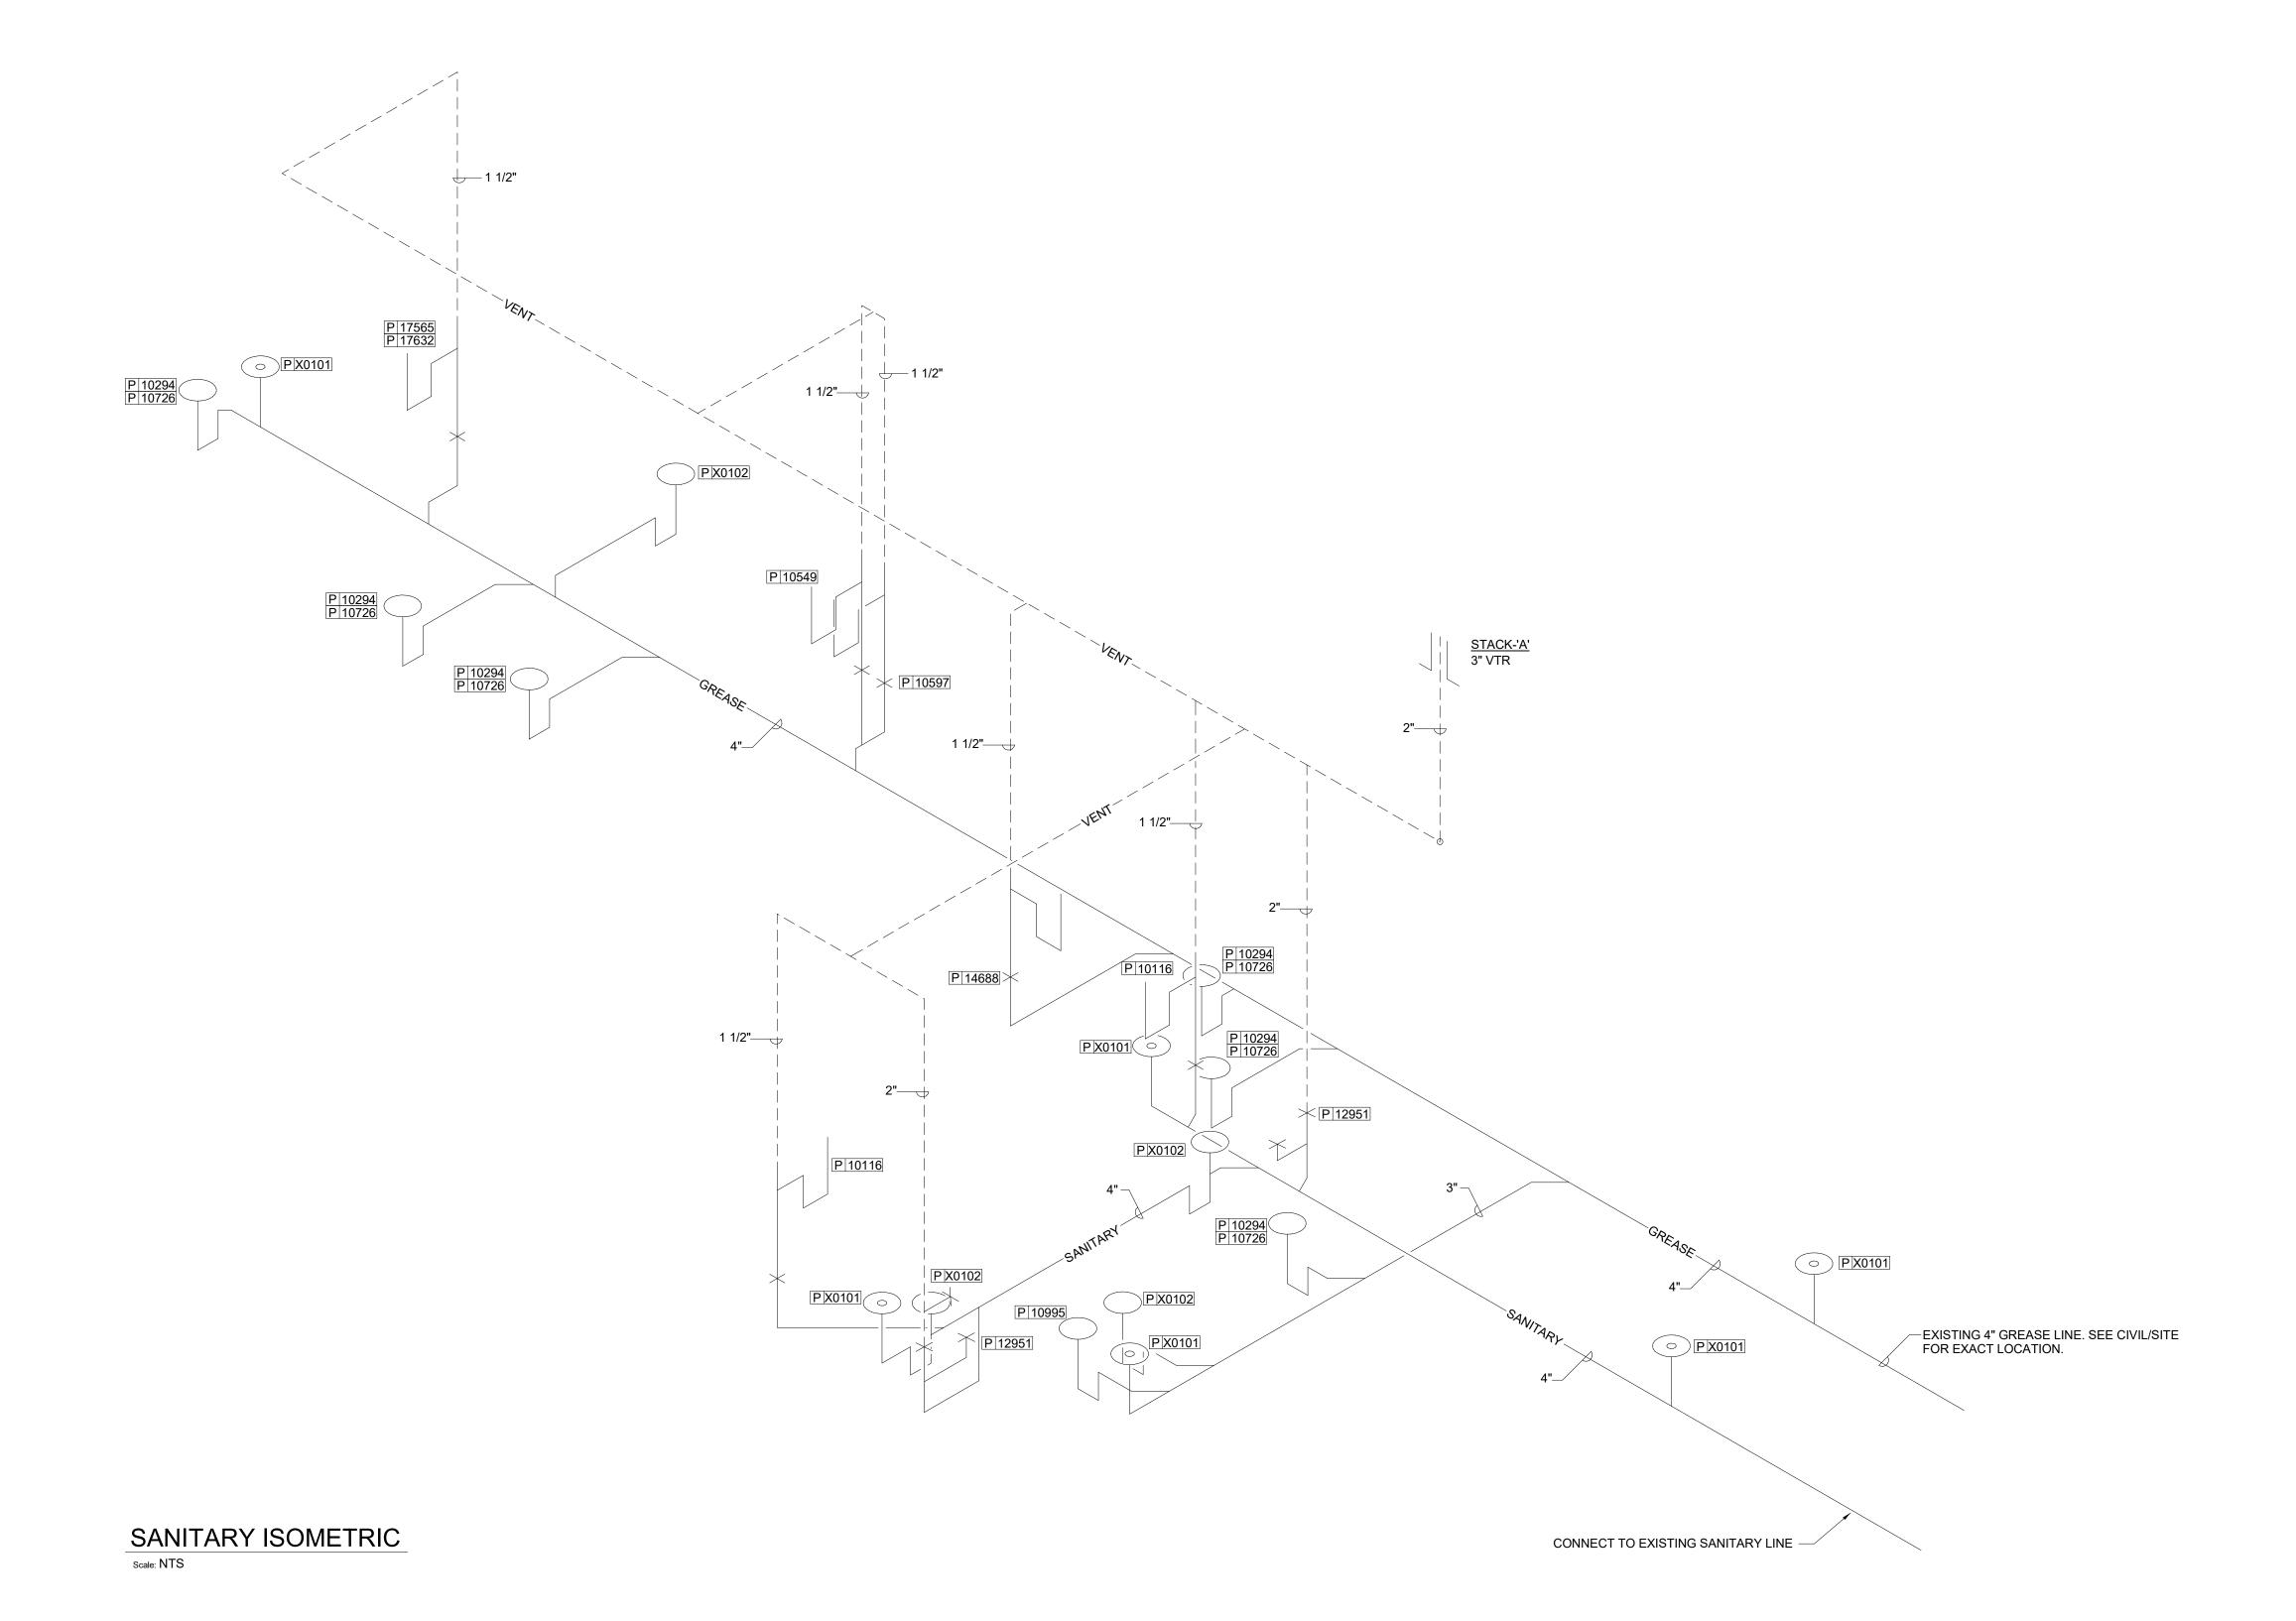
Revision Schedule

Rev Date By Description

PLUMBING WASTE & VENT PLAN
SCALE: AS SHOWN

SHEET NUMBER:



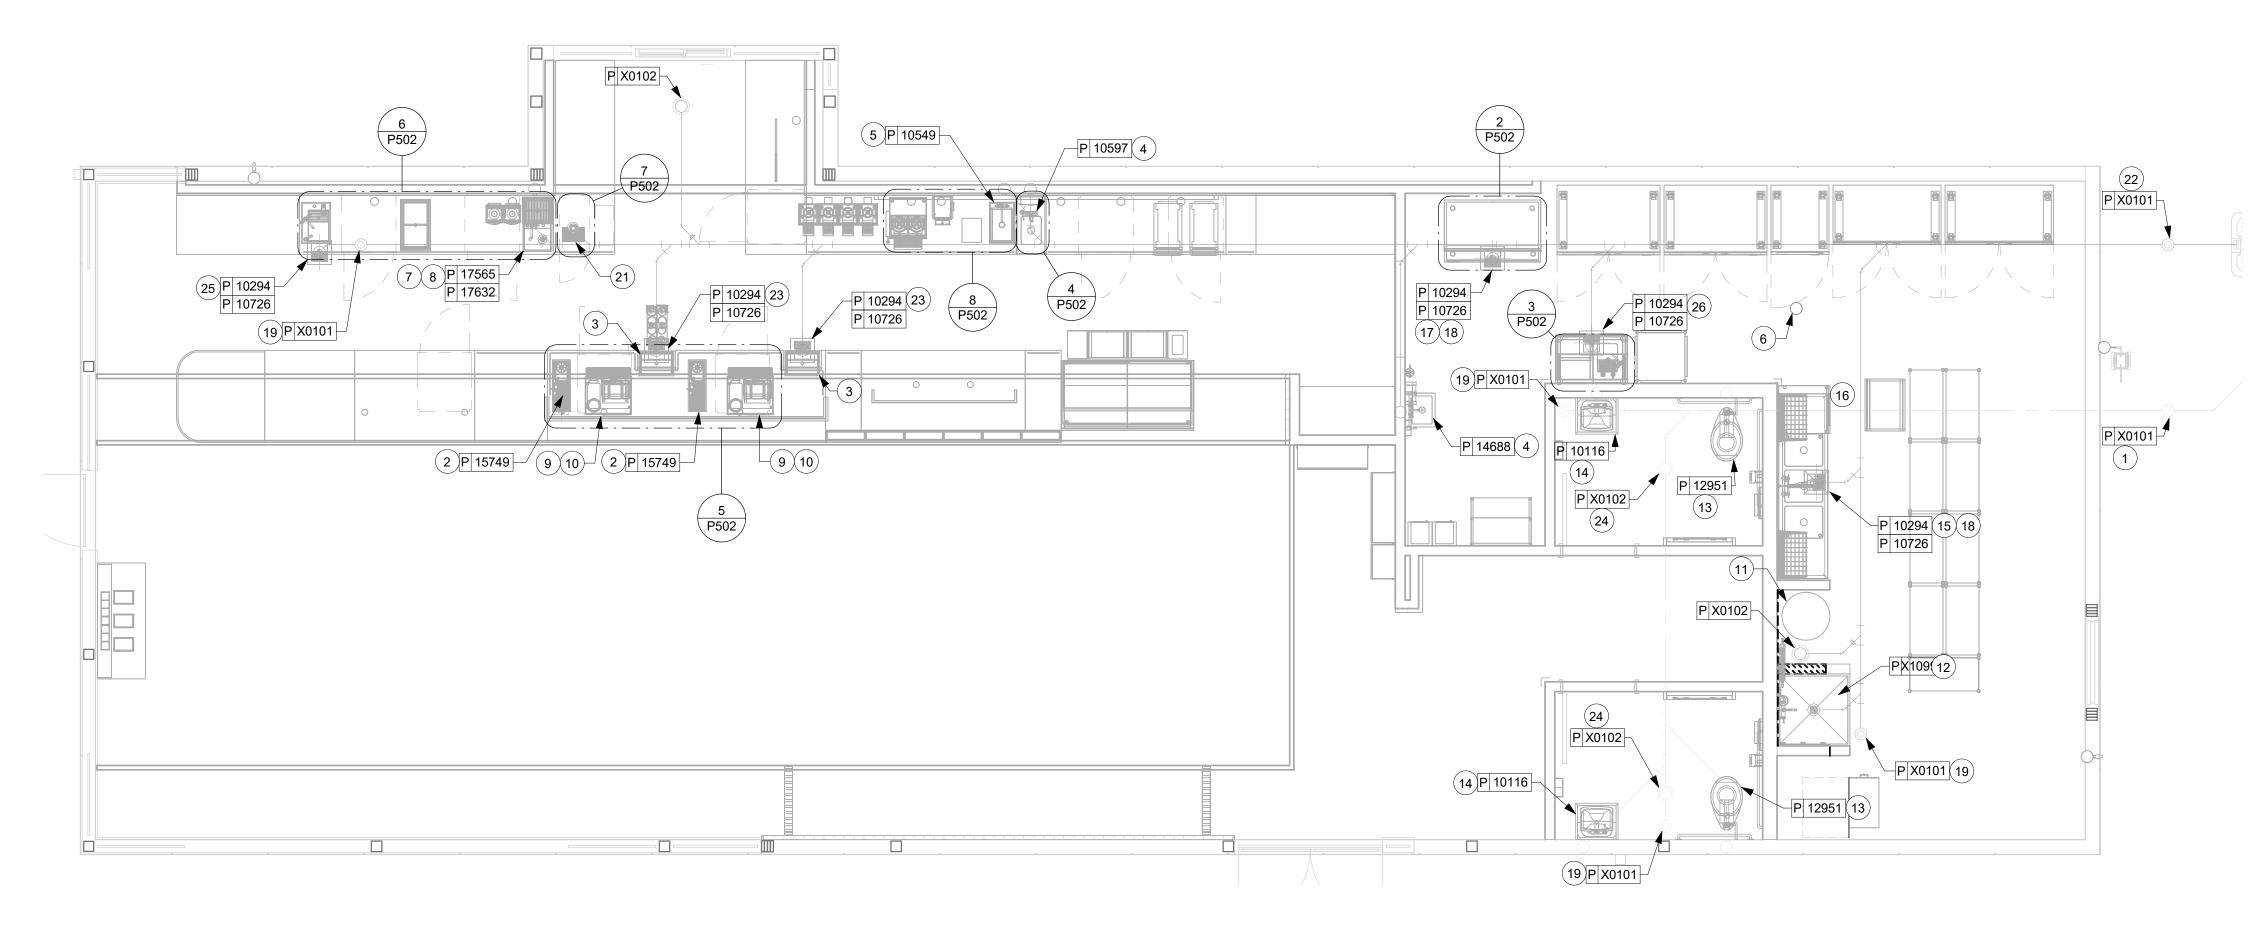



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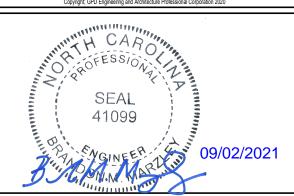
BOTH PARTIES.



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P: 330-572-2100 F: 330-572-210

GPD PROJECT NO:
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A & BRINKLEY HILL

PROJECT ADDRESS:

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85334-001

For Construction

STORE #: PROJECT #: ISSUE DATE:

DESIGN MANAGER: ASHLEY SUEIRAS PRODUCTION DESIGNER: GPD GROUP CHECKED BY: GPD GROUP

Revision Schedule

Rev	Date	Ву	Description


SHEET TITLE:


PLUMBING WASTE & SANITARY ISOMETRIC SCALE: AS SHOWN

SHEET NUMBER:





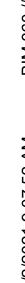

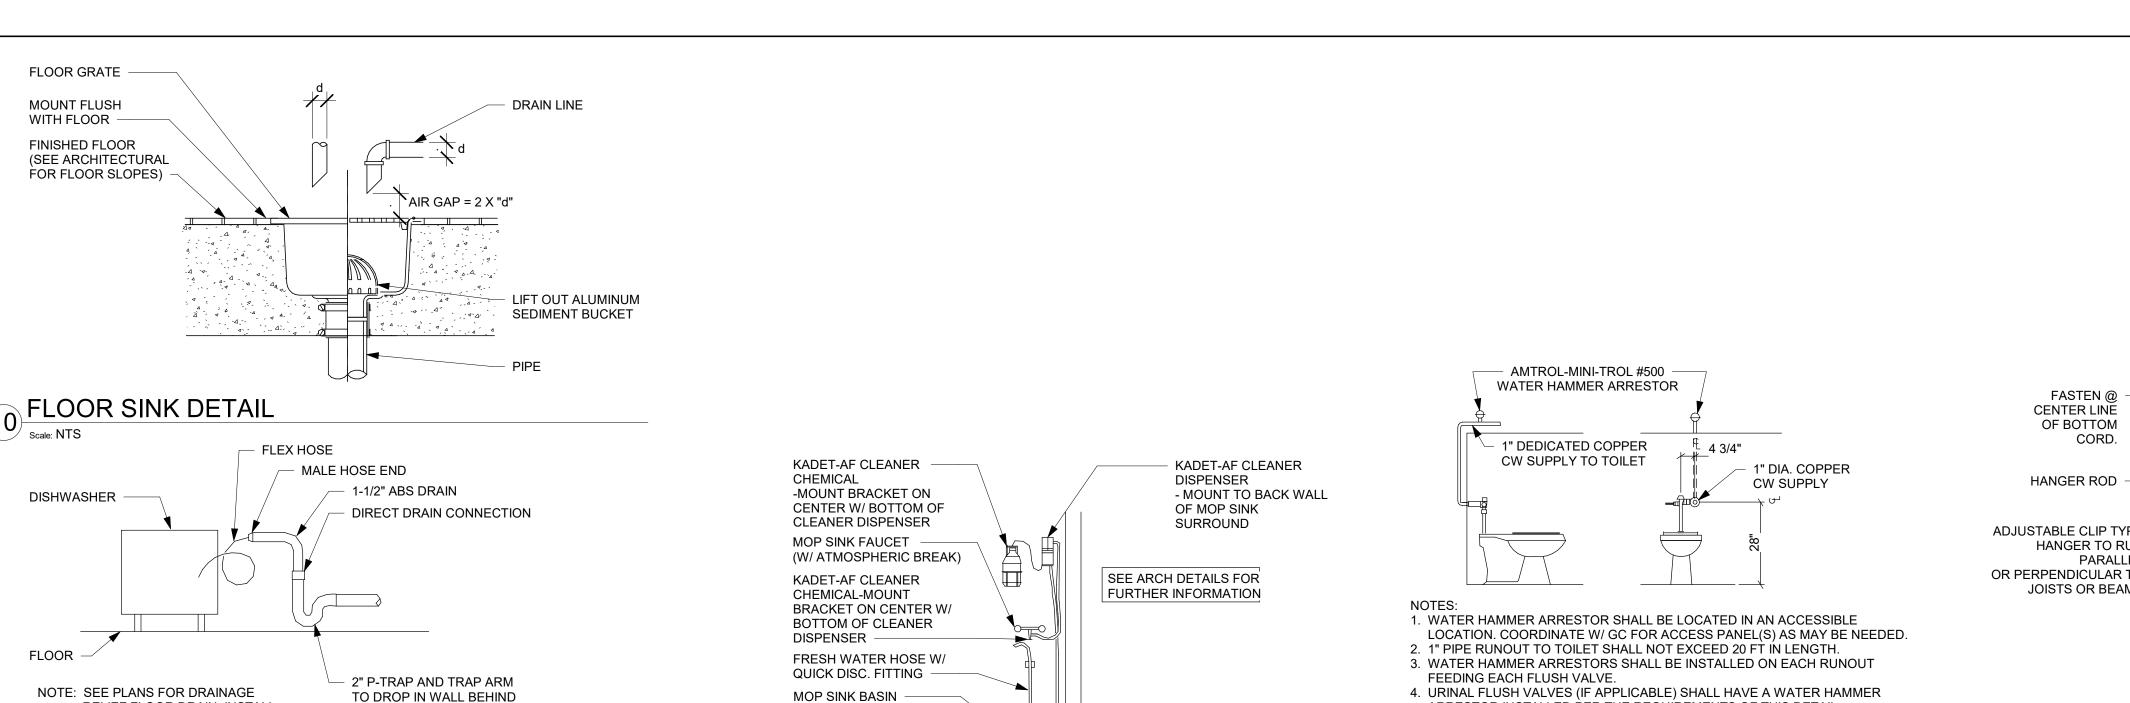

DISHWASHER DRAIN DETAIL


RELIEF FLOOR DRAIN. INSTALL

ALL PER CODE & AHJ.

MOP SINK BASIN CHEMICAL MIXER DETAIL

TOILET SUPPLY DETAIL

- 4. URINAL FLUSH VALVES (IF APPLICABLE) SHALL HAVE A WATER HAMMER ARRESTOR INSTALLED PER THE REQUIREMENTS OF THIS DETAIL. 5. MODIFY THIS DETAIL AS NEEDED IF WALL MOUNTED TOILETS ARE INSTALLED.

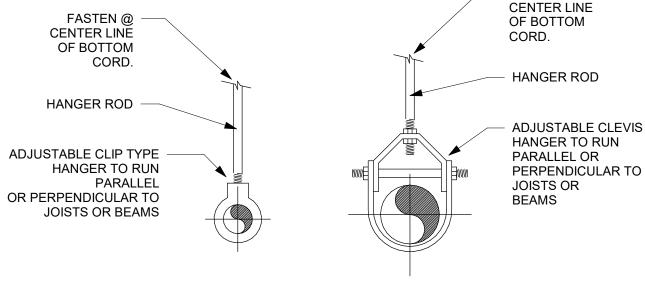

BRANCH LINE

MAIN LINE

FASTEN @

9 PIPE HANGER DETAIL

BRAIDED STAINLESS STEEL HOSE. -9/16-24 UNEF COMPRESSION 5/8" WIRE REINFORCED DRAIN CONNECTION 150 PSIG MIN. HOSE TO INDIRECT PIPE RISER RATING. (TYP. 2) **ESPRESSO ESPRESSO** MACHINE MACHINE 2" ABS DWV INDIRECT WASTE COUNTER TOP PIPE TO FLOOR SINK SLOPE HORIZONTAL AT 1/4" PER FOOT WATER PUMP. INSTALL TO ALLOW ACCESS TO HOLD PIPING TIGHT TO BACK INTEGRAL PUMP FILTER. SEE PUMP ATTACHMENT WALL (TYP.) DETAIL IN ARCH PLANS (TYP.2) BRAIDED STAINLESS STEEL HOSE BACK FLOW PREVENTION DEVICE 9/16-24 UNEF COMPRESSION PUMP CONNECTION 150PSIG MIN. LOCATION WITH LOCAL JURISDICTION. **HUB DRAIN** RATING. (TYP.2) 1/2" NPT TO HOSE COMPRESSION CONNECTION — 1/2"HW— 3/4" 1/2" BALL VALVE (TYP. 2) -----1/2"CW-----AIR GAP PER CODE.


MINIMUM 1"

FLOOR

_SINK__

DETAIL NOTES

- 1. THIS DETAIL IS SCHEMATIC ONLY. SEE THE PLAN
- DRAWINGS. 2. ALL WATER HOSES SHALL BE THE MINIMUM LENGTH NEEDED AND SUPPORTED AS NEEDED TO AVOID STRESSING CONNECTIONS AND COILING EXCESSIVE HOSE. ROUTE TO AVOID KINKING AND ALLOW SPACE FOR UNDER COUNTER REFRIGERATOR AND ACCESS TO EQUIPMENT AND
- 3. ALL PIPING SHALL BE HELD TIGHT TO WALLS, SLOPED WHERE NEEDED AND ROUTED TO ALLOW ACCESS TO EQUIPMENT AND VALVES.
- 4. ROUTE HORIZONTAL PIPING A MINIMUM OF 6" ABOVE WHERE REQUIRED. VERIFY TYPE AND 5. COORDINATE LOCATION AND ELEVATION OF ALL EQUIPMENT WITH OTHER TRADES. ORIENT PUMP AS NEEDED TO ALLOW MAINTENANCE.

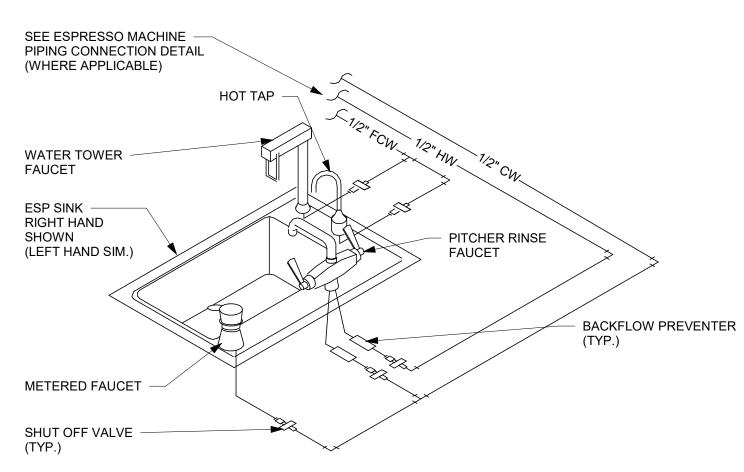

ESP SINK PIPING DETAIL


PIPE HANGER SUPPORT (OR PIPE CLAMP SUPPORT AS NEEDED.) ABS INDIRECT DRAIN PIPE (SEE PLAN FOR SIZES) SINK/ICE BIN F&I ADDITIONAL OFFSETS AS MAY BE NEEDED. PIPE CLAMP SUPPORT AT ABS THREADED COUPLING DRAIN TERMINATION TO BASKET STRAINER -(& BLOCKING - NOT SHOWN) CLEANOUTS AT ALL CHANGES IN DIRECTION (OR AS ALLOWED DISCHARGE INTO OPEN AREA BY AHJ) OF FLOOR SINK W/ 2" AIR GAP ABS DWV FITTINGS (TYP.) FINISHED FLOOR FLOOR SINK

ESPRESSO MACHINE PIPING CONNECTION DETAIL

FLOOR


- 1. F&I ALL WORK PER CODE AND AHJ REQUIREMENT EVEN IF NOT SPECIFICALLY SHOWN. 2. ALL PIPES SHALL BE RIGIDLY SUPPORTED AND ALL SUPPORTS & PIPING SHALL BE MOUNTED
- OFF THE FLOOR FOR CLEANING PURPOSES. 3. ALL INDIRECT DRAIN DISCHARGES SHALL OCCUR OVER CLEAR AREA OF FLOOR SINK AND NOT OVER GATE.
- 4. SLOPE ALL PIPES PER CODE AND F&I TRAPPED INDIRECT DRAIN AND VENT IF REQUIRED BY CODE AND/OR AHJ. (NOT SHOWN)


SINK INDIRECT DRAIN DETAIL

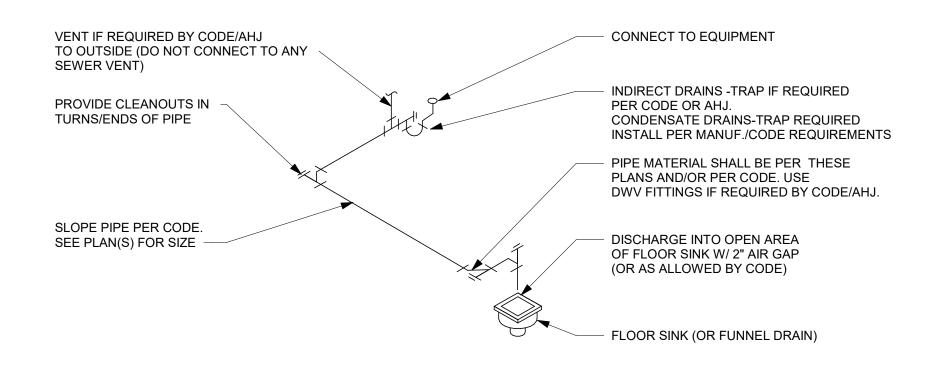

D BALL VALVE @ STUB UP (TYP.)

- 1. F&I ALL WORK PER CODE AND AHJ REQUIREMENT EVEN IF NOT SPECIFICALLY SHOWN. 2. ALL PIPES SHALL BE RIGIDLY SUPPORTED AND ALL SUPPORTS & PIPING SHALL BE MOUNTED
- OFF THE FLOOR FOR CLEANING PURPOSES. 3. ALL FLEXIBLE INDIRECT DRAIN LINES FOR APPLIANCES SHALL BE INSTALLED PER CODE/AHJ
- AND MANUF. REQUIREMENTS. SUPPORT LINES SO THERE ARE NO SAGS OR DIPS IN LINE.

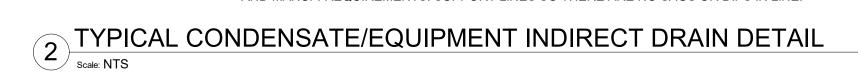

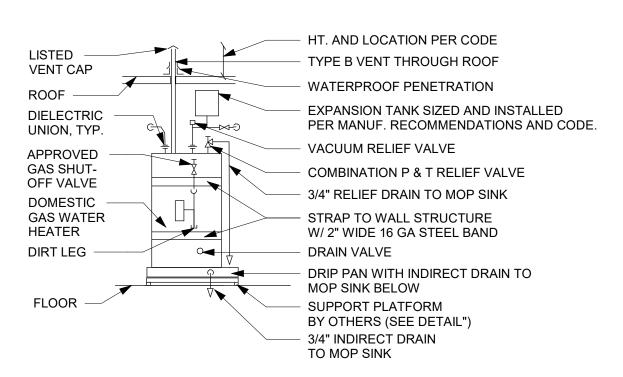

GAS WATER HEATER DETAIL



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GPD PROJECT NO: SEAL

PROJECT 2778 CAME

STORE #: 59763 85334-001 PROJECT #: ISSUE DATE: For Construction **DESIGN MANAGER:** ASHLEY SUEIRAS

PRODUCTION DESIGNER: GPD GROUP

Revision Schedule

GPD GROUP

Rev	Date	Ву	Description


PLUMBING DETAILS


SCALE: AS SHOWN

CHECKED BY:

SHEET NUMBER:



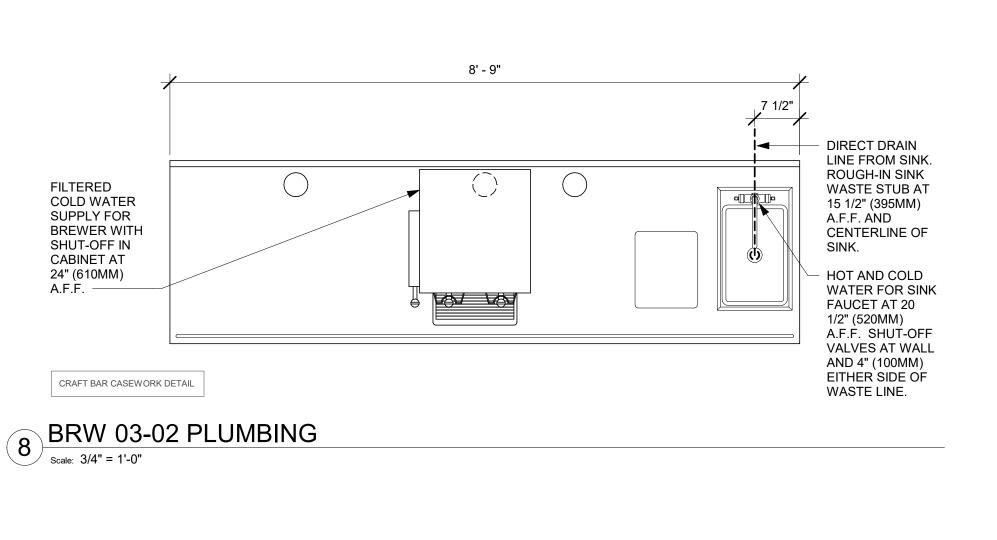

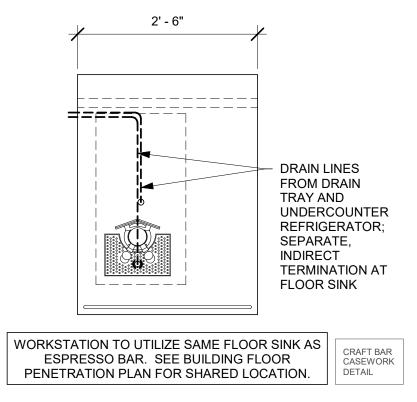

NIT 13-01 PLUMBING

INDIRECT LINE FROM

DRAINBOARD TO FLOOR

HOT AND NON-FILTERED COLD

WATER FOR SINK FAUCET AT

EITHER SIDE OF WASTE LINE

FOR BLENDER PITCHER RINSER

INDIRECT DRAIN LINE FROM ICE

FLOOR SINK


BIN TO FLOOR SINK

20 1/2" (20MM) A.F.F. SHUT-OFF


VALVES AT WALL AND 4" (100MM)


NON-FILTERED COLD WATER SUPPLY


INDIRECT DRAIN LINE FROM SINK TO

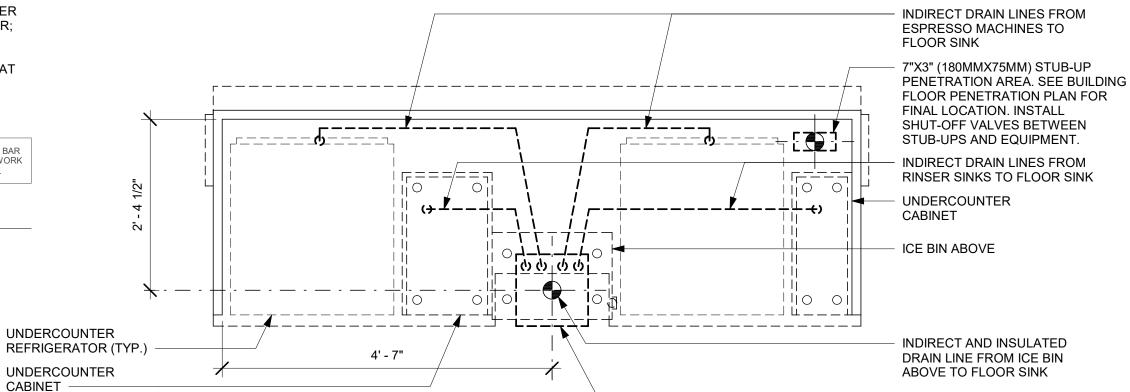


UNDER COUNTER

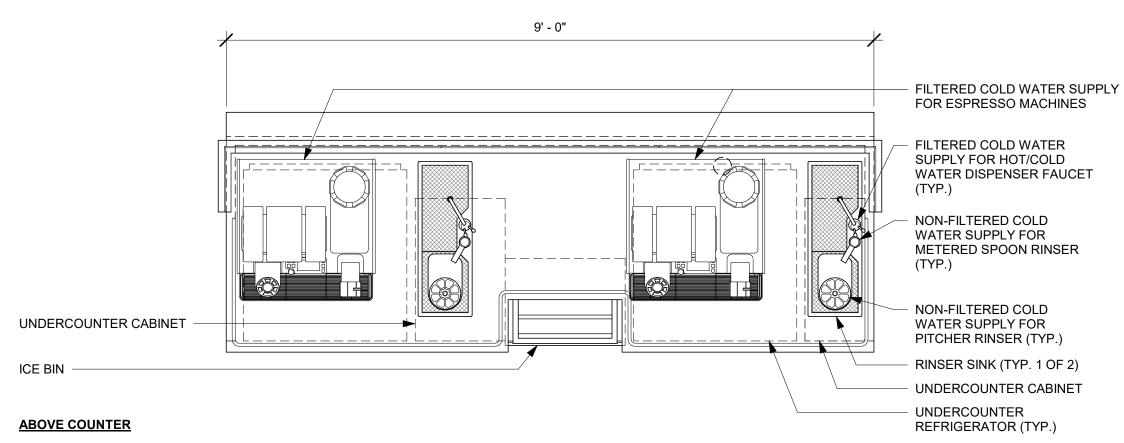

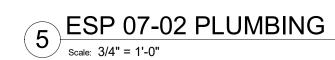

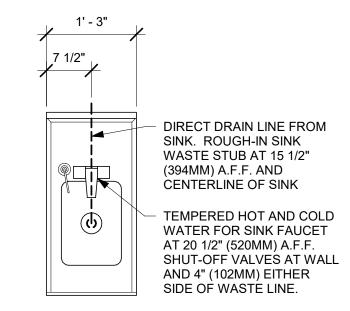

ADD 02-01 PLUMBING

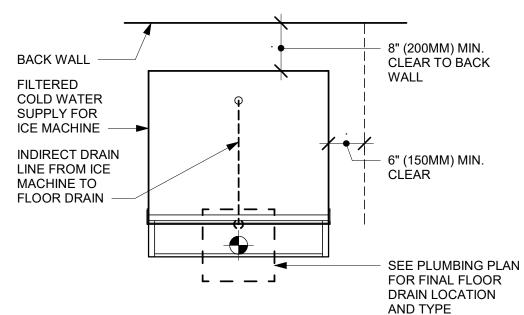

ICE MACHINE - PLUMBING

AT FLOOR LEVEL FILTERED **COLD WATER** SUPPLY FOR WATER TOWER **FAUCET** FILTERED **COLD WATER** SUPPLY FOR **INSTANT HOT** WATER TAP NON-FILTERED HOT AND COLD WATER SUPPLY FOR SINK **FAUCET** SHELVING **ABOVE COUNTERTOP** ABOVE

SEE PLUMBING PLAN FOR

FINAL FLOOR SINK

LOCATION AND TYPE

WATER FILLING STATION - PLUMBING



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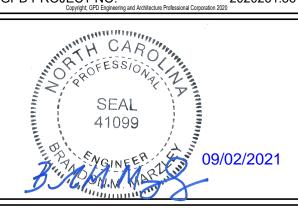
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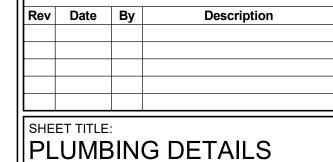


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PROJECT 2778 CAME STORE #: 59763 PROJECT #: 85334-001 ISSUE DATE: For Construction

DESIGN MANAGER: ASHLEY SUEIRAS PRODUCTION DESIGNER: GPD GROUP CHECKED BY: GPD GROUP

Revision Schedule



SCALE: AS SHOWN

SHEET NUMBER:

CONFIGURATION I, BASE WATER FILTRATION

| Scale: 1 1/2" = 1'-0"

FILTERED COLD WATER SUPPLY

FOR WATER TOWER FAUCET

HOT AND NON-FILTERED COLD

VALVES AT WALL AND 4" (100MM)

10"

(FLOOR SINK)

WATER FOR SINK FAUCET AT 20 1/2" (520MM) A.F.F. SHUT-OFF

EITHER SIDE OF WASTE LINE

NON-FILTERED COLD WATER

SUPPLY FOR RINSE FAUCET

INDIRECT DRAIN LINE FROM

SEE PLUMBING PLAN FOR FINAL FLOOR SINK LOCATION AND

SINK TO FLOOR SINK

NON-FILTERED COLD

WATER SUPPLY FOR METERED SPOON

CRAFT BAR CASEWORK DETAIL

CHROME

ESCUTCHEON

3/4" (20MM) BYPASS VALVE (NORMALLY CLOSED) 3' - 0" (915MM) ROUGH-IN 1' - 6" (460MM) ROUGH-IN 3/4" (20MM) BY-PASS LÍNE 3/4" (20MM) CWF OUT 72" (1830MM) A.F.F. FILTERED COLD WATER TO FILTERED FIXTURES (ESPRESSO MACHINES, BREWERS, HOT TAP, WATER TOWER 3/4" (20MM) FAUCET, CBE CHILLER, DOMESTIC WATER IN

10' - 7"

ICE MACHINE) 4-3/16" (105MM) FROM FACE OF WALL TO **CENTER OF PIPE** CONNECTION

FULL PORT FILTRATION SYSTEM THREADED, BRASS BALL SHUT-OFF

VALVE (TYP.) 3-3/8" (85MM) FROM WALL TO CENTER OF PIPE CONNECTION 62" (1575MM) A.F.F. UNION (TYP.).

1. ALL COMPONENTS DRAWN IN BOLD ARE GC RESPONSIBILITY. GC TO COORDINATE INSTALLATION OF ALL OTHER COMPONENTS SHOWN WITH FILTER VENDOR. 2. ALL PIPING SHALL BE COPPER EXCEPT PEX TYPE PIPING WHICH IS ACCEPTABLE BETWEEN FILTER SYSTEM COMPONENTS WHERE ALLOWED BY CODE.

3. COMPONENTS ARE TO BE POSITIONED TO MAXIMIZE ACCESS FOR REGULAR SERVICING. PRE-FILTER, BYPASS VALVES, AND SOFTENER TANKS MUST BE INSTALLED 72" (1828MM) A.F.F. OR LOWER.

INDIRECT LINE

FROM PREP

FLOOR SINK

SINK TO

PLUMBING FIXTURE SCHEDULE - "P"							
DESIGN ID	COUNT	DESCRIPTION	FURN. BY	INST. BY	COMMENTS		
10294	6	DRAIN - FLOOR SINK SQUARE - 12IN 305MM	SB	GC			
X0101	4	GRADE CLEANOUT	GC	GC	ZURN ZN1474, GRADE CLEANOUT, NICKEL BRONZE COVER.		
X0102	4	FLOOR DRAIN	GC	GC			
X0107	2	WALL HYDRANT	GC	GC	ZURN Z1321 WALL HYDRANT		
DRAIN			1				
10294	1	DRAIN - FLOOR SINK SQUARE - 12IN 305MM	SB	GC	ZURN FD2372-H, A.R.E. FLOOR SINK WITH 6" SUPM DEPTH AND 1/2 GRATE.		
10726	6	FLOOR SINK - GRATE HALF SQUARE - 12IN 305MM	SB	GC	ZURN FD2372-H, A.R.E. FLOOR SINK WITH 6" SUPM DEPTH AND 1/2 GRATE.		
FAUCET							
10152	1	FAUCET - DOUBLE LABORATORY WITH BENT RISER SPOUT	SB	GC			
10153	2	FAUCET - WATER TOWER - 12IN 305MM	SB	GC			
10215	3	FAUCET - DOUBLE LABORATORY WITH SWING SPOUT	SB	GC			
10447	1	FAUCET - PRE RINSE SPRAYER WALL MOUNTED	SB	GC	1.2 GPM FLOW RATE		
10597	1	FAUCET - SINGLE HANDLE	SB	GC	0.5 GPM FLOW RATE		
10804	1	FAUCET - PRE RINSE SWING SPOUT	SB	GC			
10874	1	FAUCET - INSTAHOT SYSTEM SINGLE LEVER	SB	GC	0.5 GPM FLOW RATE		
10922	1	FAUCET - MOP SINK WALL MOUNTED	SB	GC			
11003	3	FAUCET - METERED	SB	GC	METERED		
13588	1	FAUCET - HAND SINK WALL MOUNTED	SB	GC			
15749	2	FAUCET - HOT AND COLD WATER SYSTEM	SB	GC			
21352	2	FAUCET - RESTROOM WITH MOTION SENSOR					
FILTER		T-11	100	100			
13076	1	FILTER - PREFILTRATION SYSTEM	SB	SB	GC TO COORDINATE WITH SB VENDOR		
13080	1	FILTER - HEAD QUAD	SB	SB	GC TO COORDINATE WITH SB VENDOR		
13081	4	FILTER - CARBON FILTER CARTRIDGE	SB	SB	GC TO COORDINATE WITH SB VENDOR		
13149	1	FILTER - PRESSURE GAUGE	SB	SB	GC TO COORDINATE WITH SB VENDOR		
OTHER							
22231	1	WATER HEATER TANK GAS - 199.9K BTU	GC	GC	BRADFORD WHITE MODEL NO. D-100L-199-3N, 199.9 MBH INPUT		
SINK							
10116	2	SINK - RESTROOM WALL MOUNTED	SB	GC			
10549	1	SINK - RINSE DROP IN SST - 12X20IN 305X510MM	SB	GC			
12807	1	SINK - UTENSIL RINSE WITH GRATE SST - LH - 14X20IN 355X510MM	SB	GC			
13264	1	SINK - 3 COMP WORK SST - 93IN 2350MM	SB	GC			
14688	1	SINK - HAND WITH SIDE SPLASH WALL MOUNTED SST	SB	GC			
17565	1	SINK - RINSE WITH DRAINBOARD - 15X27IN 380X685MM	SB	GC			
17632	1	SINK - STACKED DRAINBOARD - 15IN 380MM	SB	GC			
18743	1	SINK - WATER FILLING STATION - 36X24IN 915X610MM	SB	GC			
19277	2	SINK - COUNTERTOP RINSER WITH DRAIN TROUGH - 26X9IN 660X235MM	SB	GC			
X10995	1	SINK - MOP - 36X36IN	GC	GC			
TOILET 12951	2	TOILET - TANKLESS EFFICIENT SINGLE FLUSH	GC	GC	SLOAN MODEL ST-2020-1.28, ADA COMPLIANT VITEROUS CHINA WATER CLOSET, WHITE, PROVIDE WITH CHURCH COMMERICAL 295CT TOILET SEAT		
13040	2	TOILET - FLUSH VALVE AUTOMATIC EFFICIENT SINGLE FLUSH	GC	GC	SLOAN MODEL 8111-1.28 OPTIMA SYSTEMS BATTERY POWERED FLUSHOMETERS		



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STARBUCKS TEMPLATE VERSION: i2021-01-22



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Revision Schedule

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PLUMBING SCHEDULES

SCALE: AS SHOWN

SHEET NUMBER: