

VICINITY MAP
 NOT TO SCALE

SPRING LAKE RAY ROAD DOLLAR GENERAL SITE DEVELOPMENT PLANS

ANDERSON CREEK TOWNSHIP
 NEAR SPRING LAKE, NORTH CAROLINA
 HARNETT COUNTY

EXISTING UTILITY OWNER

WATER
 HARNETT REGIONAL WATER
 700 McKinney Parkway
 Lillington, North Carolina 27546
 910-893-7575
 Contact: Shane Cummings, PE



CIVIL ENGINEER
 4D SITE SOLUTIONS, INC.
 409 Chicago Drive - Suite 112
 Fayetteville, North Carolina 28306
 910-426-6777
 Contact: Scott Brown, PE
 email: sbrown@4dsitesolutions.com

INDEX OF DRAWINGS

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OWNER/DEVELOPER
 RHETSON COMPANIES, INC
 2075 Juniper Lake Road
 West End, North Carolina, 27376
 910-944-0881
 Contact: JOHN PARKER
 email: john@rhetson.com

SURVEYOR
 4D SITE SOLUTIONS, INC.
 409 Chicago Drive - Suite 112
 Fayetteville, North Carolina 28306
 910-426-6777
 Contact: Jimmy Holland, PLS
 email: jholland@4dsitesolutions.com



REVISIONS

PROJECT NAME

**SPRING LAKE
 RAY ROAD
 DOLLAR
 GENERAL**

TAX ID# 0505-48-7310.000
 RAY ROAD
 ANDERSON CREEK
 TOWNSHIP
 NEAR SPRING LAKE
 HARNETT COUNTY
 NORTH CAROLINA

CLIENT

**RHETSON
 COMPANIES, INC**

2075 Juniper Lake Road
 West End, North Carolina 27376
 Phone: (910) 944-0881

PROJECT INFORMATION

DESIGNED BY:	SCOTT
DRAWN BY:	SCOTT
CHECKED BY:	CHRIS
PROJECT NUMBER:	1644

DRAWING SCALE

SEE SHEETS

DATE RELEASED

APRIL 22, 2021



REVISIONS

PROJECT NAME

**SPRING LAKE
RAY ROAD
DOLLAR
GENERAL**

UTILITY NOTES

CLIENT

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G-1.0


2020_HRW_REQUIRED_UTILITY_NOTES
(REVISION 8 – MARCH 2020)

WATER

- A. THE FIRE MARSHAL'S OFFICE SHALL APPROVE ALL HYDRANT TYPES AND LOCATIONS IN NEW SUBDIVISIONS. HOWEVER, HARNETT REGIONAL WATER (HRW) PREFERENCES THE CONTRACTORS TO INSTALL ONE OF THE FOLLOWING FIRE HYDRANTS:
- MUELLER – SUPER CENTURIUM 250 A–423 MODEL WITH A 5¼" MAIN VALVE OPENING THREE WAY (TWO HOSE NOZZLES AND ONE PUMPER NOZZLE);
 - AMERICAN DARLING – MARK B–84–B MODEL WITH A 5¼" MAIN VALVE OPENING THREE WAY (TWO HOSE NOZZLES AND ONE PUMPER NOZZLE);
 - WATEROUS – PACER B–67–250 MODEL WITH A 5¼" MAIN VALVE OPENING THREE WAY (TWO HOSE NOZZLES AND ONE PUMPER NOZZLE) OR APPROVED EQUAL FOR STANDARDIZATION.
- B. FIRE HYDRANTS ARE INSTALLED AT CERTAIN ELEVATIONS. ANY GRADE CHANGE NEAR ANY FIRE HYDRANT, WHICH IMPEDES ITS OPERATION, SHALL BECOME THE RESPONSIBILITY OF THE UTILITY CONTRACTOR FOR CORRECTION. CORRECTIONS WILL BE MONITORED BY THE HRW UTILITY CONSTRUCTION INSPECTOR AND THE HARNETT COUNTY FIRE MARSHAL.
- C. THE PROFESSIONAL ENGINEER (PE) SHALL OBTAIN AND PROVIDE THE NCDCE "AUTHORIZATION TO CONSTRUCT" PERMIT TO THE UTILITY CONTRACTOR BEFORE THE CONSTRUCTION OF THE WATER LINE SHALL BEGIN. THE UTILITY CONTRACTOR MUST POST A COPY OF THE NCDCE "AUTHORIZATION TO CONSTRUCT" PERMIT ISSUED BY THE NORTH CAROLINA DEPARTMENT OF ENVIRONMENTAL QUALITY (NDEQ) ON SITE PRIOR TO THE START OF CONSTRUCTION. THE PERMIT MUST BE MAINTAINED ON SITE THROUGHOUT THE ENTIRE CONSTRUCTION PROCESS OF THE PROPOSED WATER LINES THAT WILL SERVE THIS PROJECT.
- D. THE UTILITY CONTRACTOR SHALL NOTIFY HARNETT REGIONAL WATER (HRW) AND THE PROFESSIONAL ENGINEER (PE) AT LEAST TWO DAYS PRIOR TO CONSTRUCTION COMMENCING. THE UTILITY CONTRACTOR MUST SCHEDULE A PRE-CONSTRUCTION CONFERENCE WITH MR. ALAN MOSS, HRW UTILITY CONSTRUCTION INSPECTOR AT LEAST TWO (2) DAYS BEFORE CONSTRUCTION WILL BEGIN AND THE UTILITY CONTRACTOR MUST COORDINATE WITH HRW FOR REGULAR INSPECTION VISITATIONS AND ACCEPTANCE OF THE WATER SYSTEM(S). CONSTRUCTION WORK SHALL BE PERFORMED ONLY DURING THE NORMAL WORKING HOURS OF HRW WHICH IS 8:00 AM – 5:00 PM MONDAY THROUGH FRIDAY. HOLIDAY AND WEEKEND WORK IS NOT PERMITTED BY HRW.
- E. THE PROFESSIONAL ENGINEER (PE) SHALL PROVIDE HRW AND THE UTILITY CONTRACTOR WITH A SET OF NCDCE APPROVED PLANS MARKED "RELEASED FOR CONSTRUCTION" AT LEAST TWO DAYS PRIOR TO CONSTRUCTION COMMENCING. THE REGISTERED LAND SURVEYOR (RLS) SHOULD STAKE OUT ALL LOT CORNERS AND THE GRADE STAKES FOR THE PROPOSED FINISH GRADE FOR EACH STREET BEFORE THE UTILITY CONTRACTOR BEGINS CONSTRUCTION OF THE WATER LINE(S). THE GRADE STAKES SHOULD BE SET WITH A CONSISTENT OFFSET FROM THE STREET CENTERLINE SO AS NOT TO INTERFERE WITH THE STREET GRADING AND UTILITY CONSTRUCTION.
- F. THE UTILITY CONTRACTOR SHALL PROVIDE THE HRW UTILITY CONSTRUCTION INSPECTOR WITH MATERIAL SUBMITTALS AND SHOP DRAWINGS FOR ALL PROJECT MATERIALS PRIOR TO THE CONSTRUCTION OF ANY WATER LINE EXTENSION(S), AND ASSOCIATED WATER SERVICES IN HARNETT COUNTY. THE MATERIALS TO BE USED ON THE PROJECT MUST MEET THE ESTABLISHED SPECIFICATIONS OF HRW AND BE APPROVED BY THE ENGINEER OF RECORD PRIOR TO CONSTRUCTION. ALL SUBSTANDARD MATERIALS OR MATERIALS NOT APPROVED FOR USE IN HARNETT COUNTY FOUND ON THE PROJECT SITE MUST BE REMOVED IMMEDIATELY WHEN NOTIFIED BY THE HRW UTILITY CONSTRUCTION INSPECTOR.
- G. THE WATER MAIN(S), FIRE HYDRANTS, SERVICE LINES, METER SETTERS AND ALL ASSOCIATED APPURTENANCES SHALL BE CONSTRUCTED IN STRICT IN ACCORDANCE WITH THE STANDARD SPECIFICATIONS OF THE HARNETT REGIONAL WATER (HRW). THE UTILITY CONTRACTOR SHALL BE RESPONSIBLE TO LOCATE THE NEWLY INSTALLED WATER MAIN(S), WATER SERVICE LINES AND ALL ASSOCIATED METER SETTERS AND METER BOXES FOR OTHER UTILITY COMPANIES AND THEIR CONTRACTORS UNTIL THE NEW WATER MAIN(S) HAVE BEEN APPROVED BY THE NORTH CAROLINA DEPARTMENT OF ENVIRONMENTAL QUALITY, DIVISION OF ENVIRONMENTAL HEALTH, PUBLIC WATER SUPPLY SECTION (NCDCE, DEH, FWS) AND ACCEPTED BY HRW.
- H. PRIOR TO ACCEPTANCE, ALL SERVICES WILL BE INSPECTED TO INSURE THAT THEY ARE INSTALLED AT THE PROPER DEPTH. ALL METER BOXES MUST BE FLUSH WITH THE GROUND LEVEL AT FINISH GRADE AND THE METER SETTERS MUST BE A MINIMUM OF 8" BELOW THE METER BOX LID. METER SETTERS SHALL BE CENTERED IN THE METER BOX AND SUPPORTED BY BRICK, BLOCK OR STONE.
- I. THE UTILITY CONTRACTOR SHALL PROVIDE THE PROFESSIONAL ENGINEER (PE) AND HRW UTILITY CONSTRUCTION INSPECTOR WITH A SET OF RED LINE DRAWINGS IDENTIFYING THE COMPLETE WATER SYSTEM INSTALLED FOR EACH PROJECT. THE RED LINE DRAWINGS SHOULD IDENTIFY THE MATERIALS, PIPE SIZES AND APPROXIMATE DEPTHS OF THE WATER LINES AS WELL AS THE GATE VALVES, FIRE HYDRANTS, METER SETTERS, BLOW OFF ASSEMBLIES AND ALL ASSOCIATED APPURTENANCES FOR ALL WATER LINE(S) CONSTRUCTED IN HARNETT COUNTY. THE RED LINE DRAWINGS SHOULD CLEARLY IDENTIFY ANY DEVIATIONS FROM THE NCDCE APPROVED PLANS. ALL CHANGE ORDERS MUST BE APPROVED BY HRW AND THE PROFESSIONAL ENGINEER (PE) IN WRITING AND PROPERLY DOCUMENTED IN THE RED LINE FIELD DRAWINGS.
- J. POTABLE WATER MAINS CROSSING OTHER UTILITIES AND NON-POTABLE WATER LINES (SANITARY SEWER, STORM SEWER, RCP, ETC.) SHALL BE LAID TO PROVIDE A MINIMUM VERTICAL DISTANCE OF TWENTY-FOUR (24") INCHES BETWEEN THE POTABLE WATER MAIN AND ALL OTHER UTILITIES. NCDOT REQUIRES THE NEW WATER MAINS TO BE INSTALLED UNDER THE STORM WATER LINES. THE POTABLE WATER MAIN SHALL BE INSTALLED WITH TWENTY-FOUR (24") INCHES OF VERTICAL SEPARATION AND WITH DUCTILE IRON PIPE WHEN DESIGNED TO BE PLACED UNDER A NON-POTABLE WATER LINE SUCH AS SANITARY SEWER OR STORM SEWER LINES. IF THESE SEPARATIONS CANNOT BE MAINTAINED THEN THE WATER MAIN SHALL BE INSTALLED WITH DUCTILE IRON PIPE. BOTH THE POTABLE WATER MAIN AND THE NON-POTABLE WATER LINE MUST BE CAST IRON OR DUCTILE IRON PIPE (DIP) IF THE STATE MINIMUM SEPARATIONS CANNOT BE MAINTAINED. THE DUCTILE IRON PIPE MUST BE LAID SO THE MECHANICAL JOINTS ARE AT LEAST (10') FEET FROM THE POINT WHERE THE POTABLE WATER MAIN CROSSES THE NON-POTABLE WATER LINE.
- K. POTABLE WATER MAINS INSTALLED PARALLEL TO NON-POTABLE WATER LINES (SANITARY SEWER, STORM SEWER, RCP, ETC.) SHALL BE LAID TO PROVIDE A MINIMUM HORIZONTAL DISTANCE OF TEN (10') FEET BETWEEN THE POTABLE WATER MAIN AND SANITARY SEWER MAINS, SEWER LATERALS AND SERVICES. THE HORIZONTAL SEPARATION BETWEEN THE POTABLE WATER MAIN AND ANY OTHER UTILITY OR STORM SEWER SHALL NOT BE LESS THAN FIVE (5') FEET. THE POTABLE WATER MAIN MUST BE DUCTILE IRON PIPE IF THIS HORIZONTAL SEPARATION OF TEN (10') FEET CANNOT BE MAINTAINED. THE DUCTILE IRON PIPE SHALL EXTEND AT LEAST TEN (10') FEET BEYOND THE POINT WHERE THE MINIMUM REQUIRED HORIZONTAL SEPARATION OF TEN (10') FEET CAN BE RE-ESTABLISHED.
- L. METER SETTERS SHALL BE INSTALLED IN PAIRS ON EVERY OTHER LOT LINE WHERE POSSIBLE TO LEAVE ADEQUATE SPACE FOR OTHER UTILITIES TO BE INSTALLED AT A LATER TIME. THE METER SETTERS SHALL BE INSTALLED AT LEAST ONE (1') FOOT INSIDE THE RIGHT-OF-WAY AND AT LEAST THREE (3') TO FIVE (5') FEET FROM THE PROPERTY LINE BETWEEN THE LOTS.
- M. HRW REQUIRES THAT METER BOXES FOR ¾" SERVICES SHALL BE 12" WIDE X 17" LONG ABS PLASTIC BOXES AT LEAST 18" IN HEIGHT WITH CAST IRON LIDS/COVERS. METER BOXES FOR 1" SERVICES SHALL BE 17" WIDE X 21" LONG ABS PLASTIC BOXES AT LEAST 18" IN HEIGHT WITH PLASTIC LIDS AND CAST IRON FLIP COVERS IN THE CENTER OF THE LIDS. METER BOXES FOR 2" SERVICES SHALL BE 20" WIDE X 32" LONG ABS PLASTIC BOXES AT LEAST 20" IN HEIGHT WITH PLASTIC LIDS AND CAST IRON FLIP COVERS IN THE CENTER OF THE LIDS.
- N. MASTER METERS MUST BE INSTALLED IN CONCRETE VAULTS SIZED FOR THE METER ASSEMBLY AND ASSOCIATED APPURTENANCES SO AS TO PROVIDE AT LEAST EIGHTEEN (18") INCHES OF CLEARANCE BETWEEN THE BOTTOM OF THE CONCRETE VAULT AND THE BOTTOM OF THE METER SETTER. THE MASTER METER MUST BE PROVIDED TEST PORTS IF THE METER IS NOT EQUIPPED WITH TEST PORTS FROM THE MANUFACTURER IN ACCORDANCE WITH THE HRW ESTABLISHED STANDARD SPECIFICATIONS AND DETAILS. DUCTILE IRON PIPE MUST BE USED FOR THE MASTER METER VAULT PIPING AND VALVE VAULT PIPING. THE UTILITY CONTRACTOR MUST PROVIDE SHOP DRAWINGS FOR THE METER VAULTS TO HRW PRIOR TO ORDERING THE CONCRETE VAULTS.
- O. THE UTILITY CONTRACTOR WILL INSTALL POLYETHYLENE SDR-9 WATER SERVICE LINES THAT CROSS UNDER THE PAVEMENT INSIDE A SCHEDULE 40 PVC CONDUIT TO ALLOW FOR REMOVAL AND REPLACEMENT IN THE FUTURE. TWO (2) INDEPENDENT ¾" WATER SERVICE LINES MAY BE INSTALLED INSIDE ONE (1) – TWO (2") INCH SCHEDULE 40 PVC CONDUIT OR TWO (2) INDEPENDENT 1" WATER SERVICE LINES MAY BE INSTALLED INSIDE ONE (1) – THREE (3") INCH SCHEDULE 40 PVC CONDUIT, BUT EACH WATER SERVICE SHALL BE TAPPED DIRECTLY TO THE WATER MAIN. SPLIT SERVICES ARE NOT ALLOWED BY HRW. IF SIDEWALKS ARE PROPOSED, THE CONDUIT MUST EXTEND PAST THE SIDEWALK.
- P. THE WATER MAIN(S), FIRE HYDRANTS, GATE VALVES, SERVICE LINES, METER SETTERS AND ASSOCIATED APPURTENANCES MUST BE RATED FOR 200 PSI AND HYDROSTATICALLY PRESSURE

TESTED TO 200 PSI. THE HYDROSTATIC PRESSURE TEST(S) MUST BE WITNESSED BY THE HRW UTILITY CONSTRUCTION INSPECTOR. THE UTILITY CONTRACTOR MUST NOTIFY HRW WHEN THEY ARE READY TO BEGIN FILLING IN LINES AND COORDINATE WITH HARNETT REGIONAL WATER TO WITNESS ALL PRESSURE TESTING.

- Q. THE UTILITY CONTRACTOR SHALL CONDUCT A PNEUMATIC PRESSURE TEST USING COMPRESSED AIR OR OTHER INERT GAS ON THE STAINLESS STEEL TAPPING SLEEVE(S) PRIOR TO MAKING THE TAP ON THE EXISTING WATER MAIN. THIS PNEUMATIC PRESSURE TEST MUST BE WITNESSED BY THE HRW UTILITY CONSTRUCTION INSPECTOR. THE UTILITY CONTRACTOR SHALL USE ROMAC BRAND STAINLESS STEEL TAPPING SLEEVE(S) OR APPROVED EQUAL FOR ALL TAPS MADE IN HARNETT COUNTY. ALL NEW WATER LINE EXTENSIONS MUST BEGIN WITH A RESILIENT WEDGE TYPE GATE VALVE SIZED EQUAL TO THE DIAMETER OF THE NEW WATER LINE EXTENSION IN ORDER TO PROVIDE A MEANS OF ISOLATION BETWEEN HARNETT REGIONAL WATER'S EXISTING WATER MAINS AND THE NEW WATER LINE EXTENSIONS UNDER CONSTRUCTION.
- R. ALL WATER MAINS WILL BE CONSTRUCTED WITH SDR-21 PVC PIPE OR CLASS 50 DUCTILE IRON PIPE RATED FOR AT LEAST 200 PSI OR GREATER. ALL PIPES MUST BE PROTECTED DURING LOADING, TRANSPORT, UNLOADING, STAGING, AND INSTALLATION. PVC PIPE MUST BE PROTECTED FROM EXTENDED EXPOSURE TO SUNLIGHT PRIOR TO INSTALLATION.
- S. ALL WATER MAINS WILL BE FLUSHED AND DISINFECTED IN STRICT ACCORDANCE WITH THE STANDARD SPECIFICATIONS OF THE HARNETT REGIONAL WATER. ALL WATER SAMPLES COLLECTED FOR BACTERIA TESTING WILL BE COLLECTED BY THE HRW UTILITY CONSTRUCTION INSPECTOR AND TESTED IN THE HRW LABORATORY.
- T. ALL FITTINGS LARGER THAN TWO (2") INCHES DIAMETER SHALL BE DUCTILE IRON. HRW REQUIRES THAT MECHANICAL JOINTS BE ASSEMBLED WITH GRIP RINGS AS "MEGALUG" FITTINGS ARE NOT APPROVED BY HARNETT REGIONAL WATER FOR PIPE SIZES SMALLER THAN TWELVE INCHES (12") DIAMETER. PVC PIPE USED FOR WATER MAINS SHALL BE CONNECTED BY SLIP JOINT OR MECHANICAL JOINT WITH GRIP RINGS. GLUED PIPE JOINTS ARE NOT ALLOWED ON PVC PIPE USED FOR WATER MAINS IN HARNETT COUNTY.
- U. HRW REQUIRES THAT THE UTILITY CONTRACTOR INSTALL TRACER WIRE IN THE TRENCH WITH ALL WATER LINES. THE TRACER WIRE SHALL BE 12 GA. INSULATED, SOLID COPPER CONDUCTOR AND IT SHALL BE TERMINATED AT THE TOP OF THE VALVE BOXES OR MANHOLES. NO SPLICED WIRE CONNECTIONS SHALL BE MADE UNDERGROUND ON TRACER WIRE INSTALLED IN HARNETT COUNTY. THE TRACER WIRE MAY BE SECURED WITH DUCT TAPE TO THE TOP OF THE PIPE BEFORE BACKFILLING.
- V. THE UTILITY CONTRACTOR WILL PROVIDE PROFESSIONAL ENGINEER (PE) AND THE HRW UTILITY CONSTRUCTION INSPECTOR WITH A SET OF RED LINE FIELD DRAWINGS TO IDENTIFY THE INSTALLED LOCATIONS OF THE WATER LINE(S) AND ALL ASSOCIATED SERVICES. ALL CHANGE ORDERS MUST BE PRE-APPROVED BY HRW AND THE PROFESSIONAL ENGINEER (PE) IN WRITING AND PROPERLY DOCUMENTED IN THE RED LINE FIELD DRAWINGS.
- W. THE UTILITY CONTRACTOR SHALL SPOT DIG TO EXPOSE EACH UTILITY PIPE OR LINE WHICH MAY CONFLICT WITH CONSTRUCTION OF PROPOSED WATER LINE EXTENSIONS WELL IN ADVANCE TO VERIFY LOCATIONS OF THE EXISTING UTILITIES. THE UTILITY CONTRACTOR SHALL PROVIDE BOTH HORIZONTAL AND VERTICAL CLEARANCES TO THE PROFESSIONAL ENGINEER (PE) TO ALLOW THE PE TO ADJUST THE WATER LINE DESIGN IN ORDER TO AVOID CONFLICTS WITH EXISTING UNDERGROUND UTILITIES. THE UTILITY CONTRACTOR SHALL COORDINATE WITH THE UTILITY OWNER AND BE RESPONSIBLE FOR TEMPORARY RELOCATION AND/OR SECURING EXISTING UTILITY POLES, PIPES, WIRES, CABLES, SIGNS AND/OR UTILITIES INCLUDING SERVICES IN ACCORDANCE WITH THE UTILITY OWNER REQUIREMENTS DURING WATER LINE INSTALLATION, GRADING AND STREET CONSTRUCTION.
- X. PRIOR TO THE COMMENCEMENT OF ANY WORK WITHIN ESTABLISHED UTILITY EASEMENTS OR NCDOT RIGHT-OF-WAYS THE UTILITY CONTRACTOR IS REQUIRED TO HAVE A SIGNED NCDOT ENCROACHMENT AGREEMENT POSTED ON SITE AND NOTIFY ALL CONCERNED UTILITY COMPANIES IN ACCORDANCE WITH G.S. 87-102. THE UTILITY CONTRACTOR MUST CALL THE NC ONE CALL CENTER AT 811 OR (800) 652-4949 TO VERIFY THE LOCATION OF EXISTING UTILITIES PRIOR TO THE BEGINNING OF CONSTRUCTION. EXISTING UTILITIES SHOWN IN THESE PLANS ARE TAKEN FROM MAPS FURNISHED BY VARIOUS UTILITY COMPANIES AND HAVE NOT BEEN PHYSICALLY LOCATED OR VERIFIED BY THE P.E. (I.E. TELEPHONE, CABLE, WATER, SEWER, ELECTRICAL POWER, FIBER OPTIC, NATURAL GAS, ETC.). THE UTILITY CONTRACTOR WILL BE RESPONSIBLE TO REPAIR ANY AND ALL DAMAGES TO THE SATISFACTION OF THE RELATED UTILITY COMPANY.
- Y. THE UTILITY CONTRACTOR SHALL PROVIDE HRW WITH AT LEAST ONE (1) FIRE HYDRANT WRENCH AND ONE (1) BREAK-AWAY FLANGE KIT FOR EVERY SUBDIVISION WITH FIRE HYDRANTS DEVELOPED IN HARNETT COUNTY. THESE ITEMS MUST BE PROVIDED TO HRW BEFORE THE FINAL INSPECTION WILL BE SCHEDULED BY THE HRW UTILITY CONSTRUCTION INSPECTOR. IN ADDITION, THE UTILITY CONTRACTOR SHALL INSTALL A 4" X 4" CONCRETE VALVE MARKER AT THE EDGE OF THE RIGHT-OF-WAY TO IDENTIFY THE LOCATION OF EACH GATE VALVE INSTALLED IN THE NEW WATER SYSTEM WITH THE EXCEPTION OF THE FIRE HYDRANT ISOLATION VALVES. THE CONTRACTOR SHALL MEASURE THE DISTANCE FROM THE CENTER OF THE CONCRETE MARKER TO THE CENTER OF THE VALVE BOX. THIS DISTANCE (IN LINEAR FEET) SHALL BE STAMPED ON THE BRASS PLATE LOCATED ON THE GATE VALVE MARKER. IN LIEU OF INSTALLING THE CONCRETE VALVE MARKERS, THE UTILITY CONTRACTOR MAY PROVIDE AT LEAST TWO MEASUREMENTS FROM TWO INDEPENDENT PERMANENT ABOVE GROUND STRUCTURES TO THE PROFESSIONAL ENGINEER (PE) IN THE RED LINE DRAWINGS TO IDENTIFY THE VALVE LOCATIONS. THE PROFESSIONAL ENGINEER (PE) MUST INCLUDE THESE MEASUREMENTS IN THE AS-BUILT RECORD DRAWINGS SUBMITTED TO HRW.
- Z. THE UTILITY CONTRACTOR WILL BE RESPONSIBLE FOR ANY AND ALL REPAIRS DUE TO LEAKAGE DAMAGE FROM POOR WORKMANSHIP DURING THE ONE (1) YEAR WARRANTY PERIOD ONCE THE WATER SYSTEM IMPROVEMENTS HAVE BEEN ACCEPTED BY HARNETT REGIONAL WATER. HARNETT REGIONAL WATER WILL PROVIDE MAINTENANCE AND REPAIRS WHEN REQUESTED AND BILL THE DEVELOPER AND/OR UTILITY CONTRACTOR IF NECESSARY DUE TO LACK OF RESPONSE WITHIN 48 HOURS OF NOTIFICATION OF WARRANTY WORK. THE UTILITY CONTRACTOR WILL BE RESPONSIBLE FOR ANY AND ALL REPAIRS DUE TO DAMAGES RESULTING FROM FAILURE TO LOCATE THE NEW WATER LINES AND ASSOCIATED APPURTENANCES FOR OTHER UTILITIES AND THEIR CONTRACTORS UNTIL THE WATER LINES HAVE BEEN APPROVED BY NCDCE AND ACCEPTED BY HRW. THE FINAL INSPECTION OF WATER SYSTEM IMPROVEMENTS CANNOT BE SCHEDULED WITH HRW UNTIL THE STREETS HAVE BEEN PAVED; THE RIGHTS-OF-WAY AND UTILITY EASEMENTS HAVE BEEN SEEDDED AND STABILIZED WITH AN ADEQUATE STAND OF GRASS IN PLACE TO PREVENT EROSION ISSUES ON SITE.
- AA. THE ENGINEER OF RECORD IS RESPONSIBLE TO INSURE THAT CONSTRUCTION IS, AT ALL TIMES, IN COMPLIANCE WITH ACCEPTED SANITARY ENGINEERING PRACTICES AND APPROVED PLANS AND SPECIFICATIONS. NO FIELD CHANGES TO THE APPROVED PLANS ARE ALLOWED WITHOUT PRIOR WRITTEN APPROVAL BY HRW. A COPY OF EACH ENGINEER'S FIELD REPORT IS TO BE SUBMITTED TO HRW AS EACH SUCH INSPECTION IS MADE ON SYSTEM IMPROVEMENTS OR TESTING IS PERFORMED BY THE CONTRACTOR. WATER AND SEWER INFRASTRUCTURE MUST PASS ALL TESTS REQUIRED BY HRW SPECIFICATIONS AND THOSE OF ALL APPLICABLE REGULATORY AGENCIES. THESE TESTS INCLUDE, BUT ARE NOT LIMITED TO: AIR TEST, VACUUM TEST, MANDREL TEST, VISUAL TEST, PRESSURE TEST, BACTERIOLOGICAL TEST, ETC. A HRW INSPECTOR MUST BE PRESENT DURING TESTING AND ALL TEST RESULTS SHALL BE SUBMITTED TO HRW. ALL TESTS MUST BE SATISFIED BEFORE THE FINAL INSPECTION WILL BE SCHEDULED WITH THE HRW INSPECTOR. THE ENGINEER OF RECORD MUST REQUEST IN WRITING TO SCHEDULE THE FINAL INSPECTION ONCE ALL CONSTRUCTION IS COMPLETE. THE DEVELOPER'S ENGINEER OF RECORD AND THE HRW UTILITY CONSTRUCTION INSPECTOR SHALL PREPARE A WRITTEN PUNCH LIST OF ANY DEFECTS OR DEFICIENCIES NOTED DURING THE FINAL INSPECTION, SHOULD ANY EXIST. UPON COMPLETION OF THE PUNCH LIST, THE DEVELOPER'S ENGINEER OF RECORD WILL SCHEDULE ANOTHER INSPECTION. IN THE EVENT THE NUMBER OF INSPECTIONS PERFORMED BY THE HRW EXCEEDS TWO, ADDITIONAL FEES MAY BE ACCESSED TO THE DEVELOPER.

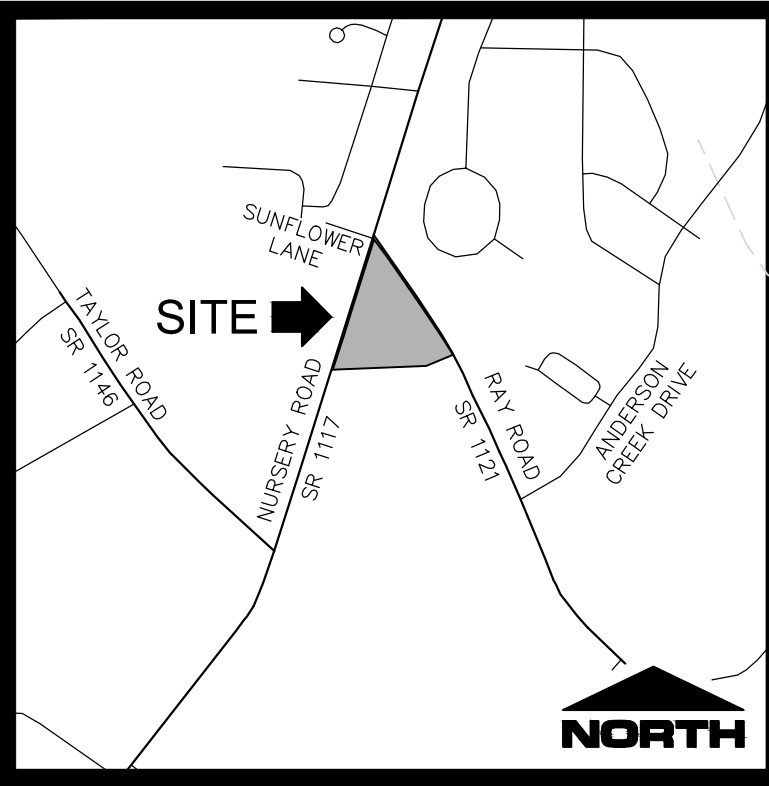

VICINITY MAP
NOT TO SCALE

- LEGEND:
- ECM - EXISTING CONCRETE MONUMENT
 - EIP - EXISTING IRON PIPE
 - ER - EXISTING IRON ROD
 - EPK - EXISTING PK NAIL
 - SRB - SET REBAR
 - CP - COMPUTED POINT
 - N/F - NOW OR FORMERLY
 - R/W - RIGHT OF WAY
 - RCP - REINFORCED CONCRETE PIPE
 - PROPERTY LINE
 - OLD PROPERTY LINE
 - ADJACENT PROPERTY LINE
 - RIGHT-OF-WAY
 - WATER LINE
 - OVERHEAD UTILITY
 - TREE LINE
 - 280 - MAJOR CONTOUR
 - 274 - MINOR CONTOUR
 - SPOT ELEVATION
 - BENCHMARK
 - UTILITY POLE
 - WATER VALVE
 - FIRE HYDRANT
 - ASPHALT
 - BUILDING

- NOTES:
- ALL DISTANCES SHOWN ARE HORIZONTAL GROUND DISTANCES UNLESS OTHERWISE NOTED.
 - COMBINED SCALE FACTOR: 0.99987276
LOCALIZATION POINT N: 558676.845 E: 2,004,634.094
CONTROL ESTABLISHED VIA NORTH CAROLINA GEODETIC SURVEY VIRTUAL REFERENCE SYSTEM.
 - THE HORIZONTAL AND VERTICAL CONTROL FOR THIS SURVEY WERE ESTABLISHED USING THE NORTH CAROLINA GEODETIC SURVEY VIRTUAL REFERENCE SYSTEM.
 - INES NOT SURVEYED ARE SHOWN AS DASHED LINES FROM INFORMATION REFERENCED ON THE FACE OF THIS MAP.
 - NONCONFORMING STRUCTURES HAVE NOT BEEN CREATED BY THIS SURVEY.
 - THE SUBJECT PROPERTY IS THE SAME AS THE PROPERTY DESCRIBED IN THAT CERTAIN TITLE COMMITMENT ID. 202011492ASL, ISSUED BY INVESTORS TITLE INSURANCE COMPANY WITH AN EFFECTIVE DATE OF MARCH 12, 2020, AND ALL EASEMENTS, COVENANTS AND RESTRICTIONS REFERENCED IN SAID TITLE COMMITMENT OR APPARENT FROM A PHYSICAL INSPECTION OF THE SUBJECT PROPERTY OR OTHERWISE KNOWN TO ME HAVE BEEN PLOTTED HEREON OR OTHERWISE NOTED AS TO THEIR EFFECT ON THE SUBJECT PROPERTY.
 - LOCATIONS OF ALL UNDERGROUND UTILITIES LYING WITHIN THIS MAPPED AREA MAY NOT BE SHOWN ON THIS PLAN. DEVELOPERS OR CONTRACTORS SHOULD NOT ONLY MAKE SUBSURFACE INVESTIGATIONS BUT SHOULD ALSO ALLOW FOR CONTINGENCIES WHICH MIGHT ARISE BY REASON OF ENCOUNTERING UNRECORDED LINES OR OF LINES BEING IN DIFFERENT LOCATIONS THAN INDICATED ON THIS SURVEY.
 - THIS PROPERTY LIES WITHIN FLOOD ZONE "X" ACCORDING TO MAP # 3720050400J OF THE FLOOD INSURANCE RATE, DATED OCTOBER 3, 2006.

TOTAL AREA: (BY COORDINATE COMPUTATION)
316,312 SF (7.26 AC)




PIN NO: 0505-48-7310.000

ZONING: COMM

FRONT 35'
SIDE 0', 20' IF ADJACENT TO RESIDENTIAL ZONED LOT
CORNER SIDE 20', 15' IF ADJACENT TO ACCESS EASEMENT OR PRIVATE STREET
REAR 25'

TO VERIFY SETBACK INFORMATION
CONTACT THE HARNETT COUNTY
PLANNING DEPARTMENT 910-893-7525

SOURCE OF TITLE
DB 872, PG 506
DB 1673, PG 496
PB 2002, PG 1065
HARNETT COUNTY
REGISTER OF DEEDS

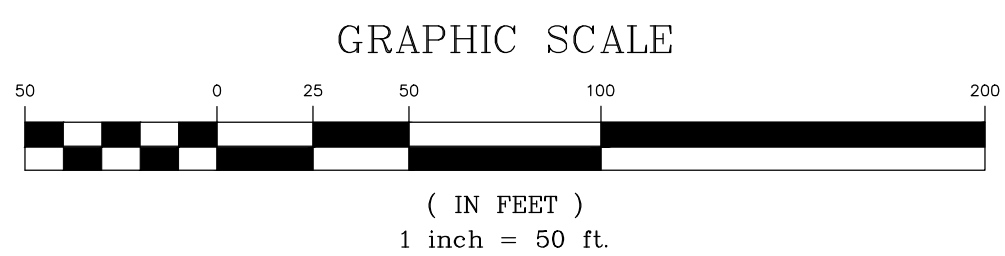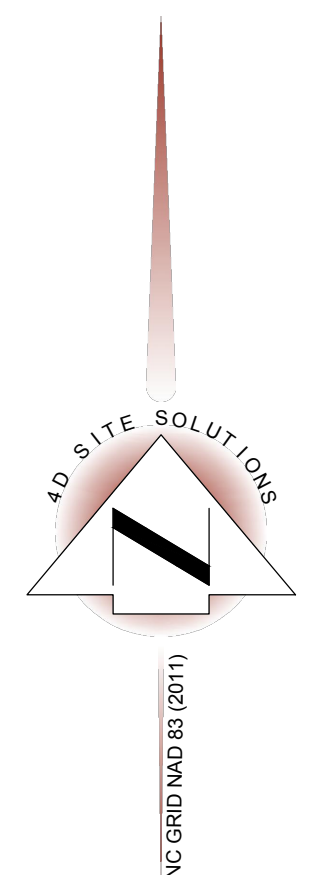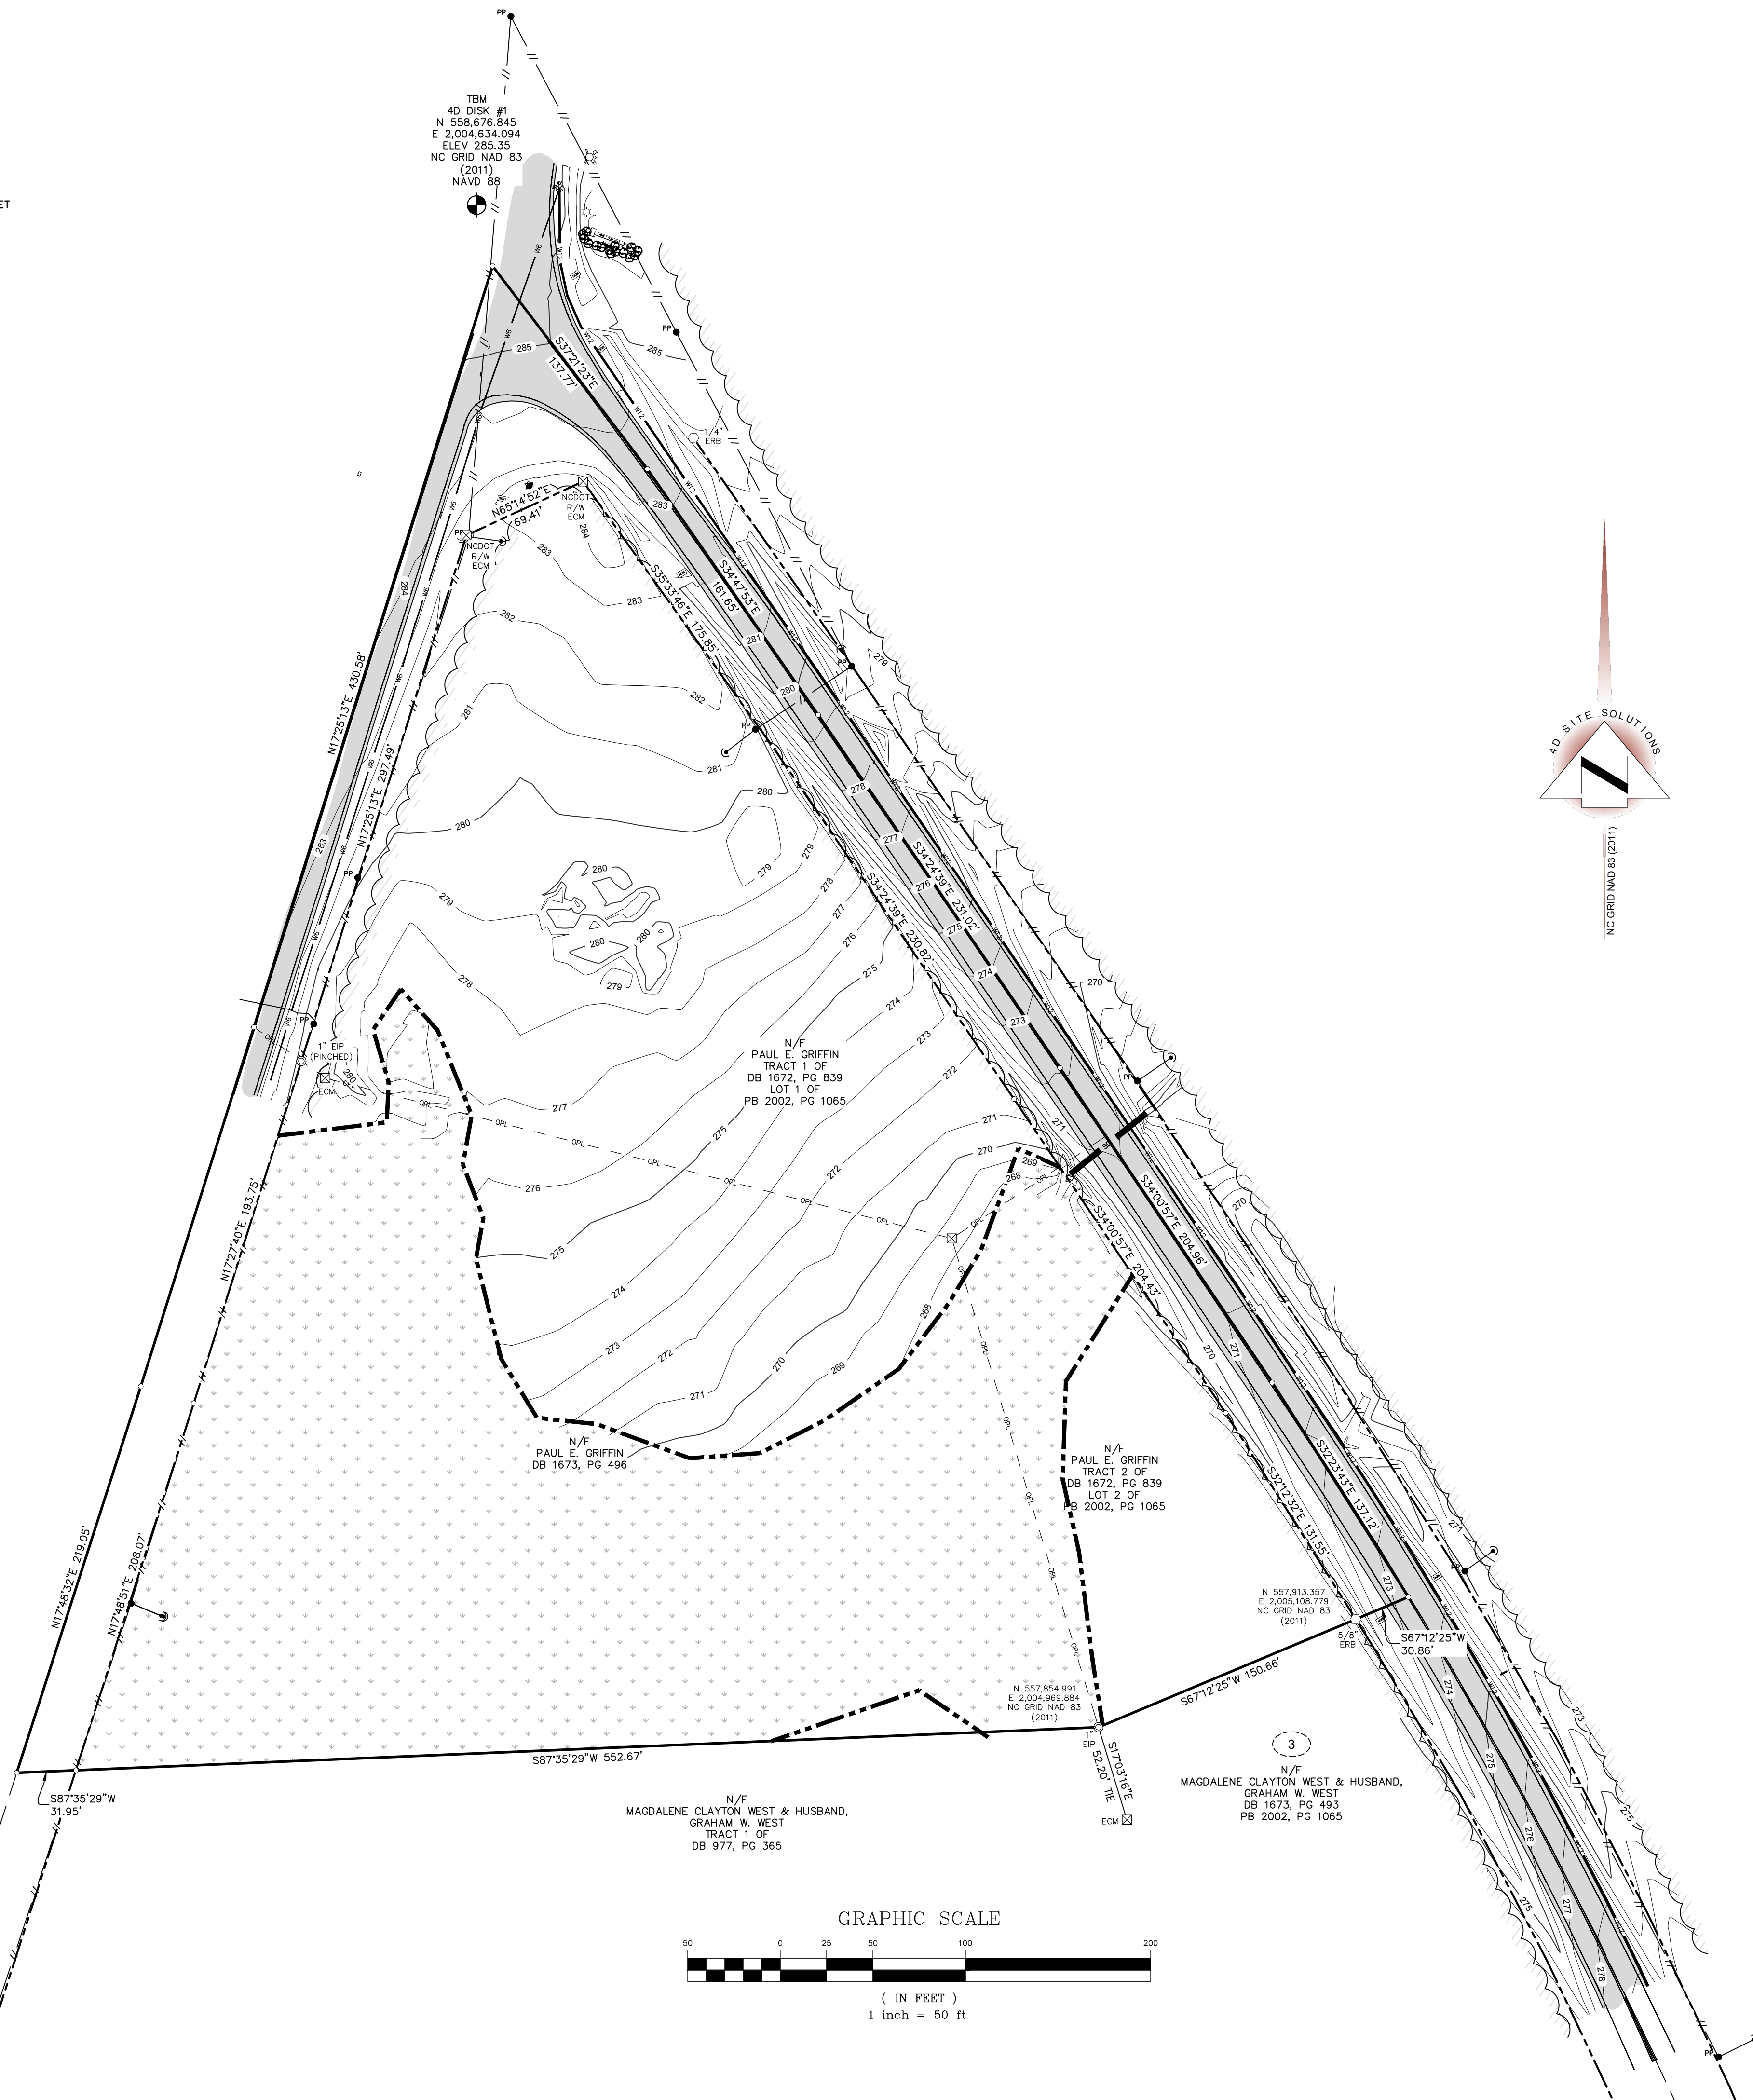

I, SEAN R. SEEVER, CERTIFY THAT THIS SURVEY IS OF AN EXISTING PARCEL OR PARCELS OF LAND OR ONE OR MORE EXISTING EASEMENTS AND DOES NOT CREATE A NEW STREET OR CHANGE AN EXISTING STREET.

Sean R. Seever
PROFESSIONAL LAND SURVEYOR - L-4571

I, SEAN R. SEEVER, CERTIFY THAT THIS CLASS "C" TOPOGRAPHIC MAP WAS DRAWN FROM AN ACTUAL SURVEY PERFORMED UNDER MY DIRECT SUPERVISION AND THAT IT MEETS OR EXCEEDS THE NORTH CAROLINA ADMINISTRATIVE CODE 21.56.1605 AND 21.56.1606. WITNESS MY HAND AND SEAL THIS 22 DAY OF APRIL, A.D., 2021.

Sean R. Seever
PROFESSIONAL LAND SURVEYOR - L-4571

I, SEAN R. SEEVER, CERTIFY THAT THIS MAP WAS DRAWN UNDER MY SUPERVISION FROM AN ACTUAL SURVEY MADE UNDER MY SUPERVISION (DEED DESCRIPTION RECORDED IN BOOK _____, PAGE _____ OR OTHER REFERENCE SOURCE _____); THAT THE BOUNDARIES NOT SURVEYED ARE INDICATED AS DRAWN FROM INFORMATION IN BOOK _____, PAGE _____ OR OTHER REFERENCE SOURCE _____; THAT THE RATIO OF PRECISION OR POSITIONAL ACCURACY IS 1:10,000+; AND THAT THIS MAP MEETS THE REQUIREMENTS OF THE STANDARDS OF PRACTICE FOR LAND SURVEYING IN NORTH CAROLINA (21 NCAC 56.1600). WITNESS MY HAND AND SEAL THIS 22 DAY OF APRIL, 2021.

Sean R. Seever
PROFESSIONAL LAND SURVEYOR - L-4571

I, SEAN R. SEEVER, CERTIFY THAT THE CONTROL FOR THIS SURVEY WAS ESTABLISHED FROM AN ACTUAL GPS SURVEY UNDER MY SUPERVISION. THIS GPS SURVEY WAS PERFORMED TO C-201 FCCC SPECIFICATIONS RTK GPS WITH VRS FIELD PROCEDURES WERE USED. THE COORDINATES WERE OBTAINED THROUGH A GRID TO GROUND ADJUSTMENT USING THE COMBINED SCALE FACTOR SHOWN HEREON. THIS SURVEY WAS PERFORMED ON JULY 9, 2020 USING TWO TRIMBLE 5700 RECEIVERS.

Sean R. Seever
PROFESSIONAL LAND SURVEYOR - L-4571



REVISIONS

PROJECT NAME
**SPRING LAKE
RAY ROAD
DOLLAR
GENERAL**

EXISTING
CONDITIONS

CLIENT
**RHETSON
COMPANIES, INC**

2075 Juniper Lake Road
West End, North Carolina 27376
Phone: (910) 944-0881


PROJECT INFORMATION

SURVEYED BY:	CLIFF
DRAWN BY:	SEAN
CHECKED BY:	JIMMY
PROJECT NUMBER:	1644

DRAWING SCALE
HORIZONTAL: 1"=40'

DATE SURVEYED
JULY 9, 2020

SHEET NUMBER
C-1.0

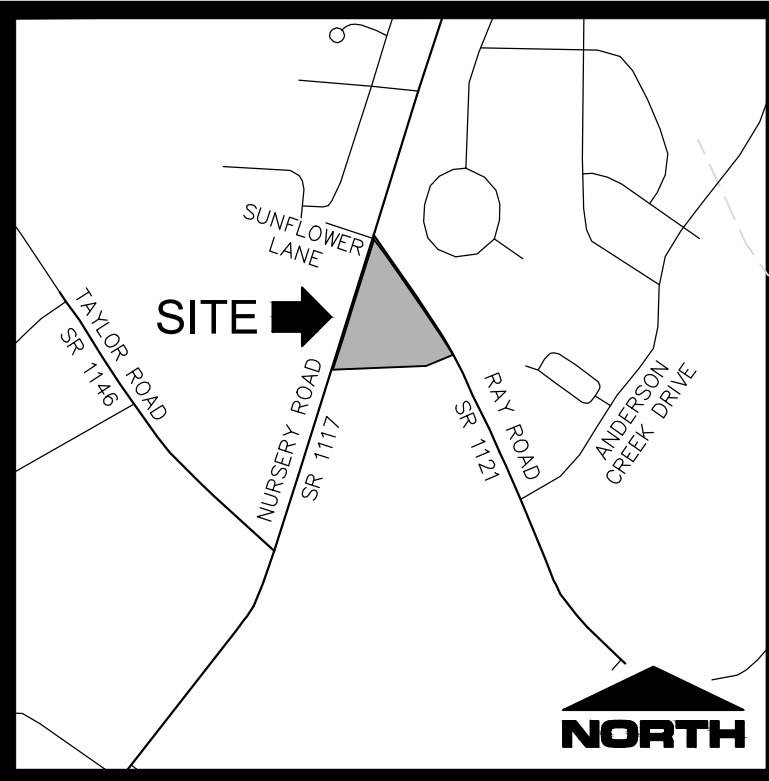

VICINITY MAP
NOT TO SCALE

LEGEND:

ECM	EXISTING CONCRETE MONUMENT
EIP	EXISTING IRON PIPE
ER	EXISTING IRON ROD
EPK	EXISTING PK NAIL
SRB	SET REBAR
CP	COMPUTED POINT
N/F	NOW OR FORMERLY
R/W	RIGHT OF WAY
RCP	REINFORCED CONCRETE PIPE
---	PROPERTY LINE
- - -	OLD PROPERTY LINE
- · - · -	ADJACENT PROPERTY LINE
- - - - -	RIGHT-OF-WAY
W	WATER LINE
///	OVERHEAD UTILITY
---	TREE LINE
---	MAJOR CONTOUR
---	MINOR CONTOUR
+	SPOT ELEVATION
+	BENCHMARK
PP	UTILITY POLE
WV	WATER VALVE
FD	FIRE HYDRANT
ASPH	ASPHALT
BUILD	BUILDING

SITE DATA	
DEVELOPER	RHETSON COMPANIES, INC
MAILING ADDRESS	2075 JUNIPER LAKE ROAD
CITY, STATE	WEST END, NORTH CAROLINA 27376
PIN NUMBER	PORTION OF 0505-48-7310.000
TOWNSHIP	ANDERSON CREEK
TOTAL SITE AREA	3.11 AC
ACREAGE TO BE DEVELOPED	3.11 AC
ZONING	COMM
EXISTING USE	UNDEVELOPED
PROPOSED USE	COMMERCIAL RETAIL
DISTURBED/DENUDED AREA	3.6 AC
IMPERVIOUS CALCS:	
TOTAL SITE AREA	135,590 SF
PRE-DEVELOPMENT	0 SF
POST-DEVELOPMENT	31,199 SF
SETBACKS REQUIRED:	
FRONT	35 FT
SIDE	0 FT
REAR	25 FT
PARKING:	
TOTAL REQUIRED	31 SPACES
PROVIDED (INCLUDING HC)	32 SPACES
HANDICAP SPACES	2 SPACES

- SITE NOTES
- EXISTING UNDERGROUND UTILITIES ARE SHOWN ONLY WHERE EVIDENCE COULD BE FOUND TO VERIFY LOCATION. PRIOR TO CONSTRUCTION OR EXCAVATION OF THE SITE, THE GENERAL CONTRACTOR SHALL VERIFY ALL UTILITY COMPANIES TO VERIFY THE LOCATION OF THEIR RESPECTIVE UTILITIES. ALL DAMAGE INCURRED TO EXISTING UTILITIES DURING CONSTRUCTION SHALL BE REPAIRED AT THE GENERAL CONTRACTOR'S EXPENSE.
 - ASPHALT AND BASE TYPE SHALL BE PER THE DETAILS.
 - HANDICAP RAMPS, SIGNAGE AND PARKING SPACES SHALL BE PROVIDED BY THE CONTRACTOR AND INSTALLED PER FEDERAL ADA AND LOCAL REQUIREMENTS.
 - ALL DIMENSIONS ARE TO THE BACK OF CURB OR TO THE FACE OF SIDEWALK UNLESS OTHERWISE NOTED.
 - ALL RADI ARE 5' UNLESS OTHERWISE NOTED.
 - PARKING STALLS MUST BE STRIPED WITH A 4 INCH CONTRASTING STRIPE (YELLOW ON CONCRETE AND YELLOW OR WHITE ON ASPHALT PARKING LOT).
 - HANDICAP PARKING SPACES ARE TO BE DESIGNATED BY BLUE STRIPING AND EITHER A BLUE SYMBOL ON A WHITE BACKGROUND OR A WHITE SYMBOL ON A BLUE BACKGROUND. ALL HANDICAP PARKING STALLS REQUIRE THE INSTALLATION OF THE PROPER SIGNAGE.
 - ALL PARKING SPACES ARE TO BE LAID OUT IN ACCORDANCE WITH THE SITE PLAN DIMENSIONS.
 - LAND USE CLASSIFICATION IS COMPACT MIXED USE.
 - PROPERTY OWNER WILL BE RESPONSIBLE FOR MAINTAINING THE PARKING AREAS, DRIVE AISLES AND ALL LANDSCAPE BUFFERING.
 - ALL MECHANICAL AREAS LOCATED ON, BESIDE OR ADJACENT TO ANY BUILDING SHALL BE SCREENED FROM VIEWS OF STREETS AND ADJACENT PROPERTY.
 - ALL WASTE MATERIAL SHALL BE DISPOSED OF OFF-SITE IN ACCORDANCE WITH STATE AND LOCAL LAWS AND REGULATIONS.
 - ALL SITE IMPROVEMENTS SHALL BE INSTALLED PER HARNETT COUNTY AND STATE REGULATIONS.

**HOURS OF OPERATION: 8 AM - 10 PM, 7 DAYS A WEEK

QTY.	TYPE	PLANTING SIZE	MIN. HEIGHT	SCIENTIFIC NAME
CANOPY TREES				
11	WILLOW OAK	2" CALIPER	6'	QUERCUS PHELLOS
4	YOSHINO CHERRY	2" CALIPER	6'	PRUNUS X YEDOENSIS
SHRUBS				
22	FLOWERING QUINCE	2 GAL.	18"	CHAENOMELES
56	LITTLELEAF BOXWOOD	2 GAL.	18"	BUXUS MICROPHYLLA

LANDSCAPING NOTES:



- HEIGHT AND SPREAD OF TREE SPECIMEN SHALL MEET REQUIREMENTS OF THE AMERICAN ASSOCIATION OF NURSERYMEN, AMERICAN STANDARD FOR NURSERY STOCK.
- EACH TREE SHALL BE PLANTED SUCH THAT THE ROOT FLARE IS VISIBLE AT THE TOP OF THE ROOT BALL. TREES WHERE THE ROOT FLARE IS NOT VISIBLE SHALL BE REJECTED. DO NOT COVER THE ROOT FLARE WITH MULCH.
- DO NOT PLACE MULCH IN CONTACT WITH THE TREE TRUNK. KEEP MULCH A MINIMUM OF 4 INCHES AWAY FROM THE TRUNK BASE.

*THIS LANDSCAPING PLAN IS THE MINIMUM REQUIRED TO MEET WITH THE HARNETT COUNTY UDO. THE OWNER OR DEVELOPER IS ENCOURAGED TO CONSULT WITH A LANDSCAPE ARCHITECT IN ORDER TO DEVELOP A PLAN THAT IS MORE IN DEPTH THAN THE MINIMUM REQUIREMENTS. THIS PLAN IS FOR PERMITTING PURPOSES ONLY.

EXISTING VEGETATION SHALL BE USED TO SATISFY THE STREET BUFFER REQUIREMENT ALONG THE FULL LENGTH OF NURSERY ROAD. THE EXISTING VEGETATION SHALL BE SUPPLEMENTED AS NEEDED TO SATISFY SECTION 9.1.8.E OF THE HARNETT COUNTY UDO.

EXISTING VEGETATION SHALL BE USED TO SATISFY THE TYPE A AND D BUFFER REQUIREMENTS. EXISTING VEGETATION SHALL BE SUPPLEMENTED AS NEEDED TO SATISFY SECTIONS 9.1.8.B AND 9.1.8.E OF THE HARNETT COUNTY UDO.


**ALL DRIVEWAYS AFFECTED BY THE WIDENING SHALL BE MODIFIED AS NEEDED FOR THE CONSTRUCTION. THE DRIVEWAY SHALL BE REPAIRED TO MATCH THE EXISTING MATERIAL. RELOCATE MAILBOXES, SIGNS, ETC AS NEEDED TO ACCOMMODATE THE WIDENING.

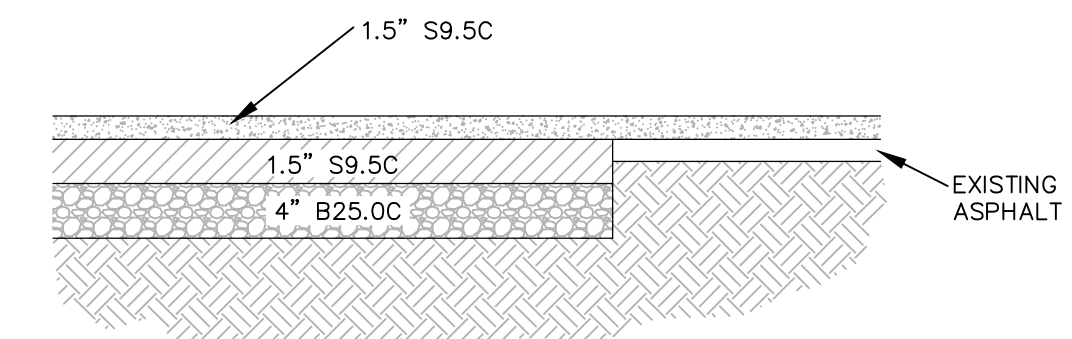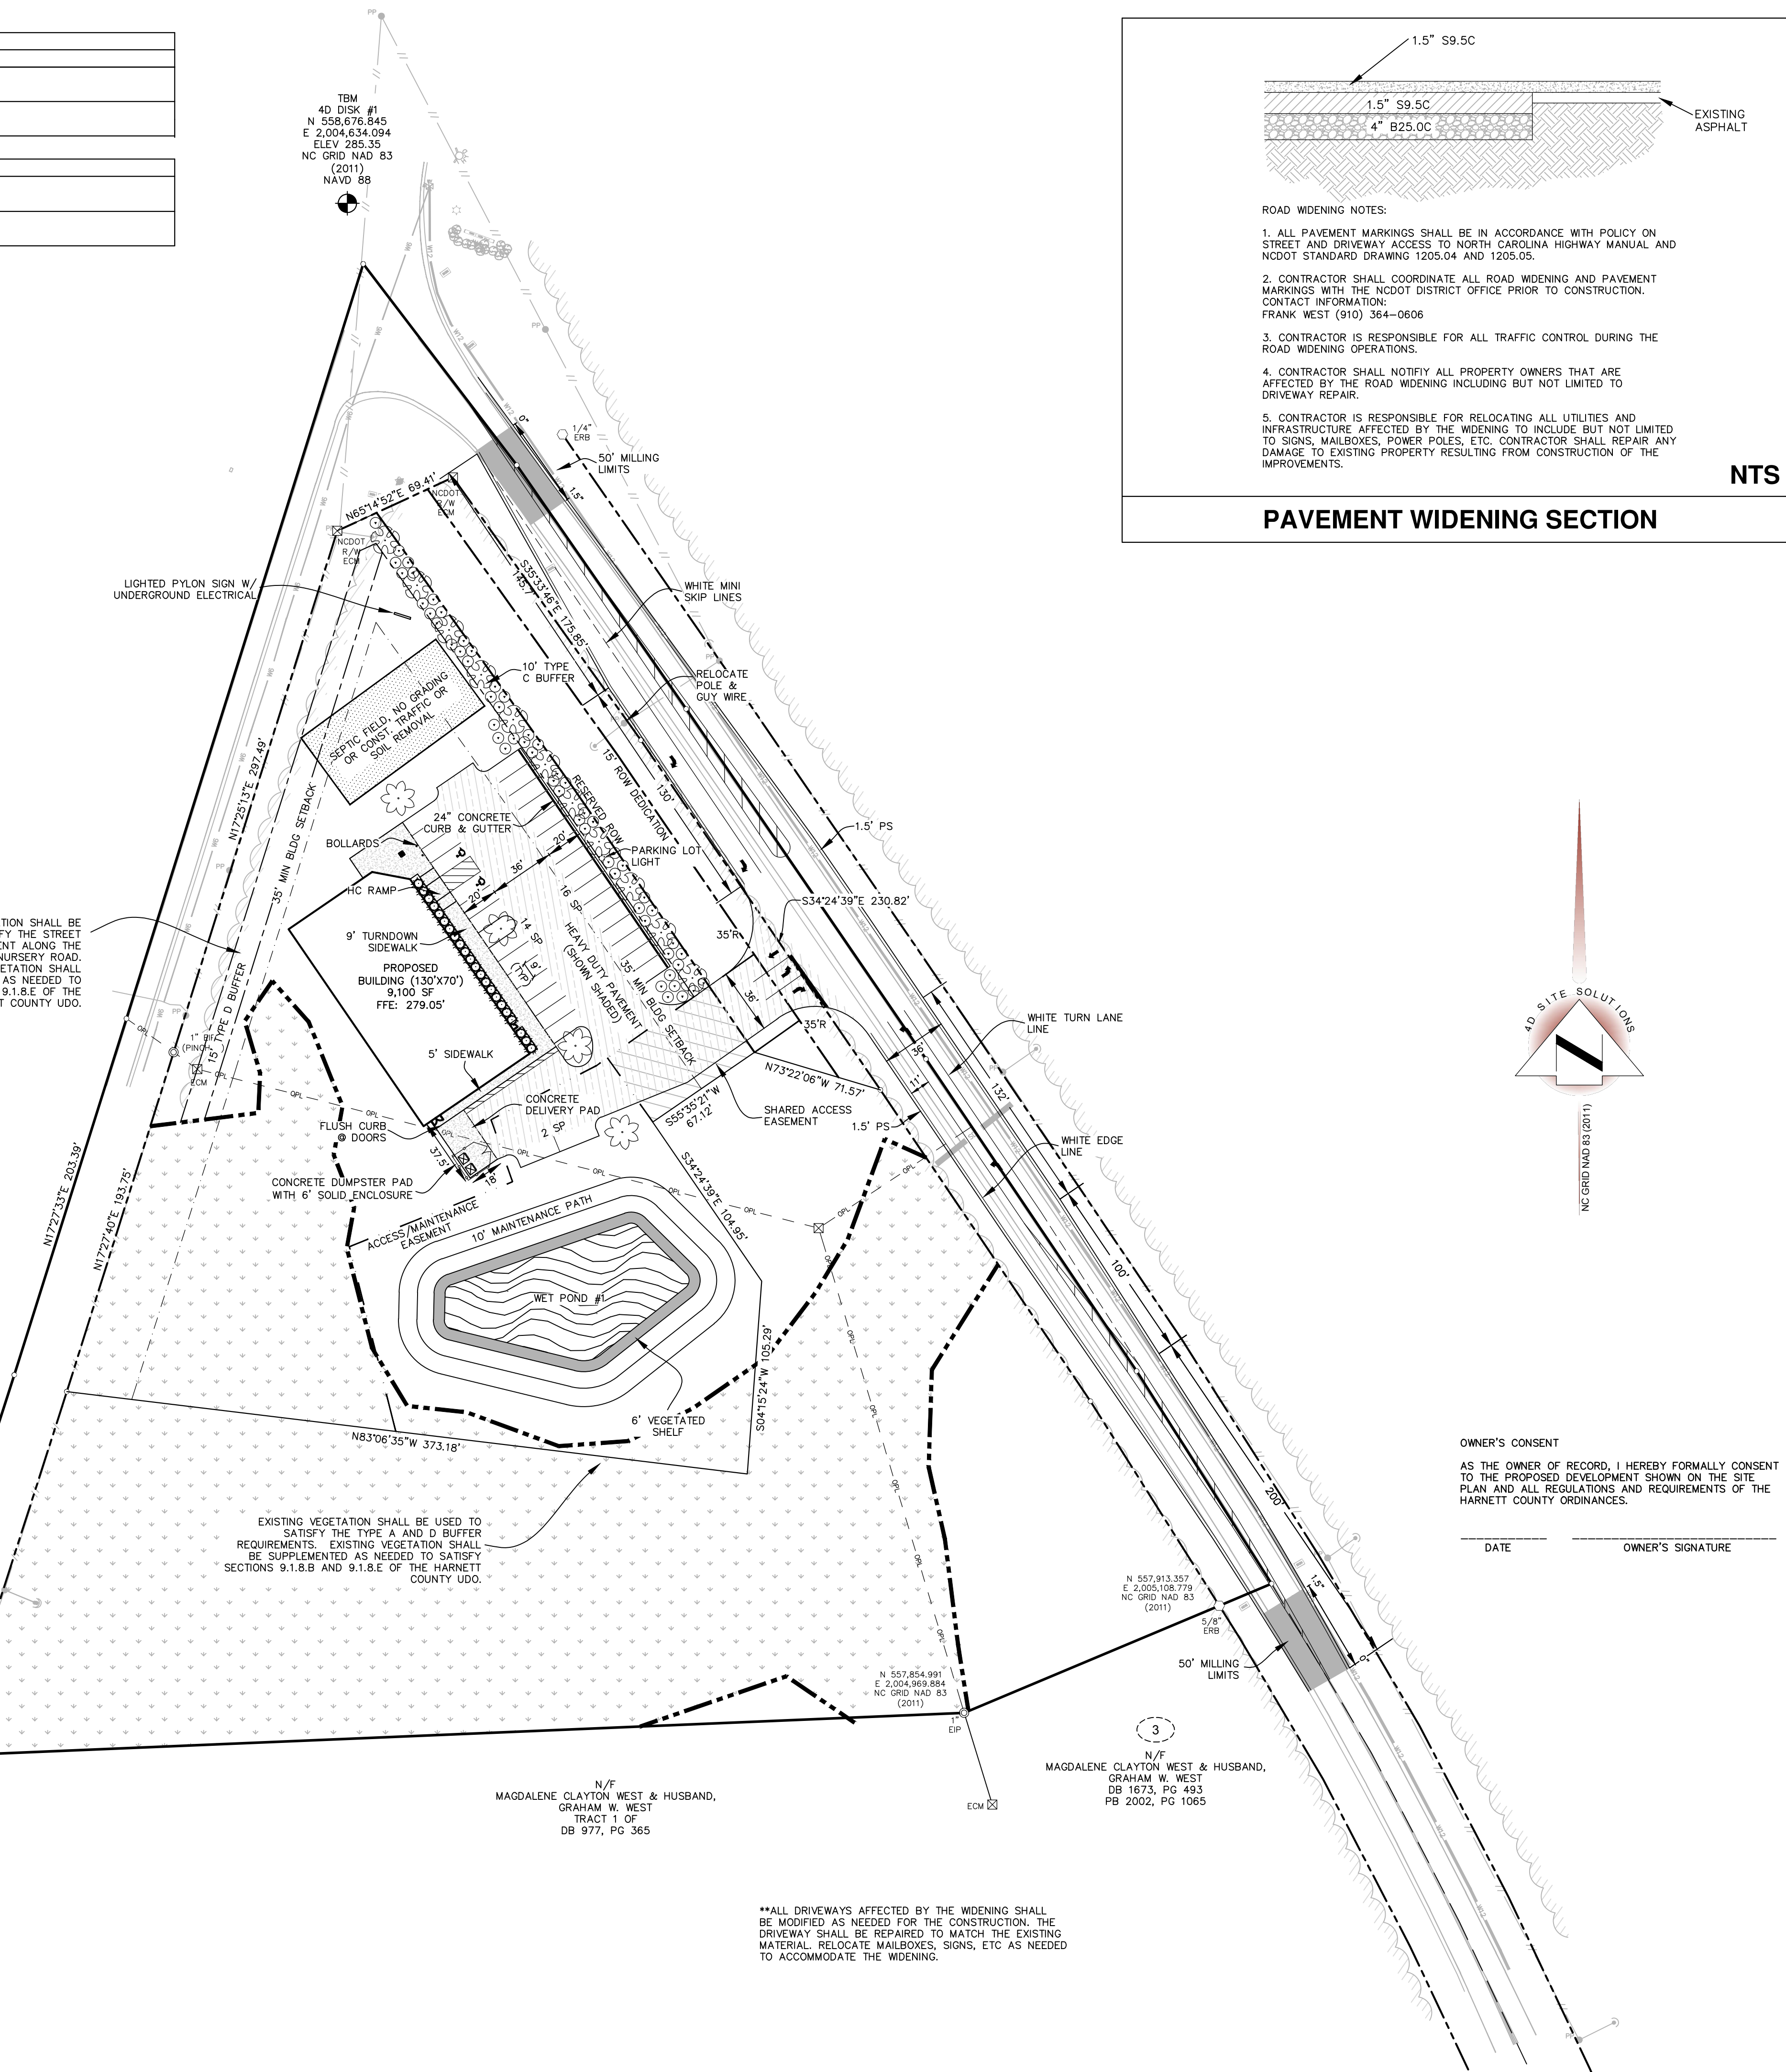

- ROAD WIDENING NOTES:
- ALL PAVEMENT MARKINGS SHALL BE IN ACCORDANCE WITH POLICY ON STREET AND DRIVEWAY ACCESS TO NORTH CAROLINA HIGHWAY MANUAL AND NCDOT STANDARD DRAWING 1205.04 AND 1205.05.
 - CONTRACTOR SHALL COORDINATE ALL ROAD WIDENING AND PAVEMENT MARKINGS WITH THE NCDOT DISTRICT OFFICE PRIOR TO CONSTRUCTION. CONTACT INFORMATION: FRANK WEST (910) 364-0606
 - CONTRACTOR IS RESPONSIBLE FOR ALL TRAFFIC CONTROL DURING THE ROAD WIDENING OPERATIONS.
 - CONTRACTOR SHALL NOTIFY ALL PROPERTY OWNERS THAT ARE AFFECTED BY THE ROAD WIDENING INCLUDING BUT NOT LIMITED TO DRIVEWAY REPAIR.
 - CONTRACTOR IS RESPONSIBLE FOR RELOCATING ALL UTILITIES AND INFRASTRUCTURE AFFECTED BY THE WIDENING TO INCLUDE BUT NOT LIMITED TO SIGNS, MAILBOXES, POWER POLES, ETC. CONTRACTOR SHALL REPAIR ANY DAMAGE TO EXISTING PROPERTY RESULTING FROM CONSTRUCTION OF THE IMPROVEMENTS.

NTS

PAVEMENT WIDENING SECTION

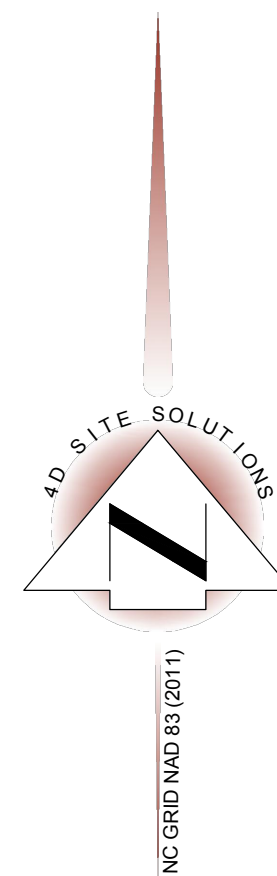

OWNER'S CONSENT
AS THE OWNER OF RECORD, I HEREBY FORMALLY CONSENT TO THE PROPOSED DEVELOPMENT SHOWN ON THE SITE PLAN AND ALL REGULATIONS AND REQUIREMENTS OF THE HARNETT COUNTY ORDINANCES.

DATE _____ OWNER'S SIGNATURE _____



REVISIONS

PROJECT NAME

**SPRING LAKE
RAY ROAD
DOLLAR
GENERAL**

SITE/LANDSCAPE
PLAN

CLIENT

**RHETSON
COMPANIES, INC**

2075 Juniper Lake Road
West End, North Carolina 27376
Phone: (910) 944-0881

PROJECT INFORMATION

DESIGNED BY:	SCOTT
DRAWN BY:	SCOTT
CHECKED BY:	CHRIS
PROJECT NUMBER:	1644

DRAWING SCALE

HORIZONTAL: 1"=50'


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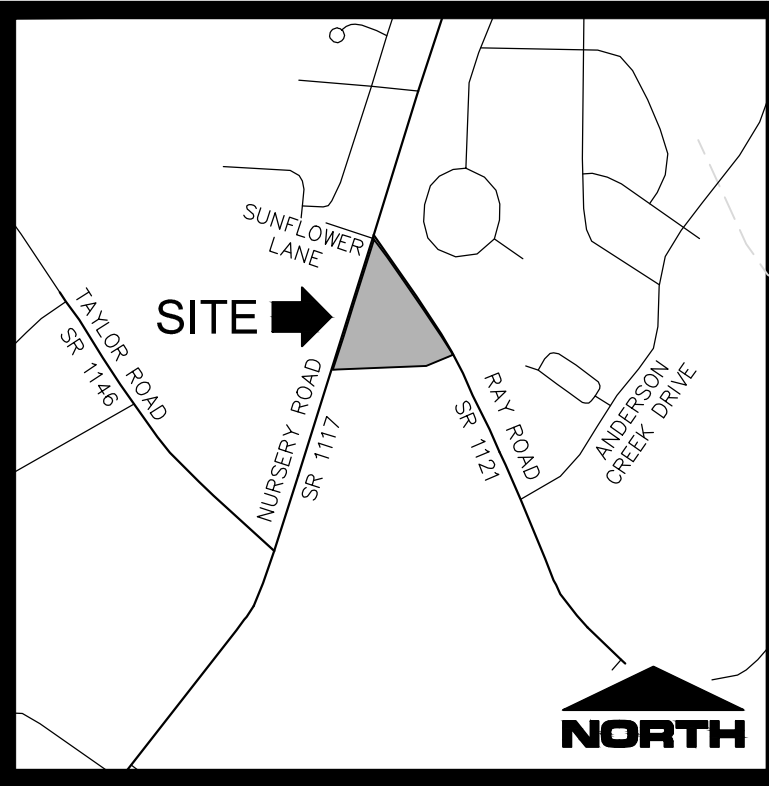
APRIL 22, 2021

SHEET NUMBER

C-2.0

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VICINITY MAP
NOT TO SCALE

- LEGEND:
- ECM - EXISTING CONCRETE MONUMENT
 - EIP - EXISTING IRON PIPE
 - EIR - EXISTING IRON ROD
 - EPK - EXISTING PK NAIL
 - SRB - SET REBAR
 - CP - COMPUTED POINT
 - N/F - NOW OR FORMERLY
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 - OLD PROPERTY LINE
 - ADJACENT PROPERTY LINE
 - RIGHT-OF-WAY
 - WATER LINE
 - OVERHEAD UTILITY
 - TREE LINE
 - 280 - MAJOR CONTOUR
 - 274 - MINOR CONTOUR
 - 263.94' SPOT ELEVATION
 - BENCHMARK
 - UTILITY POLE
 - WATER VALVE
 - FIRE HYDRANT
 - ASPHALT
 - BUILDING

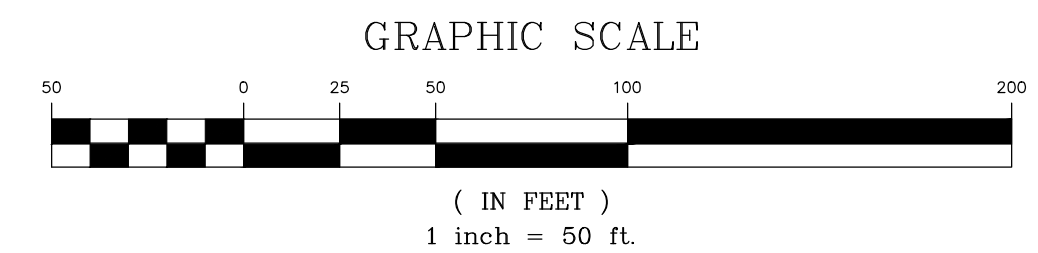EROSION CONTROL NOTES

- ALL INLET/OUTLET PROTECTION WILL BE CHECKED FOR MAINTENANCE AND FAILURE EACH ACTIVE DAY ON SITE. SEDIMENT WILL BE REMOVED FROM THE SEDIMENT TRAP AND INLET PROTECTION DEVICES WHEN THE STORAGE CAPACITY HAS BEEN APPROXIMATELY 50% FILLED. GRAVEL WILL BE CLEANED OR REPLACED WHEN THE SEDIMENT POOL BEHIND THE TRAP IS FULL. SEDIMENT WILL BE REMOVED FROM BEHIND THE SEDIMENT FENCE WHEN IT BECOMES ABOUT 0.5' DEEP AT THE FENCE. THE SEDIMENT FENCE WILL BE REPAIRED AS NEEDED TO MAINTAIN A PROPER BARRIER.
- TEMPORARY EROSION CONTROL FACILITIES AND/OR PERMANENT FACILITIES INTENDED TO CONTROL EROSION OF AND EARTH DISTURBANCE OPERATION SHALL BE INSTALLED BEFORE ANY EARTH DISTURBANCE OPERATIONS TAKE PLACE OR AT THE EARLIEST POSSIBLE POINT DURING CONSTRUCTION.
- TEMPORARY & PERMANENT EROSION CONTROL MEASURES SHALL BE CONSTRUCTED PER THE DETAILS HEREIN, OR SHALL BE CONSTRUCTED IN ACCORDANCE WITH THE NORTH CAROLINA EROSION AND SEDIMENT CONTROL PLANNING AND DESIGN MANUAL.
- THE CONTRACTOR MUST NOTIFY THE APPROPRIATE NCEQ OFFICE A MINIMUM OF 48 HOURS PRIOR TO BEGINNING ANY LAND DISTURBING ACTIVITIES. 910-433-3300
- REMOVE ALL SOILS AND SEDIMENTS TRACKED OR OTHERWISE DEPOSITED ONTO PUBLIC AND PRIVATE PAYMENT AREAS. REMOVAL SHALL BE ON A DAILY BASIS WHEN TRACKING OCCURS.
- LOCATE SOIL STOCKPILES NO LESS THAN TWENTY-FIVE (25) FEET FROM ANY PUBLIC OR PRIVATE ROADWAY OR DRAINAGE CHANNEL. IF REMAINING FOR MORE THAN SEVEN DAYS, STABILIZE THE STOCKPILES BY VEGETATIVE COVER, TARPS, OR OTHER MEANS. CONTROL EROSION FROM ALL STOCKPILES BY PLACING SILT BARRIERS AROUND THE PILES. TEMPORARY STOCKPILES LOCATED ON PAVED SURFACES MUST BE NO LESS THAN FIVE FEET FROM THE DRAINAGE/OUTLET LINE AND SHALL BE COVERED IF LEFT MORE THAN 24 HOURS.
- MAINTAIN ALL TEMPORARY EROSION AND SEDIMENT CONTROL DEVICES IN PLACE UNTIL THE CONTRIBUTING DRAINAGE AREA HAS BEEN STABILIZED. INSPECT TEMPORARY EROSION AND SEDIMENT CONTROL DEVICES ON A DAILY BASIS AND REPLACE DETERIORATED, DAMAGED, OR ROTTEN EROSION CONTROL DEVICES IMMEDIATELY.
- TEMPORARILY OR PERMANENTLY STABILIZE ALL DENuded AREAS WHICH HAVE BEEN FINISH GRADED, AND ALL DENuded AREAS IN WHICH GRADING OR SITE BUILDING CONSTRUCTION OPERATIONS ARE NOT ACTIVELY UNDERWAY AGAINST EROSION DUE TO RAIN, WIND AND RUNNING WATER WITHIN 14 DAYS. USE SEEDING AND MULCHING, EROSION CONTROL MATTING, AND/OR SODDING AND STAKING IN GREEN SPACE AREAS AND OTHERWISE APPROPRIATE MEASURES. USE EARLY APPLICATION OF GRAVEL BASE ON AREAS TO BE PAVED.
- DO NOT REMOVE ANY EROSION AND SEDIMENT CONTROL DEVICES AFTER THE PROTECTED AREA HAS UNDERGONE FINAL STABILIZATION AND PERMANENT VEGETATION HAS BEEN ESTABLISHED. IT IS RECOMMENDED THAT NCEQ APPROVE THE ACTION PRIOR TO REMOVAL.
- THE CONSTRUCTION ENTRANCE SHALL BE INSTALLED CONCURRENTLY WITH THE INITIATION OF CONSTRUCTION ACTIVITY.
- THE INSTALLATION OF EROSION CONTROL MEASURES SHALL TAKE PRECEDENCE OVER ALL OTHER CONSTRUCTION ACTIVITIES.
- THE PERMITTEE SHALL BE HELD RESPONSIBLE FOR THE ACTIONS AND PERFORMANCE OF ANY OTHER PARTIES PERFORMING WORK ON THIS PROJECT.
- ALL EROSION AND SEDIMENT CONTROL PRACTICES WILL BE CHECKED FOR STABILITY AND OPERATION FOLLOWING EVERY RUNOFF-PRODUCING RAINFALL BUT IN NO CASE LESS THAN ONCE EVERY WEEK. ANY NEEDED REPAIRS WILL BE MADE IMMEDIATELY TO MAINTAIN ALL PRACTICES AS DESIGNED.
- PURSUANT TO G.S. 113A-57(2), THE ANGLE FOR GRADED SLOPES AND FILLS SHALL BE NO GREATER THAN THE ANGLE THAT CAN BE RETAINED BY VEGETATIVE COVER OR OTHER ADEQUATE EROSION CONTROL DEVICES OR STRUCTURES. IN ANY EVENT, SLOPES LEFT EXPOSED WILL WITHIN 7 OR 14 CALENDAR DAYS OF COMPLETION OF ANY PHASE OF GRADING, BE PLANTED OR OTHERWISE PROVIDED WITH TEMPORARY OR PERMANENT GROUND COVER, DEVICES OR STRUCTURES SUFFICIENT TO RESTRAIN EROSION. PURSUANT TO G.S. 113A-57(3), PROVISIONS FOR PERMANENT GROUND COVER SUFFICIENT TO RETAIN EROSION MUST BE ACCOMPLISHED FOR ALL DISTURBED AREAS WITHIN 14 WORKING DAYS OR 90 CALENDAR DAYS (WHICHEVER IS SHORTER) FOLLOWING COMPLETION OF CONSTRUCTION DEVELOPMENT.
- CONTRACTOR IS RESPONSIBLE FOR INSTALLING ALL EROSION CONTROL MEASURES SHOWN AND ANY ADDITIONAL MEASURES REQUIRED TO CONTROL THE SEDIMENT DURING THE COURSE OF CONSTRUCTION.
- ALL SEEDED AREAS WILL BE FERTILIZED, RESEED AS NECESSARY, AND MULCHED ACCORDING TO THE DETAILS HEREIN.
- THE CONTACT PERSON FOR EROSION CONTROL ISSUES THAT ARISE ON SITE IS JOHN PARKER. CONTACT 910-944-0881.

GRADING NOTES

- ALL SPOT ELEVATIONS ARE TO THE FINISHED GRADE OR EDGE OF PAVEMENT, UNLESS OTHERWISE NOTED.
- ALL SIDEWALKS AND PEDESTRIAN WALKING SURFACES SHALL HAVE A CROSS SLOPE NO STEEPER THAN 2% AND LONGITUDINAL SLOPE NO STEEPER THAN 5%.
- THE CONTRACTOR SHALL ASSUME RESPONSIBILITY FOR ALL LAND DISTURBING ACTIVITIES AND ENSURE COMPLIANCE WITH THE APPROVED EROSION AND SEDIMENTATION CONTROL PLAN. THE CONTRACTOR SHALL INSPECT AND MAINTAIN ALL EROSION CONTROL DEVICES AND CLEAR ANY DEBRIS LEAVING THE SITE ON NEIGHBORING ROADS.
- EXISTING GROUND UPON WHICH FILL OR BASE IS TO BE PLACED SHALL BE CLEARED OF WEEDS, DEBRIS, TOPSOIL, AND ALL OTHER DELETERIOUS MATERIALS; NO FILL SHALL BE PLACED UNTIL PREPARATION OF THE EXISTING GROUND HAS BEEN COMPLETED.
- PROTECTIVE MEASURES SHALL BE TAKEN BY THE CONTRACTOR AND THE OWNER TO PROTECT ADJACENT PROPERTY, THE PUBLIC AND UTILITIES DURING GRADING OPERATIONS. THE CONTRACTOR ASSUMES ALL LIABILITY FOR THE UNDERGROUND UTILITY PIPES, CONDUITS, OR STRUCTURES, WHETHER SHOWN OR NOT ON THE PLAN.
- IT SHALL BE THE CONTRACTOR'S RESPONSIBILITY TO VERIFY THE LOCATION OF ALL UTILITIES OR STRUCTURES ABOVE AND BELOW GROUND, SHOWN OR NOT SHOWN ON THESE PLANS. THEY WILL BE HELD RESPONSIBLE FOR ALL DAMAGE TO ANY UTILITIES OR STRUCTURES CAUSED BY HIS OPERATION.
- ALL CUT AND FILL SLOPES SHOULD BE INVESTIGATED BOTH DURING AND AFTER GRADING BY THE CONTRACTOR TO DETERMINE IF ANY SLOPE STABILITY PROBLEMS EXIST. IF IT IS DETERMINED THAT THERE IS A SLOPE STABILITY PROBLEM THE ENGINEER OF RECORD SHOULD BE NOTIFIED.
- STOCKPILE AREAS THAT WILL EXCEED 10' IN HEIGHT SHOULD BE GRADED WITH 3:1 SLOPES AND SURROUNDED BY SILT FENCE.
- APPROVED COPIES OF THE GRADING AND EROSION CONTROL PLANS SHALL BE ON THE PERMITTED SITE WHILE WORK IS IN PROGRESS.
- ALL EXISTING DRAINAGE COURSES THROUGH THIS SITE SHALL REMAIN IN A CONDITION SUCH THAT THEY CAN TRANSPORT THE NATURAL DRAINAGE UNTIL FACILITIES TO HANDLE THE STORM WATER ARE CONSTRUCTED. THE CONTRACTOR SHALL BE RESPONSIBLE FOR ANY DAMAGE DUE TO OBSTRUCTING NATURAL DRAINAGE PATTERNS.
- ANY DEVIATION FROM THE APPROVED GRADING PLAN SHOULD BE REPORTED TO THE ENGINEER OF RECORD PRIOR TO IMPLEMENTATION OF THE CHANGE.
- ALL SLOPES 3:1 OR STEEPER THAT EXTEND TEN FEET OR MORE SHALL BE LINED WITH NORTH AMERICAN GREEN S75 TEMPORARY EROSION CONTROL BLANKET OR EQUAL SUBSTITUTE.
- STORM PIPE DISTANCES SHOWN ARE TO THE CENTER OF THE BOX FOR ALL STRUCTURES UNLESS OTHERWISE NOTED.
- CONTRACTOR SHALL VERIFY LOCATIONS OF DOWNSPOUTS USING THE ARCHITECTURAL PLANS PRIOR TO CONSTRUCTION.

LIMITS OF CONSTRUCTION
3.6 AC

PERMANENT WET POND #1
WATER SURFACE: 271.05'
1' YR HIGH WATER: 272.34'
10' YR HIGH WATER: 273.33'
TOP OF POND: 274.65'
INVERT OF POND: 264.55'
EMERGENCY SPILLWAY: 273.75'

**AFTER SITE IS STABILIZED, CONVERT SEDIMENT BASIN TO PERMANENT WET POND AS SHOWN.

FOREBAY
INV AT END: 263.55'
INV AT SPILLWAY: 264.55'



GROUND STABILIZATION CHART

SITE AREA DESCRIPTION	STABILIZATION TIME FRAME	STABILIZATION TIME FRAME EXCEPTIONS
PERIMETER DIKES, SWALES, DITCHES AND SLOPES	7 DAYS	NONE
HIGH QUALITY WATER (HOW) ZONES	7 DAYS	NONE
SLOPES STEEPER THAN 3:1	7 DAYS	IF SLOPES ARE 10' OR LESS IN LENGTH AND ARE NOT STEEPER THAN 2:1, 14 DAYS ARE ALLOWED
SLOPES 3:1 OR FLATTER	14 DAYS	7-DAYS FOR SLOPES GREATER THAN 50 FEET IN LENGTH
ALL OTHER AREAS WITH SLOPES FLATTER THAN 4:1	14 DAYS	NONE (EXCEPT FOR PERIMETERS AND HOW ZONES)



Know what's below.
Call before you dig.

THE CONTRACTOR MUST CONTACT NORTH CAROLINA ONE CALL CENTER AT 1-800-632-4949 A MINIMUM OF 72 HOURS PRIOR TO DIGGING IN ORDER TO HAVE THE EXISTING UTILITIES LOCATED

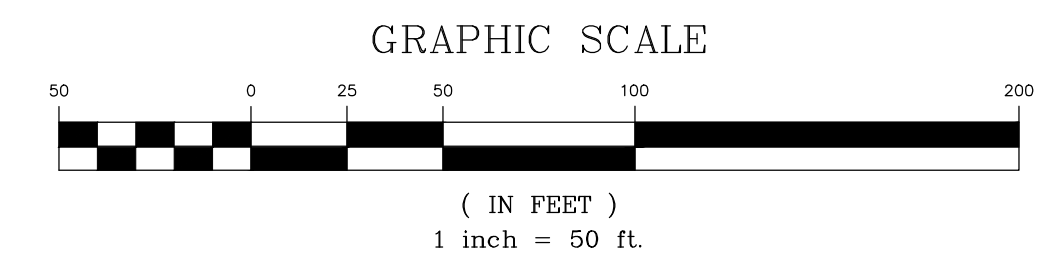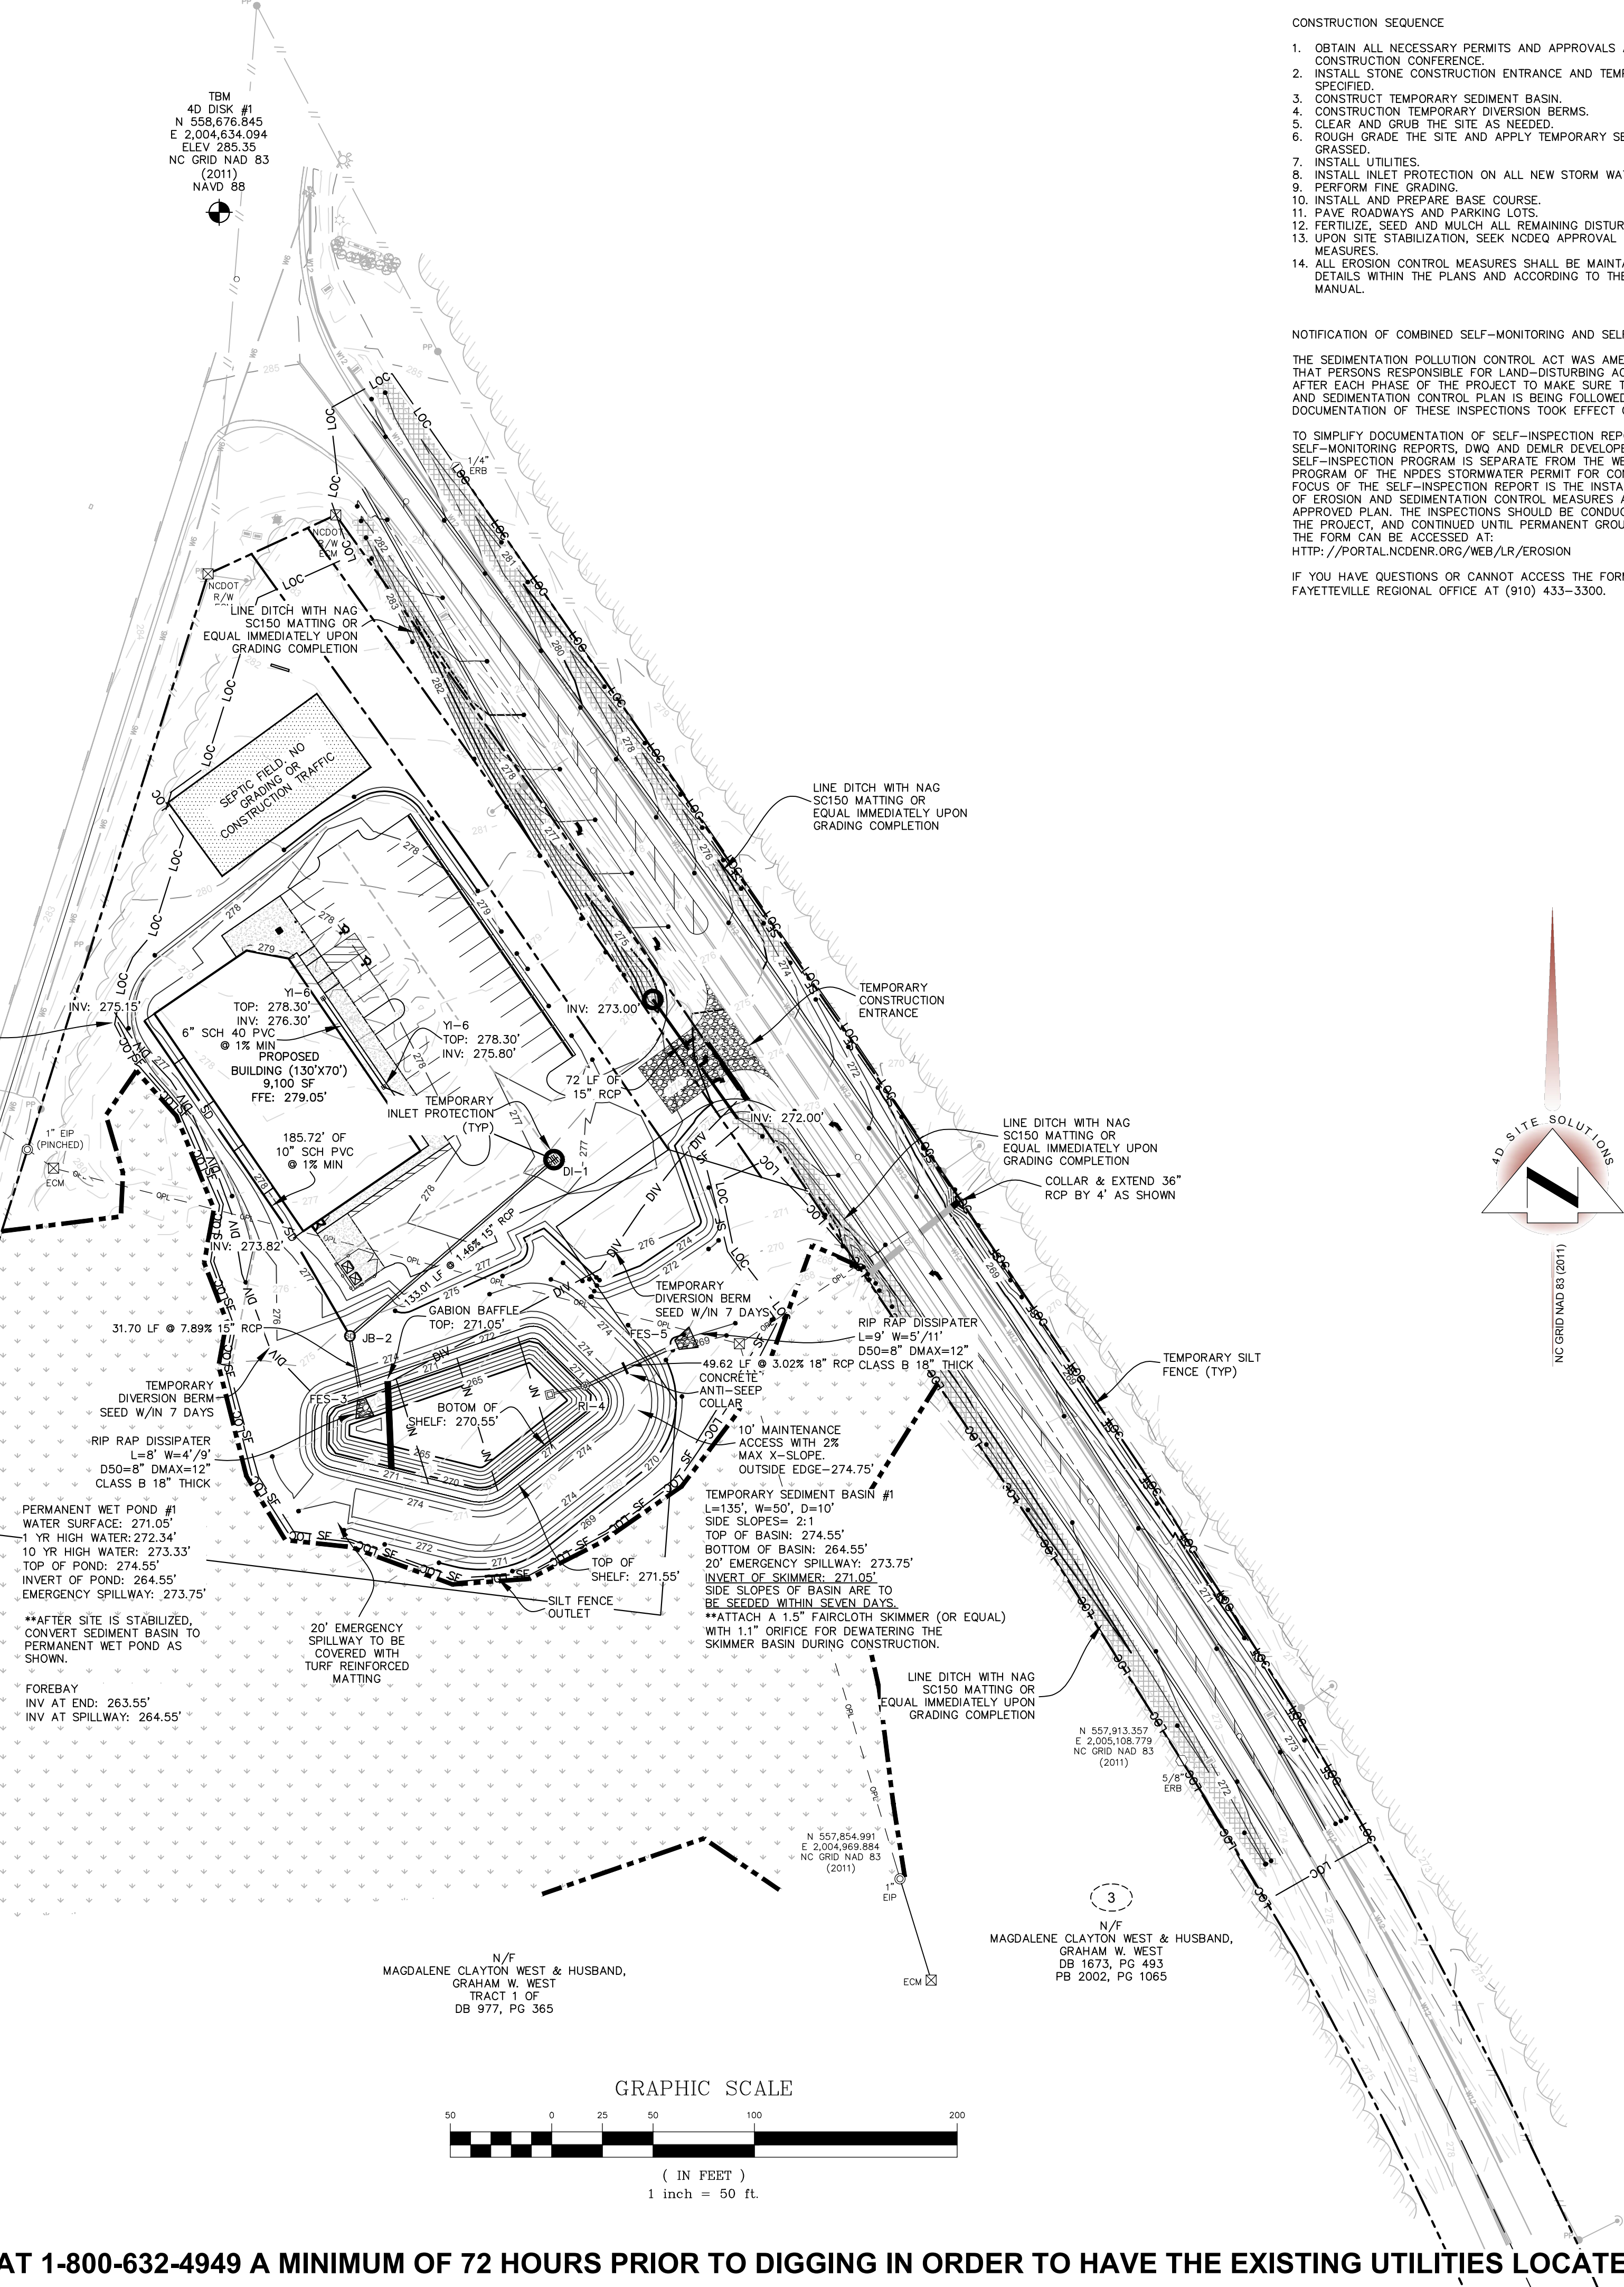

CONSTRUCTION SEQUENCE

- OBTAIN ALL NECESSARY PERMITS AND APPROVALS AND HOLD PRE CONSTRUCTION CONFERENCE.
- INSTALL STONE CONSTRUCTION ENTRANCE AND TEMPORARY SILT FENCE WHERE SPECIFIED.
- CONSTRUCT TEMPORARY SEDIMENT BASIN.
- CONSTRUCTION TEMPORARY DIVERSION BERMS.
- CLEAR AND GRUB THE SITE AS NEEDED.
- ROUGH GRADE THE SITE AND APPLY TEMPORARY SEEDING TO AREAS REMAIN GRASSED.
- INSTALL UTILITIES.
- INSTALL INLET PROTECTION ON ALL NEW STORM WATER INLETS.
- PERFORM FINE GRADING.
- INSTALL AND PREPARE BASE COURSE.
- PAVE ROADWAYS AND PARKING LOTS.
- FERTILIZE, SEED AND MULCH ALL REMAINING DISTURBED AREAS.
- UPON SITE STABILIZATION, SEEK NCEQ APPROVAL TO REMOVE ALL TEMPORARY MEASURES.
- ALL EROSION CONTROL MEASURES SHALL BE MAINTAINED AS OUTLINED IN THE DETAILS WITHIN THE PLANS AND ACCORDING TO THE NCEQ EROSION CONTROL MANUAL.

NOTIFICATION OF COMBINED SELF-MONITORING AND SELF-INSPECTION FORM:

THE SEDIMENTATION POLLUTION CONTROL ACT WAS AMENDED IN 2006 TO REQUIRE THAT PERSONS RESPONSIBLE FOR LAND-DISTURBING ACTIVITIES INSPECT A PROJECT AFTER EACH PHASE OF THE PROJECT TO MAKE SURE THAT THE APPROVED EROSION AND SEDIMENTATION CONTROL PLAN IS BEING FOLLOWED. RULES DETAILING THE DOCUMENTATION OF THESE INSPECTIONS TOOK EFFECT OCTOBER 1, 2010.

TO SIMPLIFY DOCUMENTATION OF SELF-INSPECTION REPORTS AND NPDES SELF-MONITORING REPORTS, DMO AND DEMAIR DEVELOPED A COMBINED FORM. THE SELF-INSPECTION PROGRAM IS SEPARATE FROM THE WEEKLY SELF-MONITORING PROGRAM OF THE NPDES STORMWATER PERMIT FOR CONSTRUCTION ACTIVITIES. THE FOCUS OF THE SELF-INSPECTION REPORT IS THE INSTALLATION AND MAINTENANCE OF EROSION AND SEDIMENTATION CONTROL MEASURES ACCORDING TO THE APPROVED PLAN. THE INSPECTIONS SHOULD BE CONDUCTED AFTER EACH PHASE OF THE PROJECT, AND CONTINUED UNTIL PERMANENT GROUND COVER IS ESTABLISHED. THE FORM CAN BE ACCESSED AT:
HTTP://PORTAL.NCDEMR.ORG/WEB/LR/EROSION

IF YOU HAVE QUESTIONS OR CANNOT ACCESS THE FORM, PLEASE CONTACT THE FAYETTEVILLE REGIONAL OFFICE AT (910) 433-3300.



REVISIONS

PROJECT NAME
**SPRING LAKE
RAY ROAD
DOLLAR
GENERAL**

GRADING AND
EROSION
CONTROL PLAN

CLIENT
**RHETSON
COMPANIES, INC**

PROJECT INFORMATION


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PROJECT NUMBER:	1644

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HORIZONTAL: 1"=50'

DATE RELEASED
APRIL 22, 2021



SHEET NUMBER
C-3.0

2075 Juniper Lake Road
West End, North Carolina 27376
Phone: (910) 944-0881

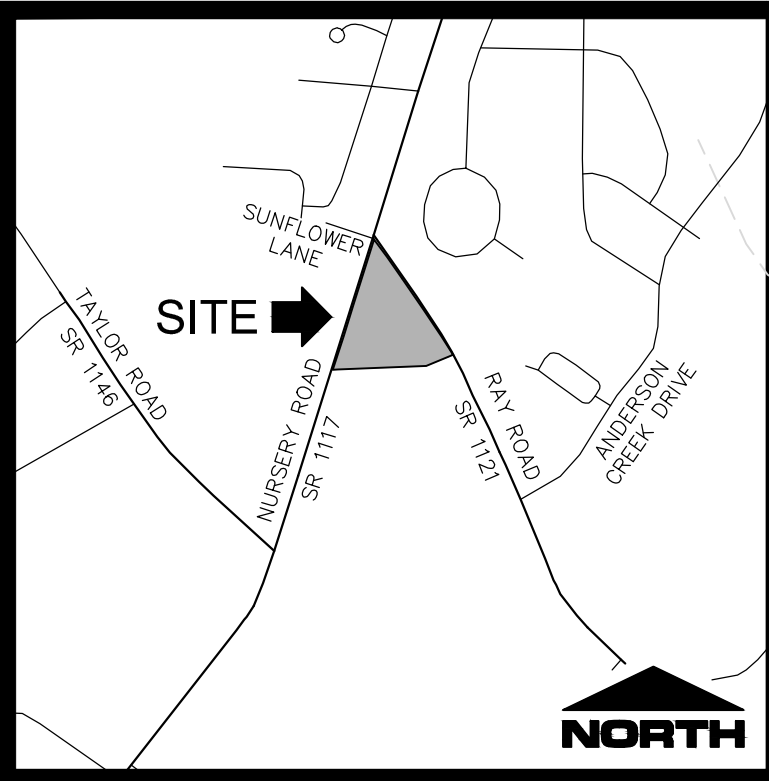

VICINITY MAP
NOT TO SCALE

- LEGEND:
- ECM - EXISTING CONCRETE MONUMENT
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 - EIR - EXISTING IRON ROD
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 - 274 - MINOR CONTOUR
 - SPOT ELEVATION
 - BENCHMARK
 - UTILITY POLE
 - WATER VALVE
 - FIRE HYDRANT
 - ASPHALT
 - BUILDING

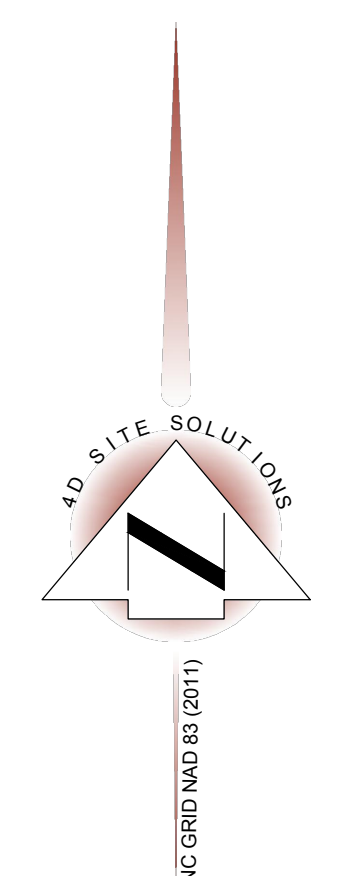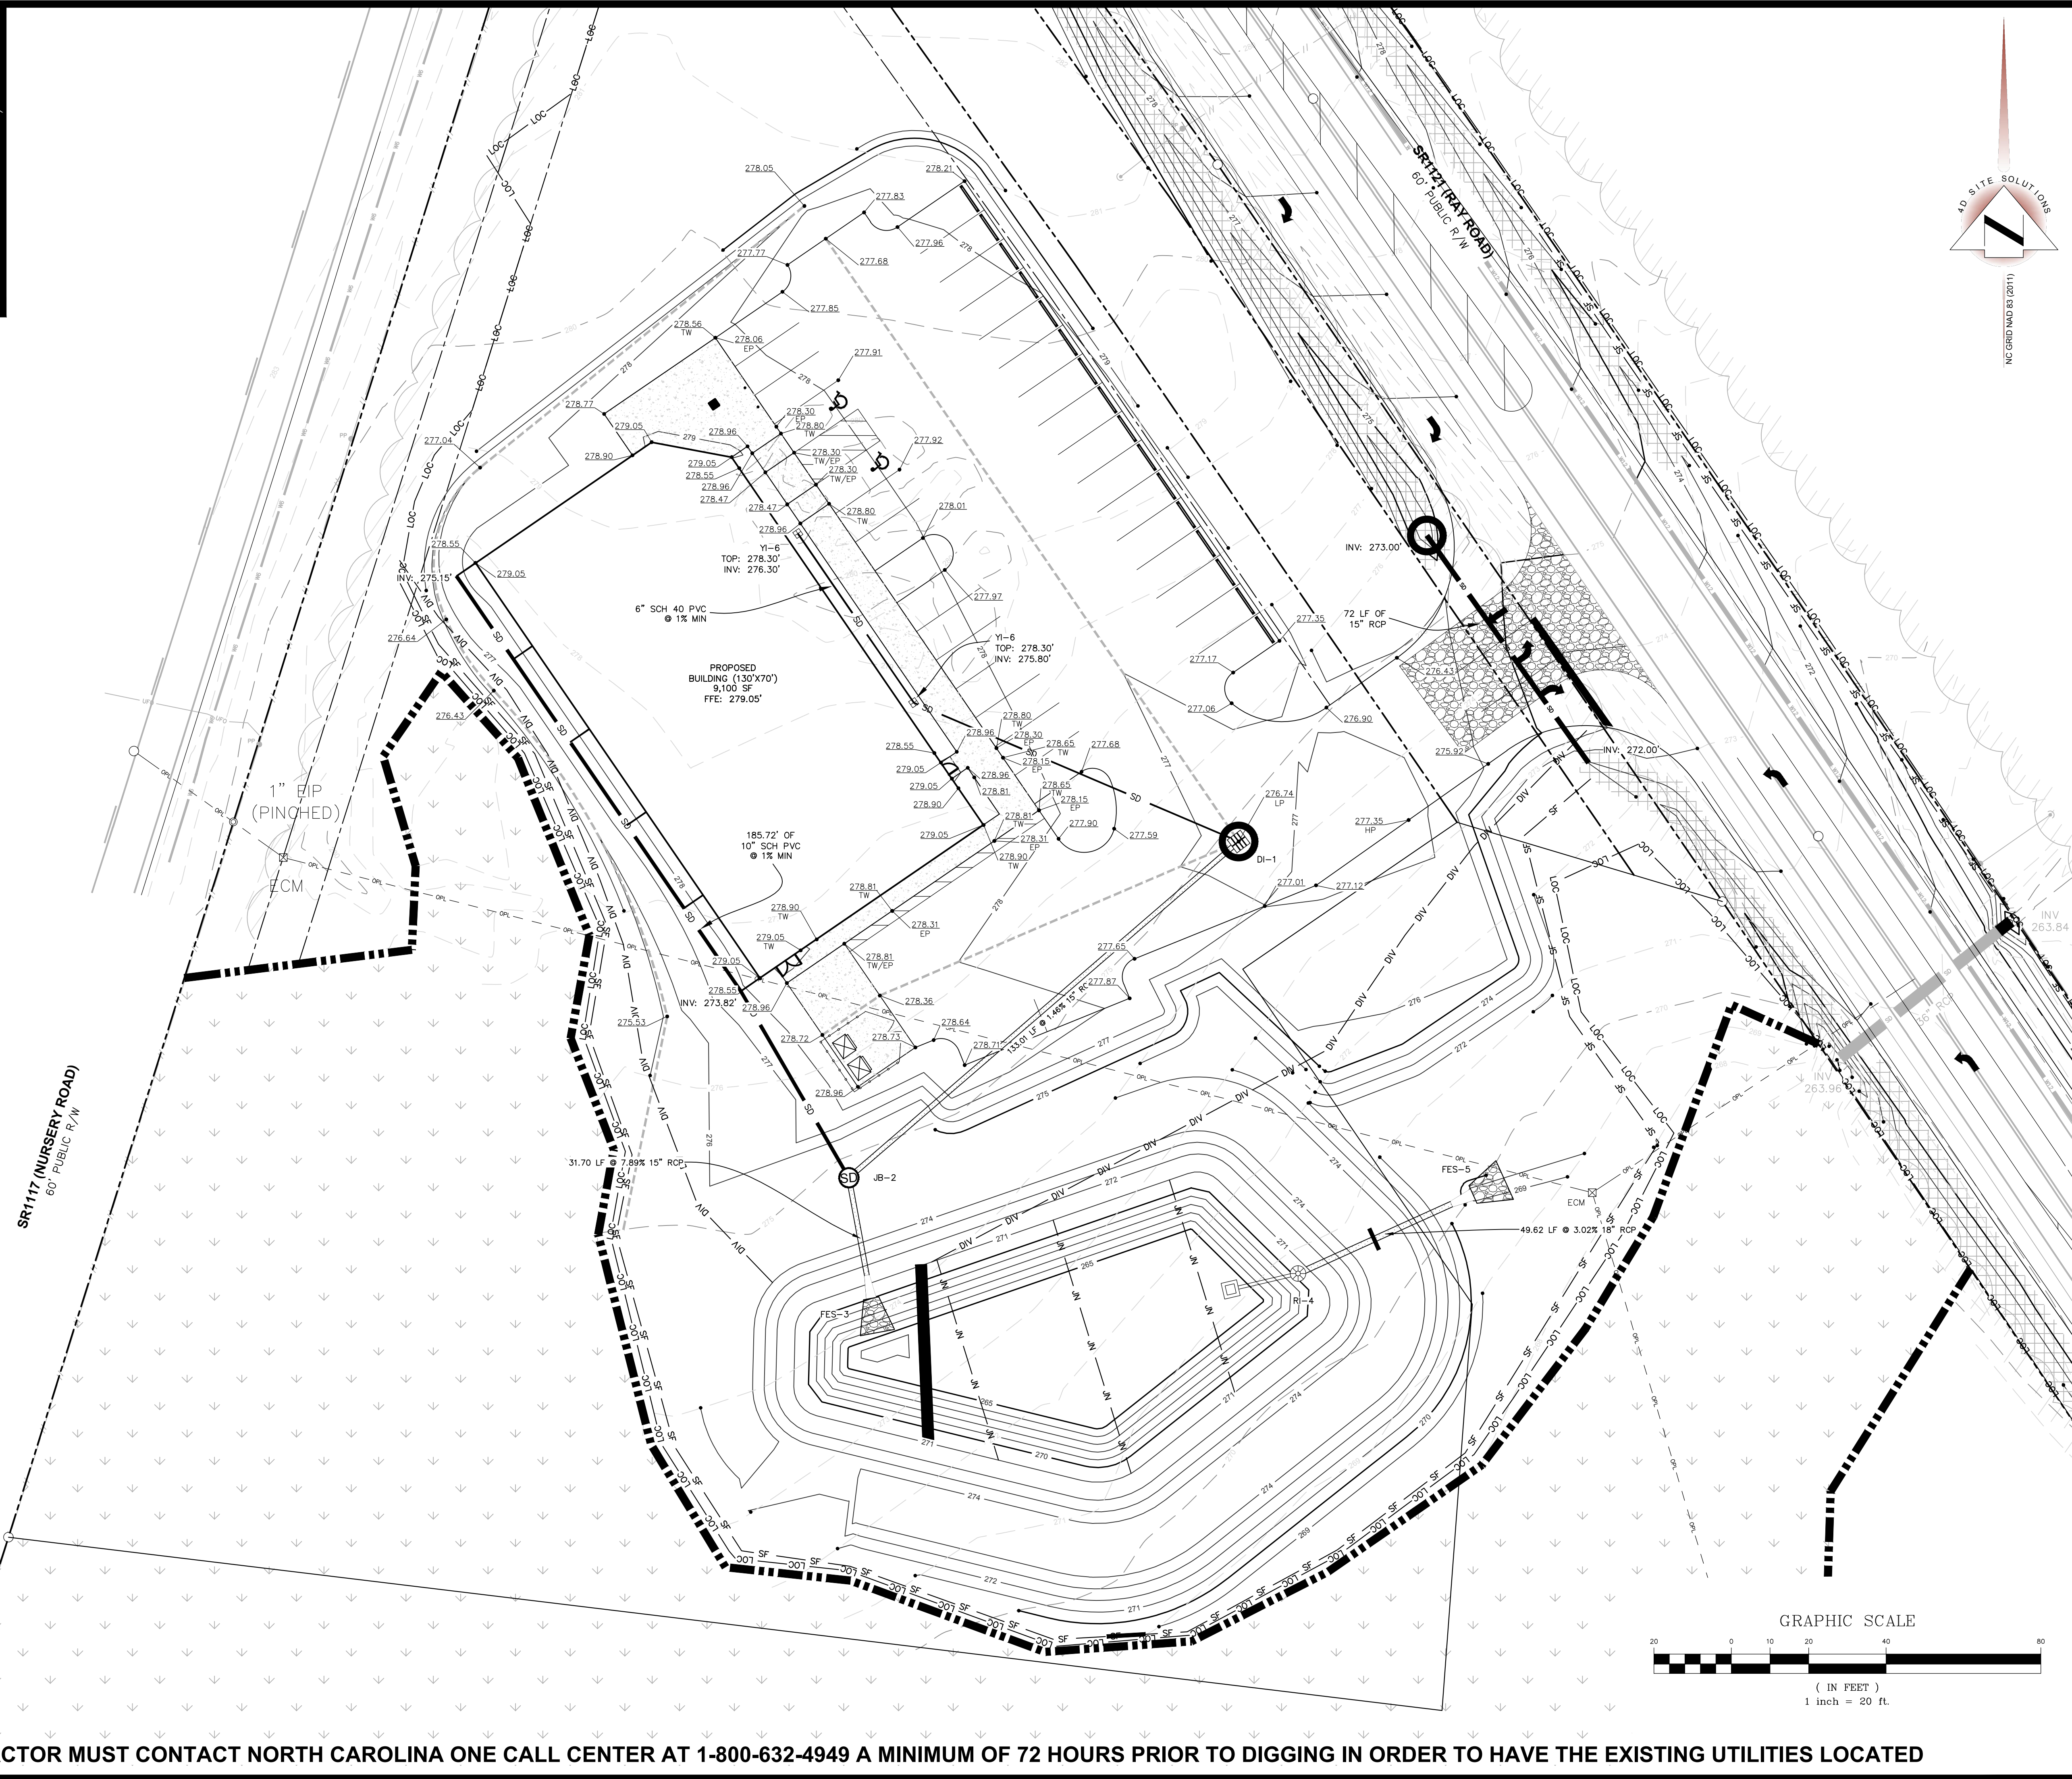

REVISIONS

PROJECT NAME

**SPRING LAKE
RAY ROAD
DOLLAR
GENERAL**

**DETAILED
GRADING PLAN**

CLIENT

**RHETSON
COMPANIES, INC**

2075 Juniper Lake Road
West End, North Carolina 27376
Phone: (910) 944-0881

PROJECT INFORMATION

DESIGNED BY:	SCOTT
DRAWN BY:	SCOTT
CHECKED BY:	CHRIS
PROJECT NUMBER:	1644

DRAWING SCALE


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DATE RELEASED

APRIL 22, 2021


SHEET NUMBER

C-3.1

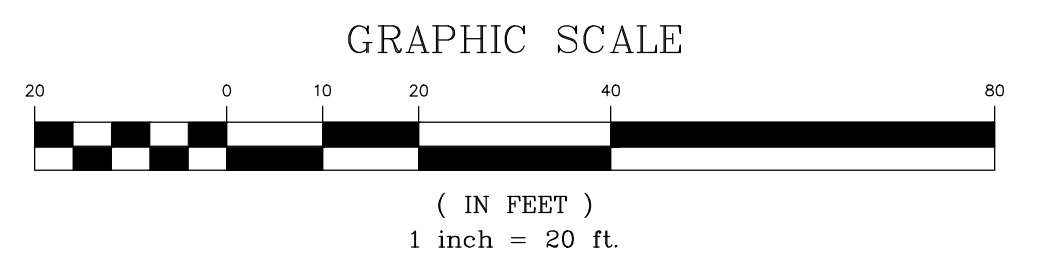


THE CONTRACTOR MUST CONTACT NORTH CAROLINA ONE CALL CENTER AT 1-800-632-4949 A MINIMUM OF 72 HOURS PRIOR TO DIGGING IN ORDER TO HAVE THE EXISTING UTILITIES LOCATED

P:\proj\2021\1644_SpringLakeRayRoad\1644_SpringLakeRayRoad.dwg, 05/04/2021 10:58:58 AM, C:\Users\scott\OneDrive\Documents\1644_SpringLakeRayRoad.dwg, 05/04/2021 10:58:58 AM

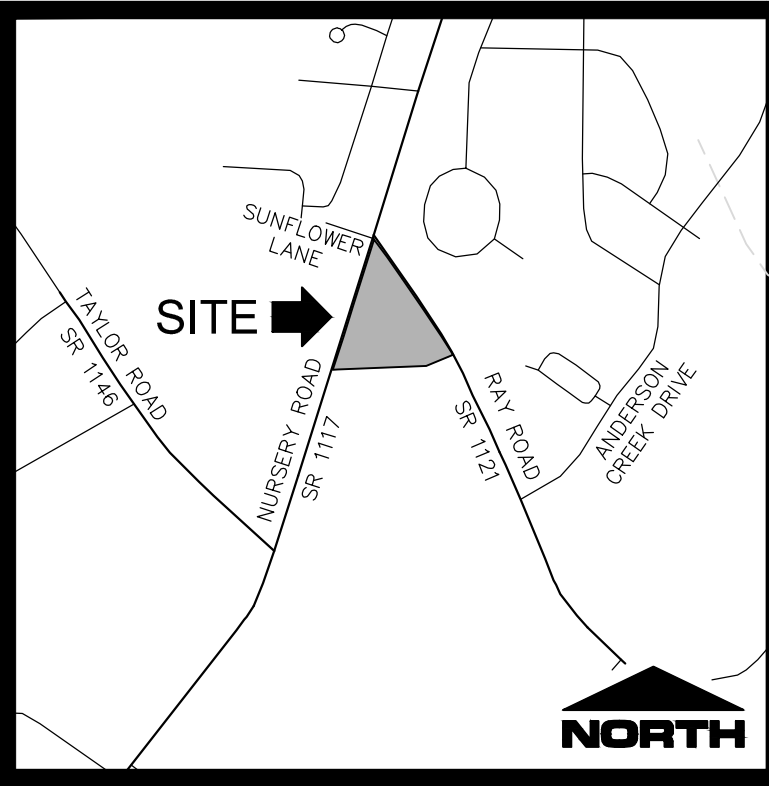

VICINITY MAP
NOT TO SCALE



- LEGEND:
- ECM - EXISTING CONCRETE MONUMENT
 - EIP - EXISTING IRON PIPE
 - EIR - EXISTING IRON ROD
 - EPK - EXISTING PK NAIL
 - SRB - SET REBAR
 - CP - COMPUTED POINT
 - N/F - NOW OR FORMERLY
 - R/W - RIGHT OF WAY
 - RCP - REINFORCED CONCRETE PIPE
 - PROPERTY LINE
 - OLD PROPERTY LINE
 - ADJACENT PROPERTY LINE
 - RIGHT-OF-WAY
 - WATER LINE
 - OVERHEAD UTILITY
 - TREE LINE
 - 280 - MAJOR CONTOUR
 - 274 - MINOR CONTOUR
 - SPOT ELEVATION
 - BENCHMARK
 - UTILITY POLE
 - WATER VALVE
 - FIRE HYDRANT
 - ASPHALT
 - BUILDING

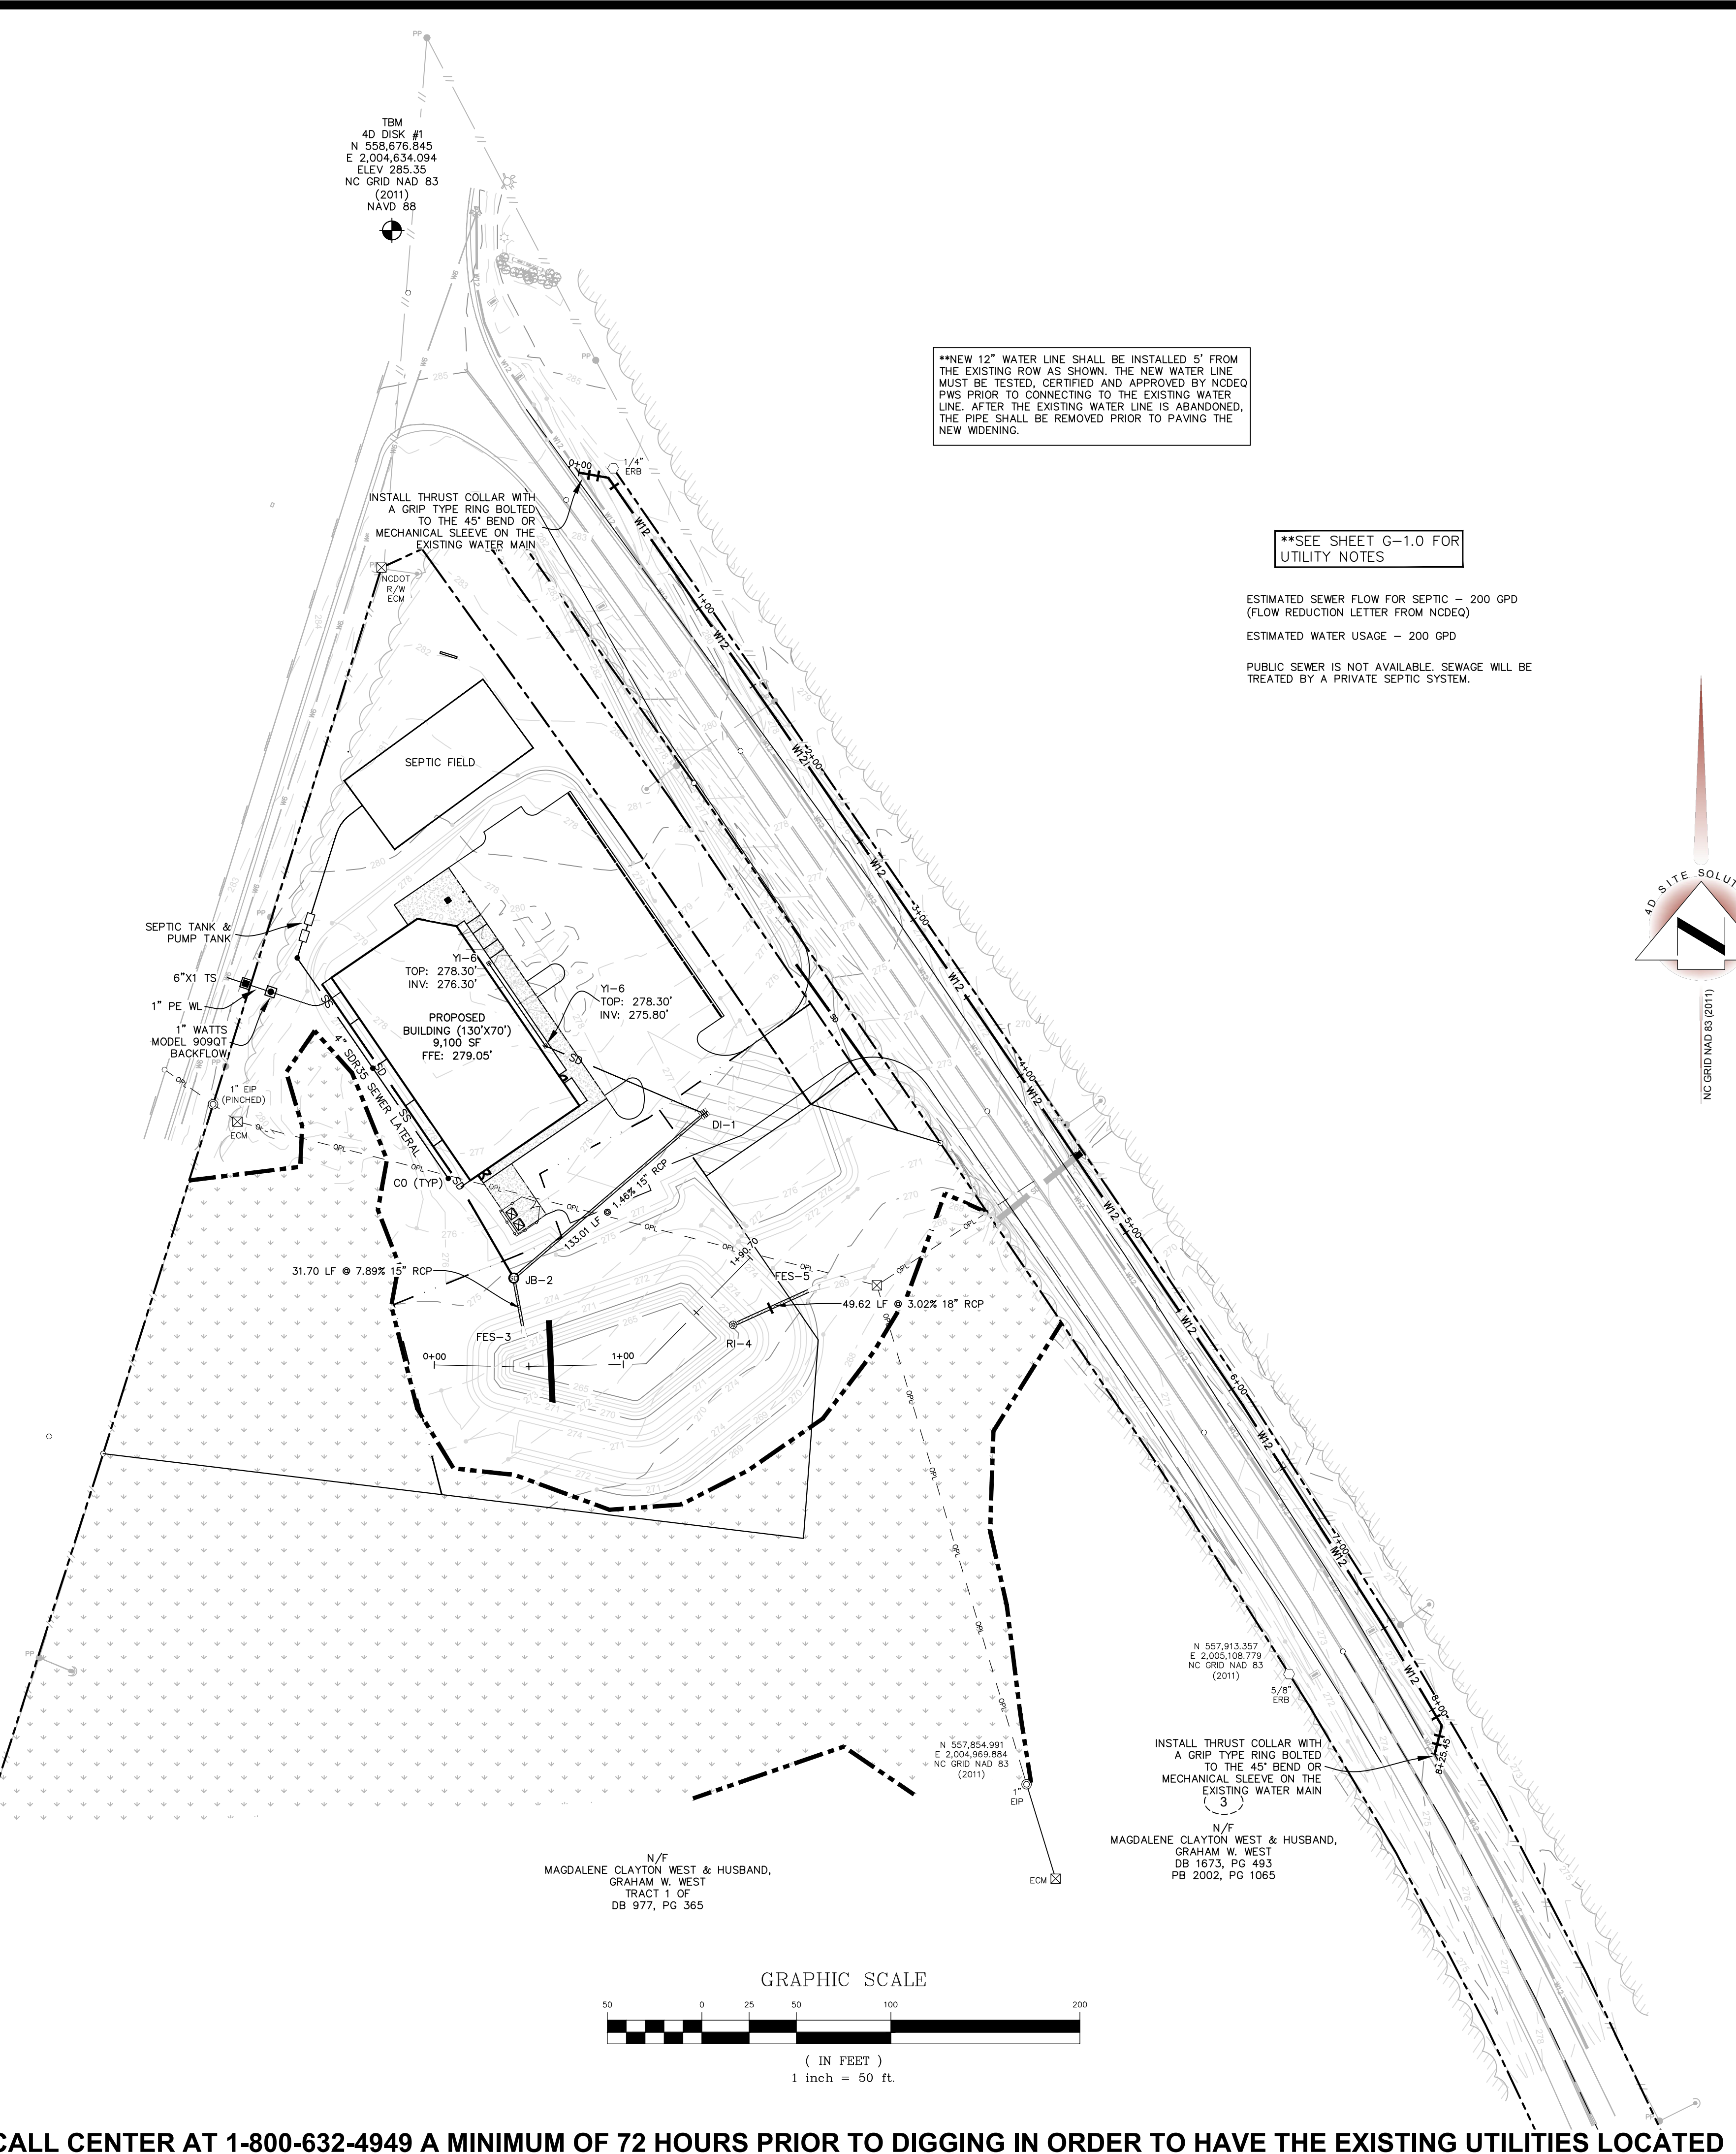

**NEW 12" WATER LINE SHALL BE INSTALLED 5' FROM THE EXISTING ROW AS SHOWN. THE NEW WATER LINE MUST BE TESTED, CERTIFIED AND APPROVED BY NCDCEQ PWS PRIOR TO CONNECTING TO THE EXISTING WATER LINE. AFTER THE EXISTING WATER LINE IS ABANDONED, THE PIPE SHALL BE REMOVED PRIOR TO PAVING THE NEW WIDENING.

**SEE SHEET G-1.0 FOR UTILITY NOTES

ESTIMATED SEWER FLOW FOR SEPTIC - 200 GPD
(FLOW REDUCTION LETTER FROM NCDCEQ)
ESTIMATED WATER USAGE - 200 GPD
PUBLIC SEWER IS NOT AVAILABLE. SEWAGE WILL BE TREATED BY A PRIVATE SEPTIC SYSTEM.

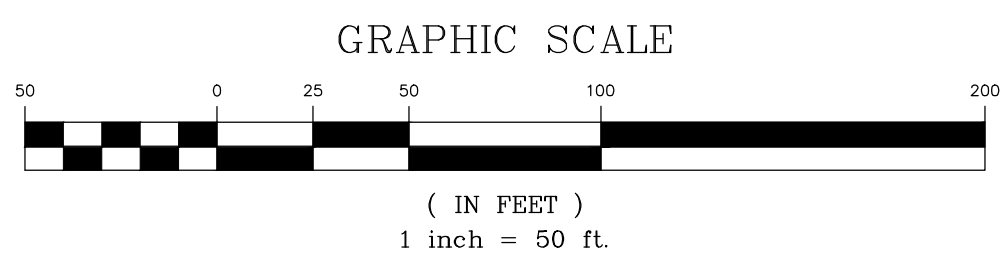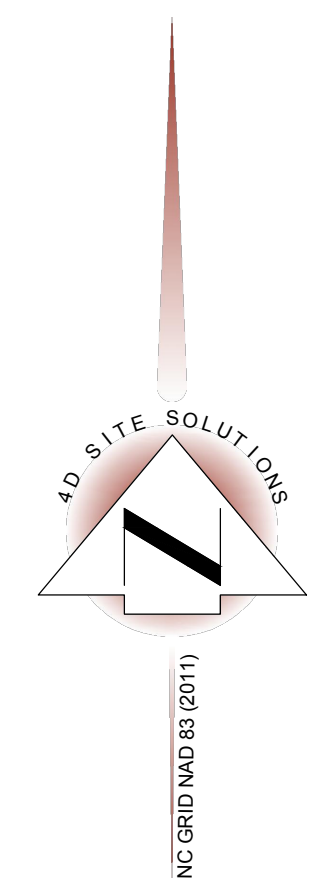

THE CONTRACTOR MUST CONTACT NORTH CAROLINA ONE CALL CENTER AT 1-800-632-4949 A MINIMUM OF 72 HOURS PRIOR TO DIGGING IN ORDER TO HAVE THE EXISTING UTILITIES LOCATED



REVISIONS

PROJECT NAME

**SPRING LAKE
RAY ROAD
DOLLAR
GENERAL**

UTILITY PLAN

CLIENT

**RHETSON
COMPANIES, INC**

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Phone: (910) 944-0881

PROJECT INFORMATION

DESIGNED BY:	SCOTT
DRAWN BY:	CHRIS
CHECKED BY:	CHRIS
PROJECT NUMBER:	1644

DRAWING SCALE

HORIZONTAL: 1"=50'

DATE RELEASED

APRIL 22, 2021

SHEET NUMBER

C-4.0



REVISIONS

PROJECT NAME

**SPRING LAKE
 RAY ROAD
 DOLLAR
 GENERAL**

**STORM
 PROFILES**

CLIENT

**RHETSON
 COMPANIES, INC**

2075 Juniper Lake Road
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 Phone: (910) 944-0881

PROJECT INFORMATION

DESIGNED BY:	SCOTT
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CHECKED BY:	CHRIS
PROJECT NUMBER:	1644

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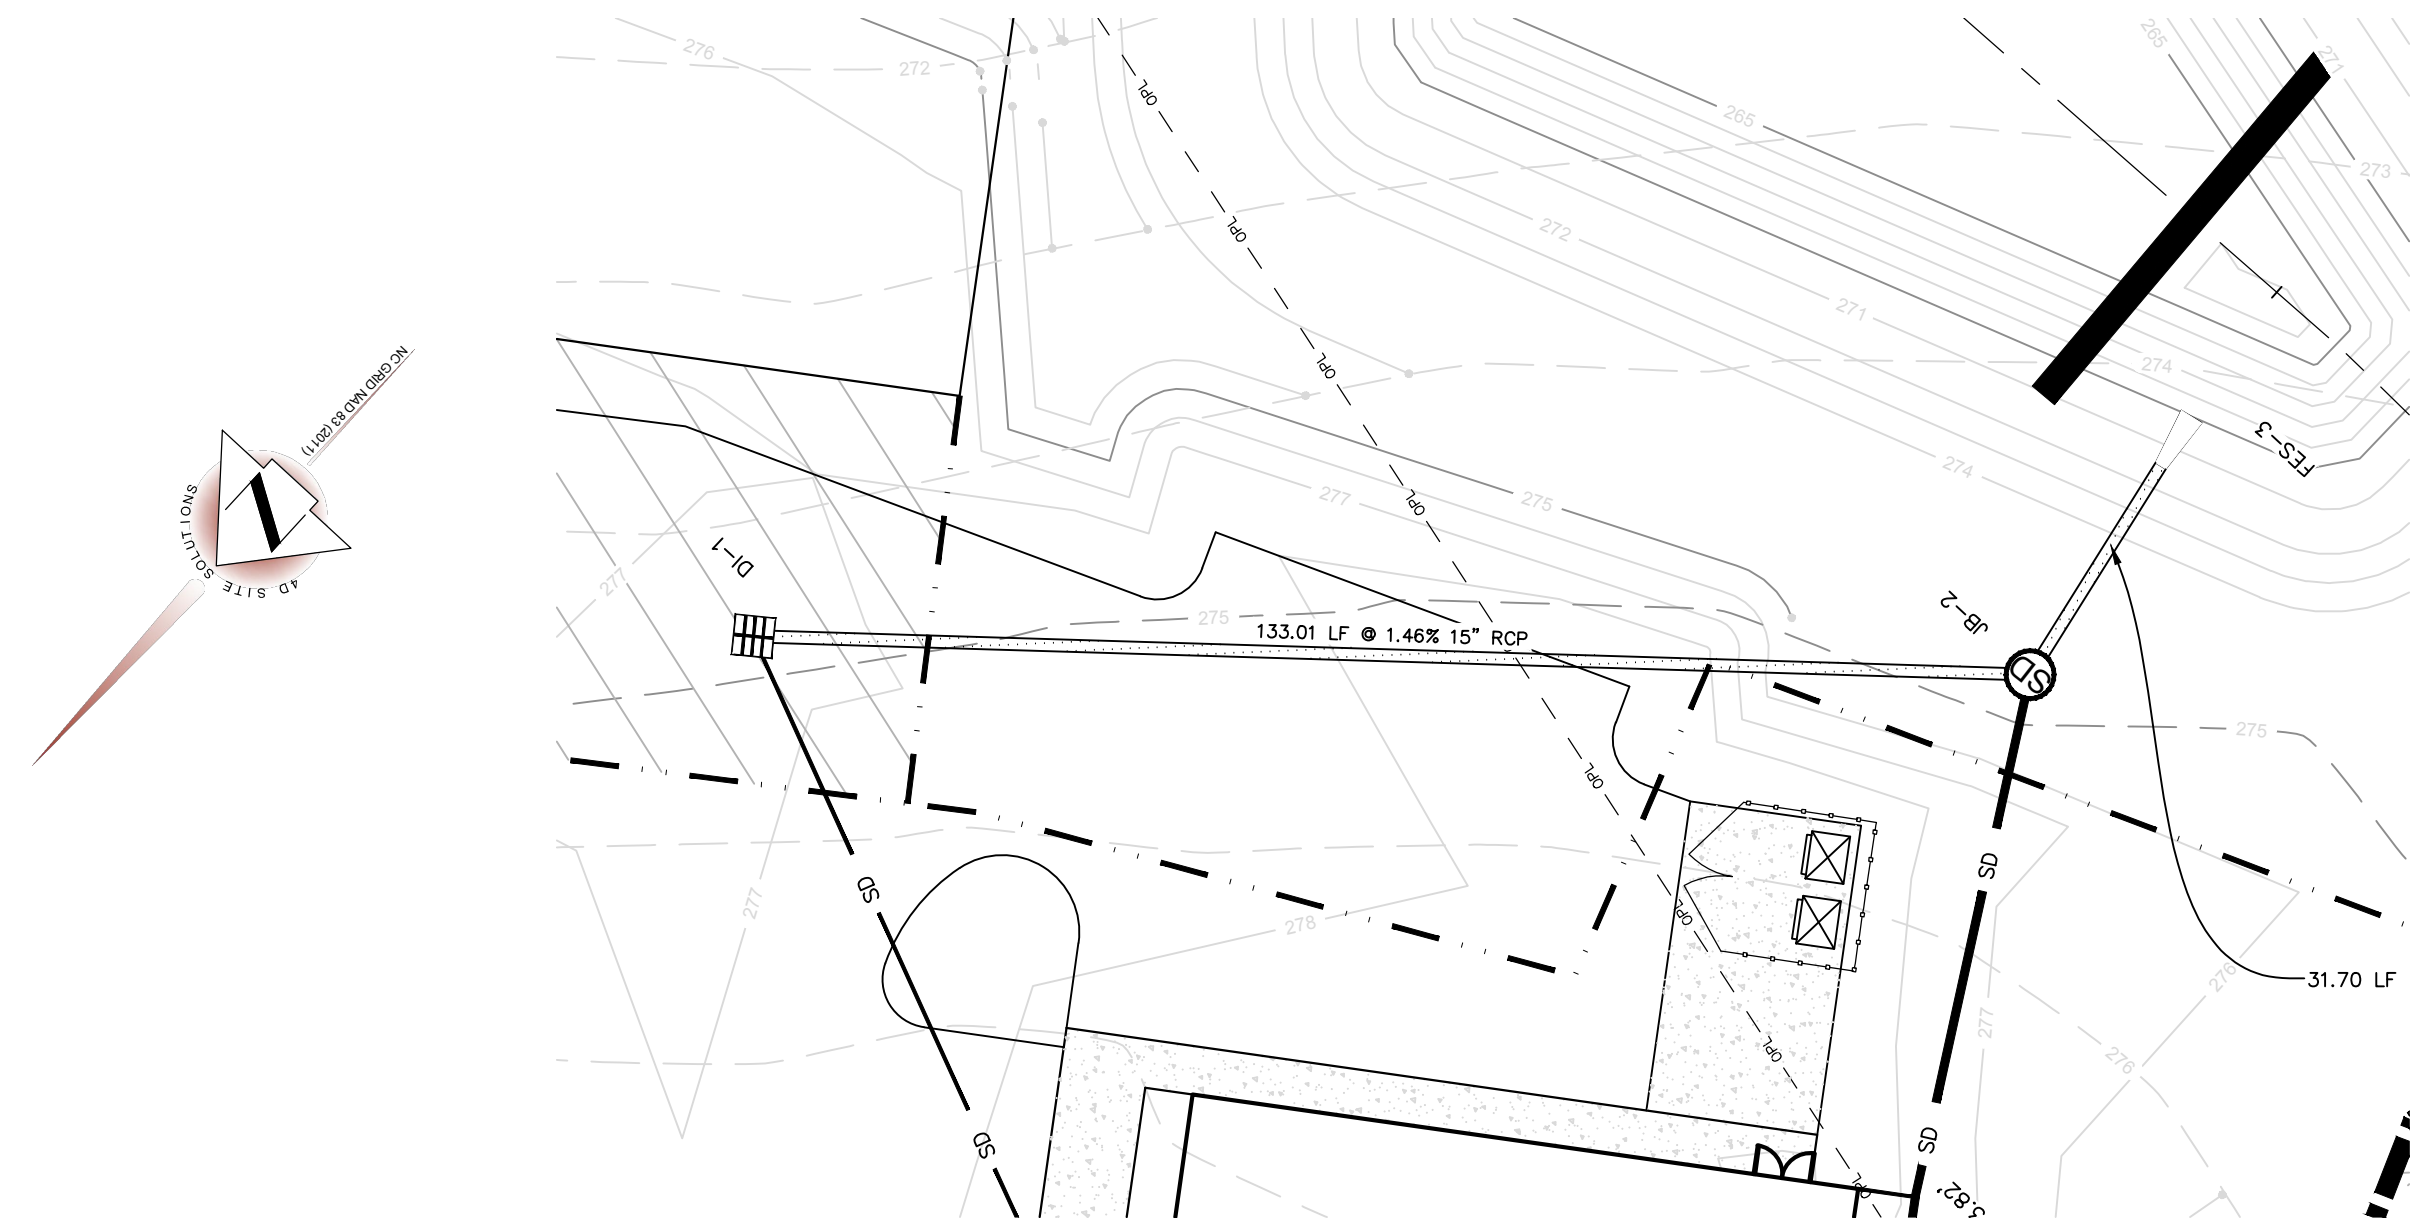
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 VERTICAL: 1"=2'

DATE RELEASED

APRIL 22, 2021


SHEET NUMBER

C-5.1






DI-1 TO FES-3

STORM DRAIN -0+50 TO 2+00

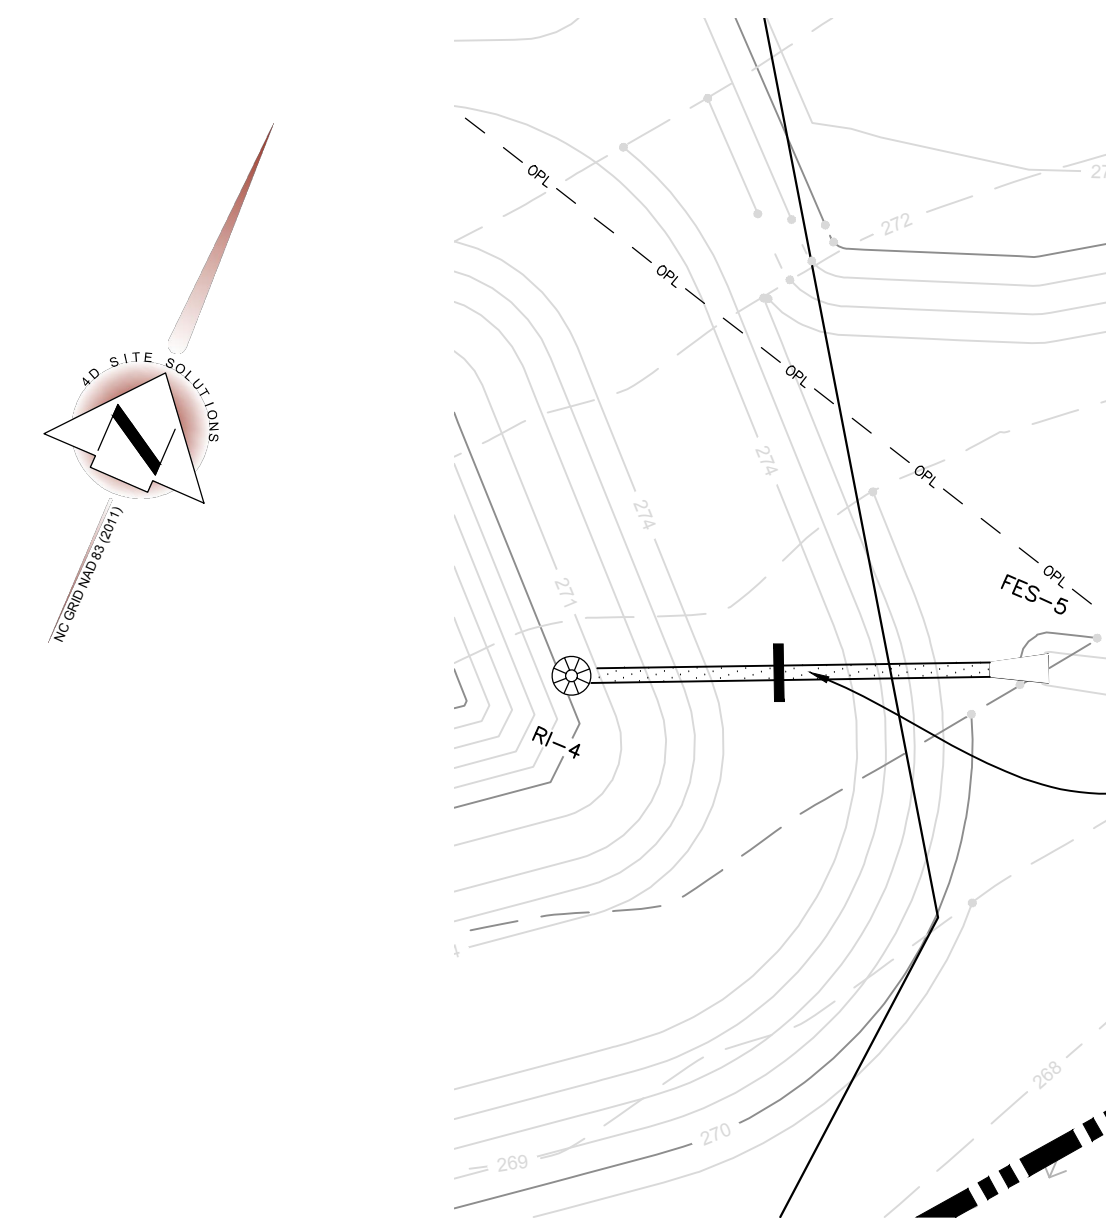

RI-4 TO FES-5

STORM DRAIN -0+25 TO 0+75

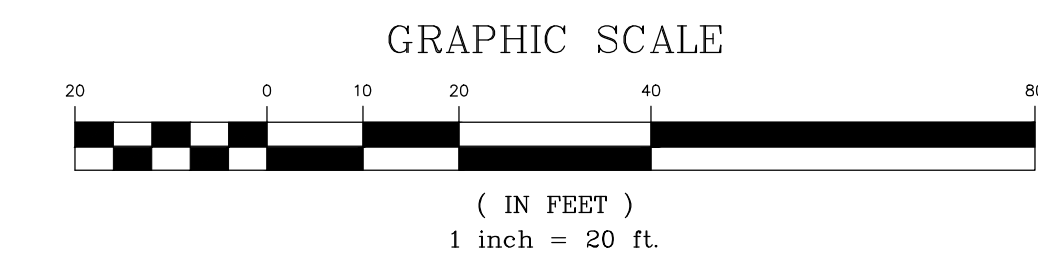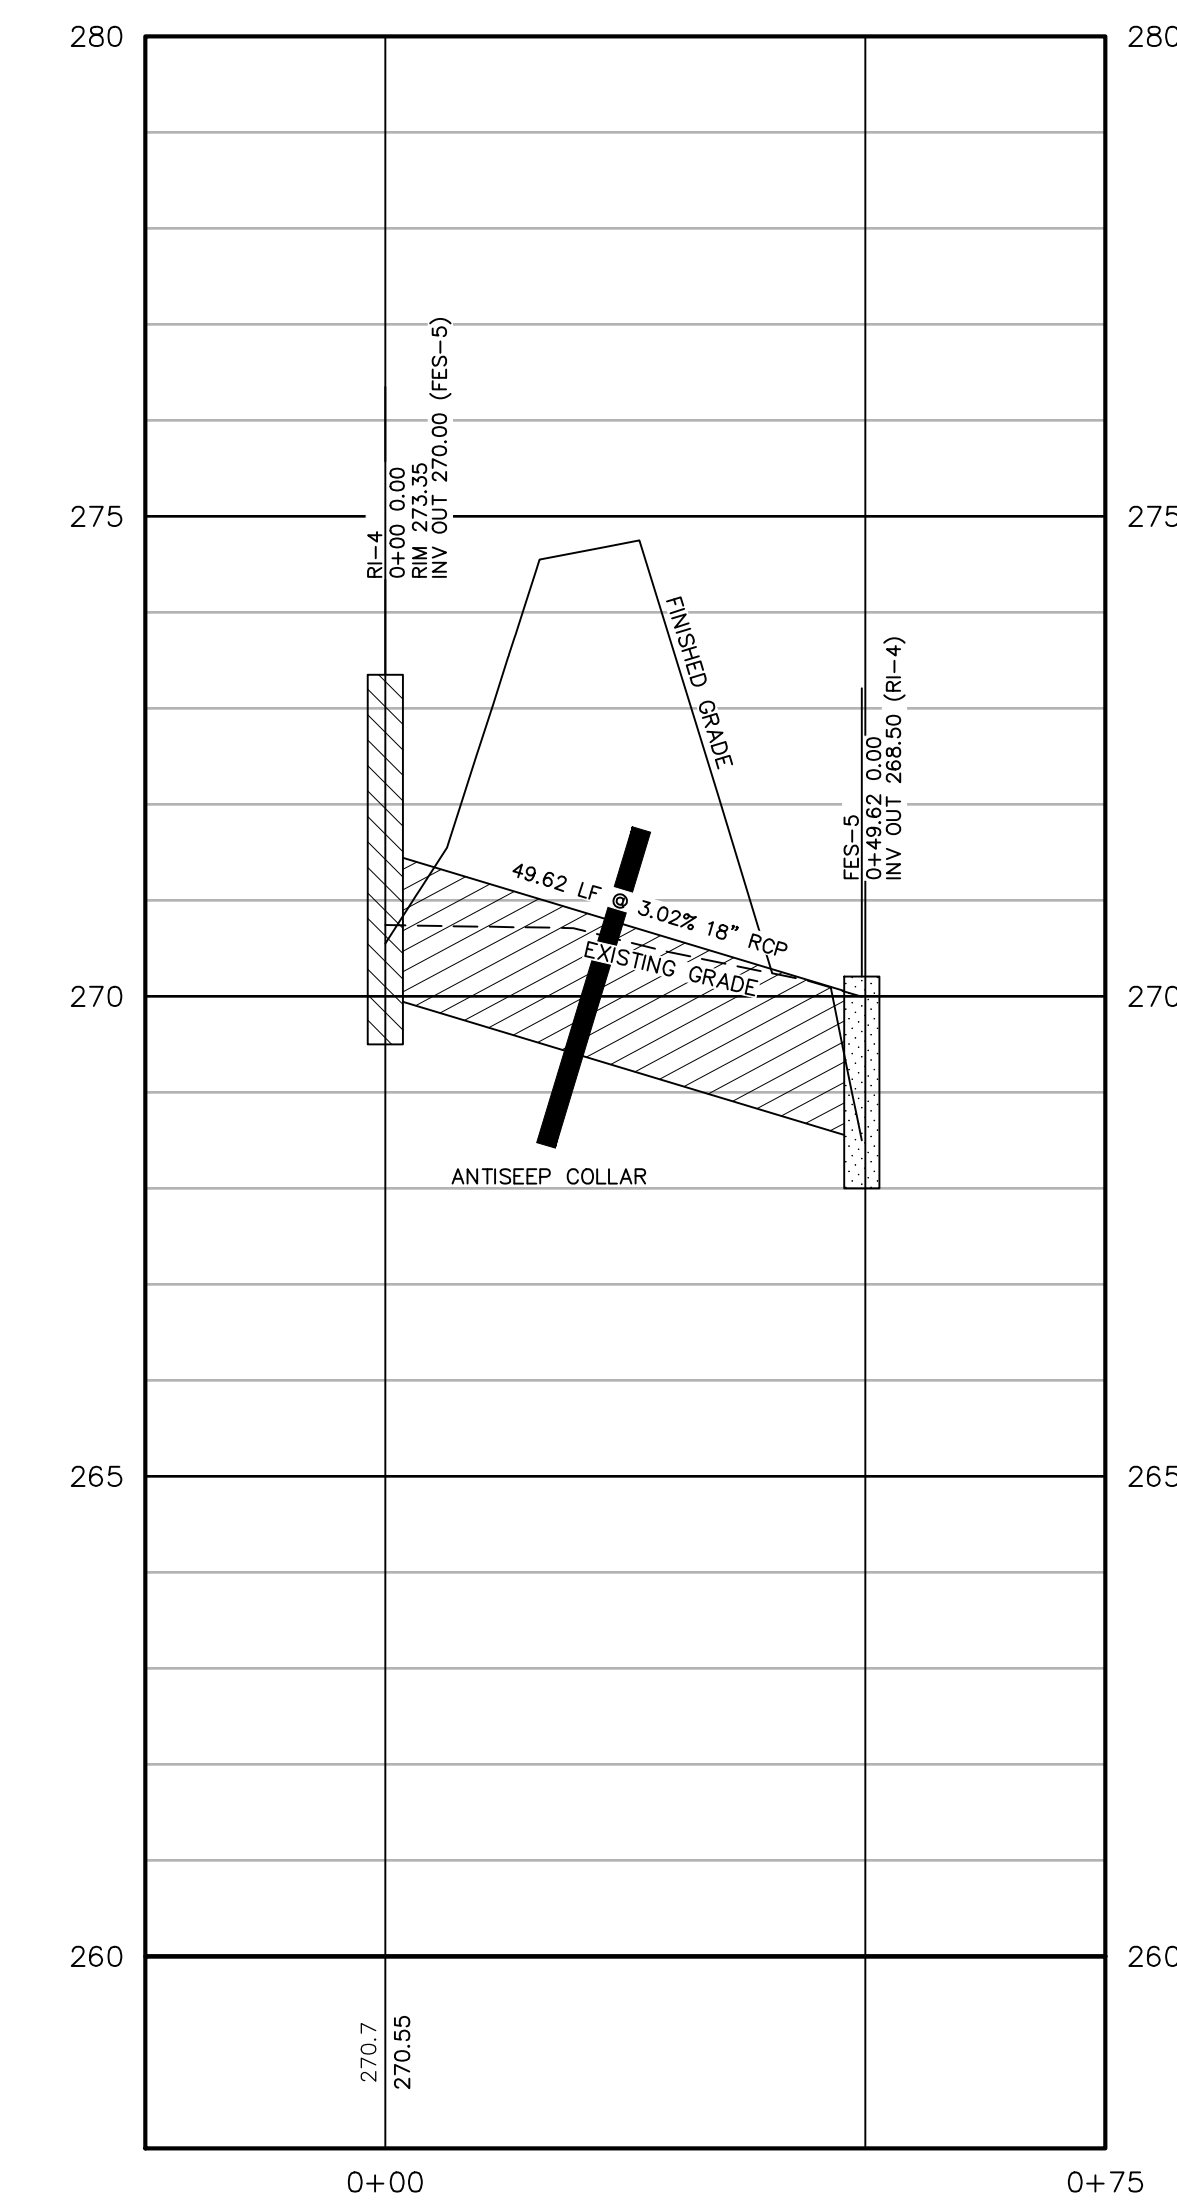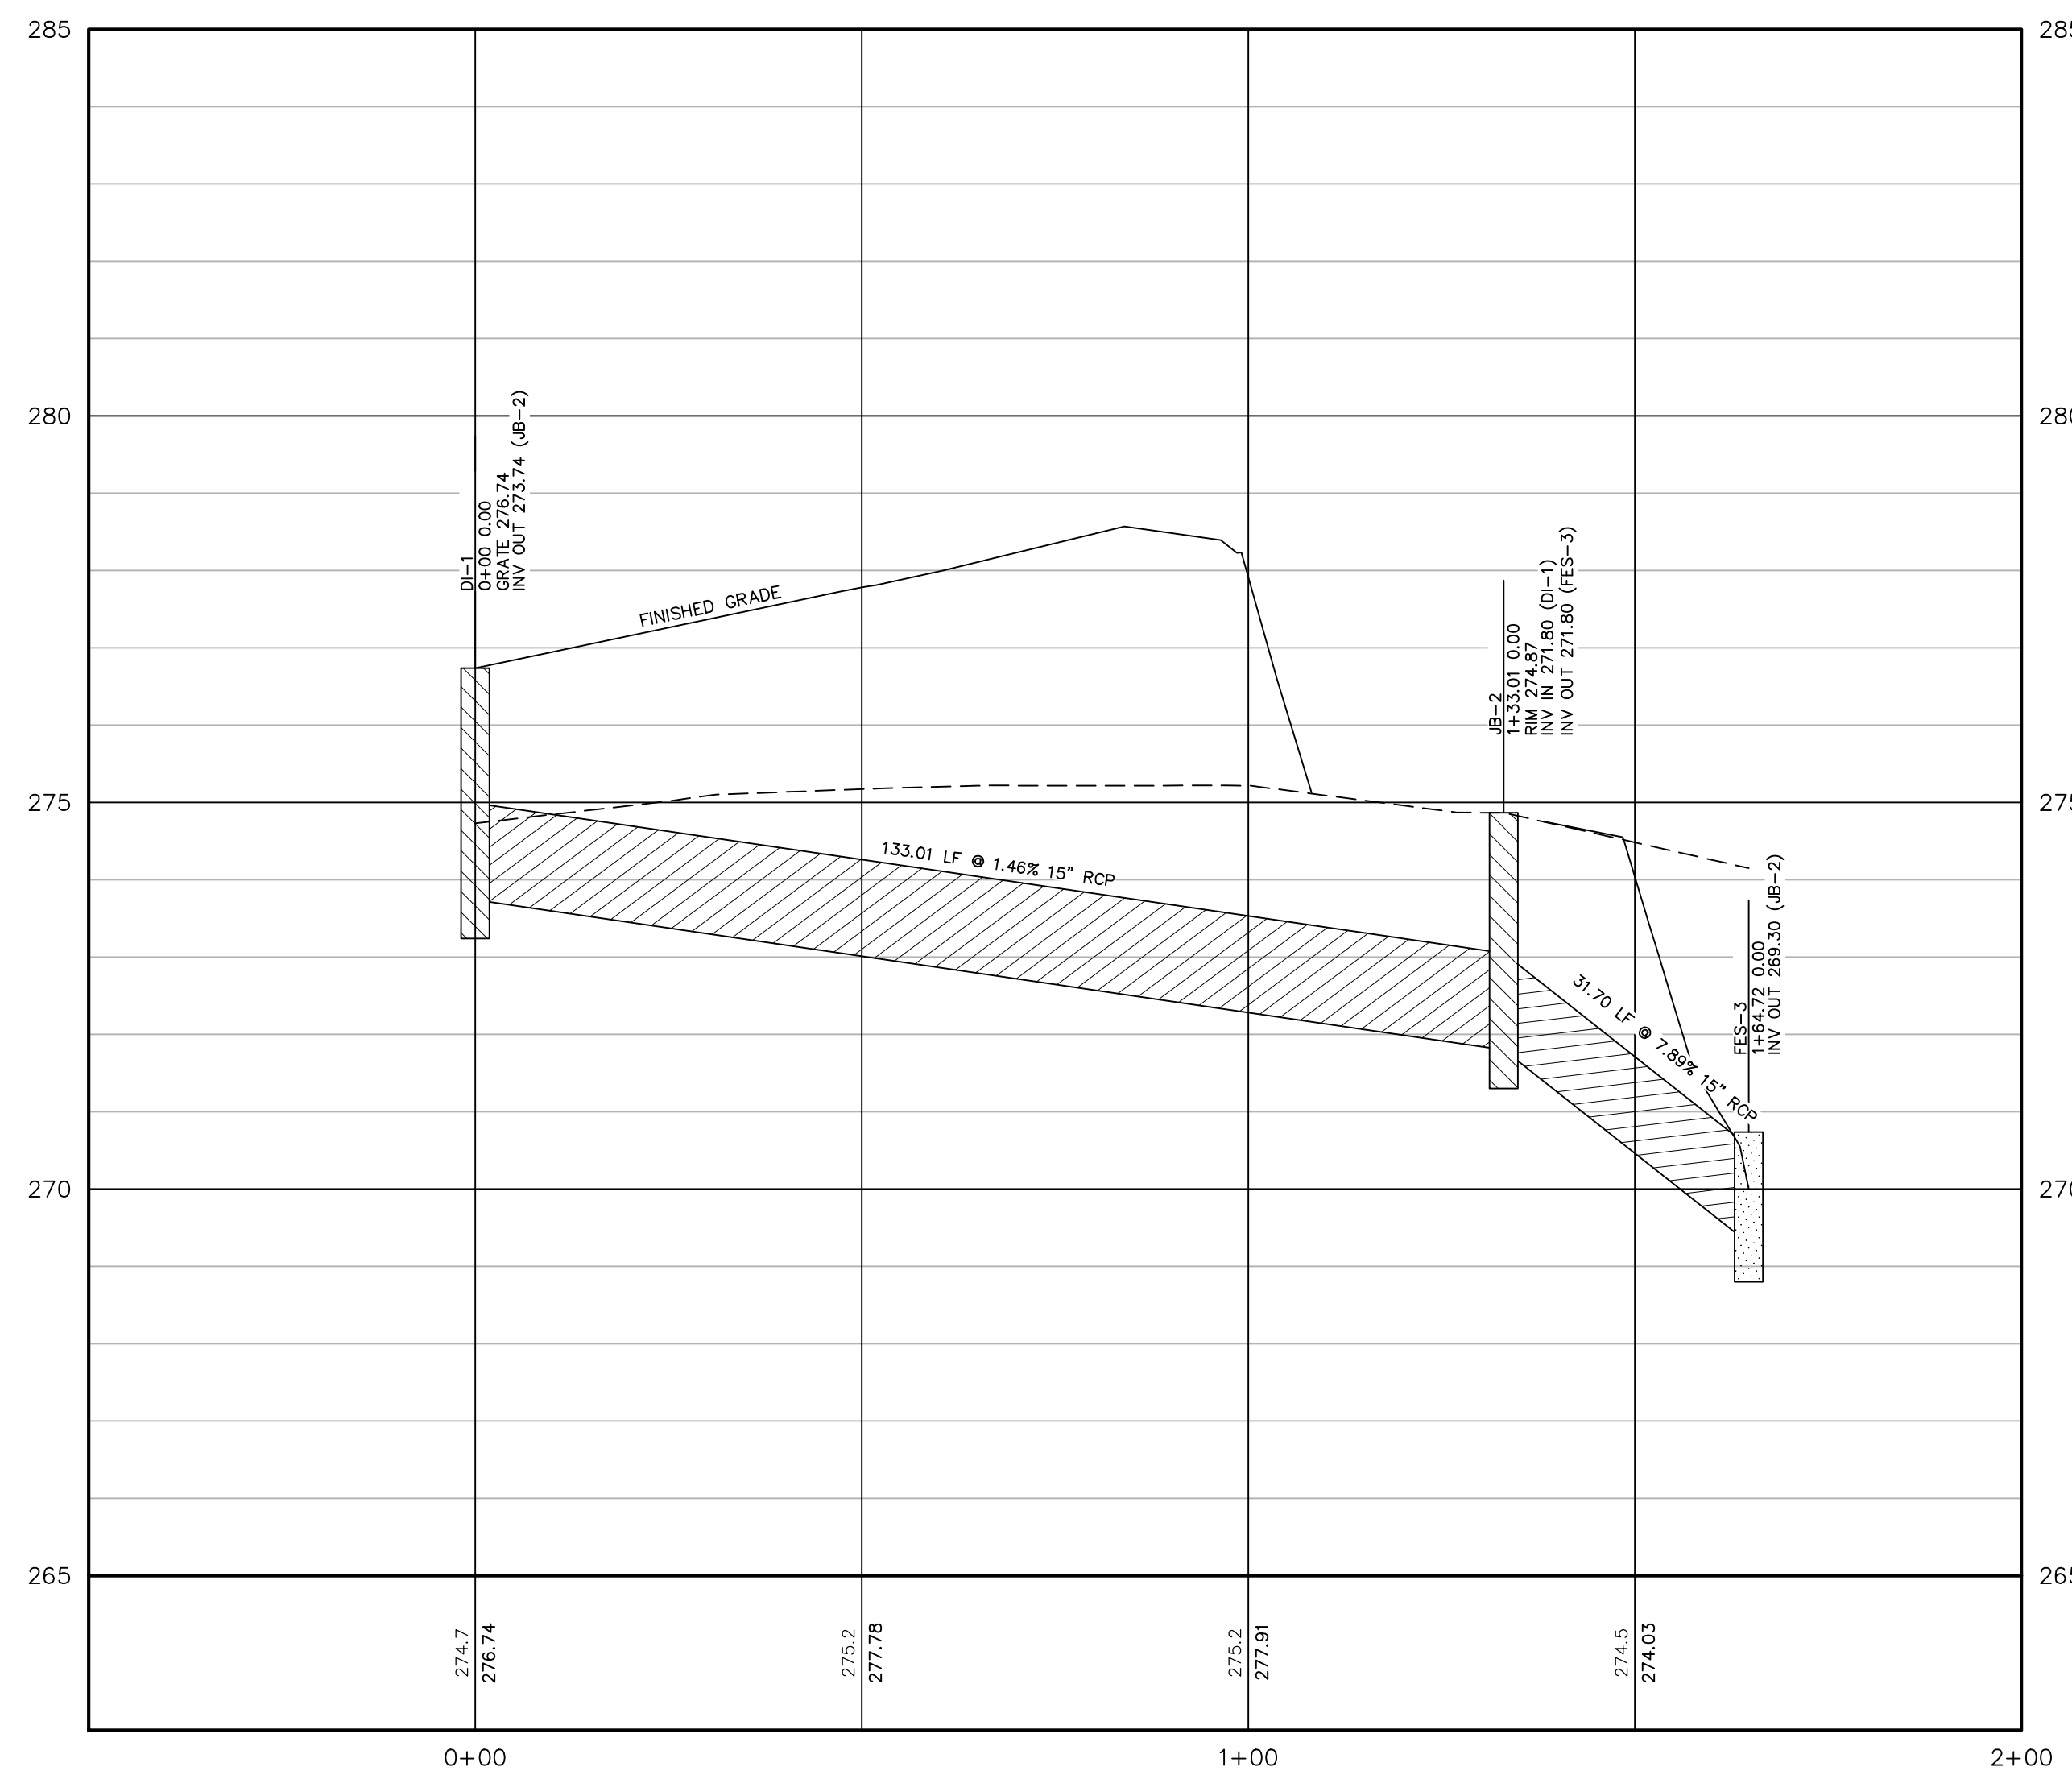



REVISIONS

PROJECT NAME

**SPRING LAKE
 RAY ROAD
 DOLLAR
 GENERAL**

**STORM
 PROFILES**

CLIENT

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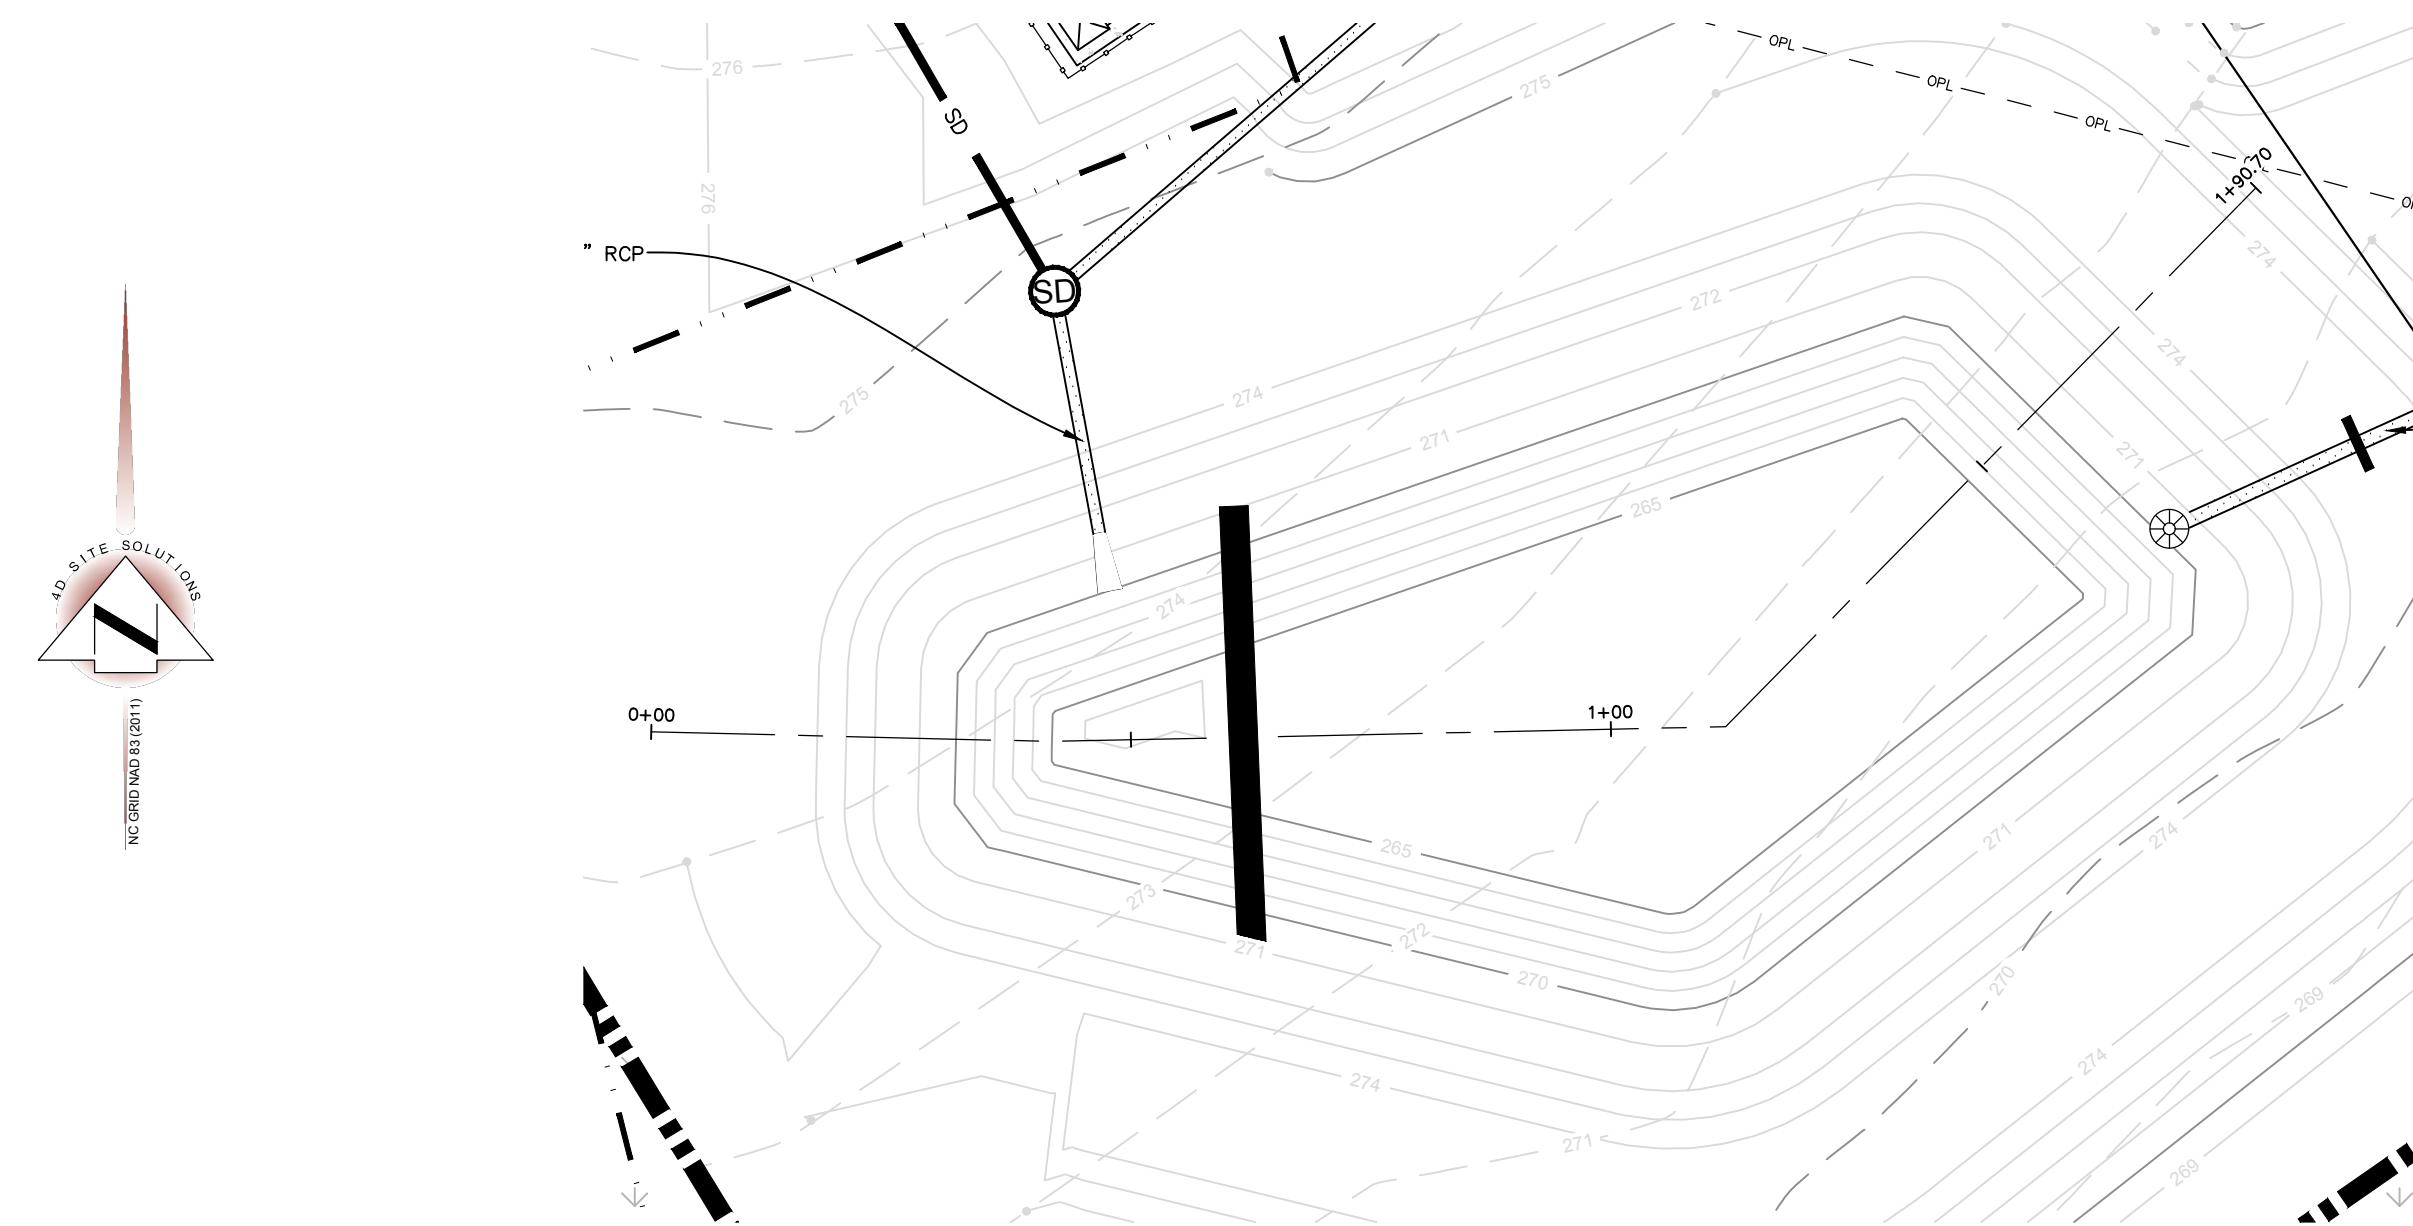
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 VERTICAL: 1"=2'

DATE RELEASED

APRIL 22, 2021



SHEET NUMBER

C-5.2



WET POND #1

STORM DRAIN -0+50 TO 2+00

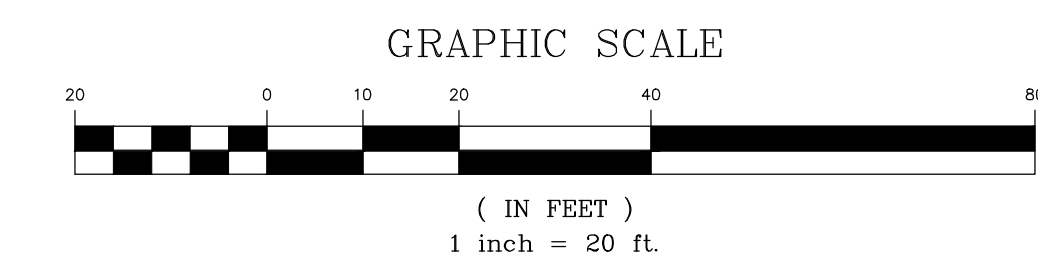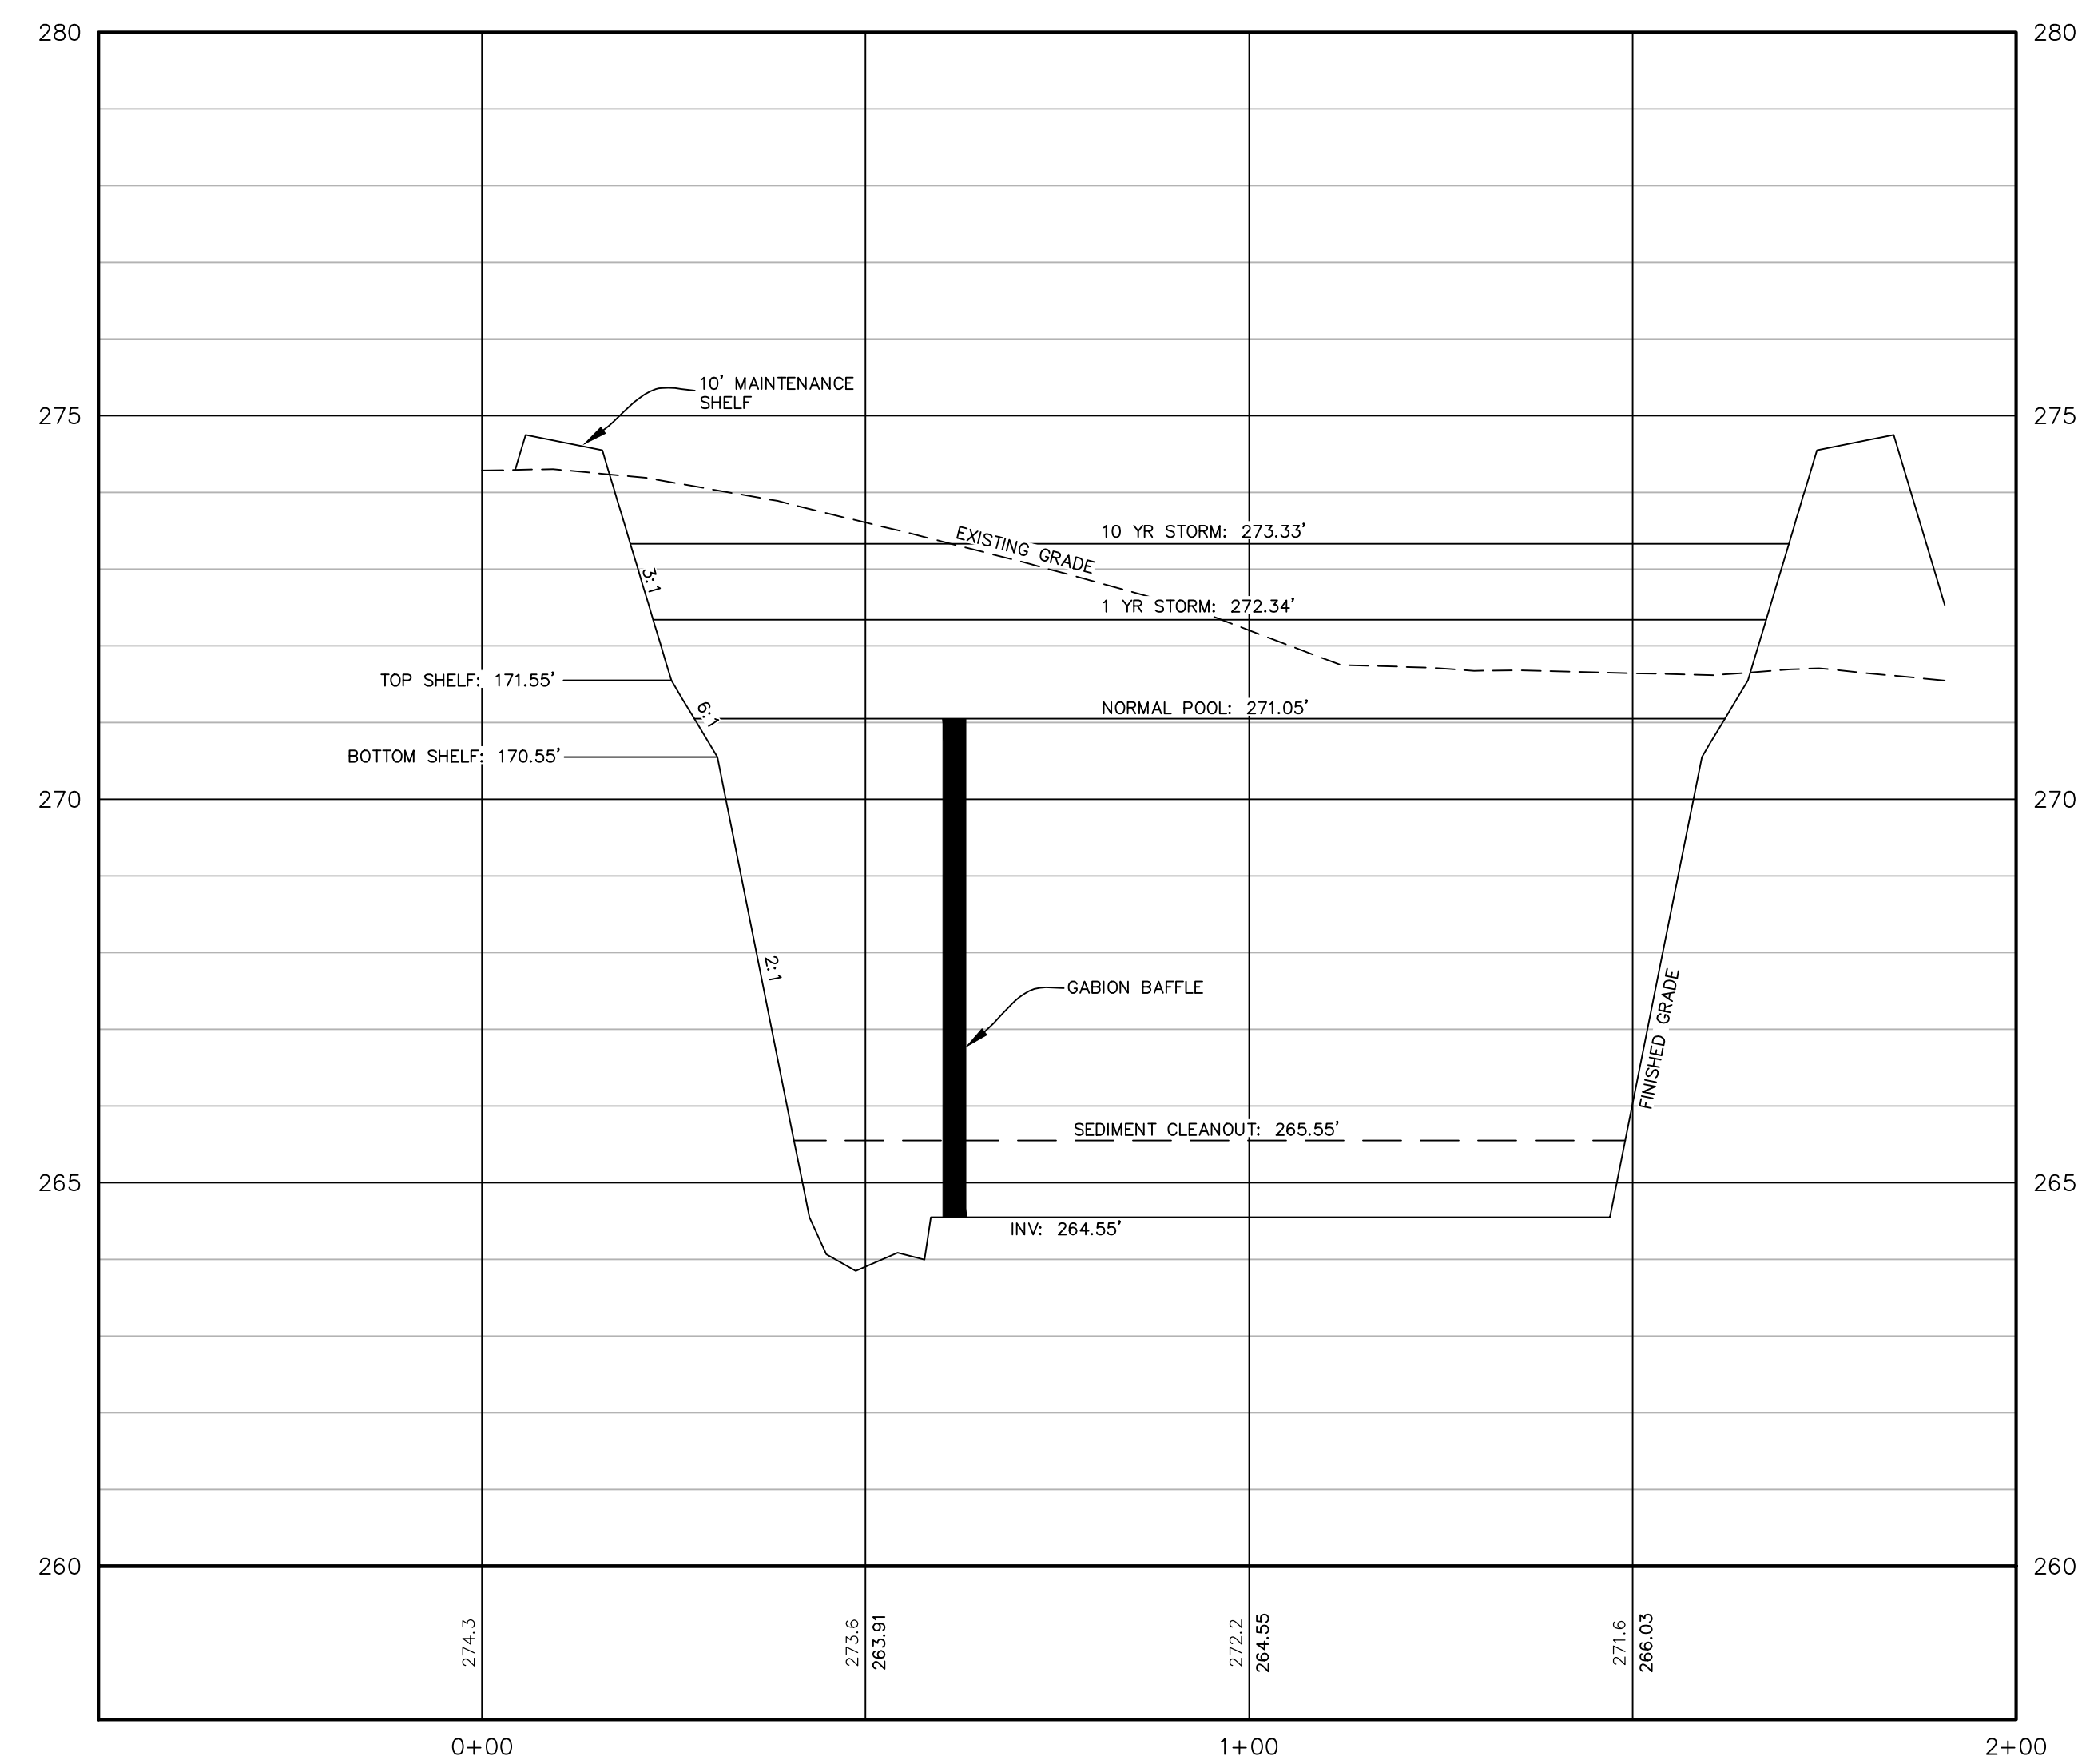



REVISIONS

PROJECT NAME

**SPRING LAKE
 RAY ROAD
 DOLLAR
 GENERAL**

SITE DETAILS

CLIENT

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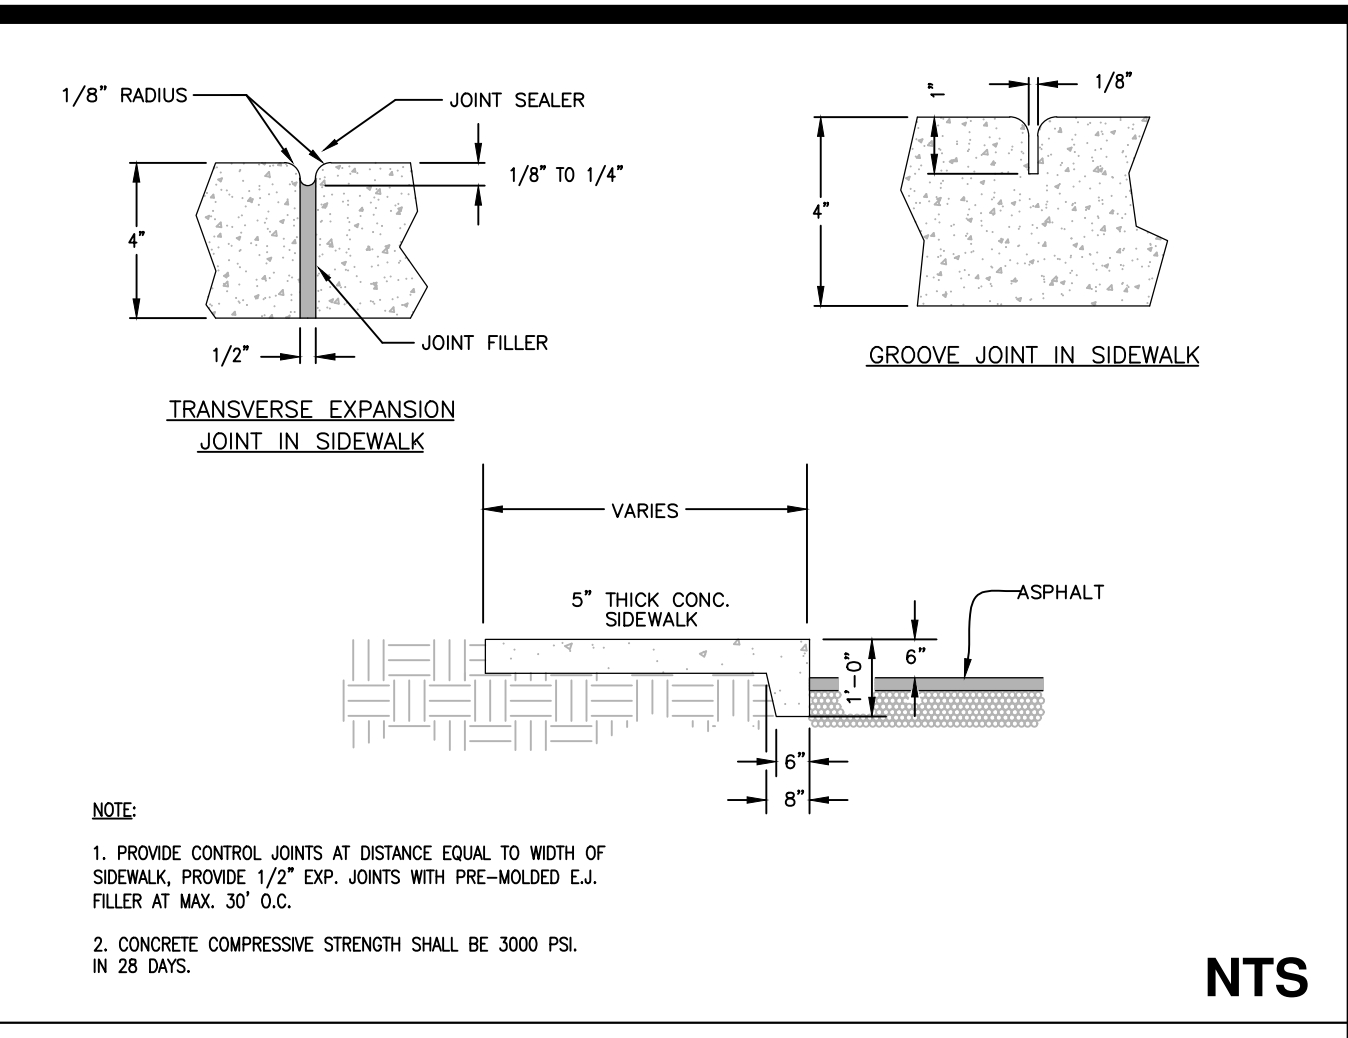
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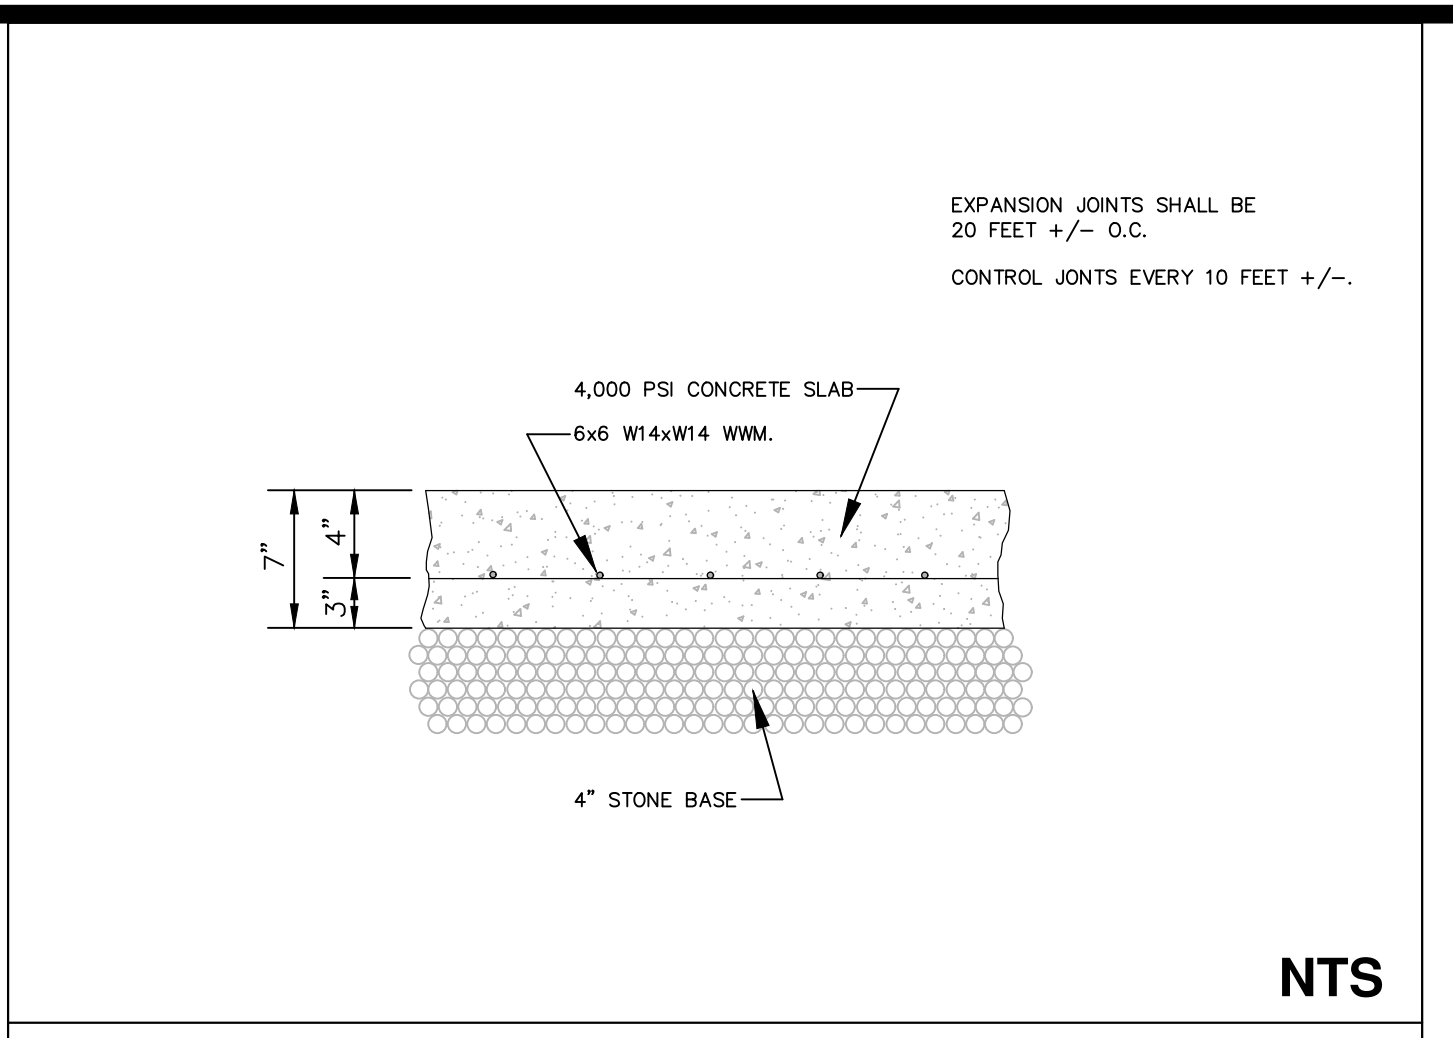
APRIL 22, 2021

SHEET NUMBER


C-6.0




4 TURN DOWN SIDEWALK




3 CONCRETE PAVEMENT SECTION

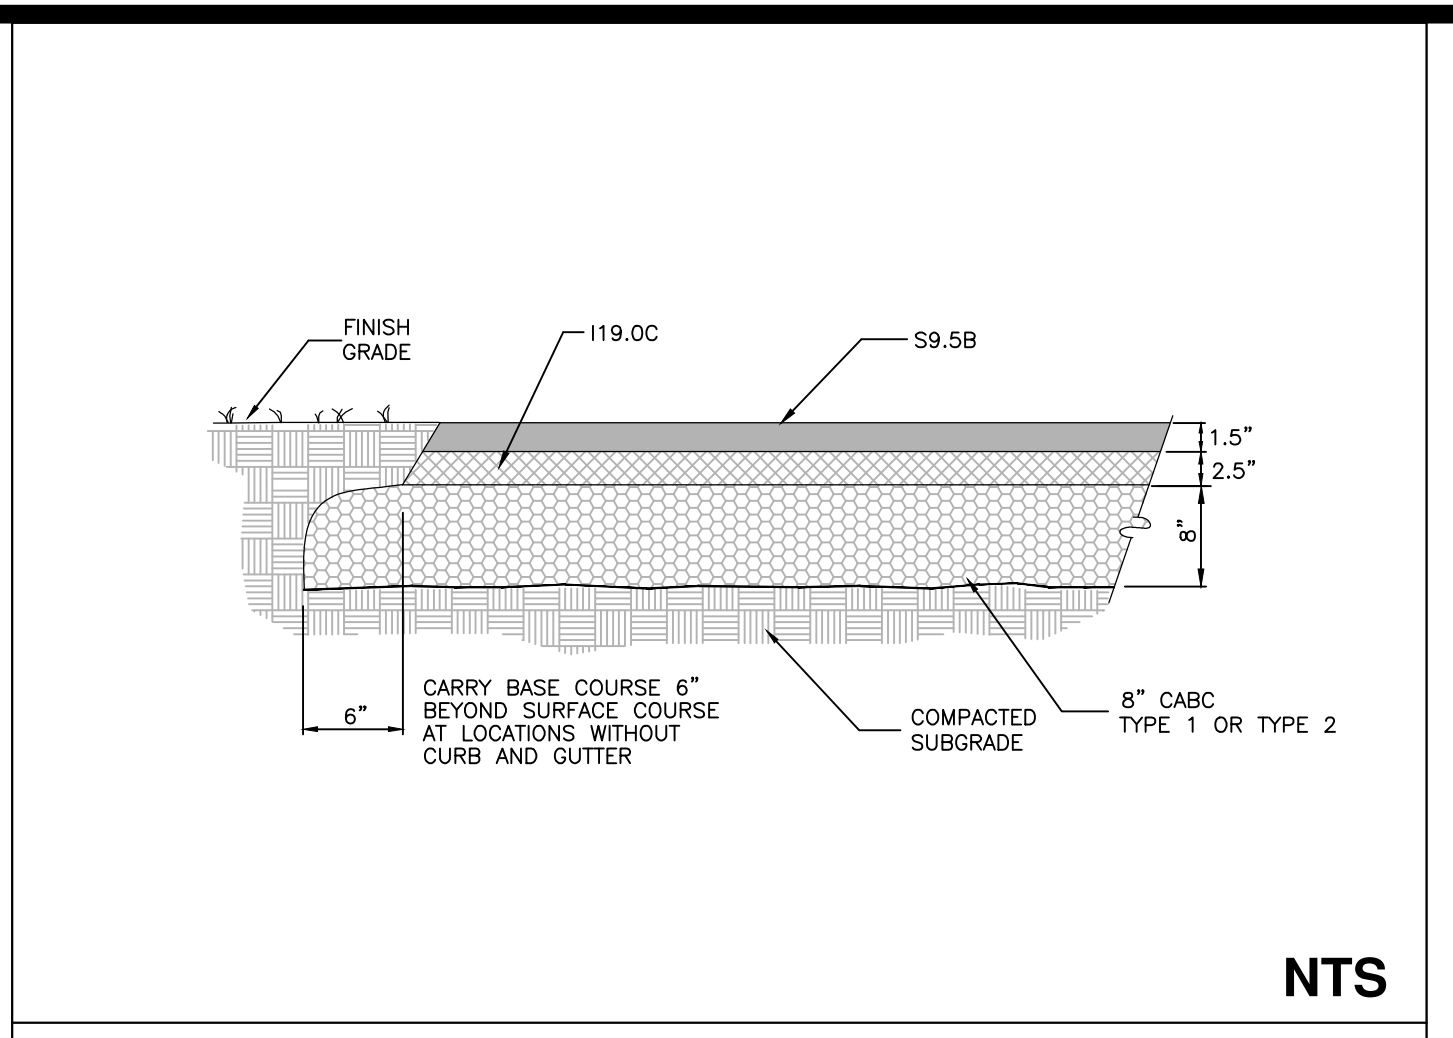


2 HEAVY DUTY PAVEMENT

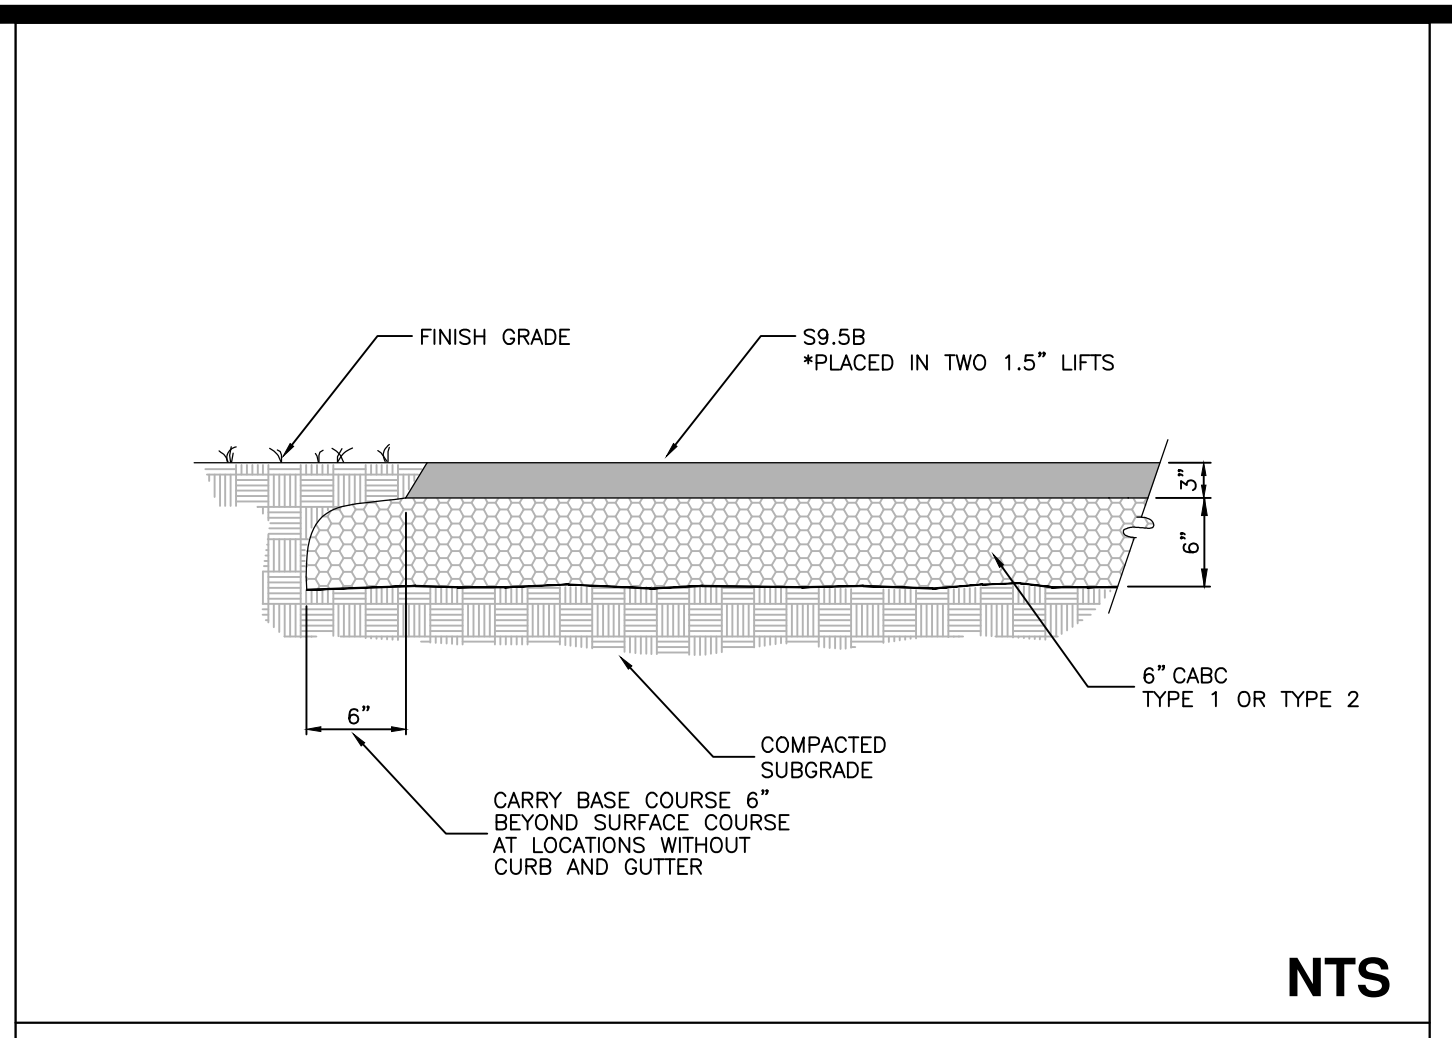


1 LIGHT DUTY PAVEMENT

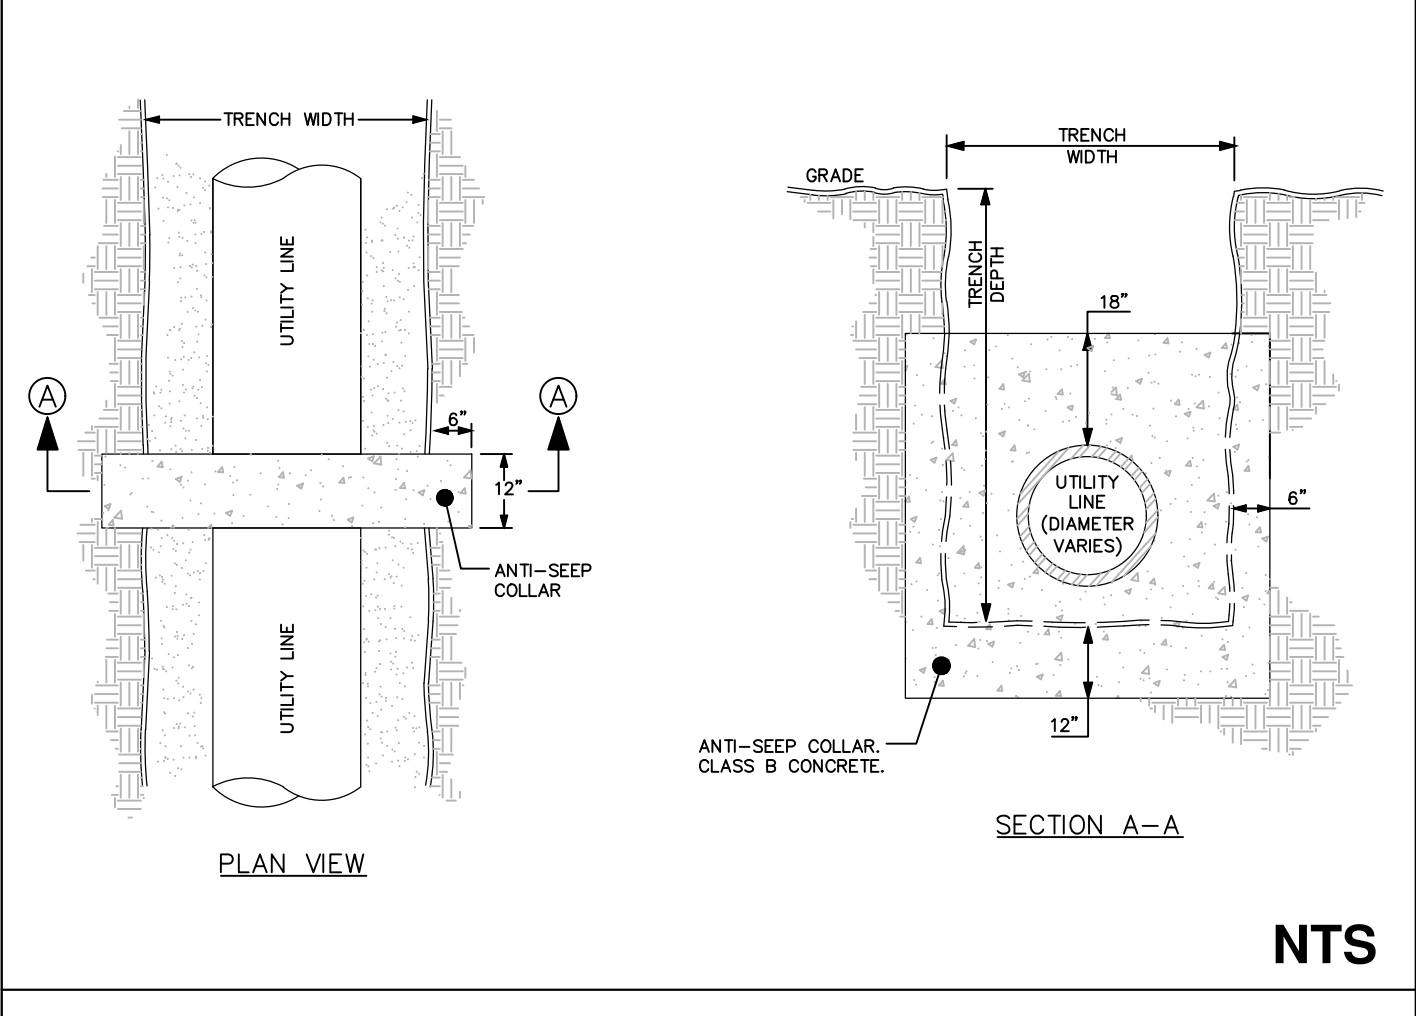


8 ANTI-SEEP COLLAR

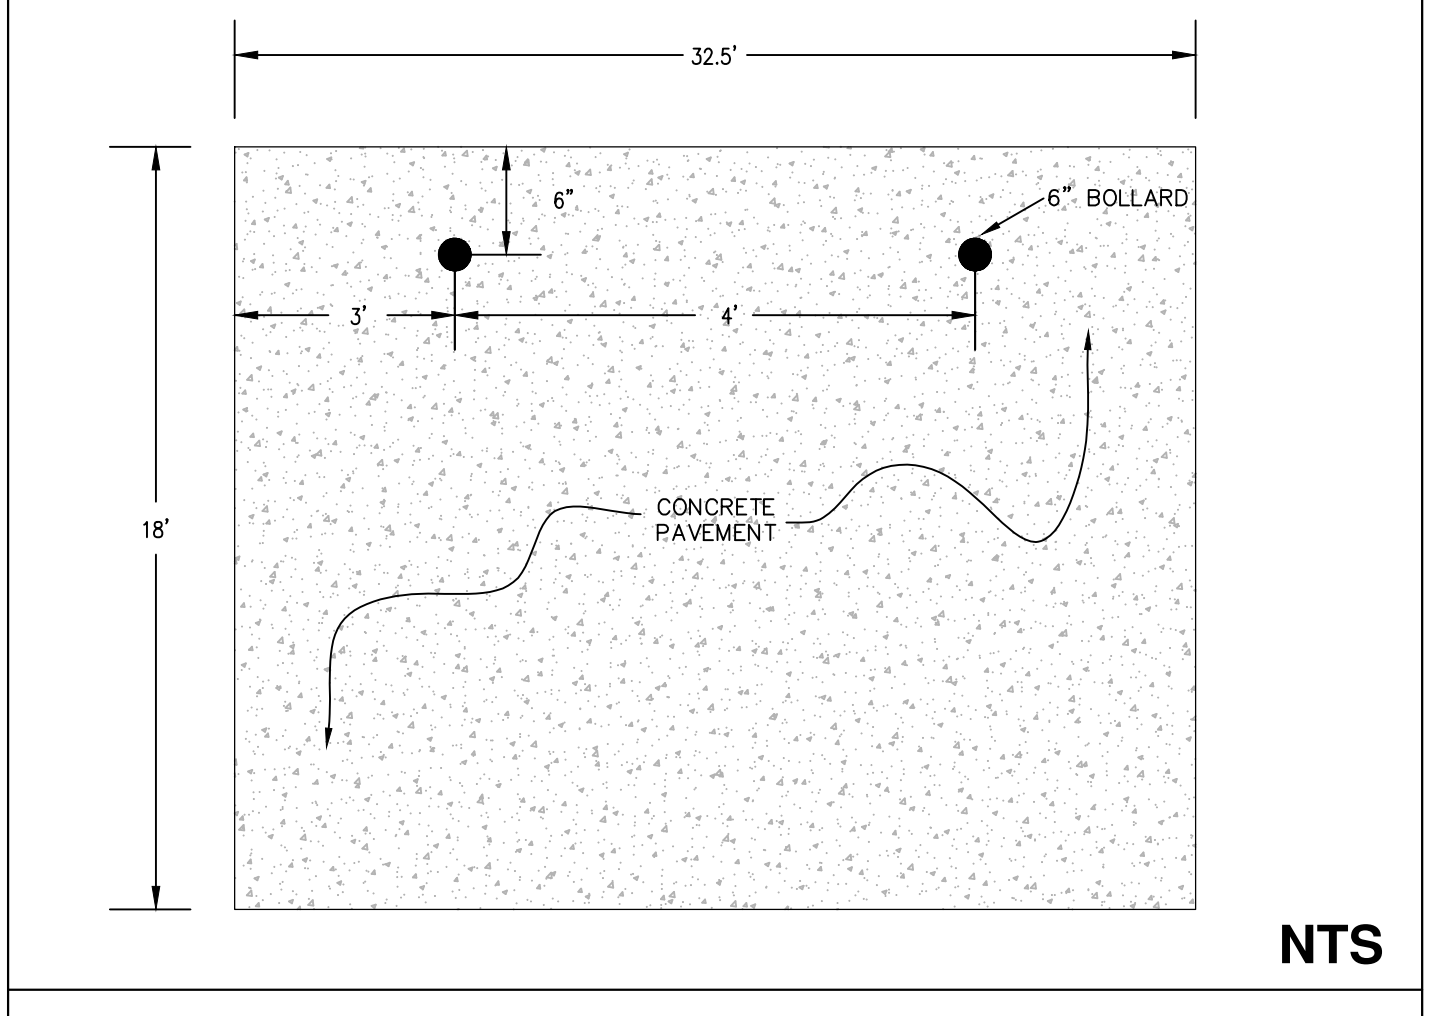

7 DUMPSTER PAD

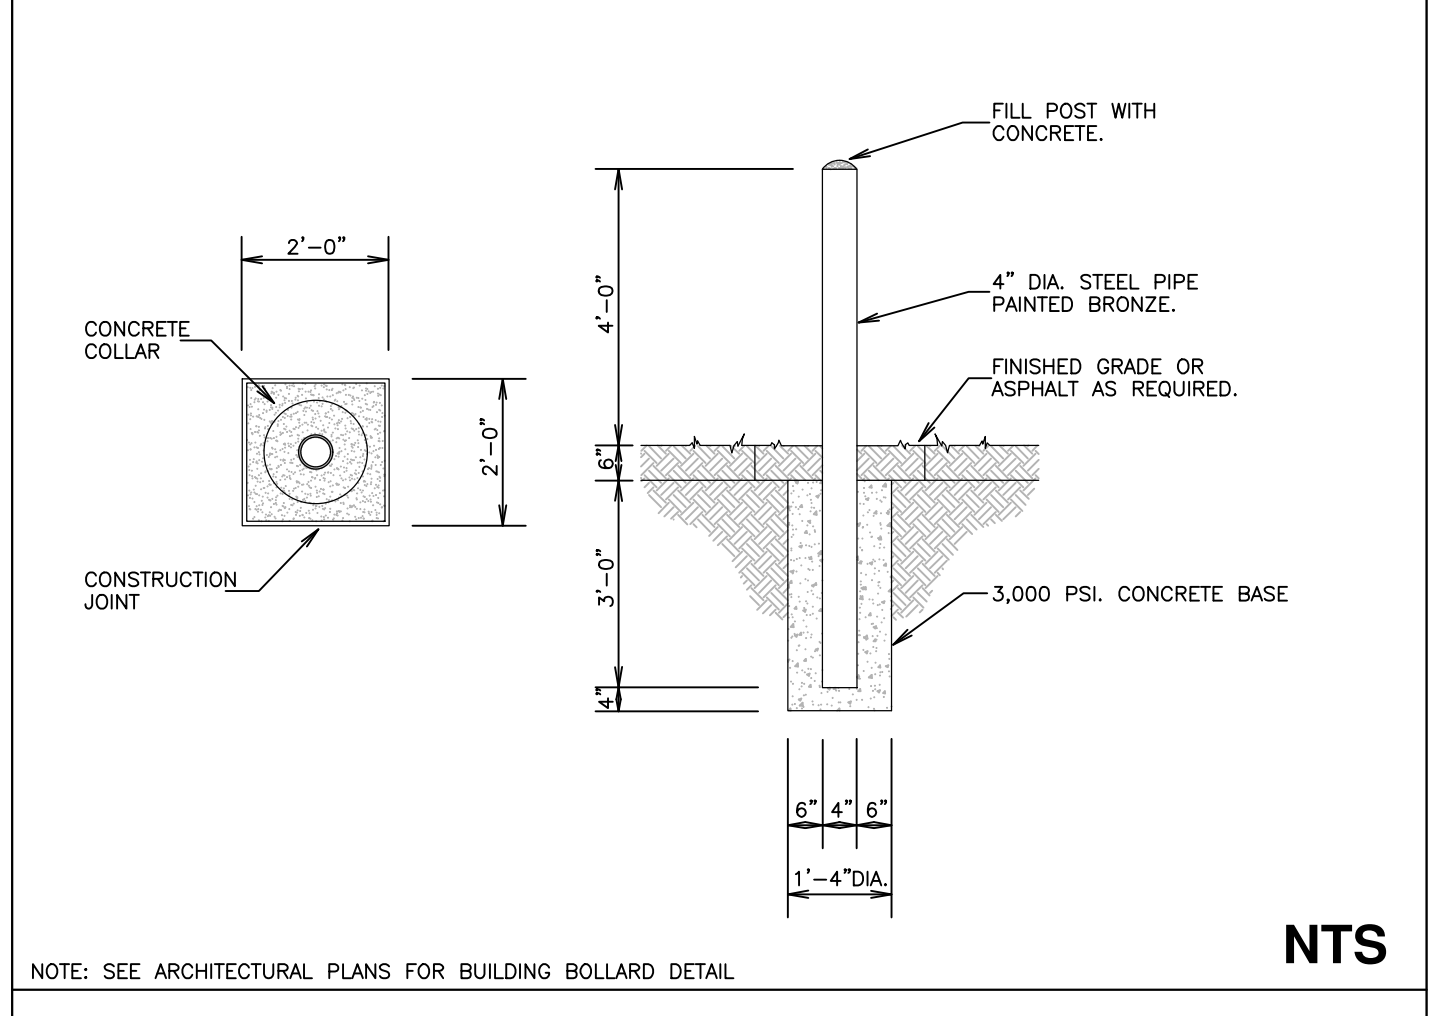

6 6\"/>

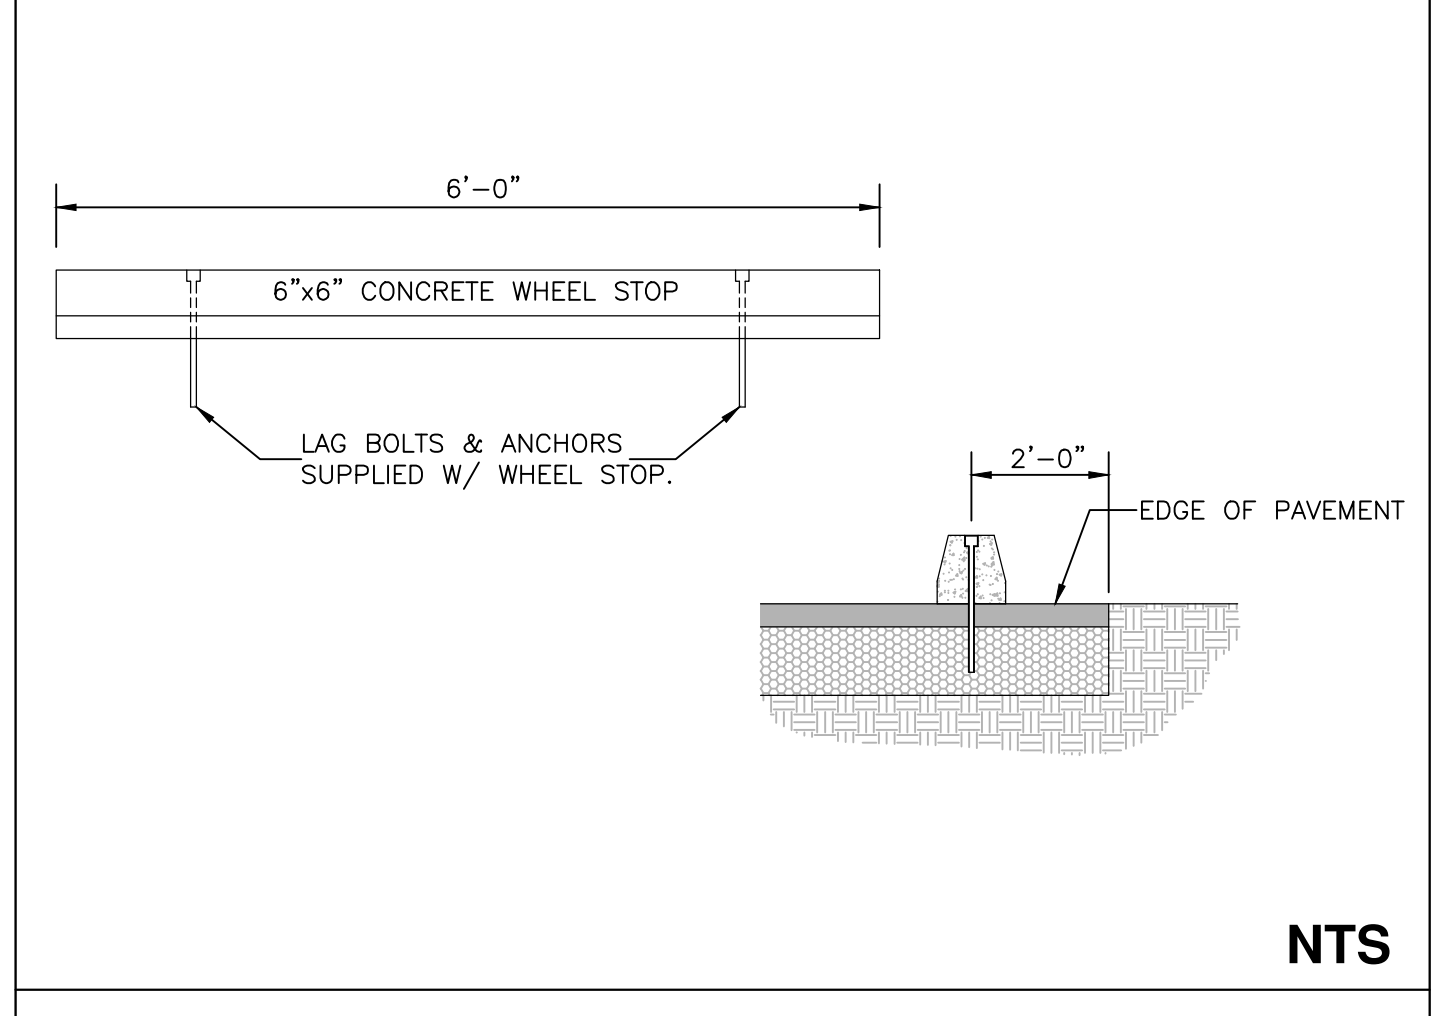

5 CONCRETE WHEEL STOP

ACCESSIBLE PARKING REQUIREMENTS

TOTAL PARKING SPACES PROVIDED	MINIMUM NUMBER OF ACCESSIBLE SPACES REQUIRED	MINIMUM NUMBER OF ACCESSIBLE SPACES REQUIRED TO BE VAN ACCESSIBLE
1 TO 25	1	1
26 TO 50	2	1
51 TO 75	3	1
76 TO 100	4	1
101 TO 150	5	1
151 TO 200	6	1
201 TO 300	7	1
301 TO 400	8	1
401 TO 500	9	2
501 TO 1000	2% OF TOTAL	1 IN EVERY 8 ACCESSIBLE SPACES
1001 AND OVER	2% PLUS 1 FOR EACH 100 OVER 1000	1 IN EVERY 8 ACCESSIBLE SPACES

SECTION 4.1.3 (5) OF THE AMERICANS WITH DISABILITIES ACT (ADA), SEE 4.1.2.(5) (6) FOR MEDICAL CARE FACILITIES.


NOTES:
 1. ALL 12"x18" ACCESSIBLE SIGNS (R7-8 & R7-1) SHALL BE MOUNTED AT 7 FEET FROM GRADE TO BOTTOM EDGE OF SIGN FACE (MUTED). MOUNTING HEIGHT CAN BE REDUCED TO 5 FEET IF PLACED IN AN AREA BETWEEN SIDEWALK AND BUILDING FACE IN WHICH PEDESTRIANS ARE NOT EXPECTED TO USE.
 2. REFER TO MANUAL ON UNIFORM TRAFFIC CONTROL DEVICES, (MUTED) U.S. DEPARTMENT OF TRANSPORTATION AND NORTH CAROLINA DEPARTMENT OF TRANSPORTATION SUPPLEMENT.
 3. IF ACCESSIBLE ROUTE IS A RAMPED SIDEWALK AREA, THEN RAMPS ARE REQUIRED AT LOADING ZONE AREA.
 4. ALL DIMENSIONS, PAVEMENT MARKINGS AND SIGNAGE SHALL COMPLY WITH CURRENT ADA REQUIREMENTS.

ACCESSIBLE ROUTE (SEE NOTE 3)


ONE OUT OF EVERY EIGHT (8) ACCESSIBLE SPACES, BUT NOT LESS THAN ONE, IS REQUIRED TO BE VAN ACCESSIBLE.

PARKING SPACE PAVEMENT MARKINGS


9 HANDICAP SIGNAGE AND PAVEMENT MARKINGS

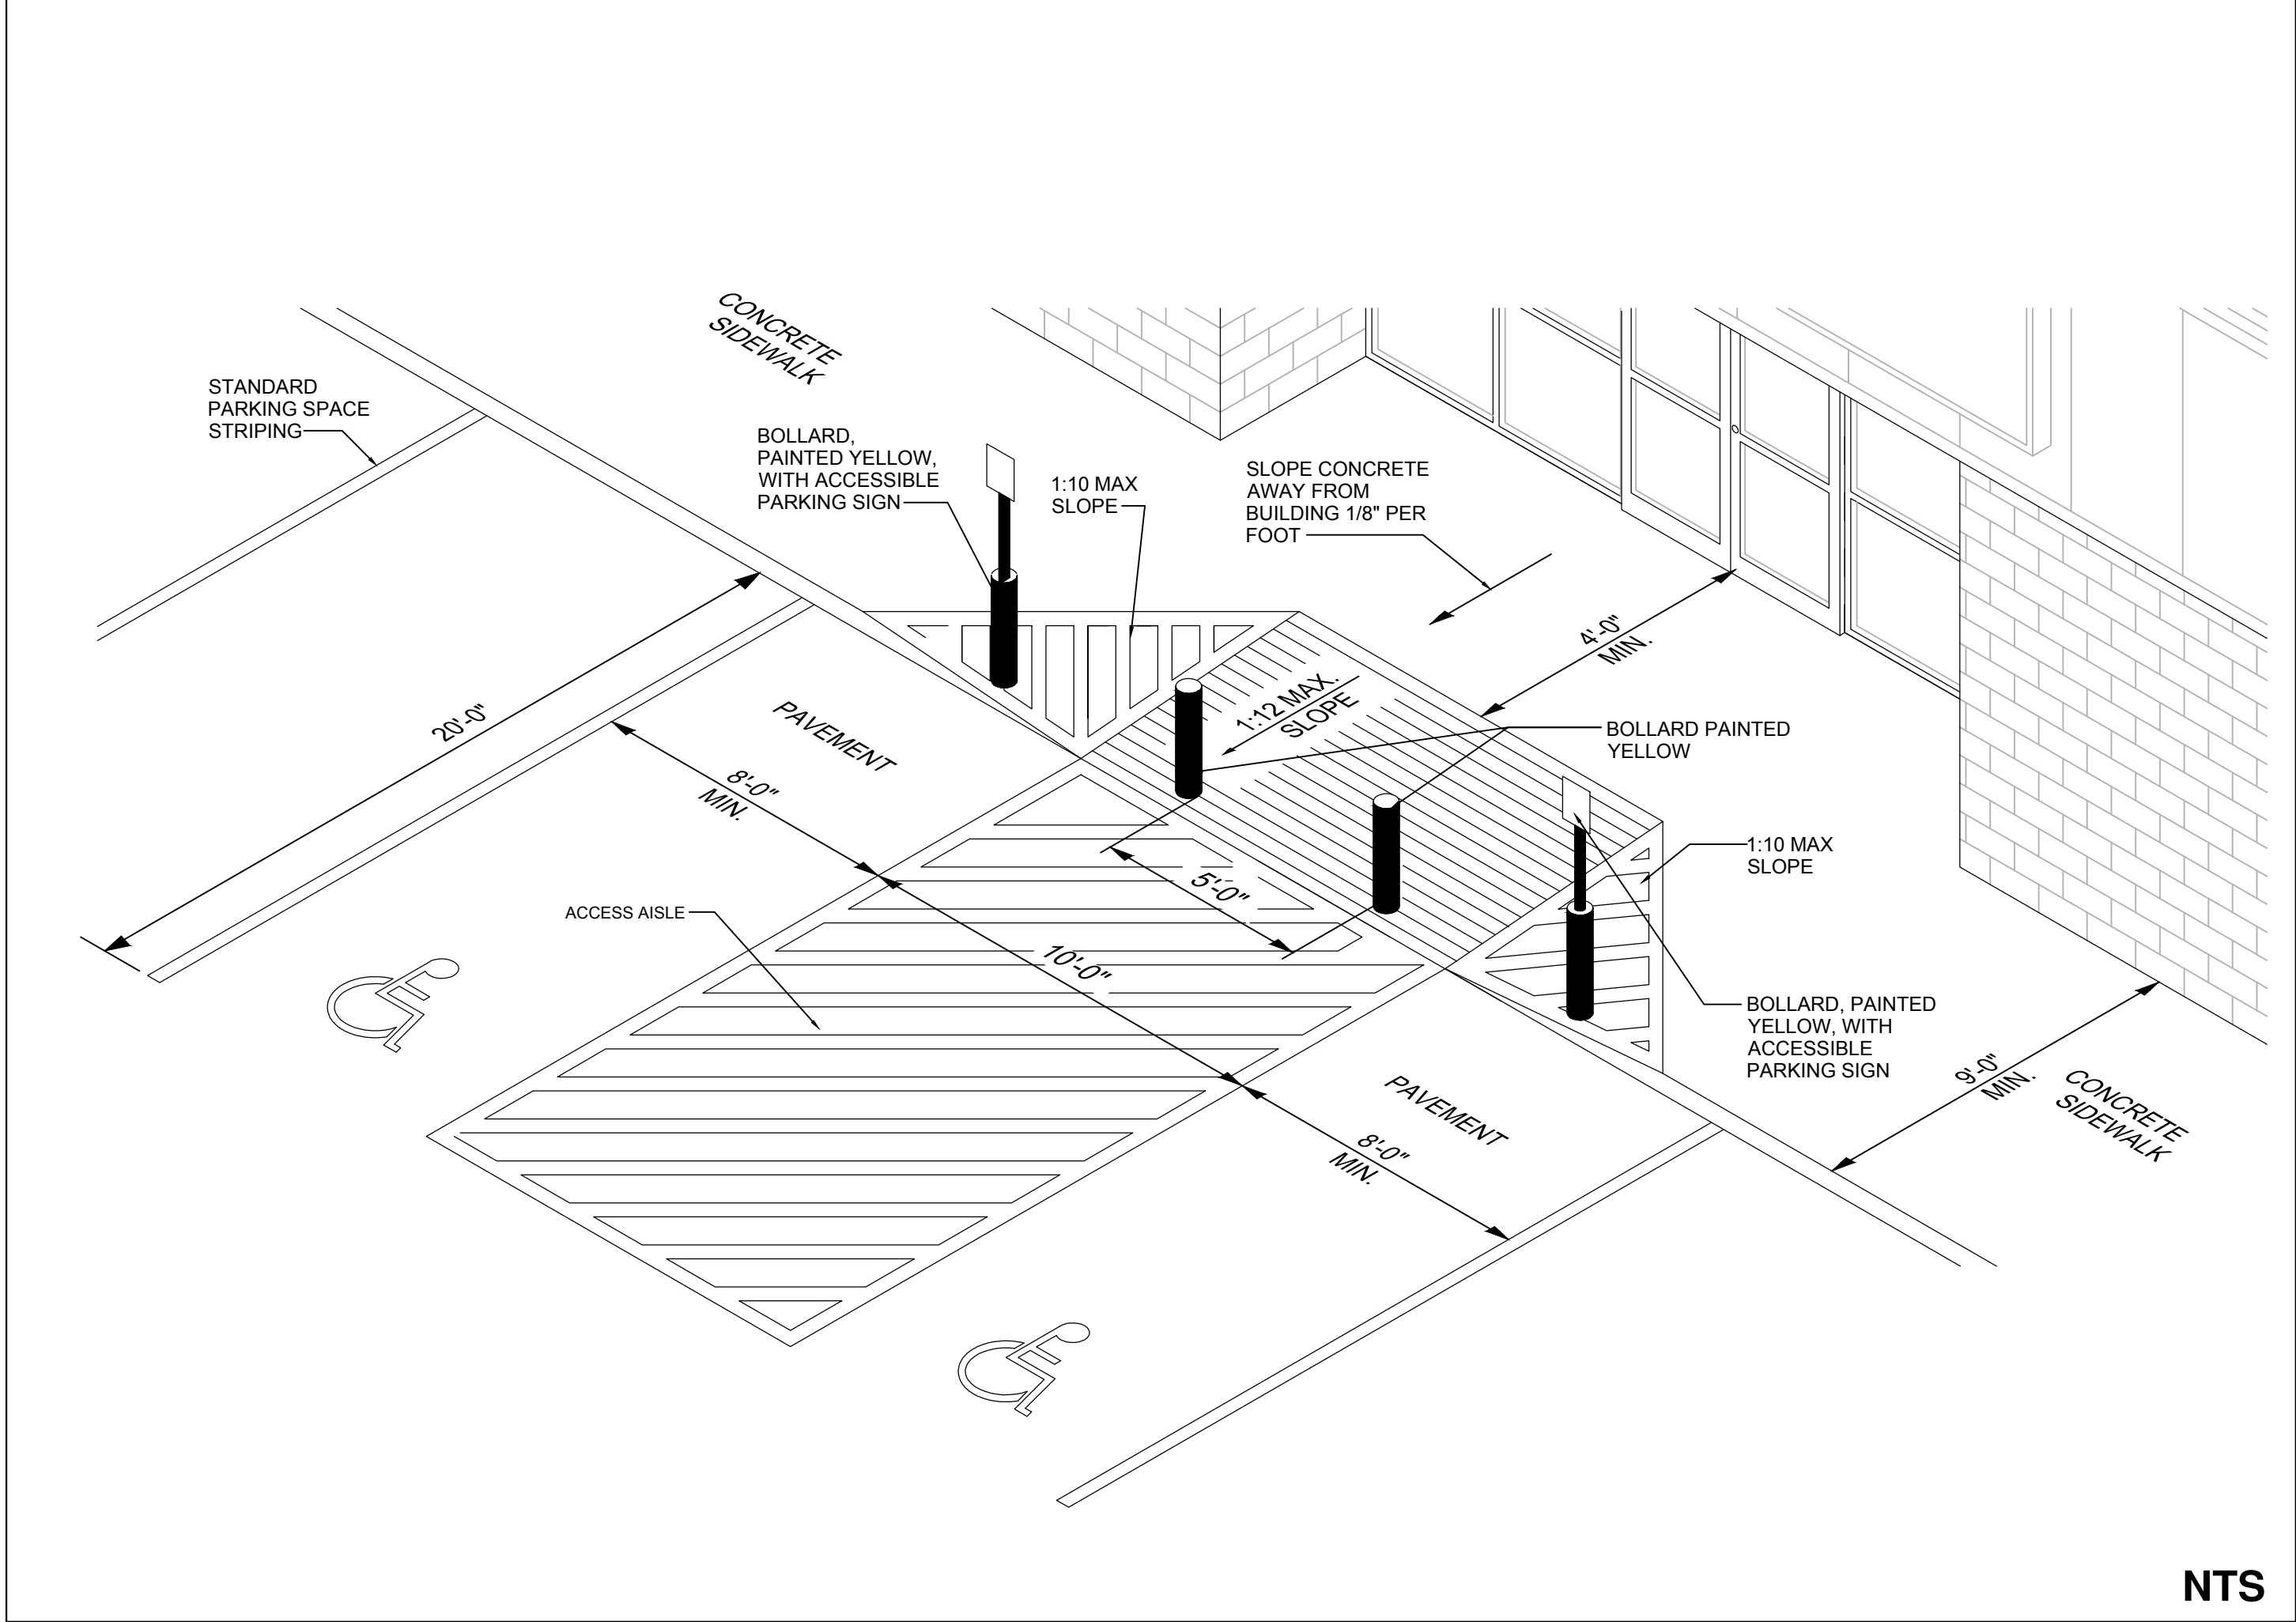

12 HANDICAP RAMP

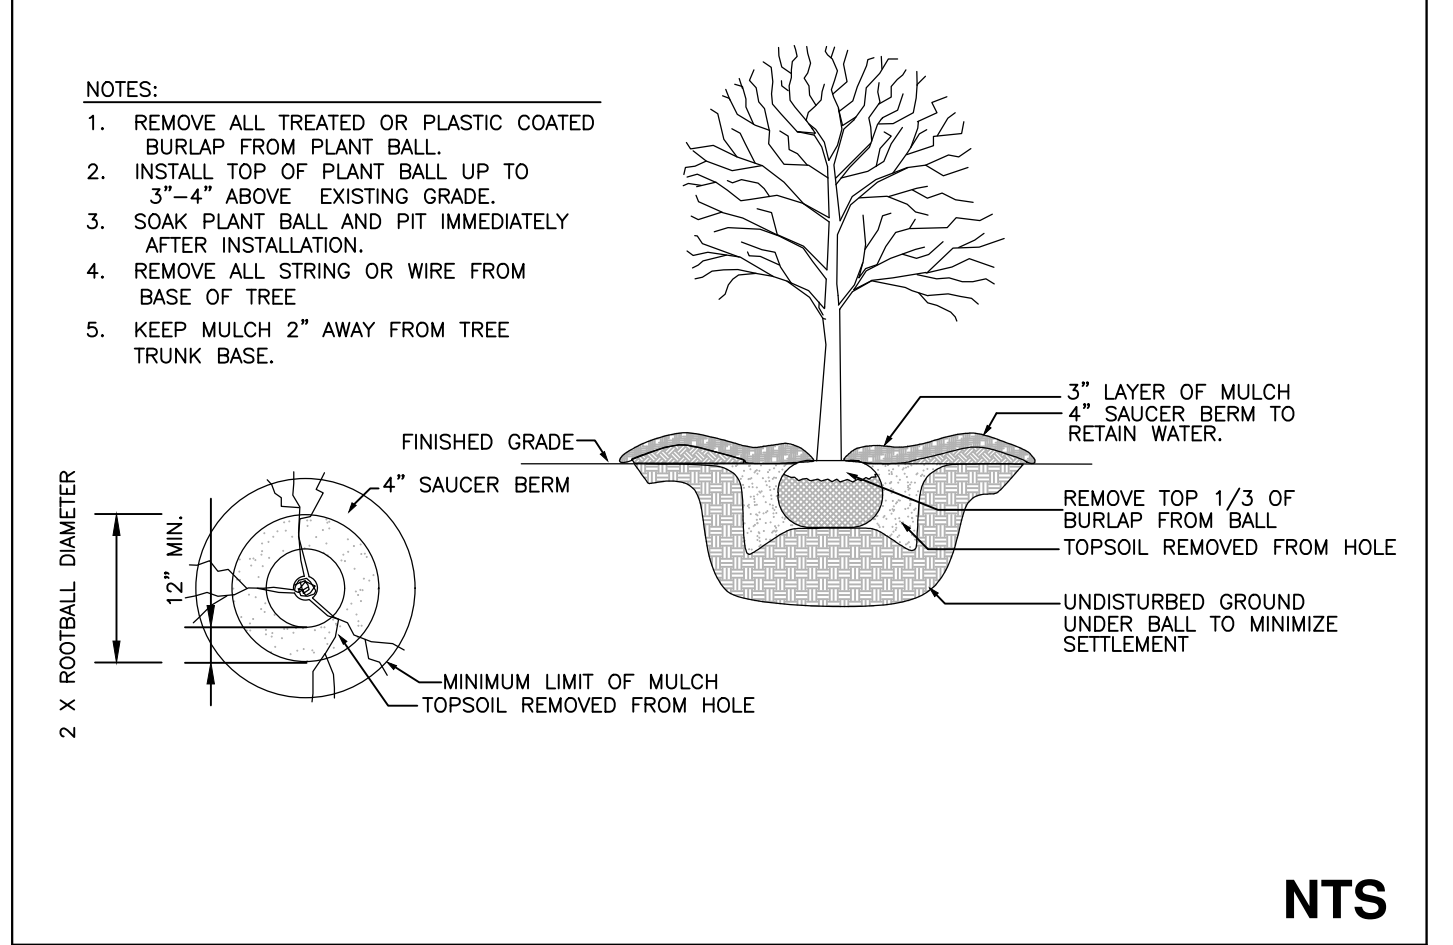

11 TREE PLANTING

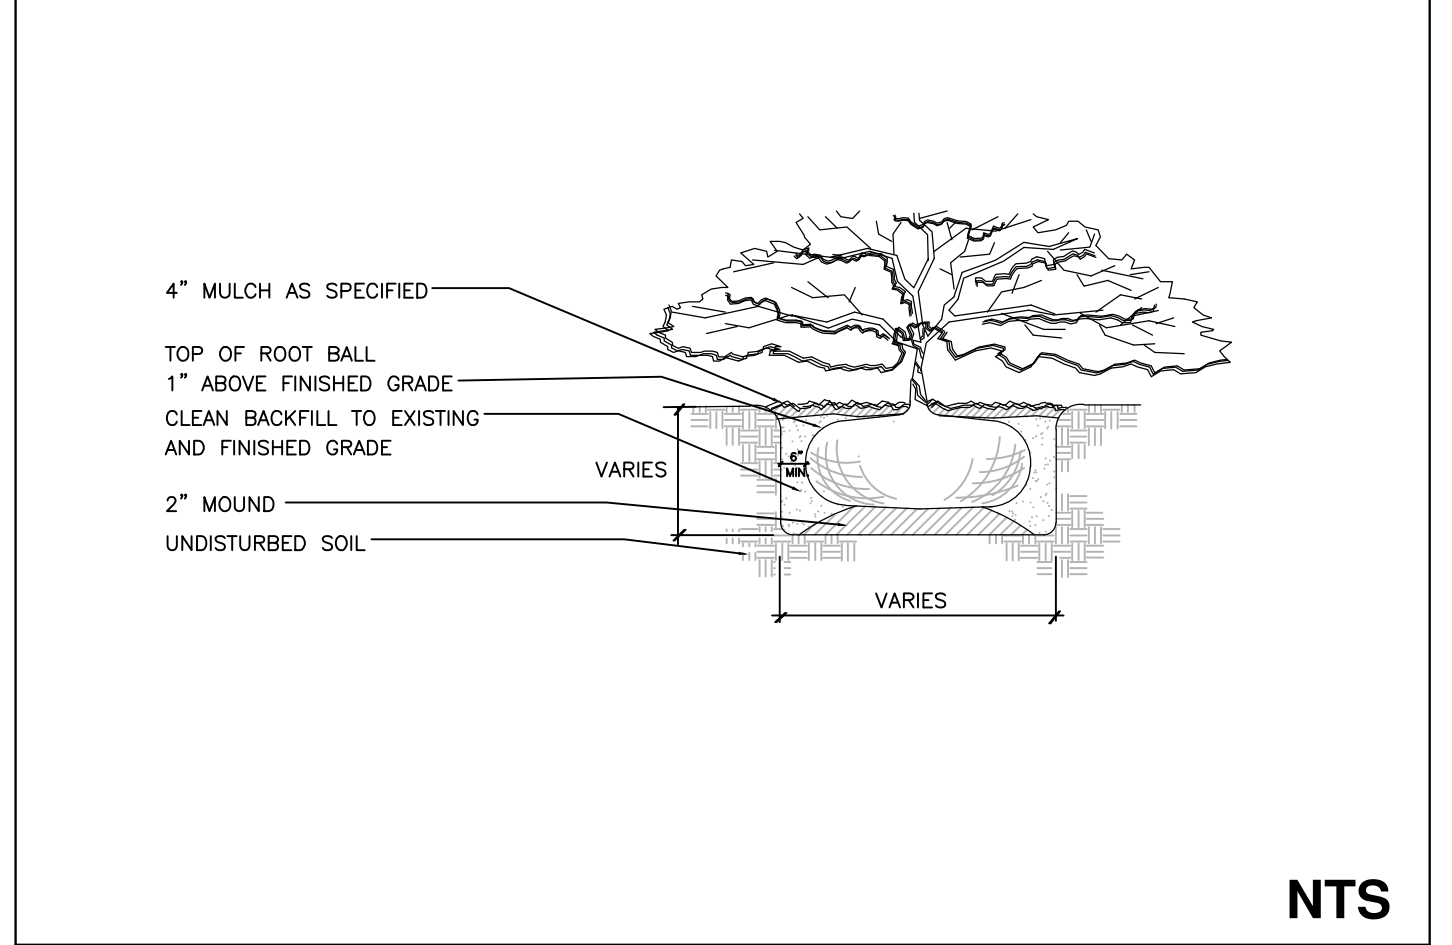

10 SHRUB PLANTING

1. Project Development/1644-Spring Lake Ray Rd. Dollar General/02/21/21-04/4/22/2021 10:22:21 AM



REVISIONS

NTS

PROJECT NAME

**SPRING LAKE
RAY ROAD
DOLLAR
GENERAL**

**SITE & EROSION
CONTROL
DETAILS**

CLIENT

**RHETSON
COMPANIES, INC**

2075 Juniper Lake Road
West End, North Carolina 27376
Phone: (910) 944-0881

PROJECT INFORMATION

DESIGNED BY:	SCOTT
DRAWN BY:	SCOTT
CHECKED BY:	CHRIS
PROJECT NUMBER:	1644

DRAWING SCALE


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DATE RELEASED


APRIL 22, 2021

SHEET NUMBER

C-6.1

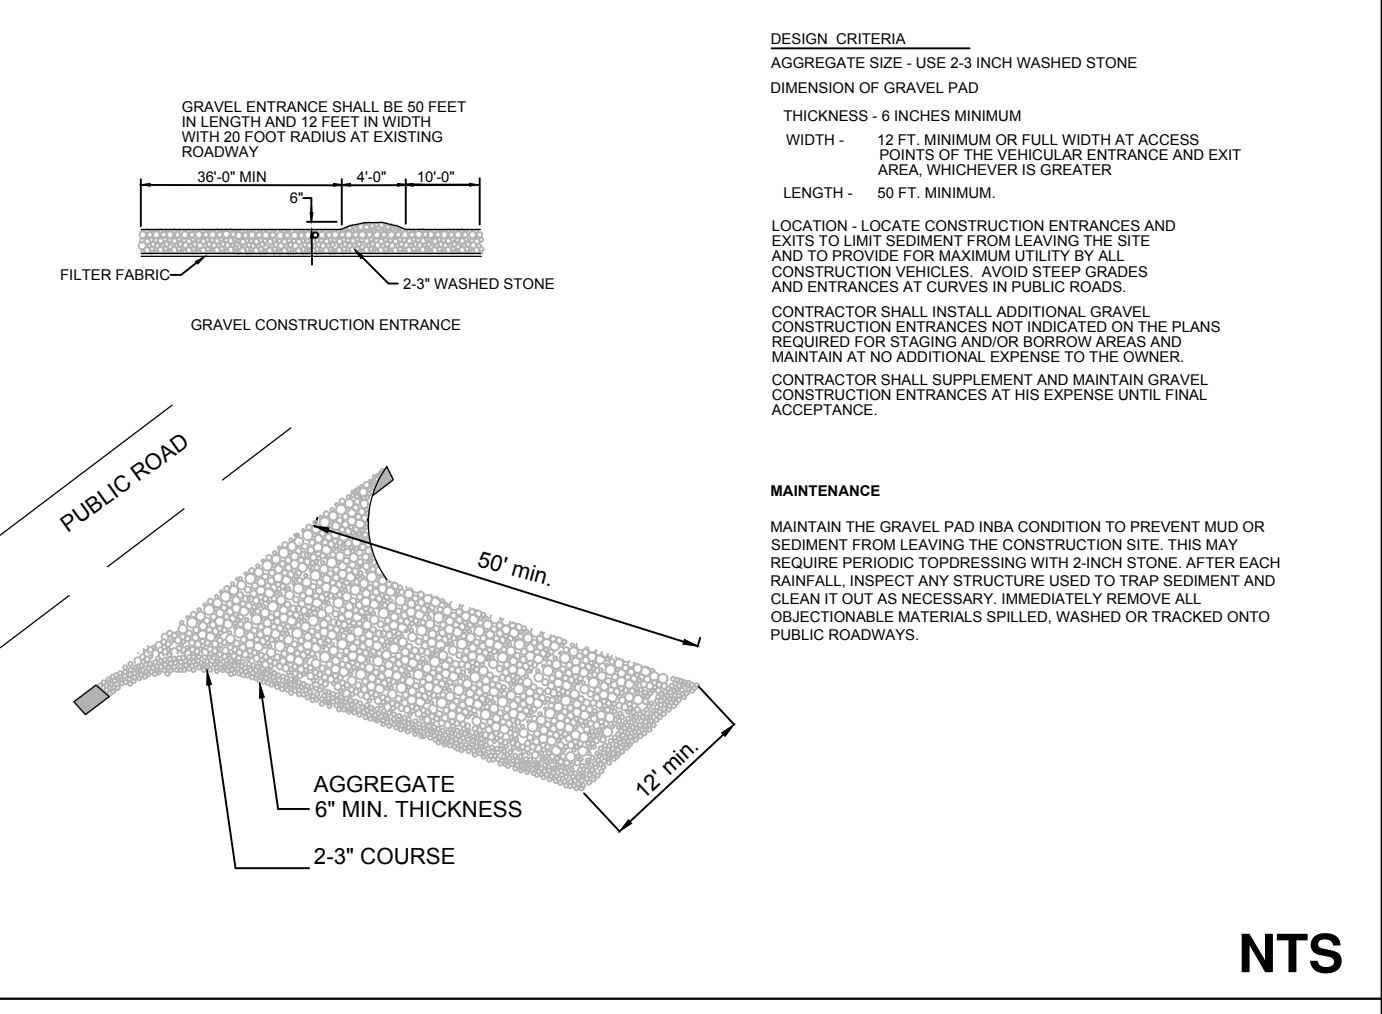

4 TEMPORARY GRAVEL CONSTRUCTION ENTRANCE

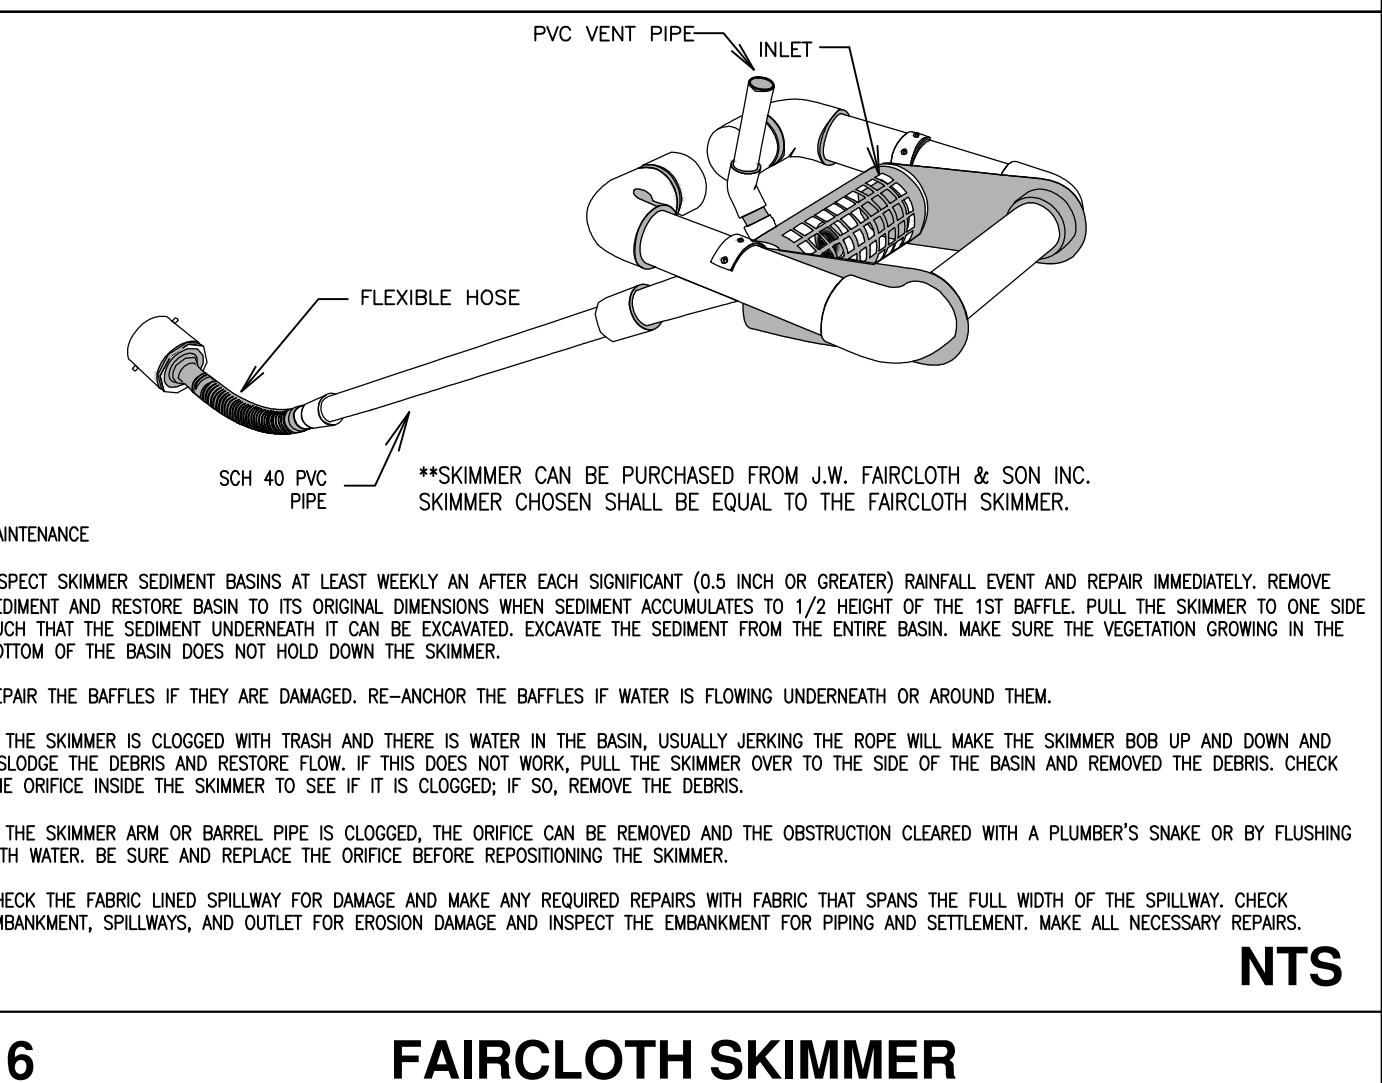

6 FAIRCLOTH SKIMMER

1. UNLESS OTHERWISE INDICATED, ALL VEGETATIVE AND STRUCTURAL EROSION AND SEDIMENT CONTROL MEASURES SHALL BE CONSTRUCTED AND MAINTAINED IN ACCORDANCE WITH THE MINIMUM STANDARDS AND SPECIFICATIONS OF THE NORTH CAROLINA EROSION AND SEDIMENT CONTROL HANDBOOK.

2. THE CONTRACTOR SHALL NOTIFY PLAN APPROVING AUTHORITY ONE WEEK PRIOR TO THE PRECONSTRUCTION CONFERENCE. ONE WEEK PRIOR TO THE COMMENCEMENT OF LAND DISTURBING ACTIVITY, AND ONE WEEK PRIOR TO FINAL INSPECTION.

3. IT IS POSSIBLE ALL EROSION AND SEDIMENT CONTROL MEASURES ARE TO BE PLACED PRIOR TO CLEARING AND/OR LAND DISTURBANCE.

4. A COPY OF THE APPROVED EROSION AND SEDIMENT CONTROL PLAN AND PERMIT SHALL BE MAINTAINED ON THE SITE AT ALL TIMES.

5. PRIOR TO COMMENCING LAND DISTURBING ACTIVITIES IN AREAS OTHER THAN INDICATED ON THESE PLANS INCLUDING BUT NOT LIMITED TO OFF-SITE BORROW OR WASTE AREAS, STAGING OR STORAGE AREAS, THE CONTRACTOR SHALL PREPARE AND SUBMIT A SUPPLEMENTARY EROSION CONTROL PLAN TO THE OWNER FOR REVIEW AND TO NECDER REGIONAL ENGINEER FOR APPROVAL. CONTRACTOR SHALL PAY ALL FEES REQUIRED AND SHALL INSTALL NECESSARY MEASURES AT HIS SEPARATE PAYMENT. THE CONTRACTOR SHALL PROVIDE THE OWNER AND THE ENGINEER A COPY OF THE AMENDED PERMIT.

6. THE CONTRACTOR IS RESPONSIBLE FOR INSTALLATION OF ANY ADDITIONAL EROSION CONTROL MEASURES NECESSARY TO PREVENT EROSION AND SEDIMENTATION AS DETERMINED BY EITHER NECDER OR THE ENGINEER.

7. ALL DISTURBED AREAS ARE TO DRAIN TO APPROVED SEDIMENT CONTROL MEASURES AT ALL TIMES DURING LAND DISTURBING ACTIVITIES AND DURING SITE DEVELOPMENT UNTIL FINAL STABILIZATION IS ACHIEVED.

8. ALL AREAS DISTURBED BY CONSTRUCTION UNLESS OTHERWISE IMPROVED SHALL BE SOODED OR SEEDED AS INDICATED AND STABILIZED.

9. DURING DEWATERING OPERATIONS, WATER SHALL BE PUMPED INTO AN APPROVED FILTERING DEVICE PRIOR TO DISCHARGE TO RECEIVING OUTLET.


10. THE CONTRACTOR SHALL INSPECT ALL EROSION CONTROL MEASURES WEEKLY AND AFTER EACH RAINOFF-PRODUCING EVENT. ANY NECESSARY REPAIRS OR CLEANUP TO MAINTAIN THE EFFECTIVENESS OF THE EROSION CONTROL DEVICES SHALL BE MADE IMMEDIATELY.

11. ALL TEMPORARY EROSION CONTROL MEASURES SHALL BE REMOVED BY CONTRACTOR ONCE STABILIZATION OF A SUFFICIENT GROUND COVER HAS BEEN ESTABLISHED OR AS DIRECTED BY THE ENGINEER. NECDER'S FINAL APPROVAL IS REQUIRED.

12. TEMPORARY GRAVEL CONSTRUCTION ENTRANCE SHALL BE REQUIRED AT ALL CONSTRUCTION STAGING AREA ENTRANCES AND ALL CONSTRUCTION ACCESS LOCATIONS INTO NON-PAVED AREA.

13. WHEN CROSSING CREEK OR DRAINAGE WAY, THE CONTRACTOR SHALL REPAIR WITH FABRIC DISTURBED BANKS AND CHANNEL AND RESTORE TO ORIGINAL CONDITIONS, BUT NOT STEEPER THAN 2:1 MAXIMUM. DISTURBED CREEK AREA SHALL BE STABILIZED IMMEDIATELY.

3 GENERAL EROSION AND SEDIMENT CONTROL NOTES

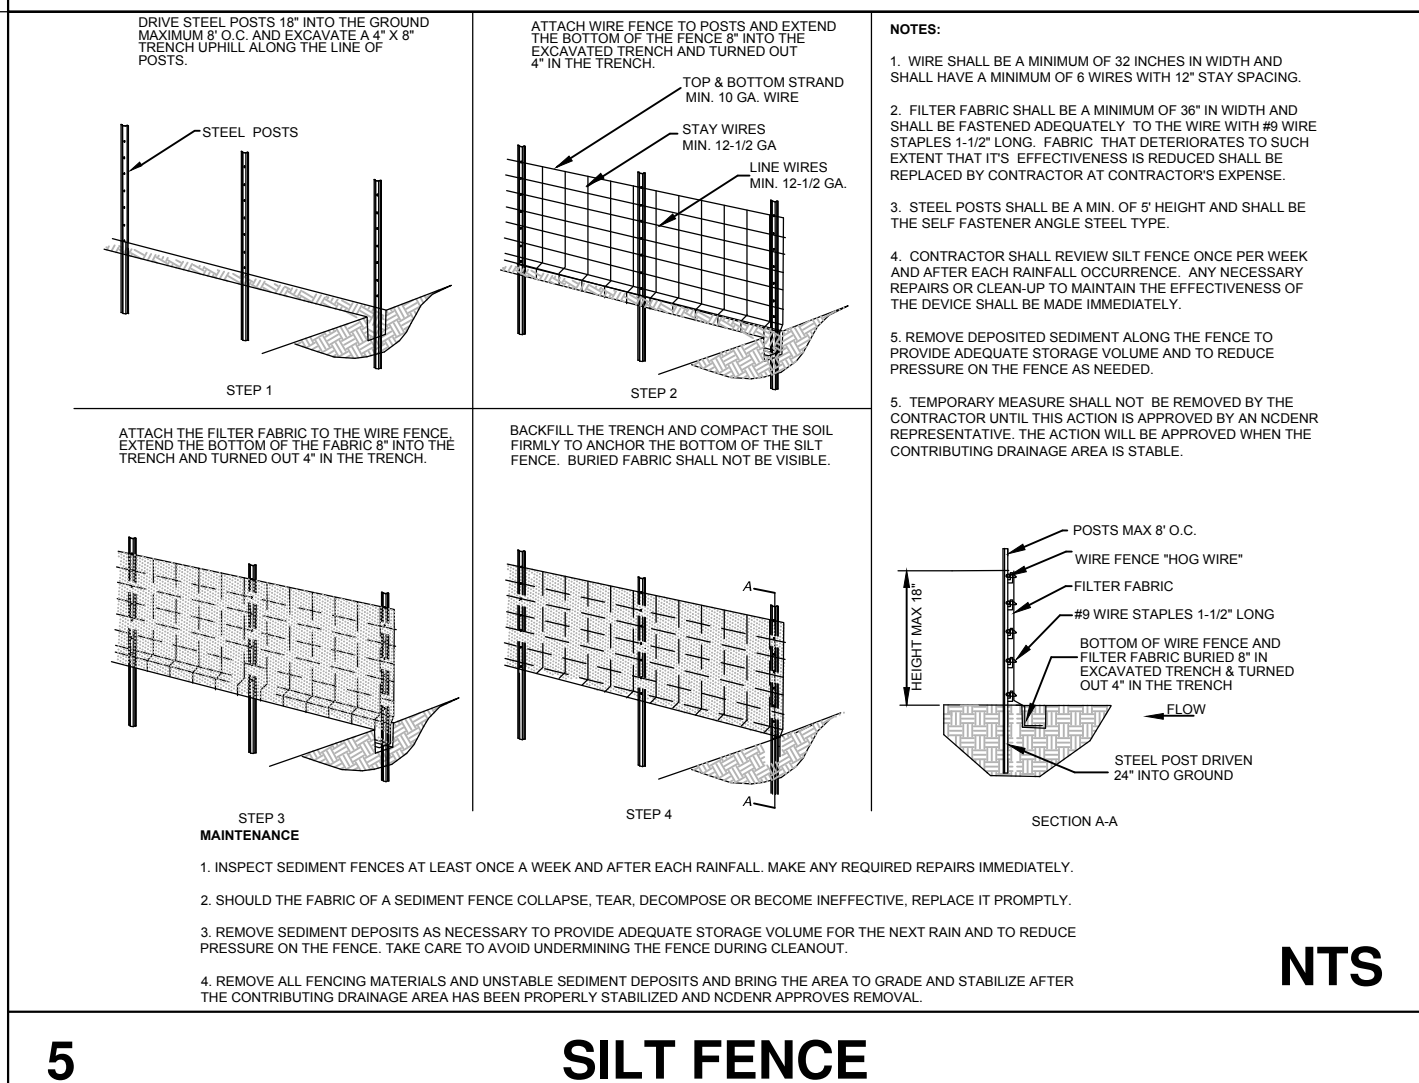

5 SILT FENCE

SEEDING SPECIFICATIONS

SEEDING MIXTURES:

SPECIES	RATE (LB./ACRE)
TALL FESCUE	80
PENSACOLA BAHIGRASS	50
SERICEA LESPEDEZA	30
KOBE LESPEDEZA	10

SEEDING NOTES:

- FROM SEPT. 1 TO MAR. 1: USE UNSCARIFIED SERICEA SEED.
- ON POORLY DRAINED SITES OMIT SERICEA AND INCREASE KOBE TO 30 LB./ACRE.
- WHERE A NEAT APPEARANCE IS DESIRED, OMIT SERICEA AND INCREASE KOBE TO 40 LB./ACRE.

NURSE PLANTS:

BETWEEN APRIL 15 AND AUG. 15, ADD 10 LB./ACRE OF GERMAN MILLET OR 15 LB./ACRE SUDAGRASS. PRIOR TO MAY 1 OR AFTER AUG. 15, ADD 25 LB./ACRE RYE (GRAIN).

SEEDING DATES:

EARLY SPRING	BEST	POSSIBLE
FEB. 15 - MAR. 20	FEB. 15 - APRIL 30	SEPT. 1 - SEPT. 31
FALL	SEPT. 1 - SEPT. 30	SEPT. 1 - OCT. 31

SOIL AMENDMENTS:

APPLY LIME AND FERTILIZER ACCORDING TO SOIL TEST, OR APPLY 3,000 - 5,000 LB./ACRE GROUND AGRICULTURAL LIMESTONE (USE THE LOWER RATE ON SANDY SOILS) AND 1,000 LB./ACRE 10-10-10 FERTILIZER.

MULCH:

APPLY 4,000 LB./ACRE GRAIN STRAW OR EQUIVALENT COVER OF ANOTHER SUITABLE MULCH. ANCHOR STRAW BY TACKLING WITH ASPHALT, NETTING, OR ROVING OR BY CRIMPING WITH A MULCH ANCHORING TOOL. A DISK WITH BLADES SET NEARLY STRAIGHT CAN BE USED AS A MULCH ANCHORING TOOL.

MAINTENANCE:

IF GROWTH IS LESS THAN FULLY ADEQUATE, RESEED, REFERTILIZE AND MULCH IMMEDIATELY FOLLOWING EROSION OR OTHER DAMAGE.

SEEDING SPECIFICATIONS

SEEDING MIXTURE:

SPECIES	RATE (LB./ACRE)
COMMON BERMUDDAGRASS	40-80(1-2 LB./1,000 FT ²)

SEEDING DATES:

COASTAL PLAIN: APR. - JULY

SOIL AMENDMENTS:

APPLY LIME AND FERTILIZER ACCORDING TO SOIL TEST, OR APPLY 3,000 LB./ACRE GROUND AGRICULTURAL LIMESTONE AND 500 LB./ACRE 10-10-10 FERTILIZER.

MULCH:


USE JUTE, EXCELSION MATTING, OR OTHER EFFECTIVE CHANNEL LINING MATERIAL TO COVER THE BOTTOM OF CHANNELS AND DITCHES. THE LINING SHOULD EXTEND ABOVE THE HIGHEST CALCULATED DEPTH OF FLOW. ON CHANNEL SIDE SLOPES ABOVE THIS HEIGHT, AND IN DRAINAGES NOT REQUIRING TEMPORARY LININGS, APPLY 4,000 LB./ACRE GRAIN STRAW AND ANCHOR STRAW BY STAPLING NETTING OVER THE TOP.

MULCH AND ANCHORING MATERIALS MUST NOT BE ALLOWED TO WASH DOWN SLOPES WHERE THEY CAN CLOG DRAINAGE DEVICES.


MAINTENANCE:

A MINIMUM OF 3 WEEKS IS REQUIRED FOR ESTABLISHMENT. INSPECTION AND REPAIR MULCH FREQUENTLY. REFERTILIZE THE FOLLOWING APR. WITH 50 LB./ACRE NITROGEN.

2 PERMANENT SEEDING SPECIFICATIONS

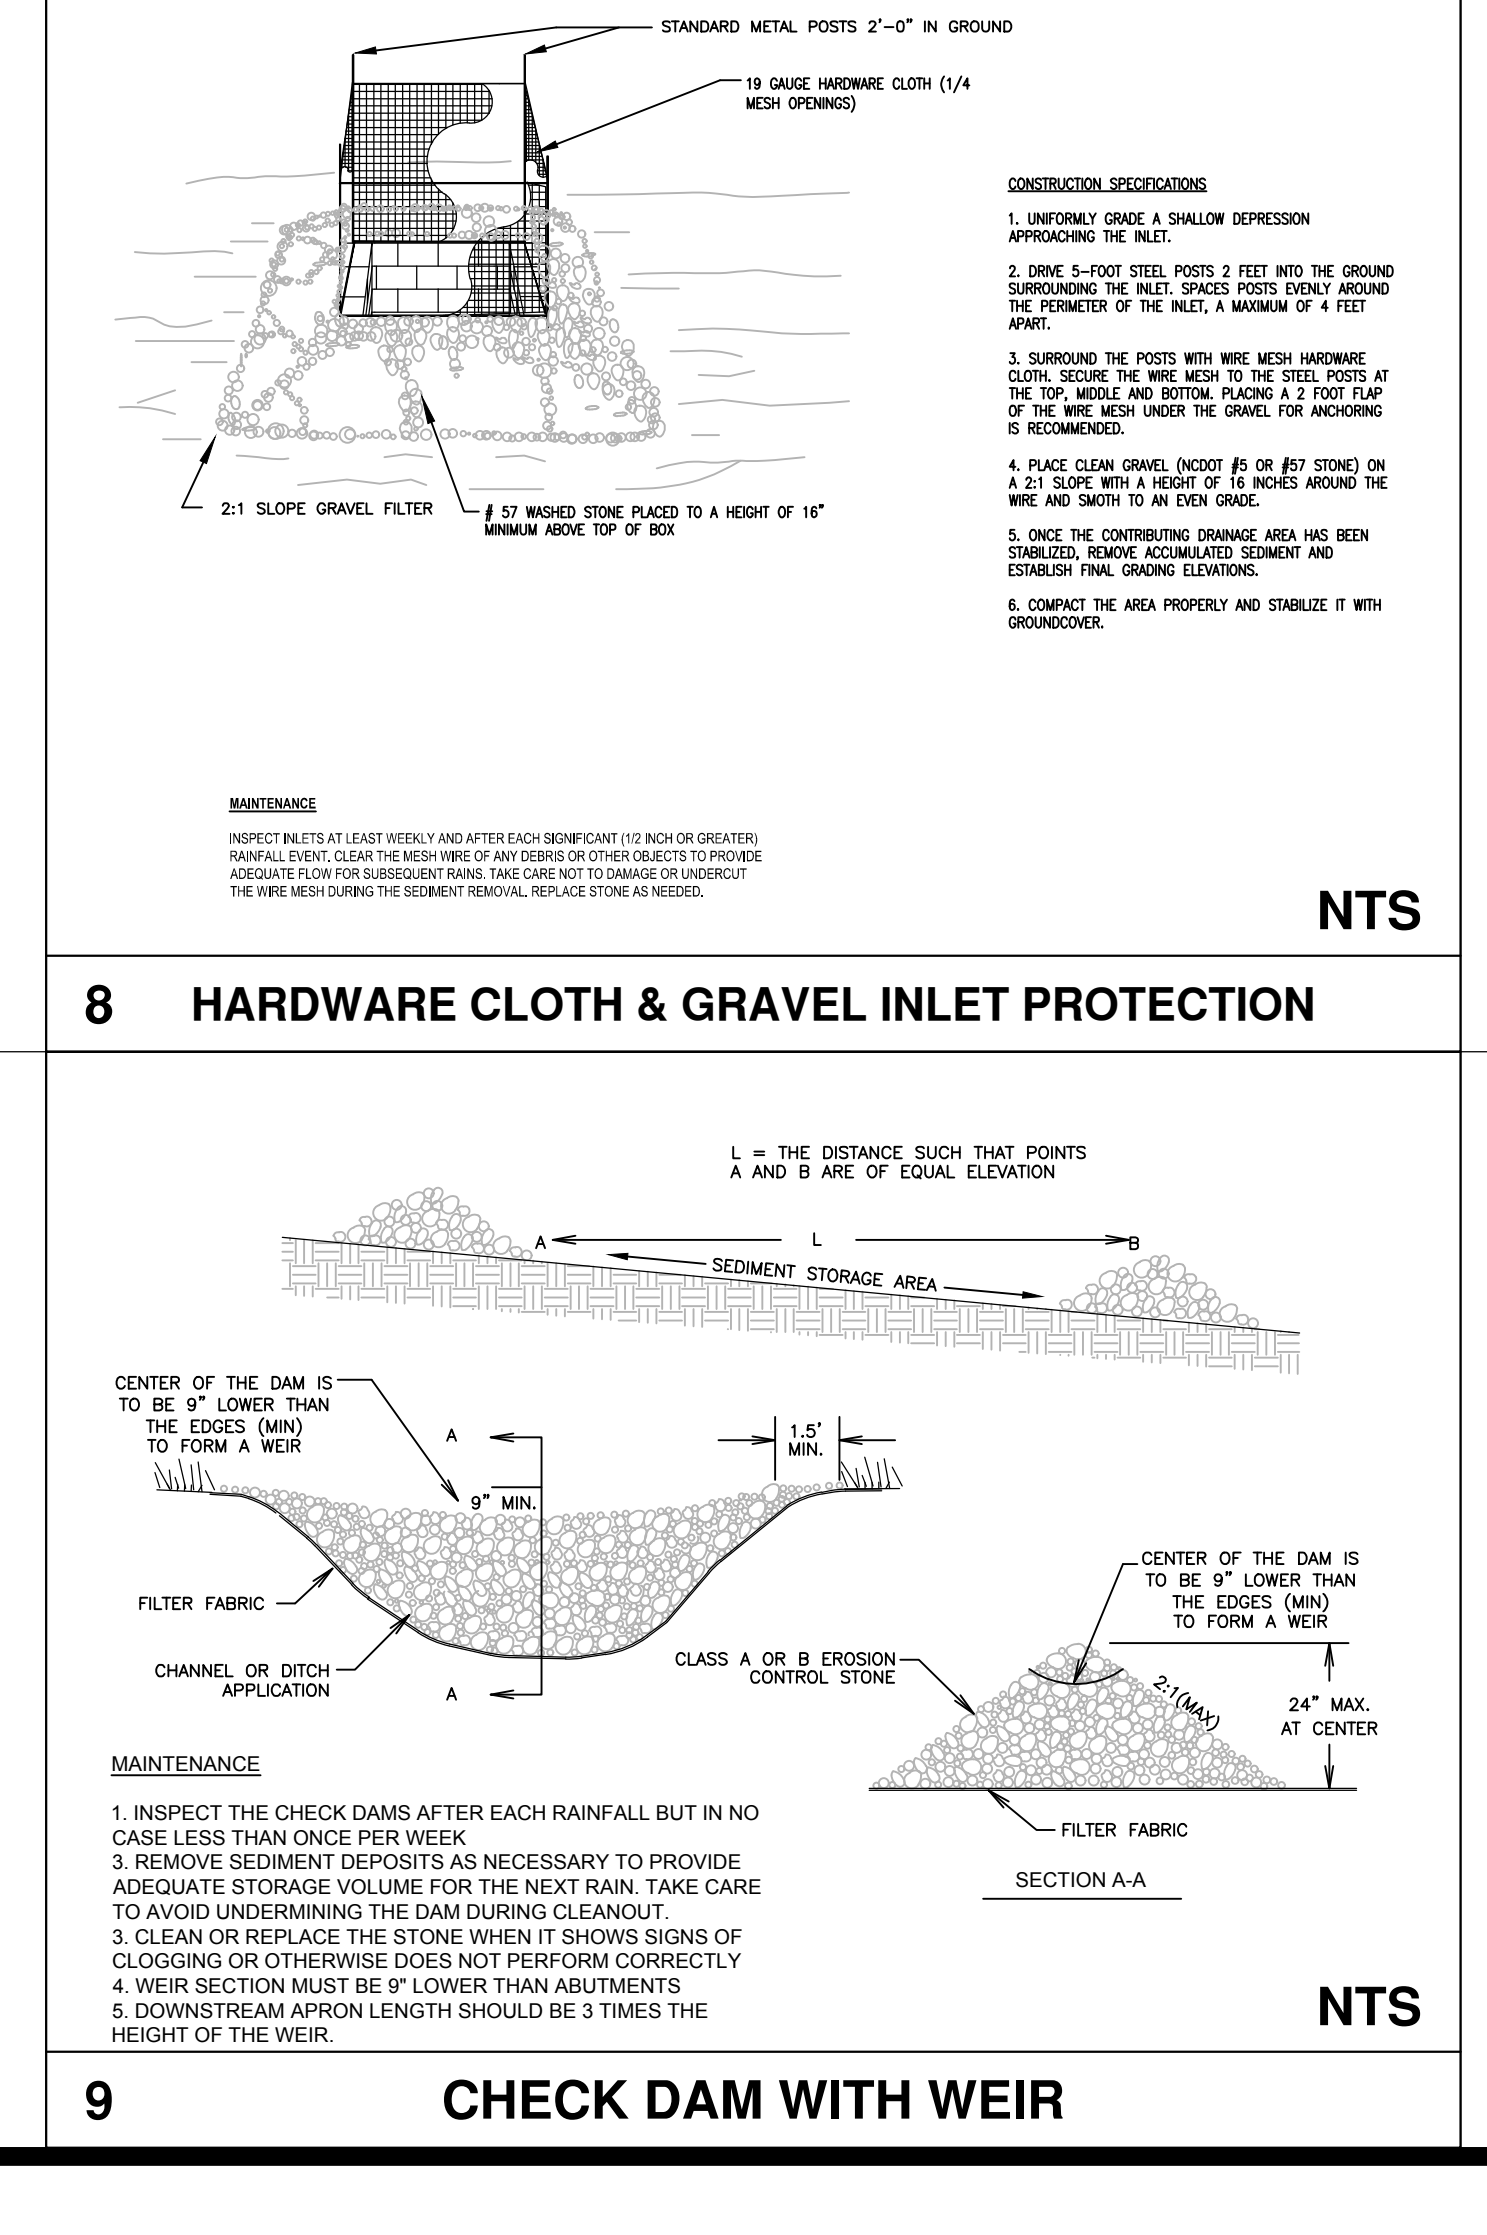

8 HARDWARE CLOTH & GRAVEL INLET PROTECTION

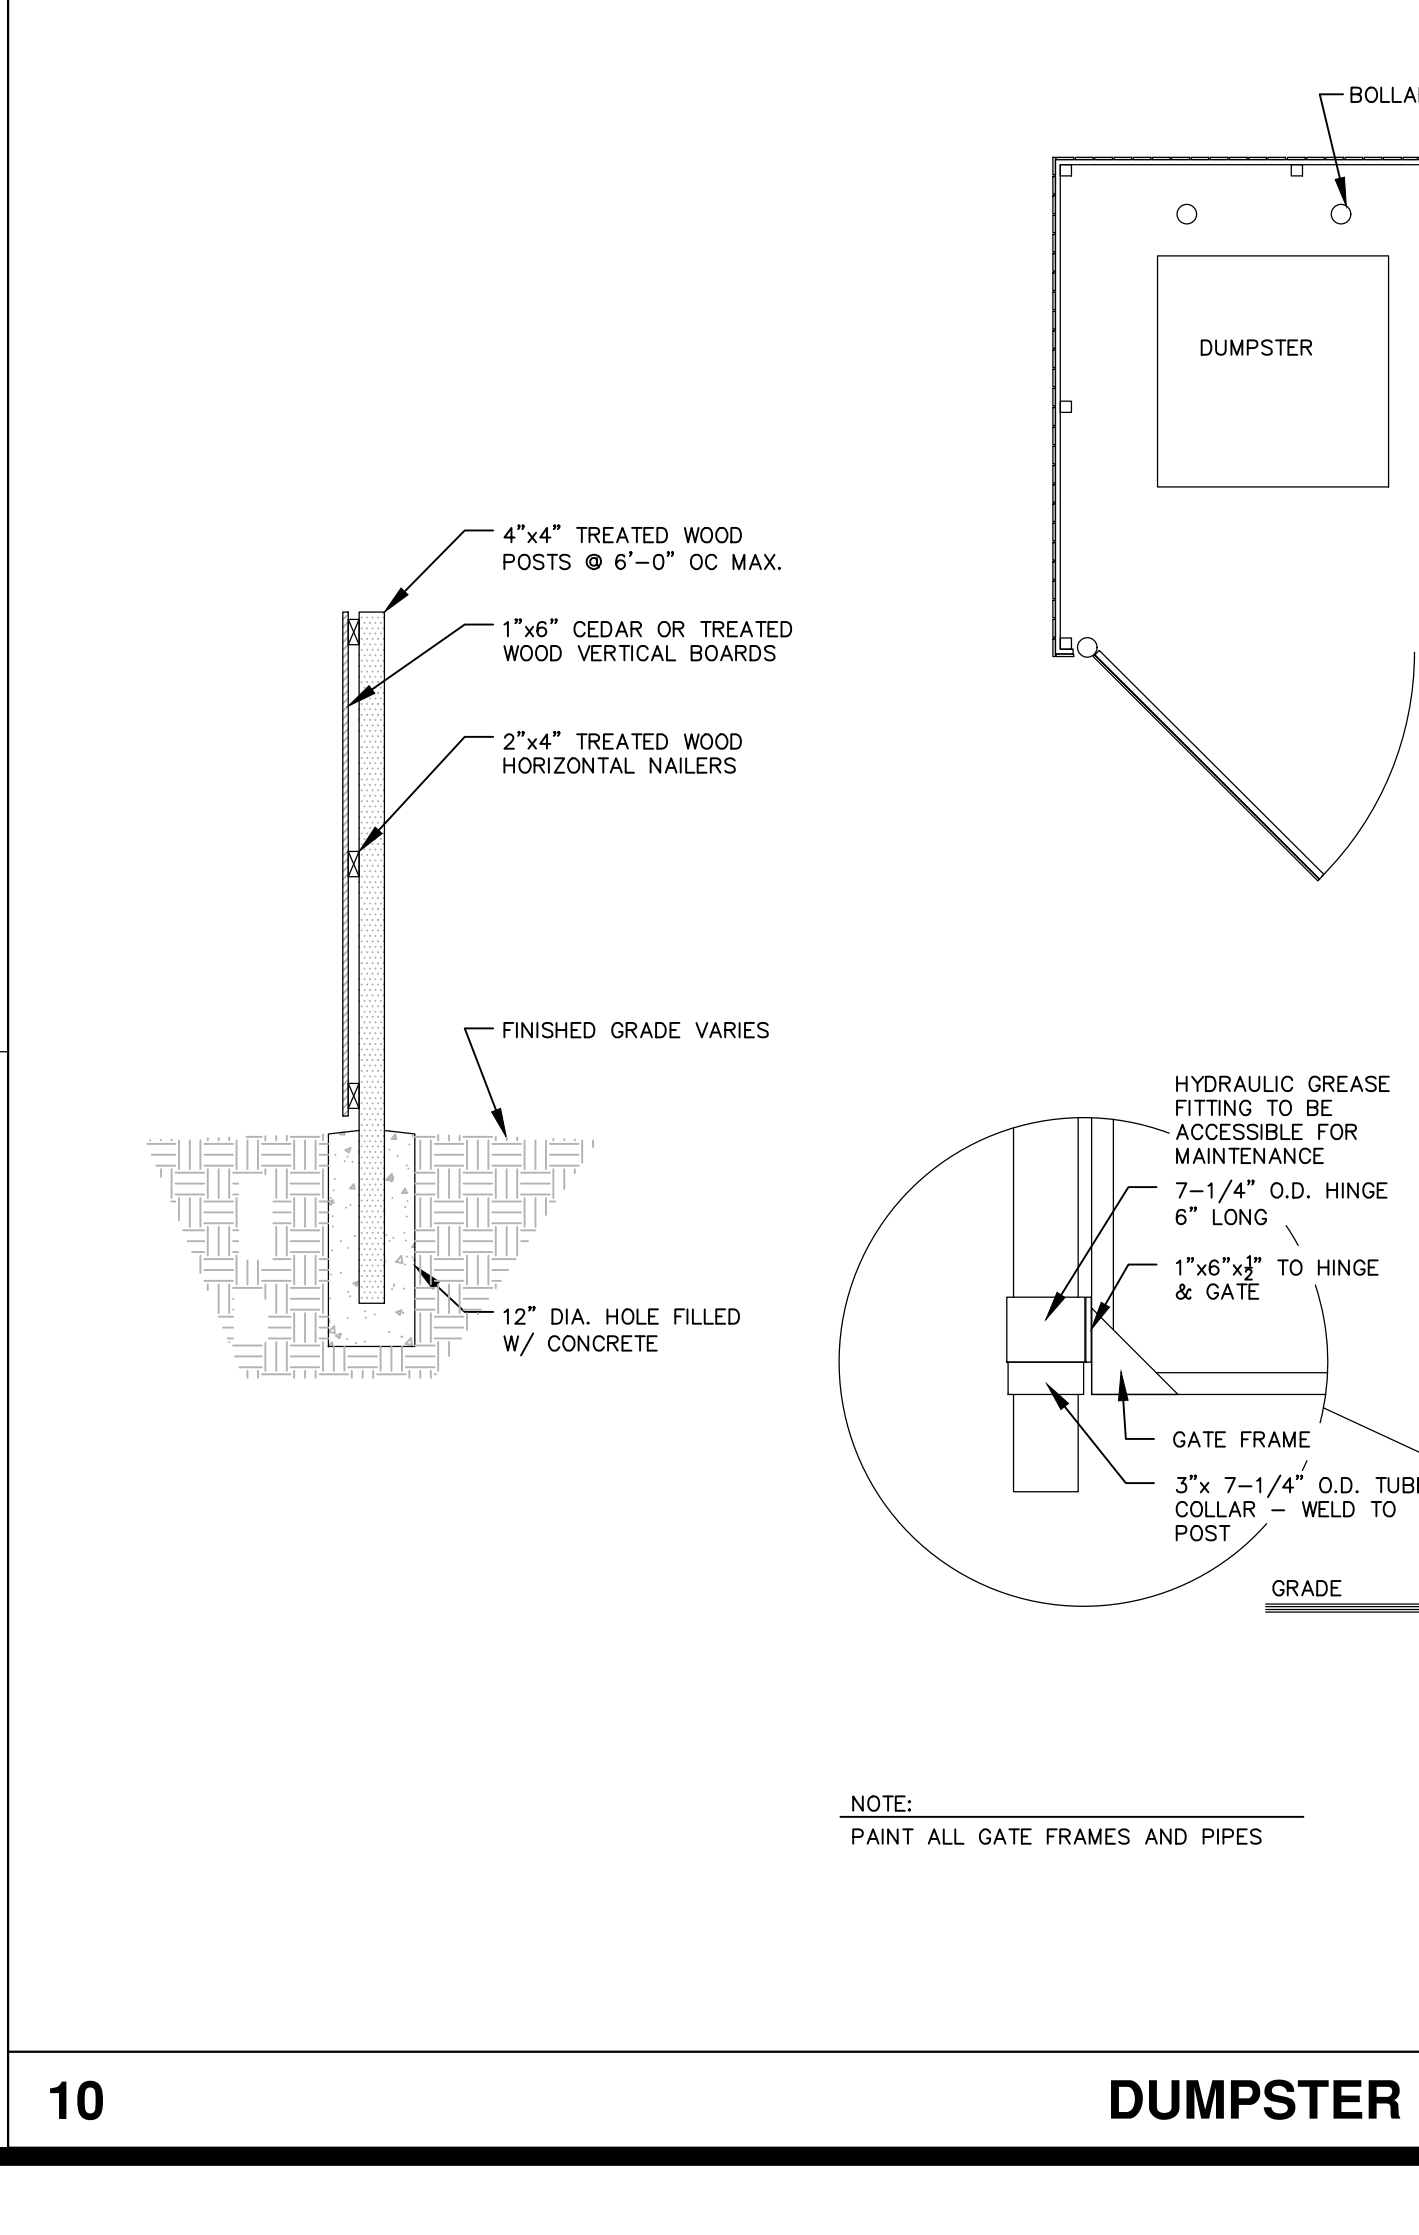

5 DUMPSTER ENCLOSURE

TEMPORARY SEEDING/MULCHING SPECIFICATIONS (FOR LATE WINTER AND EARLY SPRING)

SEEDING MIXTURE:

SPECIES	RATE (LB./ACRE)
RYE (GRAIN)	120
ANNUAL KOBE LESPEDEZA	50

OMIT ANNUAL LESPEDEZA WHEN DURATION OF TEMPORARY COVER IS NOT EXTEND BEYOND JUNE.

SEEDING DATES:

JANUARY 1 - MAY 1

SOIL AMENDMENTS:

FOLLOW RECOMMENDATIONS OF SOIL TESTS OR APPLY 2,000 LB./ACRE GROUND AGRICULTURAL LIMESTONE AND 750 LB./ACRE 10-10-10 FERTILIZER.

MULCH:

APPLY 4,000 LB./ACRE STRAW. ANCHOR STRAW BY TACKLING WITH ASPHALT, NETTING, OR A MULCH ANCHORING TOOL. A DISK WITH BLADES SET NEARLY STRAIGHT CAN BE USED AS A MULCH ANCHORING TOOL.

MAINTENANCE:

REFERTILIZE IF GROWTH IS NOT FULLY ADEQUATE. RESEED, REFERTILIZE AND MULCH IMMEDIATELY FOLLOWING EROSION OR OTHER DAMAGE.

TEMPORARY SEEDING/MULCHING SPECIFICATIONS (FOR SUMMER)

SEEDING MIXTURE:

SPECIES	RATE (LB./ACRE)
GERMAN MILLET	40

A SMALL-STEMMED SUDAGRASS MAY BE SUBSTITUTED AT A RATE OF 50 LB./ACRE.

SEEDING DATES:

MAY 1 - AUGUST 15

SOIL AMENDMENTS:

FOLLOW RECOMMENDATIONS OF SOIL TESTS OR APPLY 2,000 LB./ACRE GROUND AGRICULTURAL LIMESTONE AND 750 LB./ACRE 10-10-10 FERTILIZER.

MULCH:

APPLY 4,000 LB./ACRE STRAW. ANCHOR STRAW BY TACKLING WITH ASPHALT, NETTING, OR A MULCH ANCHORING TOOL. A DISK WITH BLADES SET NEARLY STRAIGHT CAN BE USED AS A MULCH ANCHORING TOOL.

MAINTENANCE:

REFERTILIZE IF GROWTH IS NOT FULLY ADEQUATE. RESEED, REFERTILIZE AND MULCH IMMEDIATELY FOLLOWING EROSION OR OTHER DAMAGE.

TEMPORARY SEEDING/MULCHING SPECIFICATIONS (FOR FALL)

SEEDING MIXTURE:

SPECIES	RATE (LB./ACRE)
RYE (GRAIN)	120

SEEDING DATES:

AUGUST 15 - DECEMBER 30

SOIL AMENDMENTS:

FOLLOW RECOMMENDATIONS OF SOIL TESTS OR APPLY 2,000 LB./ACRE GROUND AGRICULTURAL LIMESTONE AND 1,000 LB./ACRE 10-10-10 FERTILIZER.


MULCH:

APPLY 4,000 LB./ACRE STRAW. ANCHOR STRAW BY TACKLING WITH ASPHALT, NETTING, OR A MULCH ANCHORING TOOL. A DISK WITH BLADES SET NEARLY STRAIGHT CAN BE USED AS A MULCH ANCHORING TOOL.

MAINTENANCE:

REPAIR AND REFERTILIZE DAMAGED AREAS IMMEDIATELY. TOP DRESS WITH 50 LB./ACRE OF NITROGEN IN MARCH. IF IT IS NECESSARY TO EXTEND TEMPORARY COVER BEYOND JUNE 15, OVERSEED WITH 50 LB./ACRE KOBE LESPEDEZA IN LATE OR EARLY MARCH.

1 TEMPORARY SEEDING SPECIFICATIONS

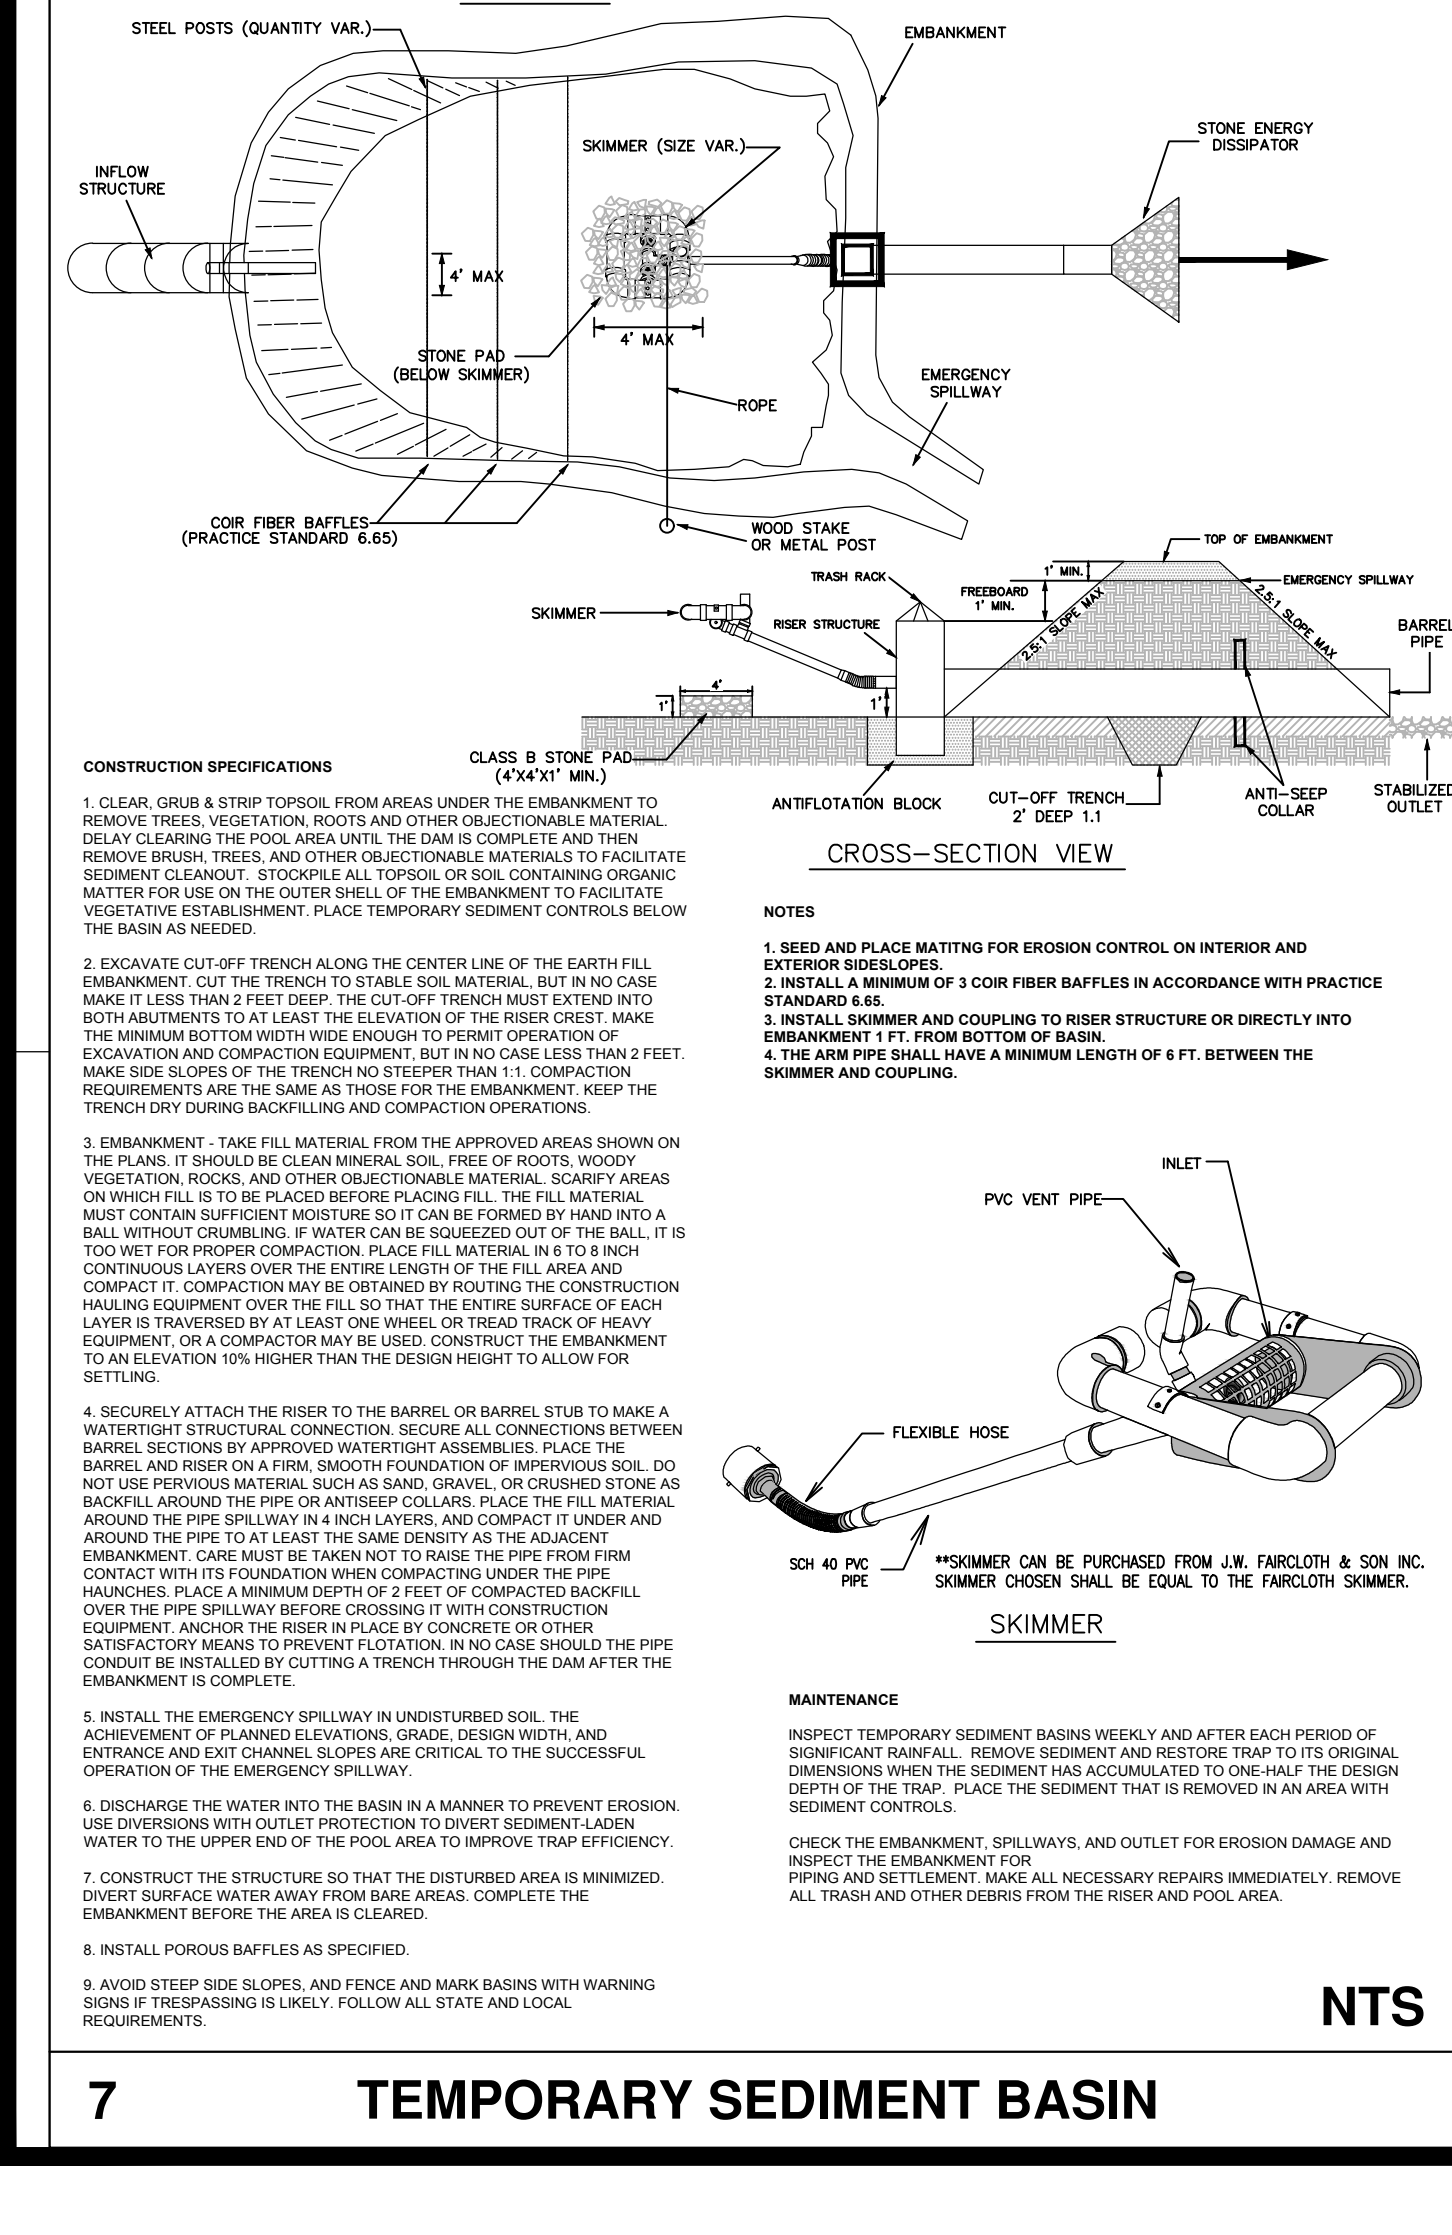

7 TEMPORARY SEDIMENT BASIN

1 SKIMMER



REVISIONS

PROJECT NAME

**SPRING LAKE
RAY ROAD
DOLLAR
GENERAL**

**EROSION
CONTROL
DETAILS**

CLIENT

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2075 Juniper Lake Road
West End, North Carolina 27376
Phone: (910) 944-0881

PROJECT INFORMATION

DESIGNED BY:	SCOTT
DRAWN BY:	SCOTT
CHECKED BY:	CHRIS
PROJECT NUMBER:	1644

DRAWING SCALE

NOT TO SCALE

DATE RELEASED

APRIL 22, 2021


SHEET NUMBER

C-6.2

GROUND STABILIZATION CHART


SITE AREA DESCRIPTION	STABILIZATION TIME FRAME	STABILIZATION TIME FRAME EXCEPTIONS
PERIMETER DIKES, SWALES, DITCHES AND SLOPES	7 DAYS	NONE
HIGH QUALITY WATER (HOW) ZONES	7 DAYS	NONE
SLOPES STEEPER THAN 3:1	7 DAYS	IF SLOPES ARE 10' OR LESS IN LENGTH AND ARE NOT STEEPER THAN 2:1, 14 DAYS ARE ALLOWED
SLOPES 3:1 OR FLATTER	14 DAYS	7-DAYS FOR SLOPES GREATER THAN 50 FEET IN LENGTH
ALL OTHER AREAS WITH SLOPES FLATTER THAN 4:1	14 DAYS	NONE (EXCEPT FOR PERIMETERS AND HOW ZONES)

4 GROUND STABILIZATION CHART

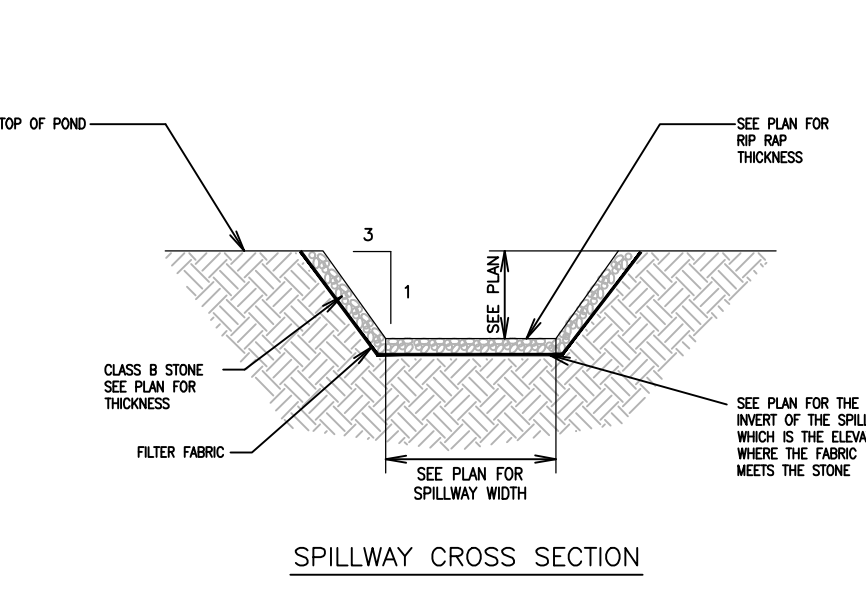


- INSTALL THE EMERGENCY SPILLWAY IN UNDISTURBED SOIL. THE ACHIEVEMENT OF PLANNED ELEVATIONS, GRADE, DESIGN WIDTH, AND ENTRANCE AND EXIT CHANNEL SLOPES ARE CRITICAL TO THE SUCCESSFUL OPERATION OF THE EMERGENCY SPILLWAY.
- ALTERNATIVE MATERIALS MAY BE USED OTHER THAN THE SPECIFIED STONE IF APPROVED BY THE DESIGN ENGINEER.
- MAX SIDE SLOPES ARE 3:1

7 EMERGENCY SPILLWAY

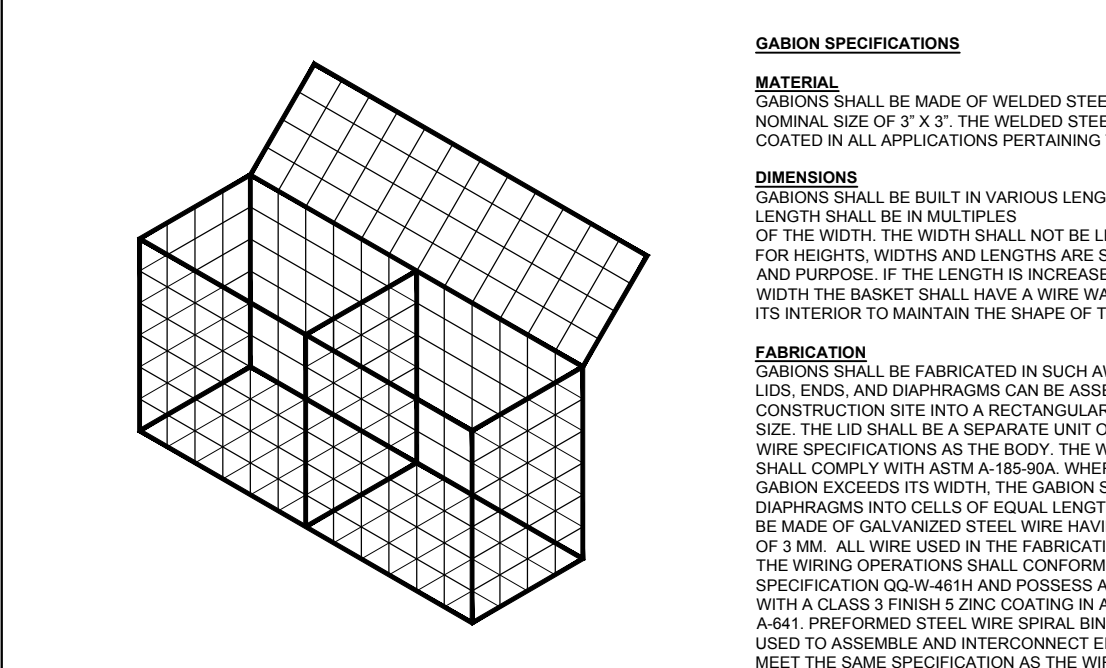



- GABION INSPECTION AND MAINTENANCE**
- GABIONS REQUIRE LITTLE MAINTENANCE. GABIONS CAN REMAIN AS PERMANENT STRUCTURES AFTER CONSTRUCTION PHASES ARE COMPLETE.
- INSPECT REGULARLY AND AFTER STORM EVENTS
 - INSPECT FOR UNDERCUTTING AND OTHER SIGNS OF STABILITY
 - INSPECT WIRE MESHES AND MATRESSES FOR SIGNS OF DEGRADATION, RUST AND BREAKAGE.
 - REPAIR OR REPLACE IMMEDIATELY TO MAINTAIN ENGINEERED PERFORMANCE STANDARDS.

11 GABION BAFFLE

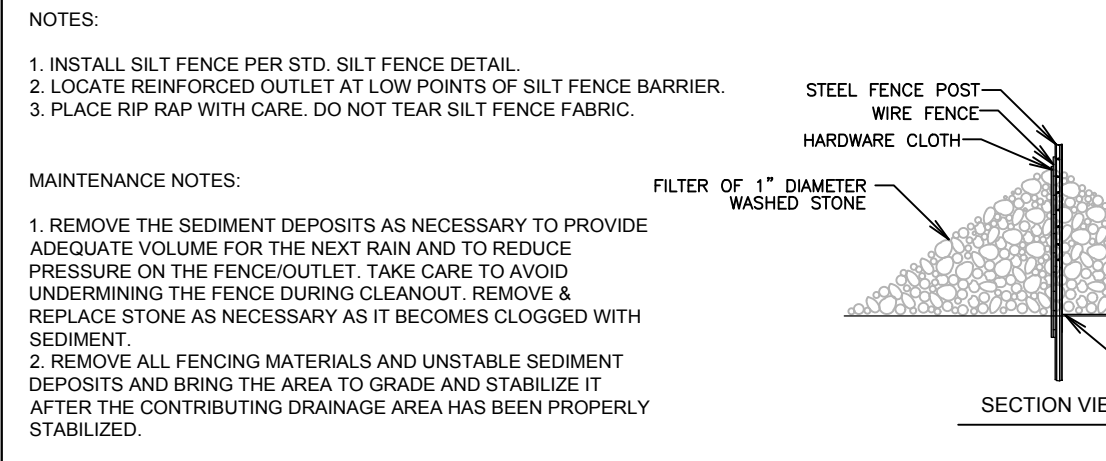

- NOTES:
- INSTALL SILT FENCE PER STD. SILT FENCE DETAIL.
 - LOCATE REINFORCED OUTLET AT LOW POINTS OF SILT FENCE BARRIER.
 - PLACE RIP RAP WITH CARE. DO NOT TEAR SILT FENCE FABRIC.

14 SILT FENCE OUTLET

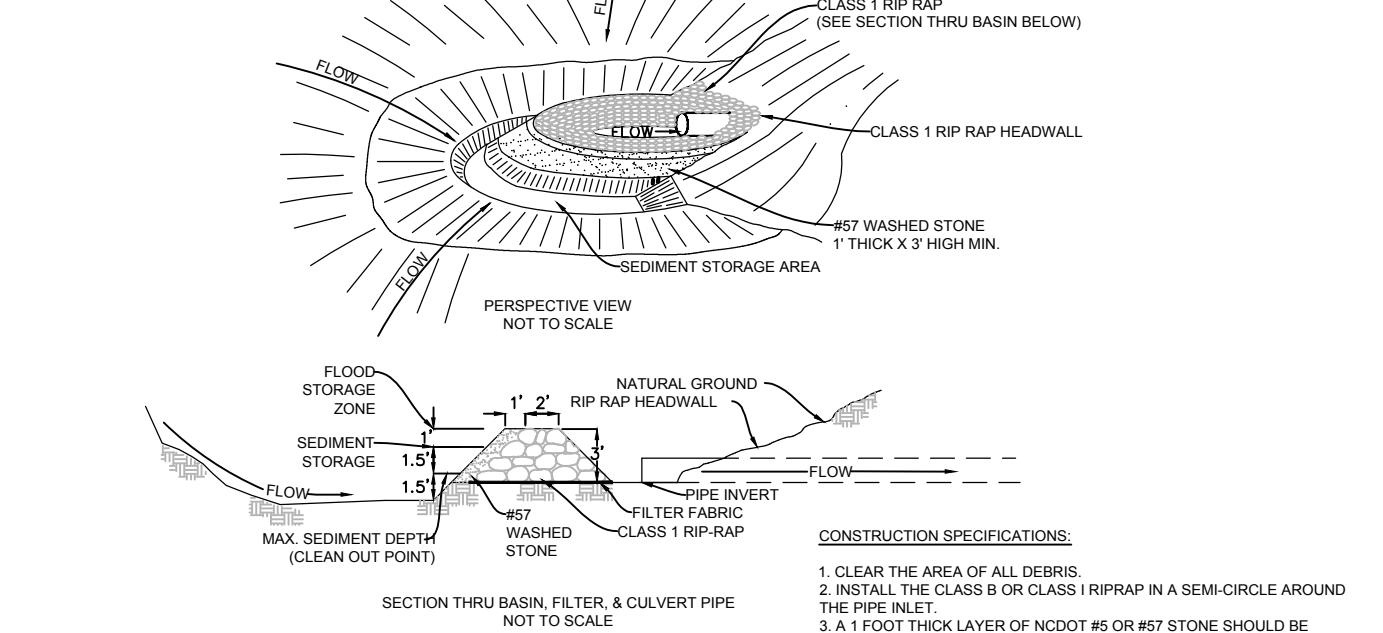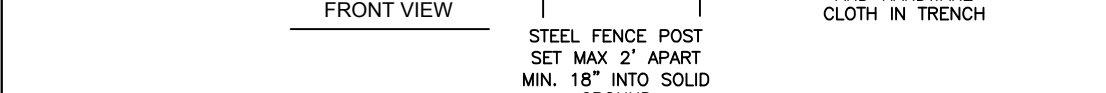

- CONSTRUCTION SPECIFICATIONS:**
- CLEAR THE AREA OF ALL DEBRIS
 - INSTALL THE CLASS B OR CLASS 1 RIP RAP IN A SEMI-CIRCLE AROUND THE PIPE INLET.
 - A 1 FOOT THICK LAYER OF #20 OR #30 STONE SHOULD BE PLACED ON THE OUTSIDE SLOPE OF THE RIP RAP.
 - SEDIMENT STORAGE AREA SHOULD BE EXCAVATED AROUND THE OUTSIDE OF THE STONE HORSESHOE 18" BELOW NATURAL GRADE.
 - WHEN THE CONTRIBUTING DRAINAGE AREA HAS BEEN STABILIZED, FILL DEPRESSION AND ESTABLISH FINAL GRADING CONDITIONS, COMPACT, AND STABILIZE WITH GROUND COVER.


3 ROCK PIPE INLET PROTECTION

COMMON NAME	SIZE	SPACING
WATERPOD	4 IN CONTAINER	24" O.C. MAXIMUM
PICKERELWEED	4 IN CONTAINER	24" O.C. MAXIMUM
LIZARD TAIL	4 IN CONTAINER	24" O.C. MAXIMUM
BULLTONGUE	4 IN CONTAINER	24" O.C. MAXIMUM
BLUE FLAG IRIS	4 IN CONTAINER	24" O.C. MAXIMUM
JOE PYE WEED	4 IN CONTAINER	18" O.C. MAXIMUM
RED CHOKEBERRY	1 GAL CONTAINER	48" O.C. MAXIMUM
CARDINAL FLOWER	1 GAL CONTAINER	48" O.C. MAXIMUM
SILKY DOGWOOD	1 GAL CONTAINER	48" O.C. MAXIMUM
SWAMP MILKWEED	4 IN CONTAINER	18" O.C. MAXIMUM

- PLANT SUPPLIERS**
- CAROLINA GREENERY, WEST END, NC 910-947-3150
MELLOW MARSH FARM, PITTSBORO, NC 919-742-1200
PLANT DELIGHTS NURSERY, RALEIGH, NC 919-772-4794
GILL IDE NATIVE PLANT NURSERY, RALEIGH, NC 877-479-2673


**VEGETATED SHELFS AND SLOPES ABOVE THE PERMANENT POOL ELEVATION SHALL HAVE A MINIMUM OF 6" TOPSOIL. SUBGRADE SHALL BE ADJUSTED TO ACCOUNT FOR ADDITION OF TOPSOIL IN THESE AREAS SUCH THAT THE ELEVATIONS SHOWN ABOVE ARE TO THE FINISHED GRADE OF THE TOPSOIL.

6 VEGETATED SHELF PLANTING DETAIL

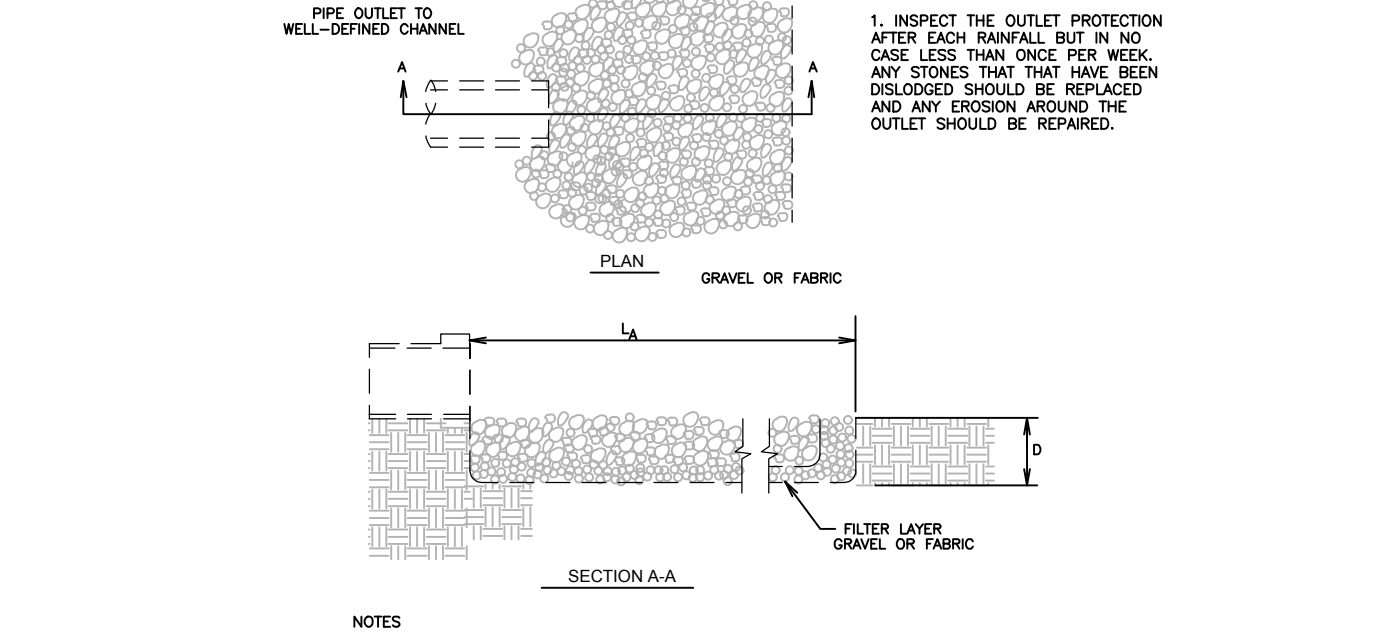


- MAINTENANCE:**
- INSPECT THE OUTLET PROTECTION AT LEAST WEEKLY BUT IN NO CASE LESS THAN ONCE PER YEAR. IF THE RIP RAP HAS BEEN DISLOADED OR ANY GRASS/VEGETATION AROUND THE OUTLET SHOULD BE REPLACED.

2 TYPICAL RIP RAP APRON

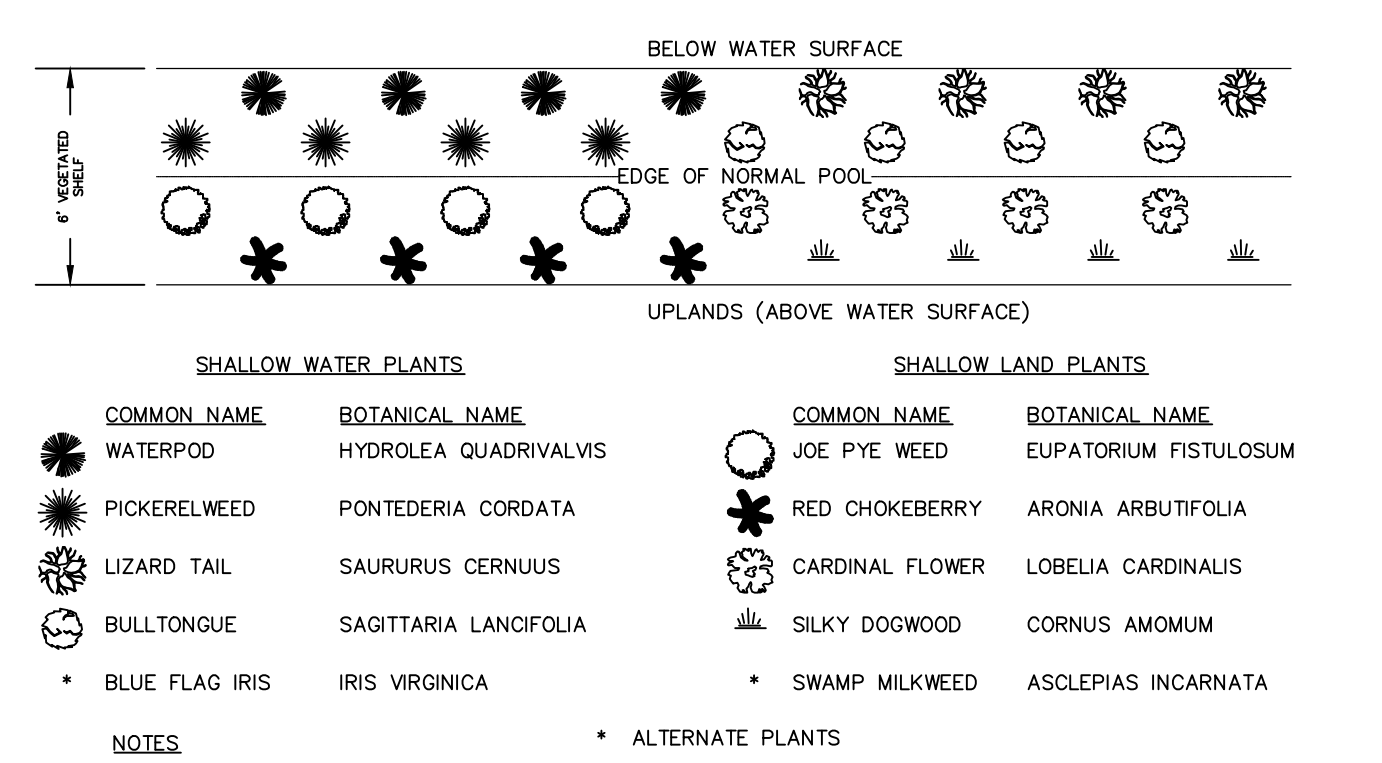


- NOTES:**
- MAXIMUM PLANT SPACING SHALL BE PER THE CHART SHOWN.
 - PLANTS CAN AND SHOULD BE MIXED MATCHED DURING THE PLANTING PROCESS. SHALLOW LAND PLANTS AND SHALLOW WATER PLANTS CANNOT BE MIXED TOGETHER.
 - SOIL SAMPLE SHOULD BE TAKEN PRIOR TO SAMPLING AND FERTILIZE AT RECOMMENDATION FROM SOILS ANALYSIS.
 - ALL SLOPES AND AREAS ADJACENT TO THE WET POND SHALL BE SEEDDED WITH BERMUDA GRASS FOR A PERMANENT GROUND COVER.
 - ALL INSTALLATIONS SHALL BE FROM A QUALIFIED PROFESSIONAL.


9 STAPLE PATTERN FOR 4' ROLLS

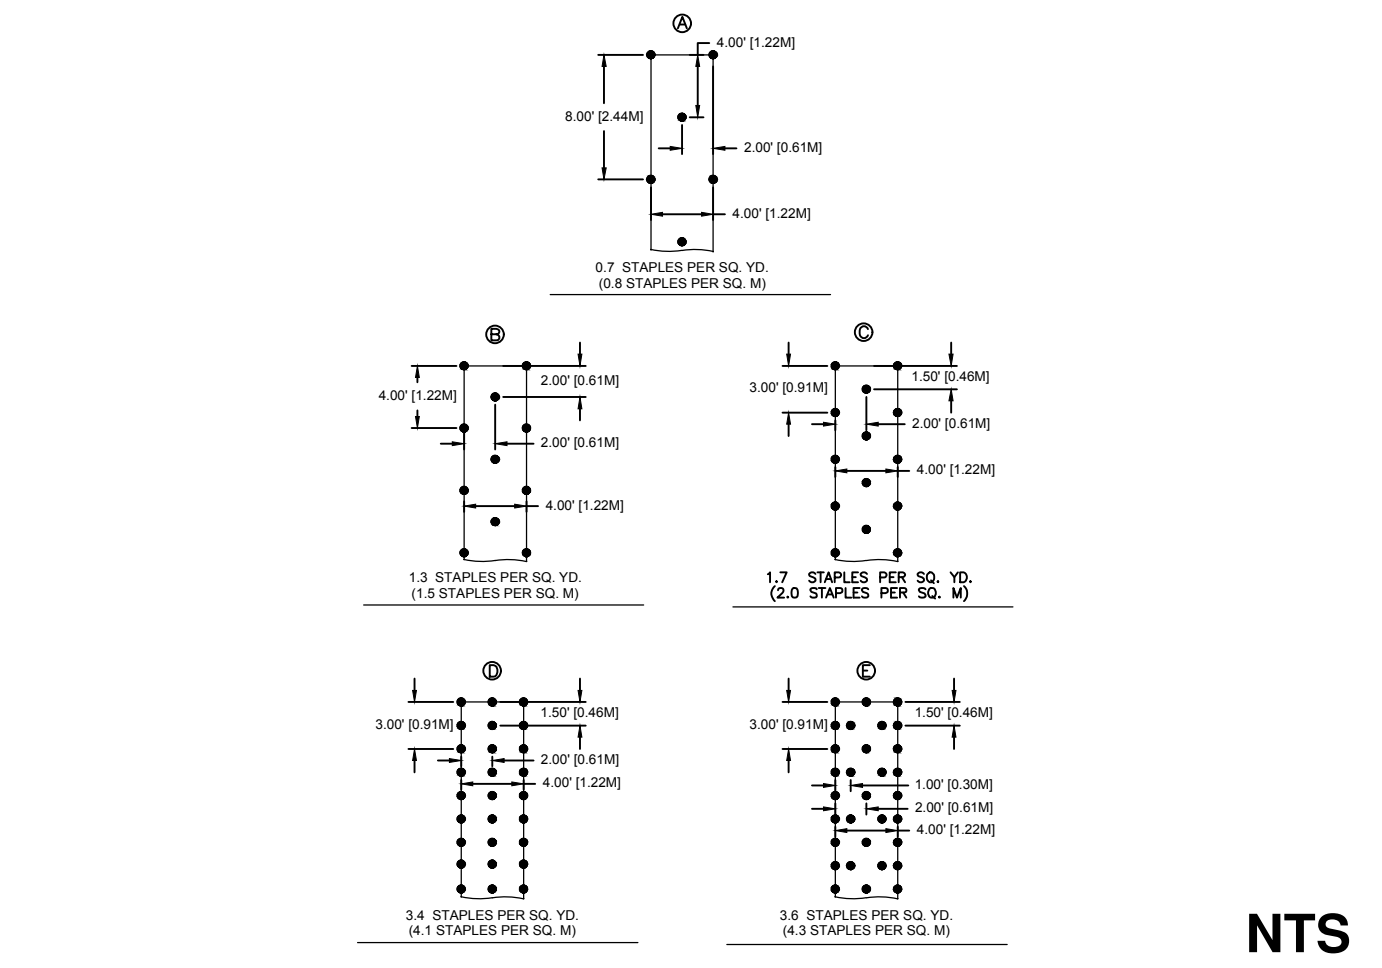

12 FLARED END SECTION

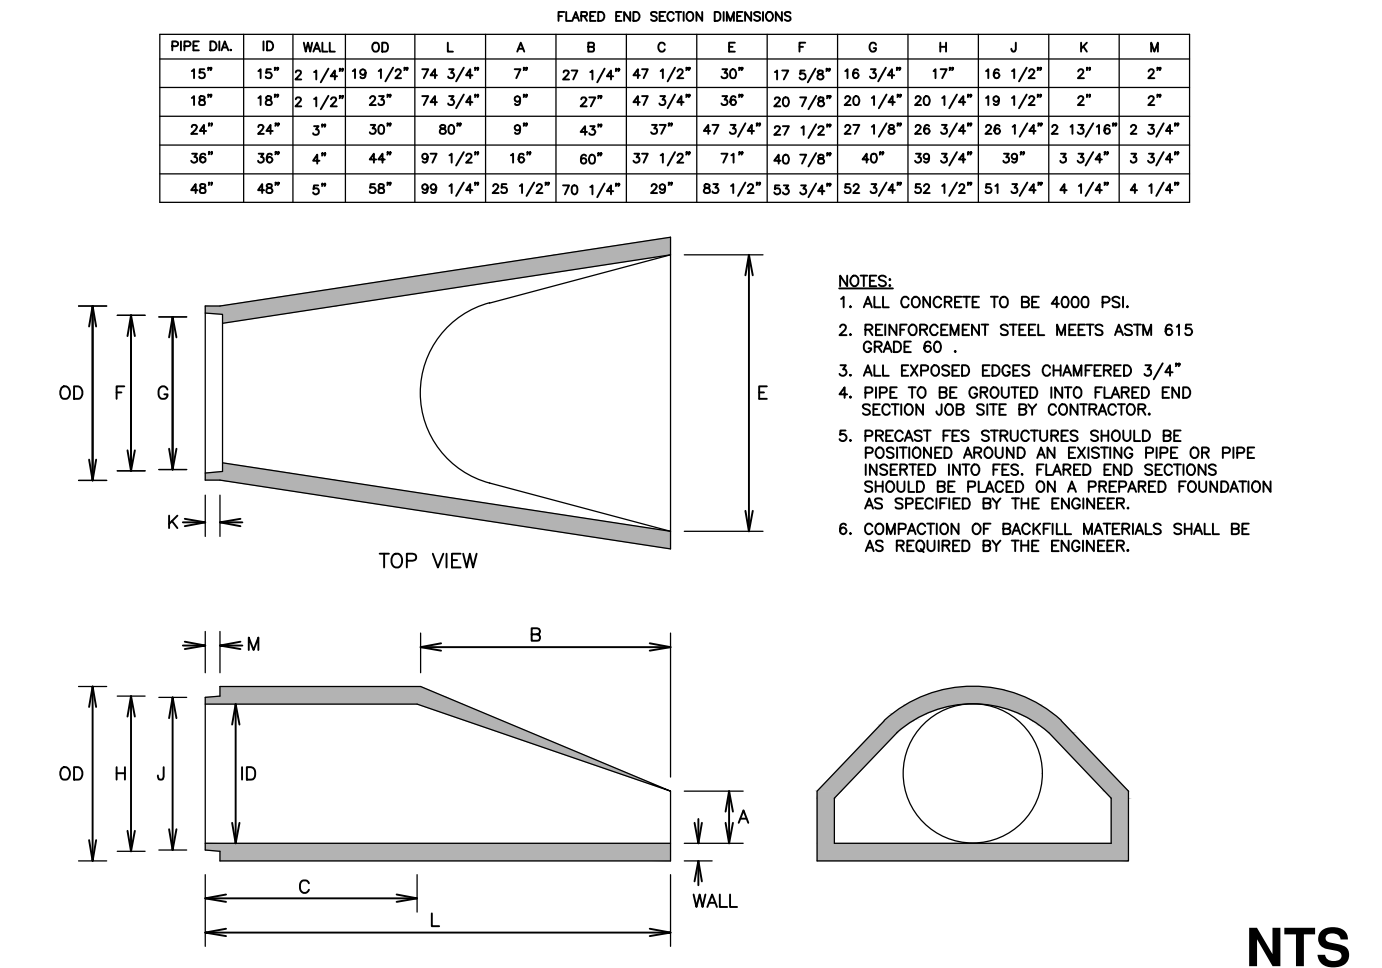


8 EROSION CONTROL BLANKET INSTALLATION

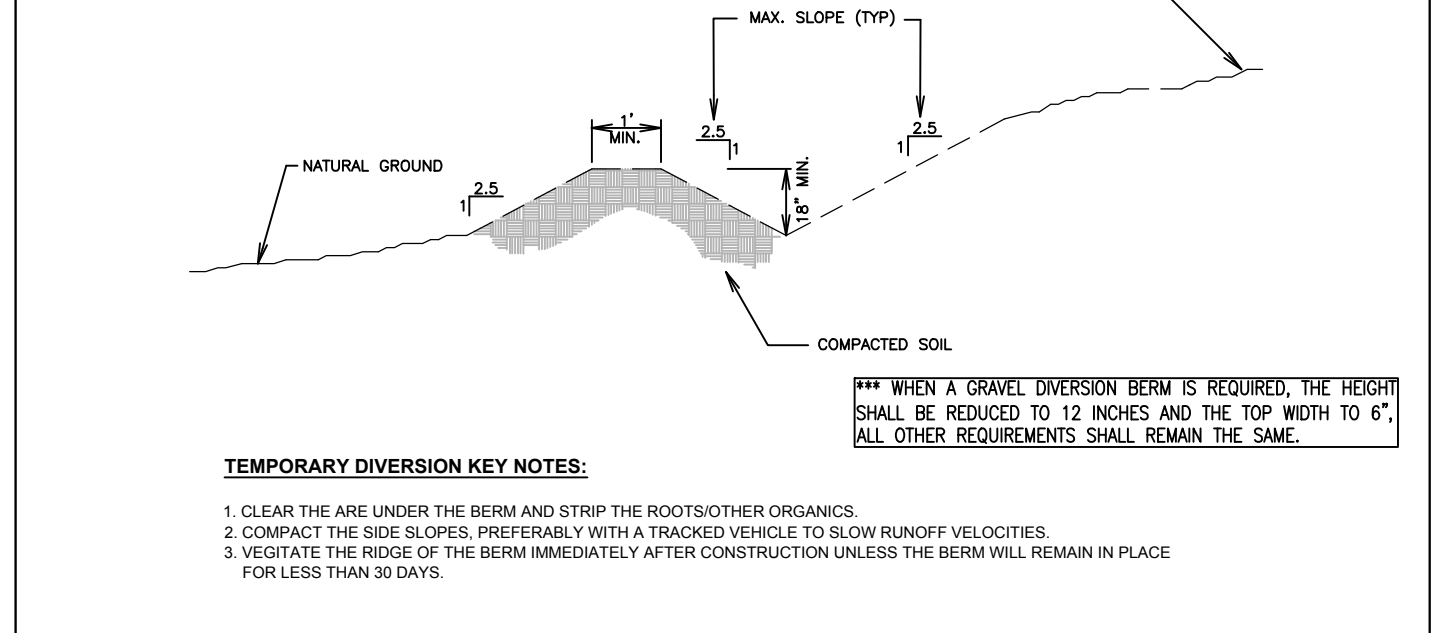


- TEMPORARY DIVERSION KEY NOTES:**
- CLEAR THE AREA UNDER THE BERM AND STRIP THE ROOTS/OTHER ORGANICS
 - CONTRACT THE SIDE SLOPES, PREFERABLY WITH A TRACKED VEHICLE TO SLOW RUNOFF VELOCITIES.
 - VEGETATE THE RIDGE OF THE BERM IMMEDIATELY AFTER CONSTRUCTION UNLESS THE BERM WILL REMAIN IN PLACE FOR LESS THAN 30 DAYS.

1 TEMPORARY DIVERSION BERM

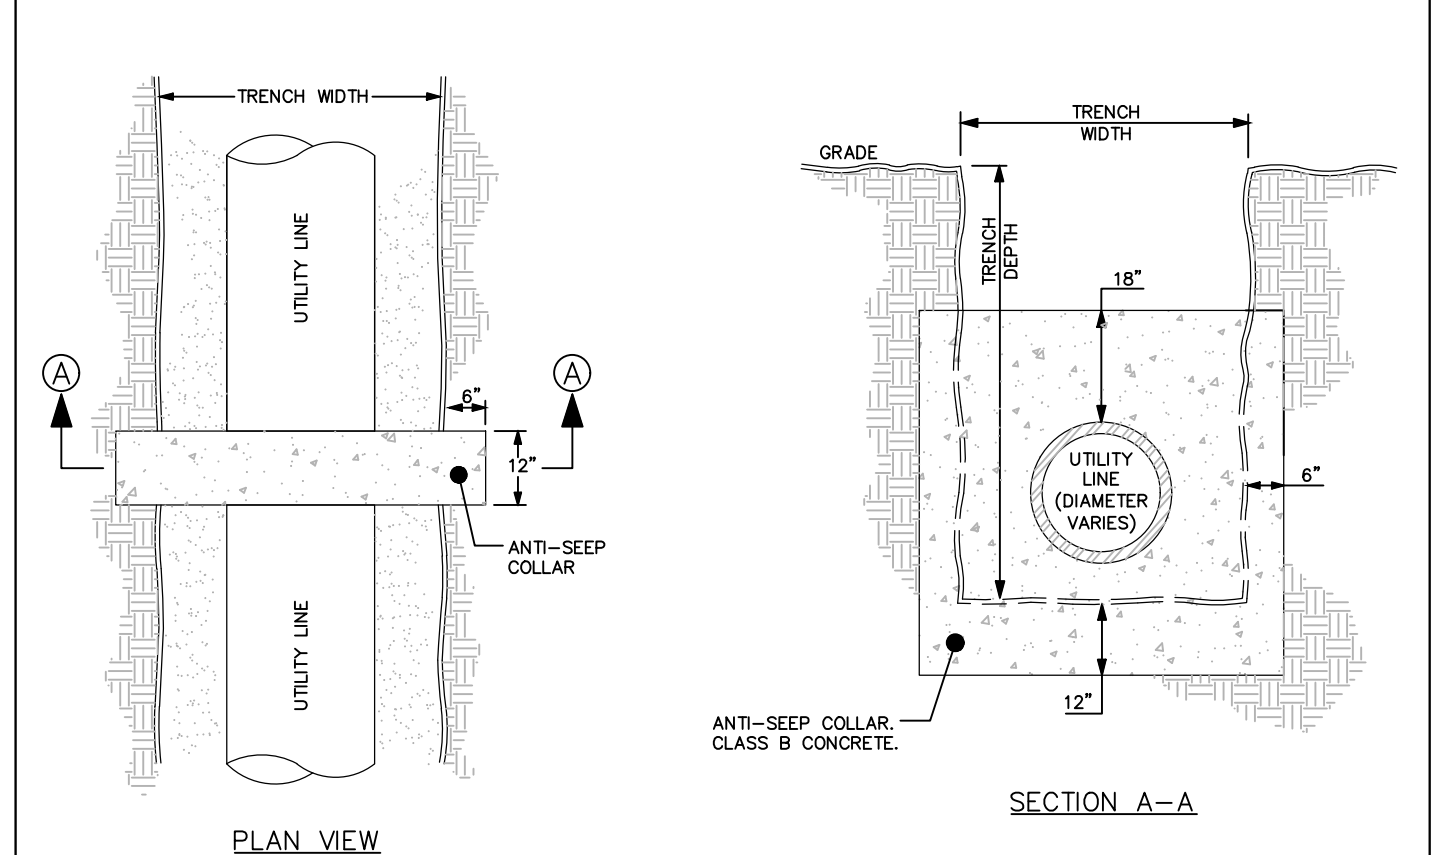

5 ANTI-SEEP COLLAR

CHANNEL INSTALLATION

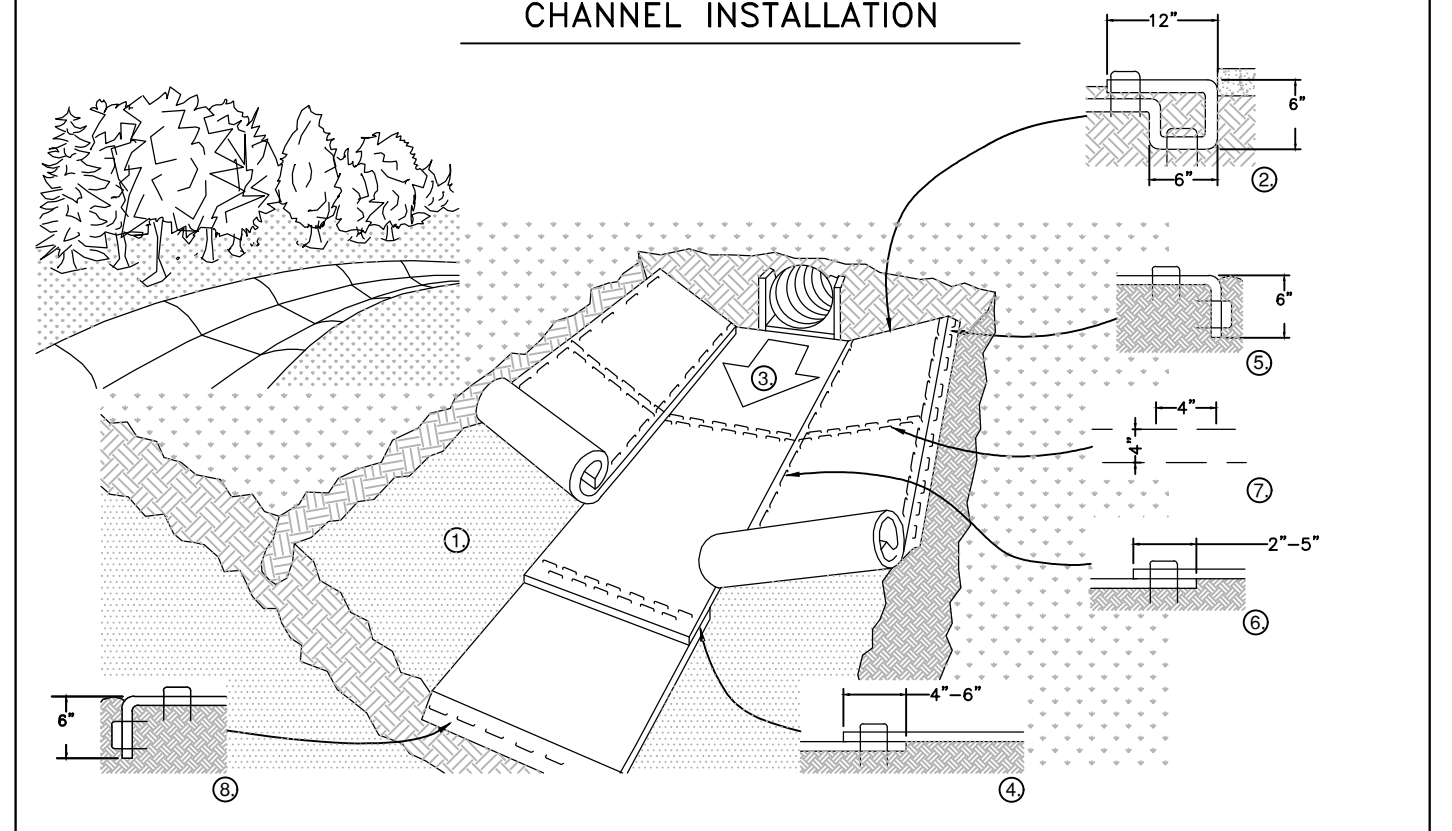

- PREPARE CELL BEFORE INSTALLING BLANKETS, INCLUDING ANY NECESSARY APPLICATION OF LIME, FERTILIZER, AND SEED. NOTE: WHEN USING CELL-0 SEED DO NOT SEED PREPARED AREA. CELL-0 SEED MUST BE INSTALLED WITH PAPER SIDE DOWN.
- BEGIN AT THE TOP OF THE CHANNEL BY ANCHORING THE BLANKET IN A 6" (15 CM) DEEP X 6" (15 CM) WIDE TRENCH WITH APPROXIMATELY 12" (30 CM) OF BLANKET EXTENDED BEYOND THE UP-SLOPE PORTION OF THE TRENCH. ANCHOR THE BLANKET WITH A ROW OF STAPLES/STAKES APPROXIMATELY 12" (30 CM) APART IN THE BOTTOM OF THE TRENCH. BACKFILL AND COMPACT THE TRENCH AFTER STAPLING. APPLY SEED TO COMPACTED SOIL AND FOLD REMAINING 12" (30 CM) PORTION OF BLANKET BACK OVER SEED AND COMPACTED SOIL. SECURE BLANKET OVER COMPACTED SOIL WITH A ROW OF STAPLES/STAKES SPACED APPROXIMATELY 12" (30 CM) ACROSS THE WIDTH OF THE BLANKET.
- ROLL CENTER BLANKET IN DIRECTION OF WATER FLOW IN BOTTOM OF CHANNEL. BLANKETS WILL UNROLL WITH APPROPRIATE SIDE AGAINST THE SOIL SURFACE. ALL BLANKETS MUST BE SECURELY FASTENED TO SOIL SURFACE BY PLACING STAPLES/STAKES IN APPROPRIATE LOCATIONS AS SHOWN IN THE STAPLE PATTERN GUIDE. WHEN USING THE DOT SYSTEM, STAPLES/STAKES SHOULD BE PLACED THROUGH EACH OF THE COLORED DOTS CORRESPONDING TO THE APPROPRIATE STAPLE PATTERN.
- PLACE CONSECUTIVE BLANKETS END OVER END (SHINGLE STYLE) WITH A 4" - 6" (10 CM - 15 CM) OVERLAP. USE A DOUBLE ROW OF STAPLES STAGGERED 4" (10 CM) APART AND 4" (10 CM) ON CENTER TO SECURE BLANKETS.
- FULL LENGTH EDGE OF BLANKETS AT TOP OF SIDE SLOPES MUST BE ANCHORED WITH A ROW OF STAPLES/STAKES APPROXIMATELY 12" (30 CM) APART IN A 6" (15 CM) DEEP X 6" (15 CM) WIDE TRENCH. BACKFILL AND COMPACT THE TRENCH AFTER STAPLING.
- ADJACENT BLANKETS MUST BE OVERLAPPED APPROXIMATELY 2" - 5" (5 CM - 12.5 CM) (DEPENDING ON BLANKET TYPE) AND STAPLED.
- IN HIGH FLOW CHANNEL APPLICATIONS, A STAPLE CHECK SLOT IS RECOMMENDED AT 30 TO 40 FOOT (9 M - 12 M) INTERVALS. USE A DOUBLE ROW OF STAPLES STAGGERED 4" (10 CM) APART AND 4" (10 CM) ON CENTER OVER ENTIRE WIDTH OF THE CHANNEL.
- THE TERMINAL END OF THE BLANKETS MUST BE ANCHORED WITH A ROW OF STAPLES/STAKES APPROXIMATELY 12" (30 CM) APART IN A 6" (15 CM) DEEP X 6" (15 CM) WIDE TRENCH. BACKFILL AND COMPACT THE TRENCH AFTER STAPLING. NOTE: * IN LOOSE SOIL CONDITIONS, THE USE OF STAPLE OR STAKE LENGTHS GREATER THAN 6" (15 CM) MAY BE NECESSARY TO PROPERLY ANCHOR THE BLANKETS.

- MAINTENANCE:**
- INSPECT THE EROSION CONTROL BLANKET ONCE A WEEK AND AFTER EVERY RAINFALL.
 - IMMEDIATELY REPAIR AND/OR REPLACE ANY DAMAGED BLANKET.
 - IF GROUND COVER IS NOT ESTABLISHED THROUGH THE BLANKET WITHIN 2 WEEKS, THE BLANKET SHOULD BE REMOVED AND THE AREA RESEEDED. AFTER RESEEDING, THE BLANKET SHOULD BE REINSTALLED.

14 EROSION CONTROL BLANKET INSTALLATION

12 FLARED END SECTION

8 EROSION CONTROL BLANKET INSTALLATION

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REVISIONS

PROJECT NAME

**SPRING LAKE
RAY ROAD
DOLLAR
GENERAL**

STORM DETAILS

CLIENT

**RHETSON
COMPANIES, INC**

2075 Juniper Lake Road
West End, North Carolina 27376
Phone: (910) 944-0881

PROJECT INFORMATION

DESIGNED BY:	SCOTT
DRAWN BY:	SCOTT
CHECKED BY:	CHRIS
PROJECT NUMBER:	1644

DRAWING SCALE

NOT TO SCALE

DATE RELEASED

APRIL 22, 2021

SHEET NUMBER

C-6.4

STATE OF NORTH CAROLINA
DEPT. OF TRANSPORTATION
DIVISION OF HIGHWAYS
RALEIGH, N.C.

1-1/2

GENERAL NOTES:
USE CLASS "B" CONCRETE THROUGHOUT.
PROVIDE ALL DROP INLETS OVER 3'-6" IN DEPTH WITH STEPS 12" ON CENTER. USE STEPS WHICH COMPLY WITH STD. DRAWING 840.06.
OPTIONAL CONSTRUCTION - MONOLITHIC POUR, 2" KEYWAY, OR #4 BAR DOWELS AT 12" CENTERS AS DIRECTED BY THE ENGINEER.
USE FORMS FOR TO CONSTRUCT OF THE BOTTOM SLAB.
IF REINFORCED CONCRETE PIPE IS SET IN BOTTOM SLAB OF BOX, ADD TO SLAB AS SHOWN ON STD. NO. 840.00.
CONSTRUCT WITH PIPE GROUNTS MATCHING.
SEE STANDARD DRAWING 840.25 FOR ATTACHMENT OF FRAMES AND GRATE NOT SHOWN.
INSTALL 2" WEEP HOLES AS DIRECTED BY THE ENGINEER.
CONCRETE AND BRICK MASONRY QUANTITIES TO INCLUDE THE ADDITION OF THE MANHOLE (I.E. DIAGONAL BARS SHORTENED AROUND OPENING IN TOP SLAB).
ADJUST THE STEEL, CONCRETE AND BRICK MASONRY QUANTITIES TO INCLUDE THE ADDITION OF THE MANHOLE (I.E. DIAGONAL BARS SHORTENED AROUND OPENING IN TOP SLAB).
MAX. DEPTH OF THIS STRUCTURE FROM TOP OF BOTTOM SLAB TO TOP ELEVATION IS 12 FEET.

12" THRU 30" PIPE

ENGLISH STANDARD DRAWING FOR
CONCRETE DROP INLET

SHEET 1 OF 1
840.14

STATE OF NORTH CAROLINA
DEPT. OF TRANSPORTATION
DIVISION OF HIGHWAYS
RALEIGH, N.C.

1-1/2

CONCRETE DROP INLET

ENGLISH STANDARD DRAWING FOR
DROP INLET FRAME AND GRATES
FOR USE WITH STD. DWG.S 840.14 AND 840.15

SHEET 1 OF 1
840.16

STATE OF NORTH CAROLINA
DEPT. OF TRANSPORTATION
DIVISION OF HIGHWAYS
RALEIGH, N.C.

1-1/2

GENERAL NOTES:
CHAMFER ALL EXPOSED CORNERS 1".
USE CLASS "B" CONCRETE THROUGHOUT.
OPTIONAL CONSTRUCTION - MONOLITHIC POUR, 2" KEYWAY, OR #4 BAR DOWELS AT 12" CENTERS AS DIRECTED BY THE ENGINEER.
USE FORMS FOR TO CONSTRUCT OF THE BOTTOM SLAB.
IF REINFORCED CONCRETE PIPE IS SET IN BASE SLAB OF BOX, ADD TO BASE AS SHOWN ON STANDARD NO. 840.00.
PROVIDE ALL JUNCTION BOXES OVER 3'-6" IN DEPTH WITH STEPS 12" ON CENTER IN ACCORDANCE WITH STD. NO. 840.06.
ADJUST THE STEEL, CONCRETE AND BRICK MASONRY QUANTITIES TO INCLUDE THE ADDITION OF THE MANHOLE (I.E. DIAGONAL BARS SHORTENED AROUND OPENING IN TOP SLAB).
ADJUST THE STEEL, CONCRETE AND BRICK MASONRY QUANTITIES TO INCLUDE THE ADDITION OF THE MANHOLE (I.E. DIAGONAL BARS SHORTENED AROUND OPENING IN TOP SLAB).
MAX. DEPTH OF THIS STRUCTURE FROM TOP OF BOTTOM SLAB TO TOP ELEVATION IS 12 FEET.

12" THRU 66" PIPE

ENGLISH STANDARD DRAWING FOR
CONCRETE JUNCTION BOX
(WITH OPTIONAL MANHOLE)

SHEET 1 OF 1
840.31

DIMENSIONS OF BOX & PIPE		REINFORCEMENT BARS "A"		TOP SLAB DIMENSIONS		CUBIC YARDS FOR CONCRETE JUNCTION BOXES		TOTAL QUANTITIES FOR BOX AND SLAB		DIMENSIONS FOR ONE PIPE CU YDS.					
PIPE	SPAN	WIDTH	MIN. HEIGHT	NO.	LENGTH	E	F	TOP SLAB	BOTTOM SLAB	WALL	PER	NO.	MIN. HT.	C.S.	R.C.
12"	2'-0"	2'-0"	2'-3"	12"	2'-0"	3'-0"	3'-0"	0.167	0.167	0.185	22	0.750	0.015	0.024	
15"	2'-3"	2'-3"	2'-6"	12"	3'-0"	3'-3"	3'-3"	0.196	0.196	0.204	24	0.902	0.023	0.036	
18"	2'-6"	2'-6"	2'-9"	14"	3'-3"	3'-6"	3'-6"	0.227	0.227	0.232	30	1.065	0.033	0.049	
24"	3'-0"	3'-0"	3'-3"	18"	3'-6"	4'-0"	4'-0"	0.296	0.296	0.299	40	1.434	0.059	0.085	
30"	3'-6"	3'-6"	3'-9"	24"	4'-0"	4'-6"	4'-6"	0.375	0.375	0.396	51	1.800	0.092	0.127	
36"	4'-0"	4'-0"	4'-3"	20"	4'-0"	5'-0"	5'-0"	0.463	0.463	0.533	64	2.341	0.132	0.178	
42"	4'-6"	4'-6"	4'-9"	22"	5'-3"	5'-6"	5'-6"	0.560	0.560	0.570	77	2.878	0.180	0.243	
48"	5'-0"	5'-0"	5'-3"	26"	6'-3"	6'-4"	6'-4"	0.743	0.743	0.407	111	3.623	0.235	0.317	
54"	5'-10"	5'-10"	5'-9"	28"	6'-7"	6'-10"	6'-10"	0.865	0.865	0.444	126	4.283	0.297	0.401	
60"	6'-6"	6'-6"	6'-3"	30"	7'-3"	7'-6"	7'-6"	1.042	1.042	0.481	145	5.090	0.367	0.495	
66"	7'-1"	7'-1"	6'-9"	32"	7'-10"	8'-1"	8'-1"	1.210	1.210	0.518	169	5.917	0.444	0.589	

STATE OF NORTH CAROLINA
DEPT. OF TRANSPORTATION
DIVISION OF HIGHWAYS
RALEIGH, N.C.

1-1/2

GENERAL NOTES:
MORTAR JOINTS 1/2" x 1/8" THICK.
USE CLASS "B" CONCRETE THROUGHOUT.
USE FORMS FOR CONSTRUCTION OF THE BOTTOM SLAB.
USE #4 BAR DOWELS AT 12" CENTERS.
DUCT FOR PIPES FROM TOTAL CU YDS. OF BRICK MASONRY.
PROVIDE ALL CATCH BASINS OVER 3'-6" IN DEPTH WITH STEPS 12" ON CENTER. USE STEPS WHICH COMPLY WITH STD. DRAWING 840.06.
USE BRICK OR CONCRETE BLOCK WHICH COMPLES WITH THE REQUIREMENTS OF SECTION 840 OF THE STANDARD SPECIFICATIONS.
IF REINFORCED CONCRETE PIPE IS SET IN BOTTOM SLAB OF BOX, ADD TO SLAB AS SHOWN ON STD. NO. 840.00.
FOR 6" OF IN HEIGHT OR LESS, USE 8" WALL. OVER 6" OF IN HEIGHT, USE 12" WALL TO 6" FROM TOP OF WALL AND 8" WALL FOR THE REMAINING 6" OF IN HEIGHT. QUANTITIES TO BE ADJUSTED ACCORDINGLY.
CONSTRUCT WITH PIPE GROUNTS MATCHING.
SEE STANDARD DRAWING 840.25 FOR ATTACHMENT OF FRAMES AND GRATES.
DO NOT USE BRICK MASONRY DROP INLET IN LOCATIONS SUBJECT TO TRAFFIC.
CHAMFER ALL EXPOSED CORNERS 1".
DRAWING NOT TO SCALE.

12" THRU 30" PIPE

ENGLISH STANDARD DRAWING FOR
BRICK DROP INLET

SHEET 1 OF 1
840.15

STATE OF NORTH CAROLINA
DEPT. OF TRANSPORTATION
DIVISION OF HIGHWAYS
RALEIGH, N.C.

1-1/2

BRICK DROP INLET

ENGLISH STANDARD DRAWING FOR
MANHOLE FRAME AND COVER

SHEET 1 OF 1
840.54

STATE OF NORTH CAROLINA
DEPT. OF TRANSPORTATION
DIVISION OF HIGHWAYS
RALEIGH, N.C.

1-1/2

GENERAL NOTES:
CHAMFER ALL EXPOSED CORNERS 1".
USE CLASS "B" CONCRETE THROUGHOUT.
OPTIONAL CONSTRUCTION - MONOLITHIC POUR, 2" KEYWAY, OR #4 BAR DOWELS AT 12" CENTERS.
MORTAR JOINTS 1/2" x 1/8" THICK.
CONCAVE TOO ALL EXPOSED JOINTS.
USE FORMS FOR TO CONSTRUCT OF THE BOTTOM SLAB.
JUMBO BRICK WILL BE PERMITTED. CONCRETE BRICK OR 4" SOLID CONCRETE BLOCKS MAY BE USED IN LIEU OF CLAY BRICK.
FOR 6" OF IN HEIGHT OR LESS, USE 8" WALL. OVER 6" OF IN HEIGHT, USE 12" WALL TO 6" FROM TOP OF WALL AND 8" WALL FOR THE REMAINING 6" OF IN HEIGHT. ADJUST DIMENSIONS AND QUANTITIES ACCORDINGLY.
IF REINFORCED CONCRETE PIPE IS SET IN BASE SLAB OF BOX, ADD TO BASE AS SHOWN ON STANDARD NO. 840.00.
PROVIDE ALL JUNCTION BOXES OVER 3'-6" IN DEPTH WITH STEPS 12" ON CENTER IN ACCORDANCE WITH STD. NO. 840.06.
ADJUST THE STEEL, CONCRETE AND BRICK MASONRY QUANTITIES TO INCLUDE THE ADDITION OF THE MANHOLE (I.E. DIAGONAL BARS SHORTENED AROUND OPENING IN TOP SLAB).
ADJUST THE STEEL, CONCRETE AND BRICK MASONRY QUANTITIES TO INCLUDE THE ADDITION OF THE MANHOLE (I.E. DIAGONAL BARS SHORTENED AROUND OPENING IN TOP SLAB).
MAX. DEPTH OF THIS STRUCTURE FROM TOP OF BOTTOM SLAB TO TOP ELEVATION IS 12 FEET.

12" THRU 66" PIPE

ENGLISH STANDARD DRAWING FOR
BRICK JUNCTION BOX
(WITH OPTIONAL MANHOLE)

SHEET 1 OF 1
840.32

DIMENSIONS OF BOX & PIPE		REINFORCEMENT BARS		TOP SLAB DIMENSIONS		CUBIC YARDS FOR BRICK JUNCTION BOXES		TOTAL QUANTITIES FOR BOX AND SLAB		DIMENSIONS FOR ONE PIPE CU YDS.					
PIPE	SPAN	WIDTH	MIN. HEIGHT	NO.	LENGTH	E	F	TOP SLAB	BOTTOM SLAB	WALL	PER	NO.	MIN. HT.	C.S.	R.C.
12"	2'-0"	2'-0"	2'-3"	12"	3'-1"	3'-4"	3'-4"	0.412	0.412	0.591	0.263	0.020	0.032		
15"	2'-3"	2'-3"	2'-6"	12"	3'-1"	3'-4"	3'-4"	0.412	0.412	0.657	0.263	0.031	0.047		
18"	2'-6"	2'-6"	2'-9"	14"	3'-5"	3'-8"	3'-8"	0.468	0.468	0.814	0.296	0.044	0.065		
24"	3'-0"	3'-0"	3'-3"	18"	4'-1"	4'-4"	4'-4"	0.695	0.695	1.176	0.362	0.078	0.113		
30"	3'-6"	3'-6"	3'-9"	18"	4'-5"	4'-8"	4'-8"	0.807	0.807	1.481	0.395	0.122	0.170		
36"	4'-0"	4'-0"	4'-3"	20"	5'-1"	5'-4"	5'-4"	1.053	1.053	1.859	0.461	0.178	0.238		
42"	4'-6"	4'-6"	4'-9"	22"	5'-9"	6'-0"	6'-0"	1.333	1.333	2.503	0.527	0.240	0.323		
48"	5'-0"	5'-0"	5'-3"	26"	6'-5"	6'-8"	6'-8"	1.646	1.646	3.400	0.600	0.313	0.422		
54"	5'-10"	5'-10"	5'-9"	28"	6'-11"	7'-2"	7'-2"	2.002	2.002	4.502	0.609	0.396	0.535		
60"	6'-6"	6'-6"	6'-3"	30"	7'-7"	7'-10"	7'-10"	2.272	2.272	4.113	0.658	0.489	0.660		
66"	7'-1"	7'-1"	6'-9"	32"	8'-2"	8'-5"	8'-5"	2.624	2.624	4.778	0.708	0.591	0.798		