


#### Kwik Bolt 3 Expansion Anchor Installation Instructions

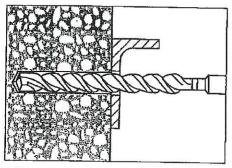


1. Hammer drill a hole to the same nominal diameter as the Kwik Bolt 3. The hole depth must exceed the anchor embedment by at least one diameter. The fixture may be used as a drilling template to ensure proper anchor location.

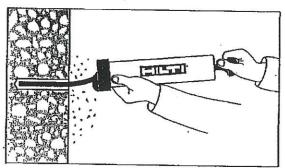

2. Clean hole.

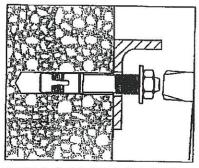


3. Drive the Kwik Bolt 3 into the hole using a harmer. The anchor must be driven until at least six threads are below the surface of the fixture.

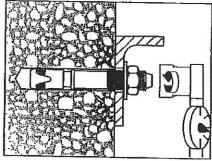


4. Tighten the nut to the recommended installation torque.


DESIGN INFORMATION	Units		Nominal Anchor Diameter			
		1/4	3/8	1/2	5/8	3/4
installation torque	ft*lb	4	20	40	60	110
mousement torque	(Nm)	(5)	(27)	(54)	(81)	(149)

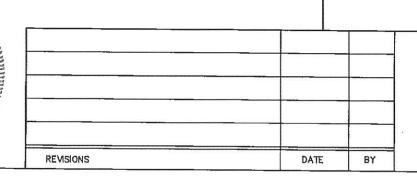


# Kwik Bolt TZ Anchor Installation Instructions into normal-weight and lightweight concrete

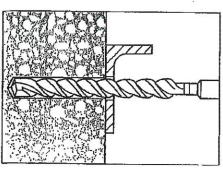


Hammer drill a hole to the same nominal diameter as the Kwik Bolt TZ. The hole depth must exceed the anchor embedment by at least 1/4 inch. The fixture may be used as a drilling template to ensure proper anchor location.

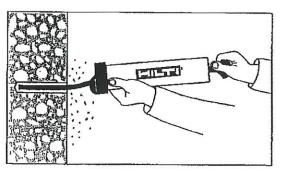

2. Clean hole.

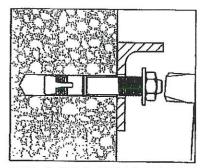

 Drive the Kwik Bolt TZ into the hole using a hammer. The anchor must be driven until at least 4 threads are below the surface of the fixture.

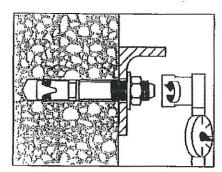

 Tighten the nut to the recommended installation torque.

SETTING	Units		Nominal anchor di	iameter (in.)	
INFORMATION		3/8	1/2	5/8	3/4
Installation torque	(t-fb	25	40	60	110
	(Nm)	(34)	(54)	(81)	(149)


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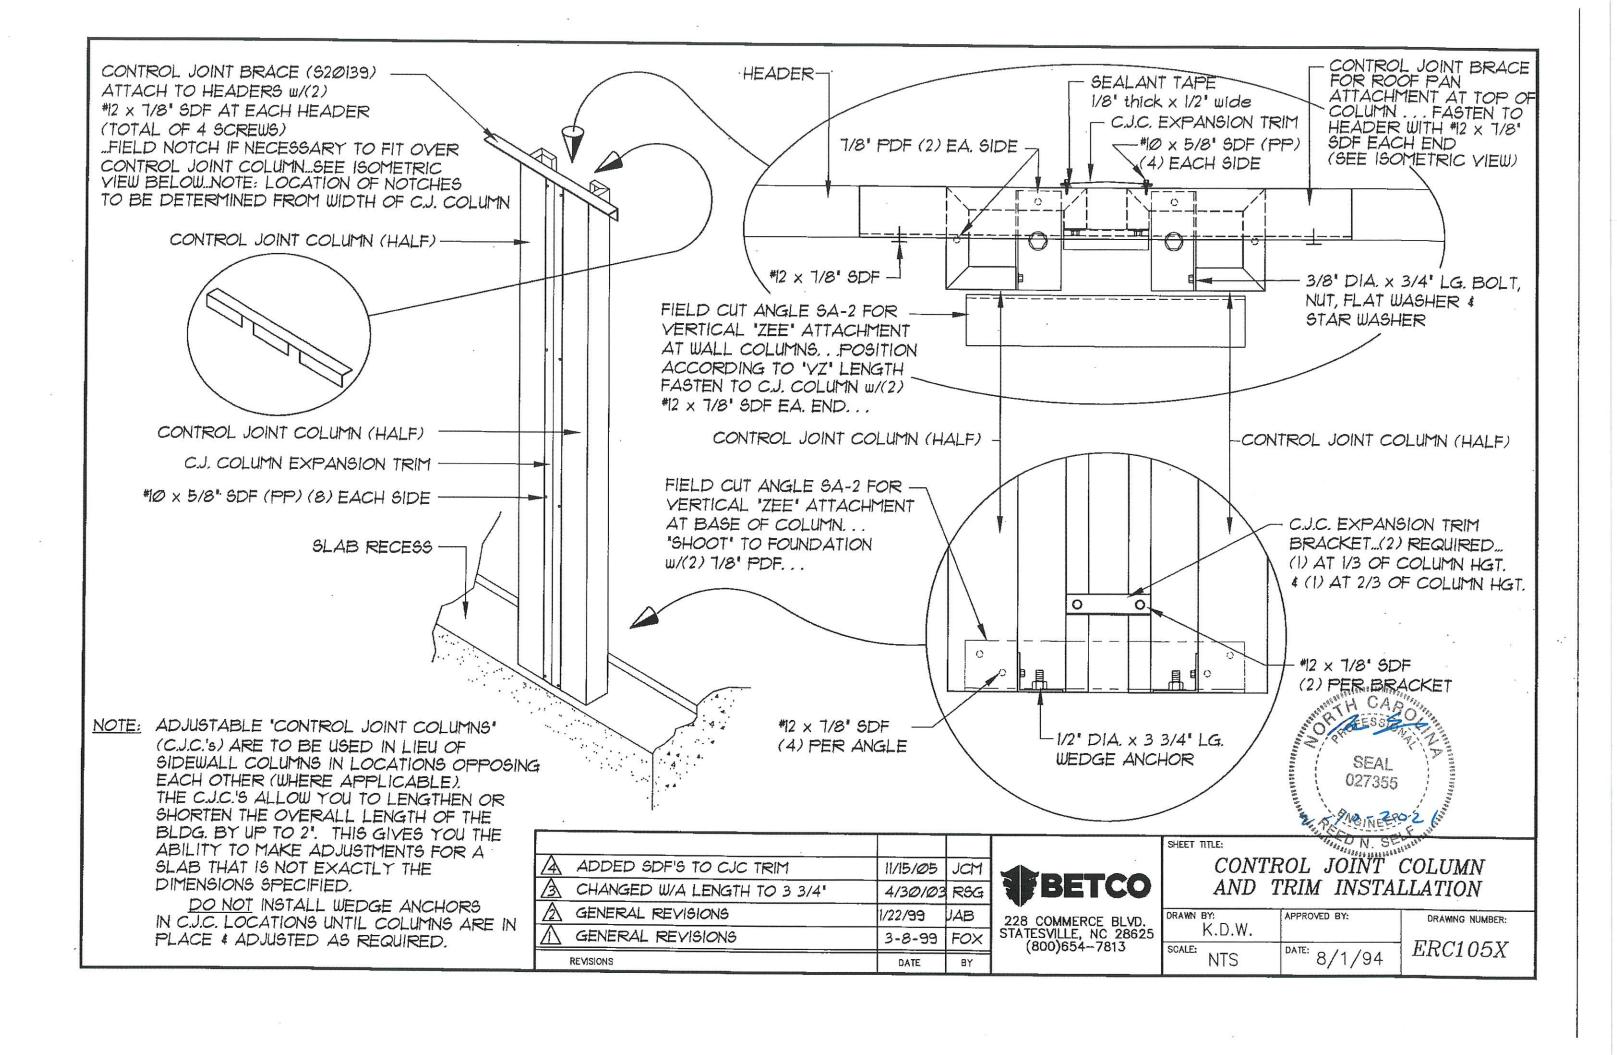



228 COMMERCE BLVD. STATESVILLE, NC 28625 (800)654-7813


	Kwik	Bolt	Anch	or
Ins	tallat	ion l	nstruc	tions


1	- 1	1100011100101	11100100010110
DRAWN BY:	BDL	APPROVED BY:	DRAWING NUMBER:
SCALE:	NTS	DATE: 11/8/20	ERC016X




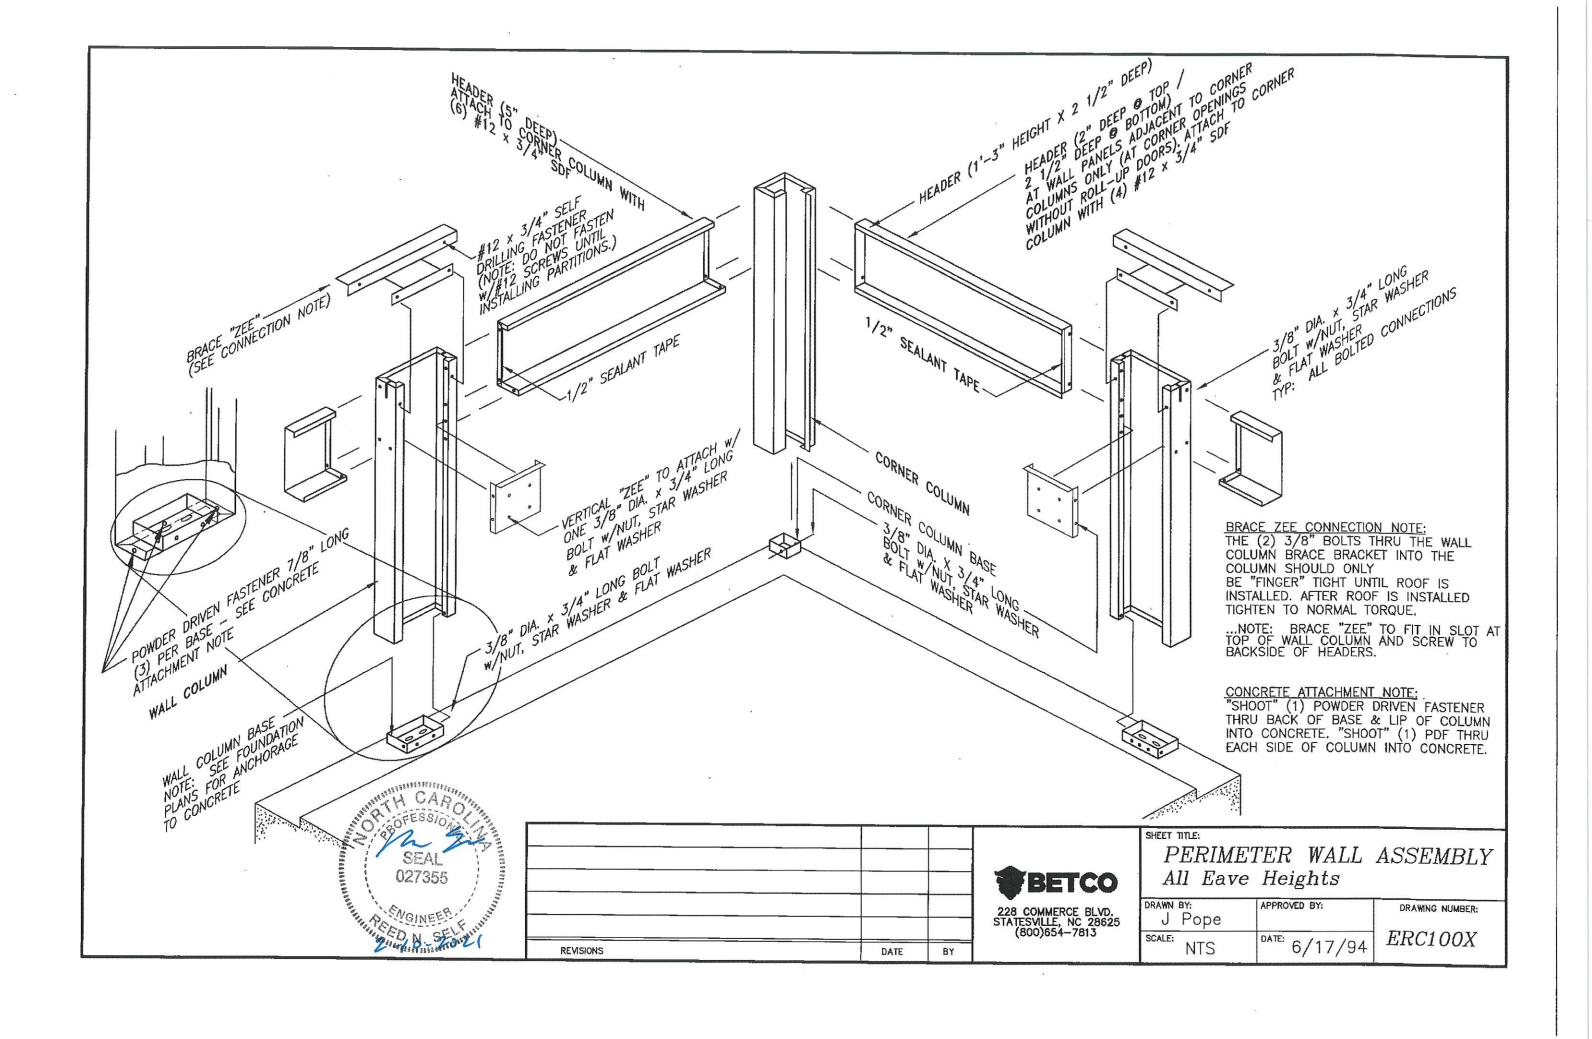


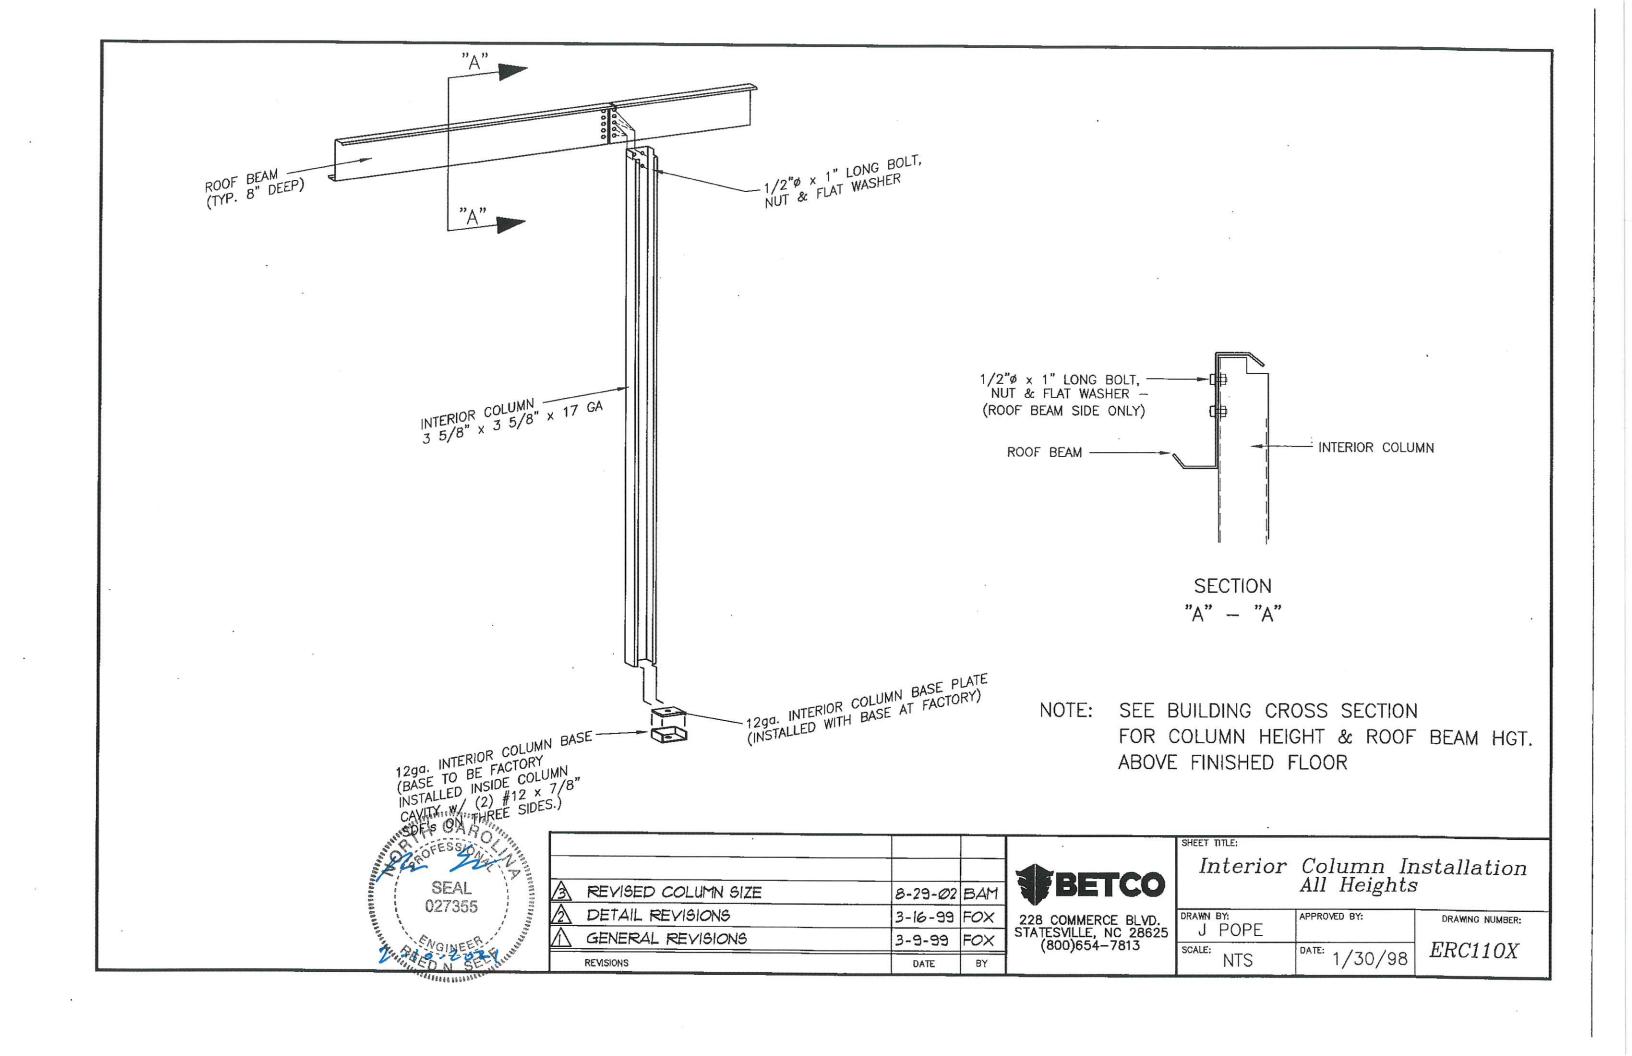


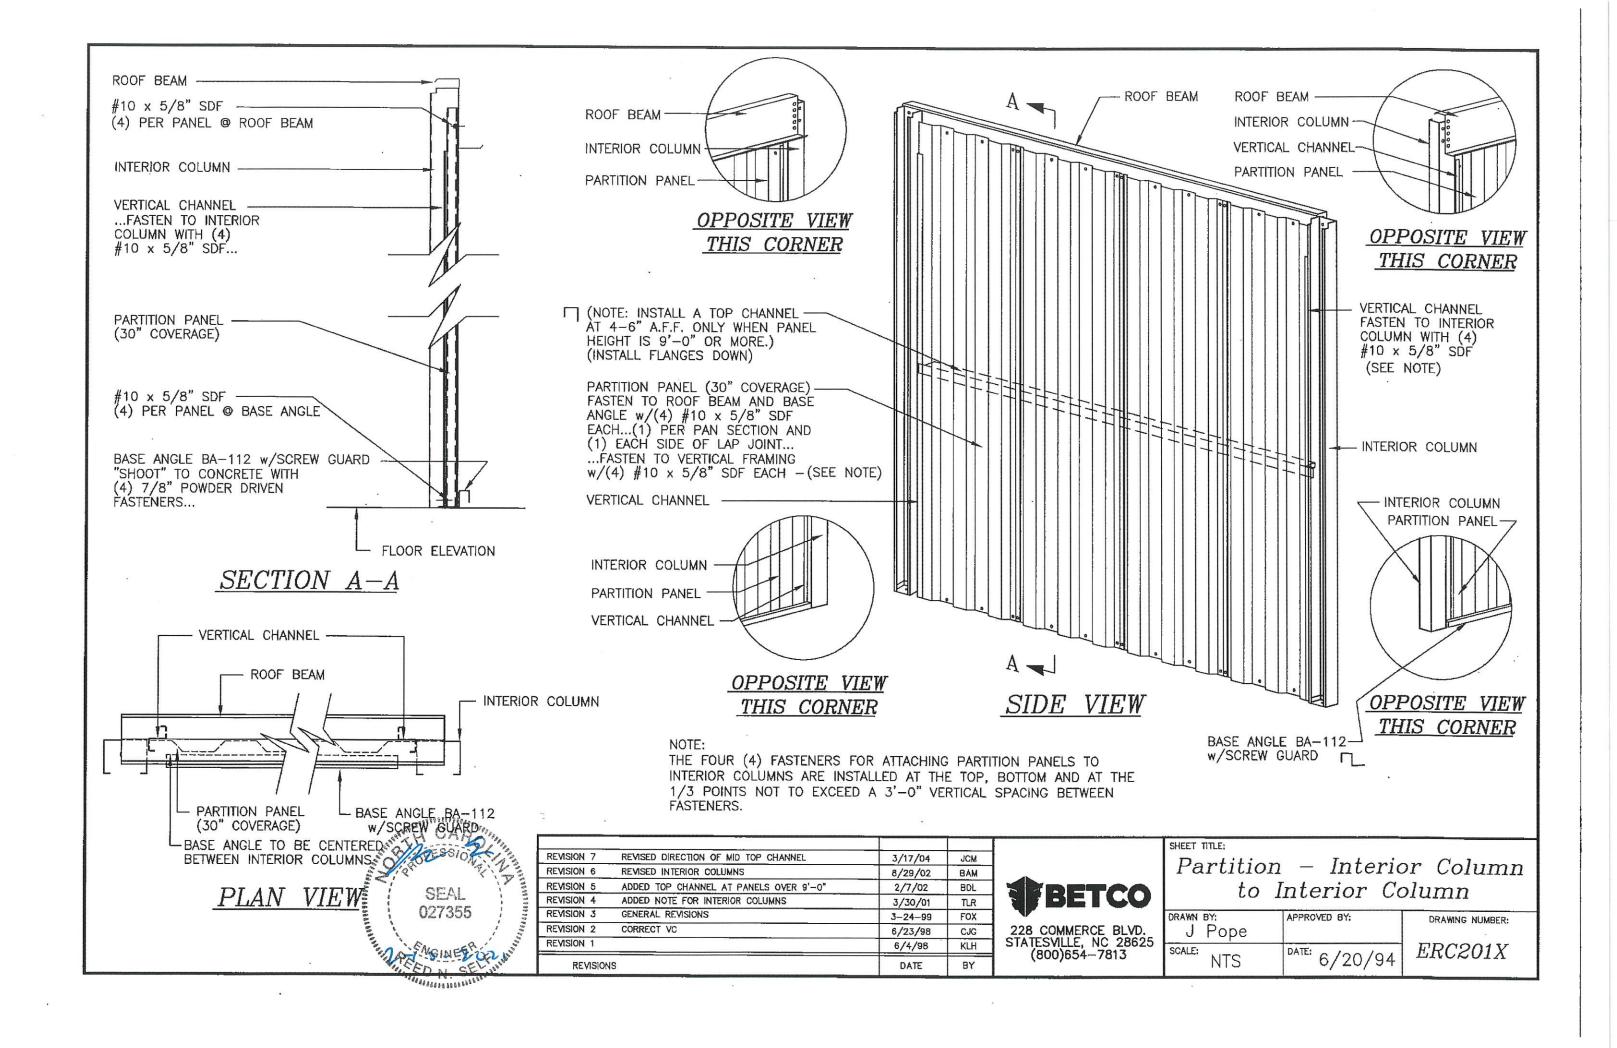


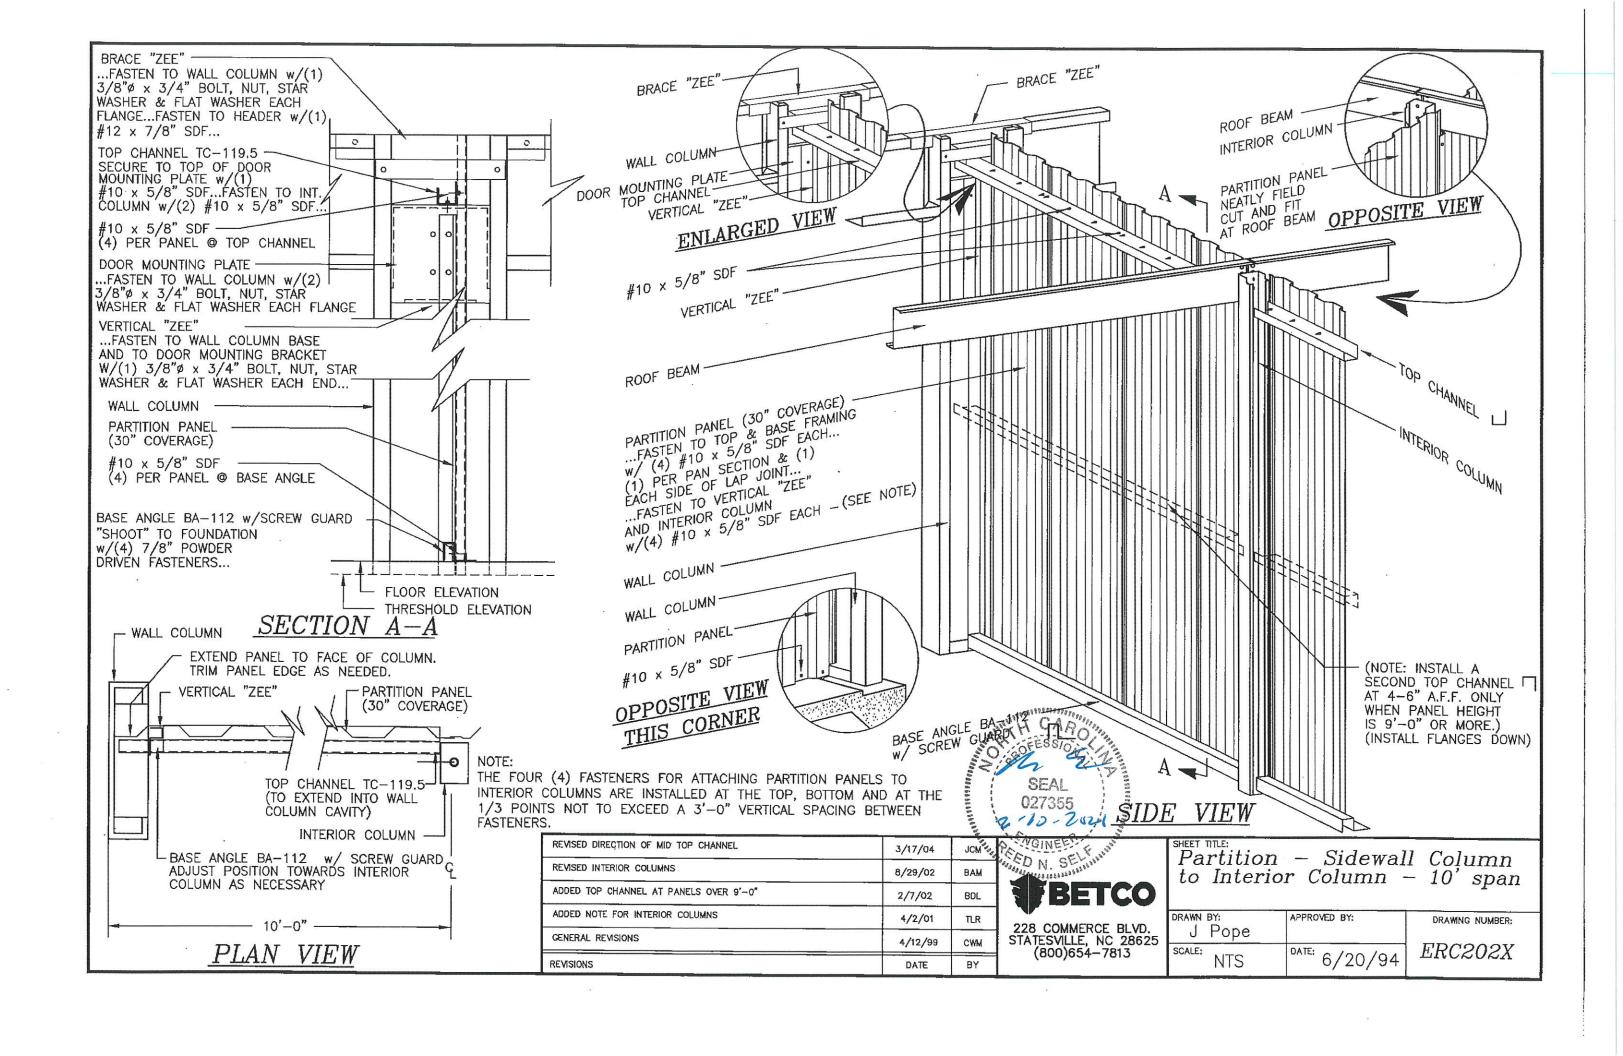


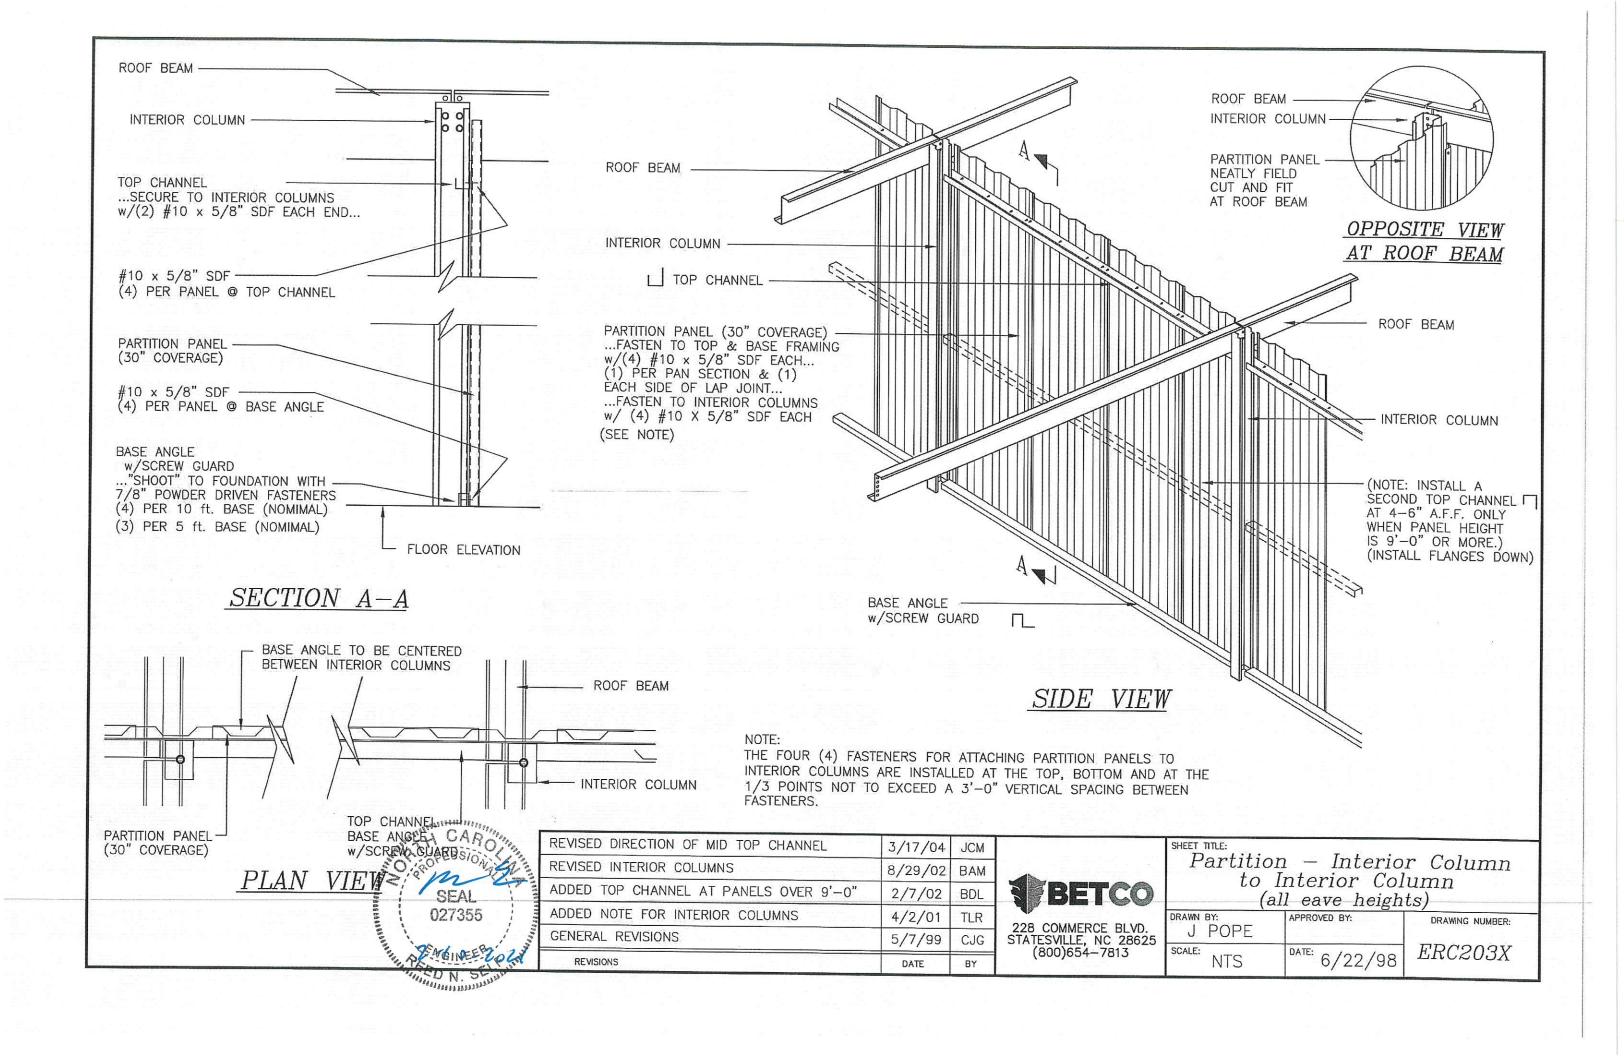


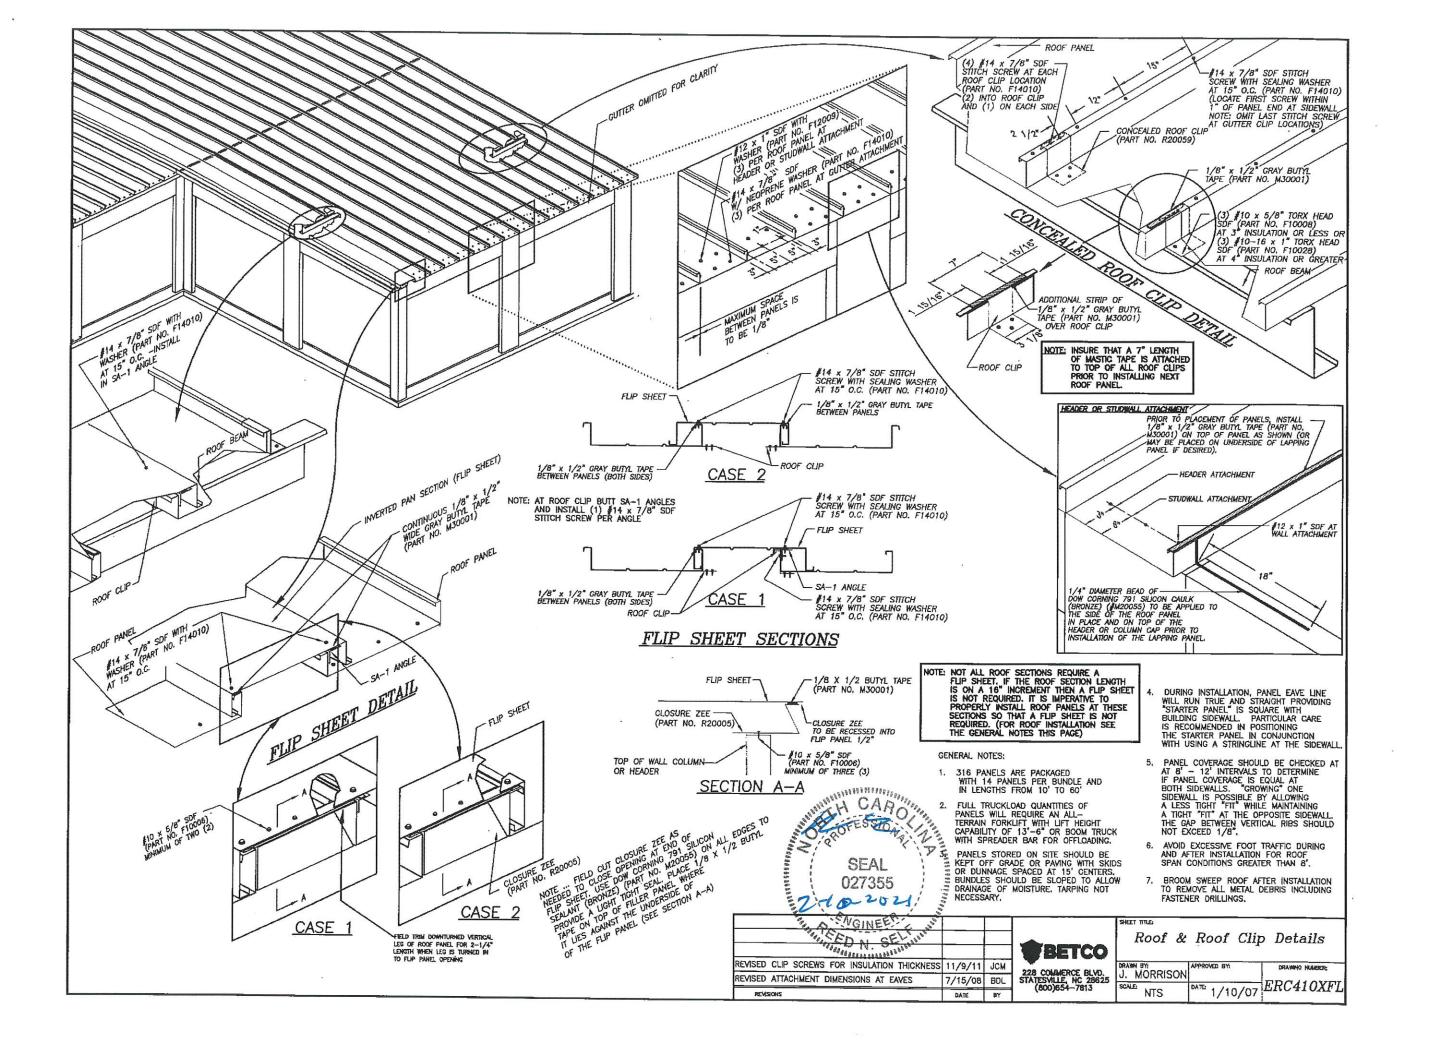

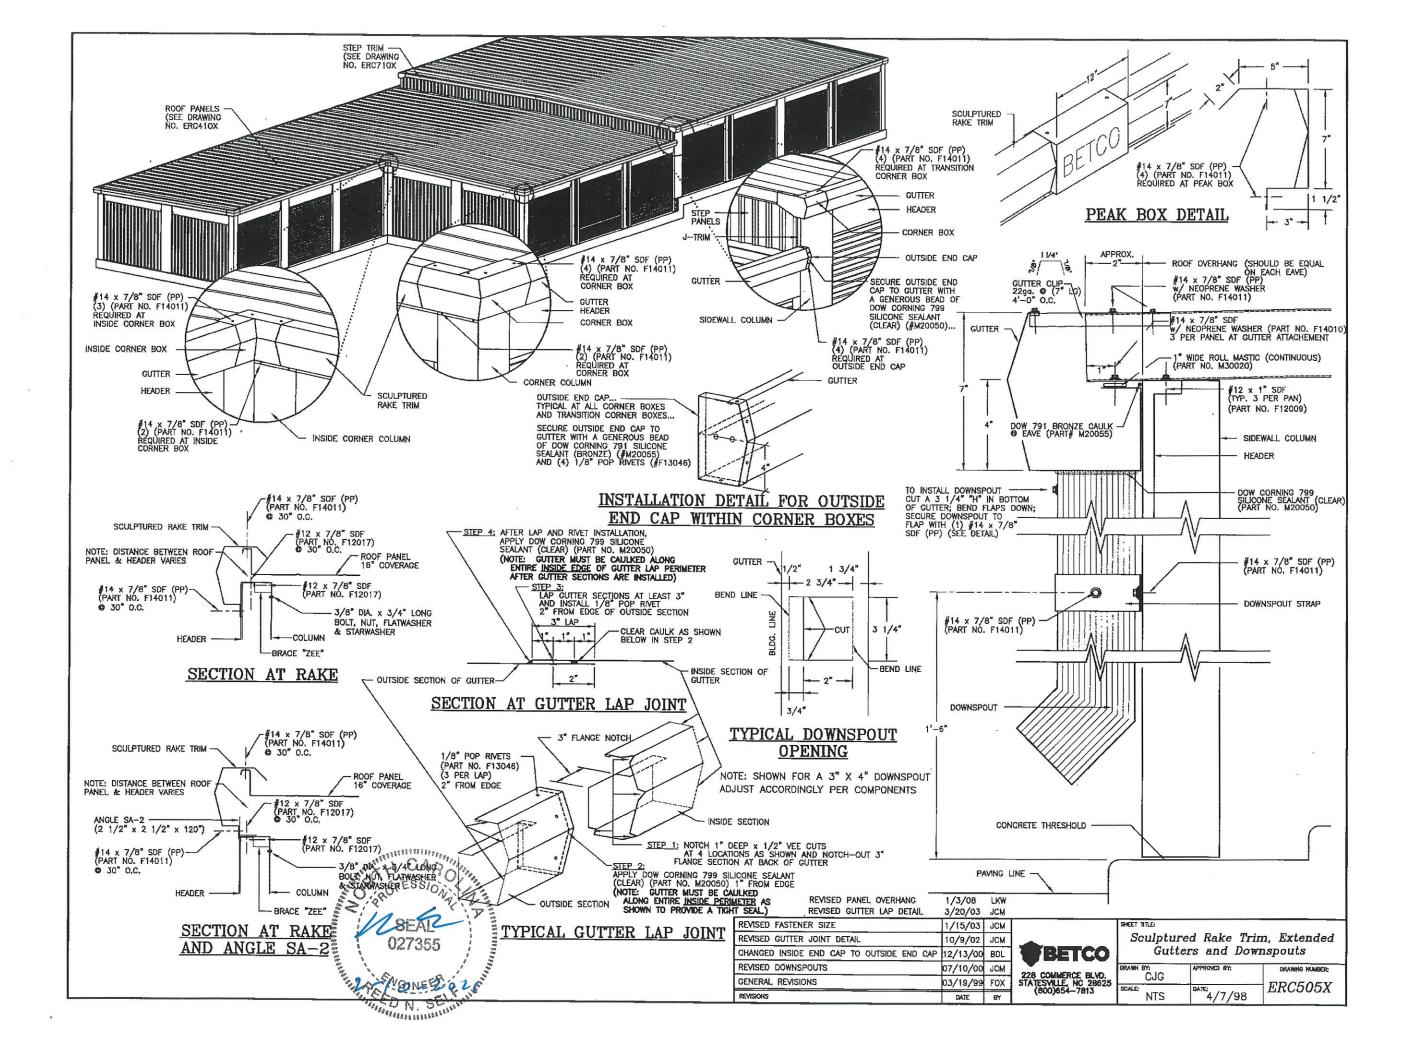

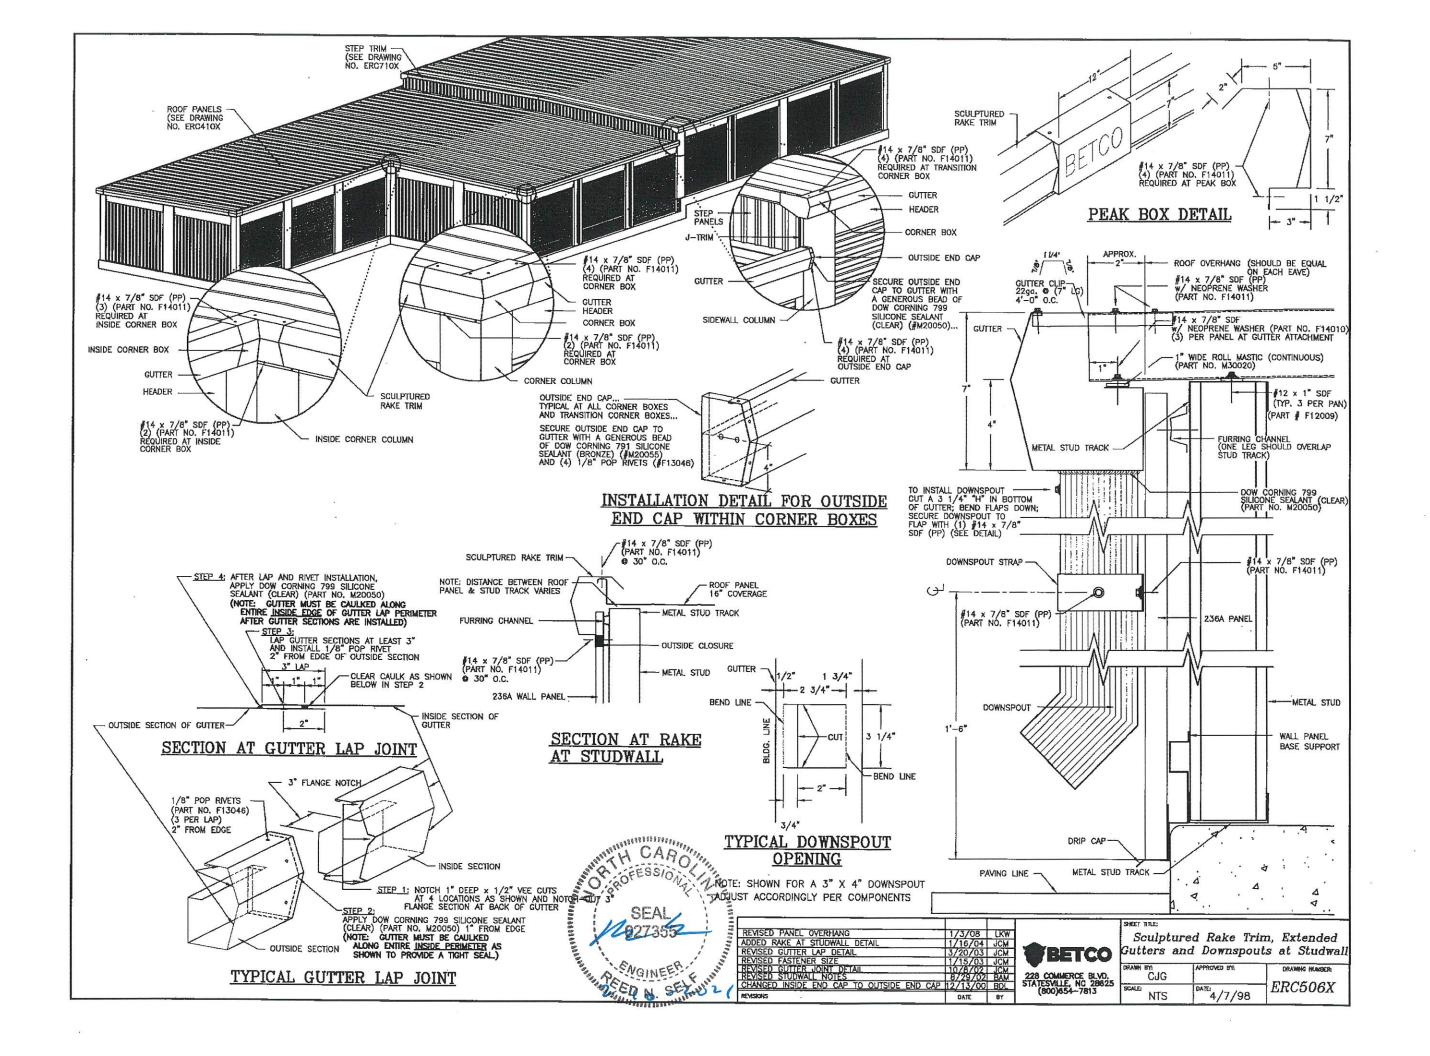

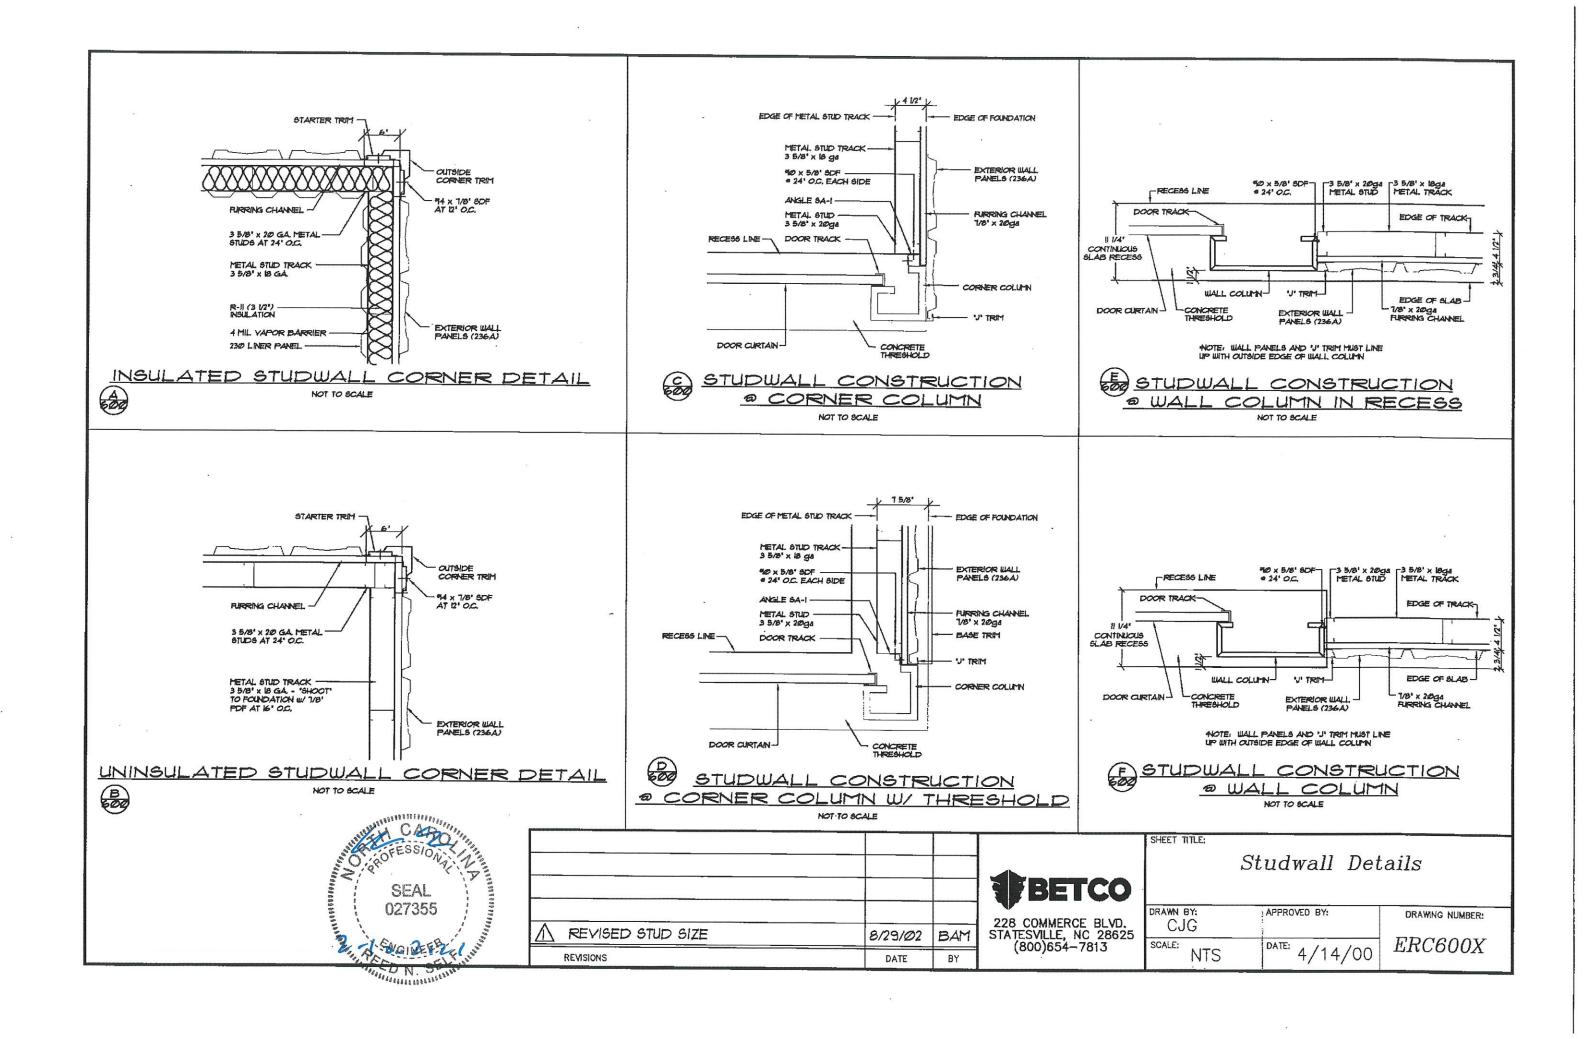

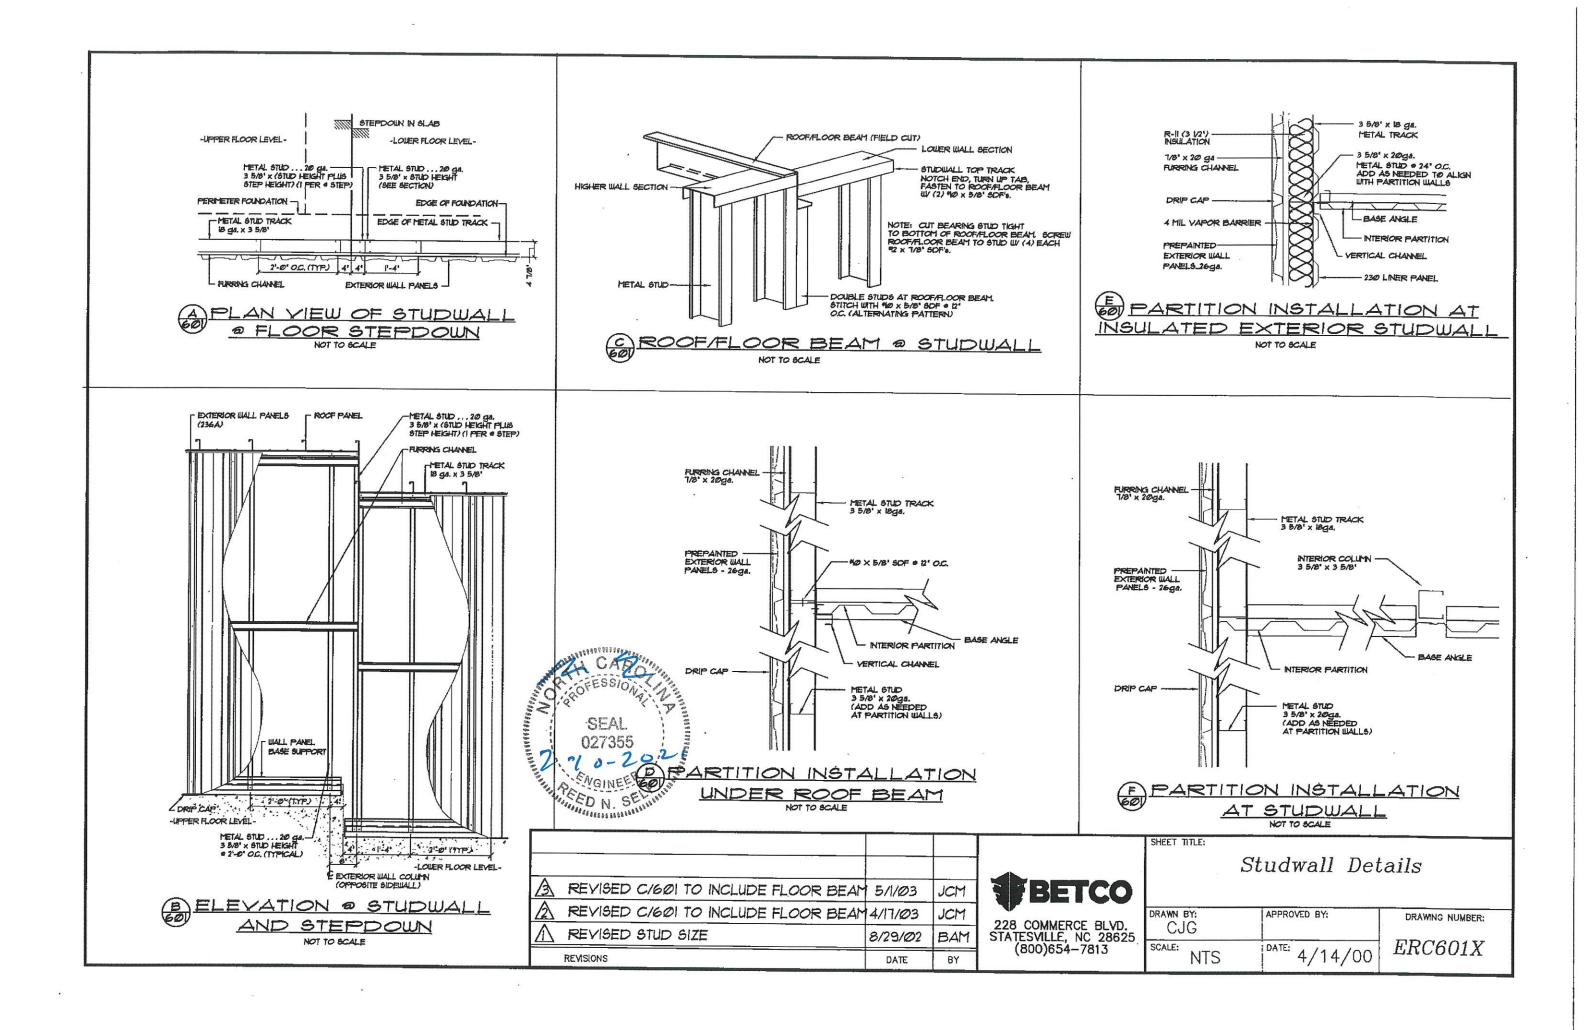

#### EXTERIOR STUDWALL CONSTRUCTION . FLAT SLAB: (SEE ERC630X)

-3 5/8" METAL STUDS @ 24" O.C. - 20ga -3 5/8" CONTINUOUS FLOOR AND CEILING TRACK - 18gg, - FASTEN W/3/8" x 3" WEDGE ANCHOR (2" MIN, EMBEDDMENT) @ 30" O.C. MAX -2 OR 3 ROWS CONTINUOUS 20gg, FURRING CHANNELS (NOTE #2) -PRE-PAINTED EXTERIOR 236A WALL PANELS -WALL PANEL BASE SUPPORT -DRIP CAP (#T60120)
\*3 1/2" THICK FIBERGLASS INSULATION
\*4 MIL POLYETHYLENE VAPOR BARRIER \*230 LINER PANELS @ INTERIOR (ATTACH EACH PANEL TO BASE & TOP TRACK WITH 4 EACH #10 x 5/8" SDF's) \*J-TRIM ® TOP OF LINER PANELS
-SEE NOTE #4 FOR GENERAL STUDWALL CONSTRUCTION NOTES.

#### EXTERIOR STUDWALL CONSTRUCTION . RECESS: (SEE ERC630X)

-3 5/8" METAL STUDS @ 24" O.C. - 20ga -3 5/8" CONTINUOUS FLOOR AND CEILING TRACK — 18ga. — FASTEN W/3/8" x 3" WEDGE ANCHOR (2" MIN. EMBEDDMENT) @ 30" O.C. MAX
-3 OR 4 ROWS CONTINUOUS 20ga, FURRING CHANNELS (NOTE #2)
-PRE-PAINTED EXTERIOR 236A WALL PANELS
-BASE TRIM (#T60593) \*3 1/2" THICK FIBERGLASS INSULATION \*4 MIL POLYETHYLENE VAPOR BARRIER \*230 LINER PANELS @ INTERIOR (ATTACH EACH PANEL TO BASE & TOP TRACK WITH 4 EACH #10 x 5/8" SDF's) \*J-TRIM @ TOP OF LINER PANELS -SEE NOTE #4 FOR GENERAL STUDWALL CONSTRUCTION NOTES.

#### INSULATED LOAD BEARING STUDWALL:

-3 5/8" METAL STUDS @ 24" O.C. - 20ga ~3 5/8" CONTINUOUS FLOOR AND CEILING TRACK - 18gg. - FASTEN w/3/8" x 3" WEDGE ANCHOR (2" MIN. EMBEDDMENT) ⊕ 30" O.C. MAX -3 1/2" THICK FIBERGLASS INSULATION -4 MIL POLYETHYLENE VAPOR BARRIER -230 LINER PANELS (EACH SIDE-ATTACH EACH PANEL TO TOP & BASE TRACK WITH 4 EACH #10 x 5/8" SDF's)

-J-TRIM @ TOP OF LINER PANELS -SEE NOTE #4 FOR GENERAL STUDWALL CONSTRUCTION NOTES.

#### INSULATED NON-LOAD BEARING STUDWALL:

-3 5/8" METAL STUDS @ 24" O.C. - 20ga -3 5/8" CONTINUOUS FLOOR AND CEILING TRACK - 20ga. (ATTACH BASE TRACK TO CONCRETE FLOOR SLAB WITH 7/8" PDF's @ 24" O.C) -3 1/2" THICK FIBERGLASS INSULATION

-4 MIL POLYETHYLENE VAPOR BARRIER -230 LINER PANELS (EACH SIDE-ATTACH EACH PANEL TO TOP & BASE TRACK WITH 4 EACH #10 x 5/8" SDF's)

-J-TRIM @ TOP OF LINER PANELS -SEE NOTE #4 FOR GENERAL STUDWALL CONSTRUCTION NOTES.

#### EXTERIOR STUDUALL CONSTRUCTION . HYAC

INSET/ ALCOVE: . . (ERC 603X 4 604X) -3 5/8" METAL STUDS @ 24" O.C. - 20ga -3 5/8" CONTINUOUS FLOOR AND CEILING TRACK - 18gg, - FASTEN W/3/8" x 3" WEDGE ANCHOR (2" MIN. EMBEDDMENT) @ 30" O.C. MAX
-3 OR 4 ROWS CONTINUOUS 20gg. FURRING CHANNELS (NOTE #2)
-PRE-PAINTED EXTERIOR 236A WALL PANELS
-DRIP CAP (#T50032) \*3 1/2" THICK FIBERGLASS INSULATION \*4 MIL POLYETHYLENE VAPOR BARRIER \*230 LINER PANELS @ INTERIOR (ATTACH EACH PANEL TO BASE & TOP TRACK WITH 4 EACH #10 x 5/8" SDF's) \*J-TRIM @ TOP OF LINER PANELS -SEE NOTE #4 FOR GENERAL STUDWALL CONSTRUCTION NOTES.

# FIRE RESISTANT PARTITION ... I HOUR RATED UL • U465. ... (NON-LOAD BEARING)

ONE HOUR FIREWALL CONSTRUCTION:

-3 5/8" METAL STUDS ⊕ 24" O.C. - 20ga. -3 5/8" CONTINUOUS FLOOR and CEILING TRACK - 20ga (TOP TRACK MUST FOLLOW SLOPE OF ROOF DECK) (SECURE BOTTOM TRACK W/ 7/8" PDF'S AT 24" O.C.) -5/8" GYPSUM BOARD (X—RATED) EACH SIDE IT MUST

BE PLACED SUCH THAT ALL JOINTS ARE VERTICAL.

-GYPSUM BOARD SHALL BE ATTACHED TO STUDS, FLOOR
AND CEILING TRACK USING TYPE "S" SELF—TAPPING SCREWS

ALONG EDGES OF BOARD SPACED 8" O.C. AND 12" O.C. IN THE FIELD.

-VINYL OR CASE—IN, DRY OR PRE—MIXED JOINT COMPOUND APPLIED IN
TWO COATS TO JOINTS SCREW—HEADS. PERFORATED PAPER TAPE, 2"
WIDE, EMBEDDED IN FIRST LAYER OF COMPOUND OVER ALL JOINTS.

\*3 1/2" THICK FIBERGLASS INSULATION

\*4 MIL POLYFTIM FNE VAPOR BARBIER \*4 MIL POLYETHYLENE VAPOR BARRIER -SEE NOTE #4 FOR GENERAL STUDWALL CONSTRUCTION NOTES.

#### FIRE RESISTANT PARTITION ... I HOUR RATED UL \* U425. . . (LOAD BEARING)

ONE HOUR FIREWALL CONSTRUCTION:

-3 5/8" METAL STUDS @ 24" O.C. - 20ga. -3 5/8" CONTINUOUS FLOOR & CEILING TRACK - 18gg - FASTEN w/ 3/8" x 3" WEDGE ANCHOR (2" MIN. EMBEDDMENT) @ 30" O.C. MAX (TOP TRACK MUST FOLLOW SLOPE OF ROOF DECK) -5/8" GYPSUM BOARD (X-RATED) EACH SIDE IT MUST BE PLACED SUCH THAT ALL JOINTS ARE VERTICAL.

-GYPSUM BOARD SHALL BE ATTACHED TO STUDS,
FLOOR AND CEILING TRACK USING TYPE "S" SELF-TAPPING SCREWS ALONG EDGES OF BOARD SPACED 8" O.C. AND 12" O.C. IN THE FIELD. -VINYL OR CASE-IN, DRY OR PRE-MIXED JOINT COMPOUND APPLIED IN TWO COATS TO JOINTS SCREW-HEADS. PERFORATED PAPER TAPE, 2" WIDE, EMBEDDED IN FIRST LAYER OF COMPOUND OVER ALL

THICK FIBERGLASS INSULATION \*4 MIL POLYETHYLENE VAPOR BARRIER

-SEE NOTE #4 FOR GENERAL STUDWALL CONSTRUCTION NOTES.

#### EXTERIOR FIRE RESISTANT PARTITION .... -UL \* U423, , (I HOUR RATED) (LOAD BEARING)

ONE HOUR FIREWALL CONSTRUCTION:

SEAL

027355

NGINEER SED N. SEL

CADON

-3 5/8" METAL STUDS @ 24" O.C. - 20ga. -3 5/8" CONTINUOUS FLOOR AND CEILING TRACK - 18ga. - FASTEN W/3/8" x 3" WEDGE ANCHOR (2" MIN. EMBEDDMENT) ⊕ 30" O.C. MAX (TOP TRACK MUST FOLLOW SLOPE OF ROOF DECK) -2 OR 3 ROWS CONTINUOUS 20ga, FURRING CHANNELS (NOTE #2)
-PRE-PAINTED EXTERIOR 236A WALL PANELS -PRE-PAINTED EXTERIOR 236A WALL PANELS

-WALL PANEL BASE SUPPORT

-DRIP CAP (#T60120)

-1 LAYER 5/8" GYPSUM BOARD (X-RATED) EACH SIDE IT MUST

BE PLACED SUCH THAT ALL JOINTS ARE VERTICAL.

-GYPSUM BOARD SHALL BE ATTACHED TO STUDS,
FLOOR AND CEILING TRACK USING TYPE "S"

SELF-TAPPING SCREWS ALONG EDGES OF BOARD

SPACED 8" O.C. AND 12" O.C. IN THE FIELD.

-VINYL OR CASE-IN, DRY OR PRE-MIXED JOINT

COMPOUND APPLIED IN TWO COATS TO JOINTS

SCREW-HEADS PERFORATED PARED TABLE 2" WIDE

SCREW-HEADS. PERFORATED PAPER TAPE, 2" WIDE, EMBEDDED IN FIRST LAYER OF COMPOUND OVER ALL

JOINTS.
\*3 1/2" THICK FIBERGLASS INSULATION
\*4 MIL POLYETHYLENE VAPOR BARRIER

-SEE NOTE #4 FOR GENERAL STUDWALL CONSTRUCTION NOTES.

# EXTERIOR FIRE RESISTANT PARTITIONS • RECESS: UL • U423. . . . (I HOUR RATED) (LOAD BEARING)

ONE HOUR FIREWALL CONSTRUCTION:

-3 5/8" METAL STUDS @ 24" O.C. - 20ga. -3 5/8" CONTINUOUS FLOOR AND CEILING TRACK - 18gg. - FASTEN W/3/8" x 3" WEDGE ANCHOR (2" MIN. EMBEDDMENT) @ 30" O.C. MAX (TOP TRACK MUST FOLLOW SLOPE OF ROOF DECK)

-3 OR 4 ROWS CONTINUOUS 20ga, FURRING CHANNELS (NOTE #2)
-PRE-PAINTED EXTERIOR 236A WALL PANELS

-DRIP CAP (#T60593)
-1 LAYER 5/8" GYPSUM BOARD (X-RATED) EACH SIDE IT MUST BE PLACED SUCH THAT ALL JOINTS ARE VERTICAL. BE PLACED SUCH THAT ALL JUINIS ARE VERTICAL.

-GYPSUM BOARD SHALL BE ATTACHED TO STUDS, FLOOR
AND CEILING TRACK USING TYPE "S" SELF-TAPPING SCREWS
ALONG EDGES OF BOARD SPACED 8" O.C. AND 12" O.C. IN THE FIELD.

-VINYL OR CASE-IN, DRY OR PRE-MIXED JOINT COMPOUND APPLIED IN
TWO COATS TO JOINTS SCREW-HEADS. PERFORATED PAPER TAPE, 2"
WIDE, EMBEDDED IN FIRST LAYER OF COMPOUND OVER ALL JOINTS.

\*3 1/2" THICK FIBERGLASS INSULATION

\*4 MIL POLYETHYLENE VAPOR BARRIER
-SEE NOTE #4 FOR GENERAL STUDWALL CONSTRUCTION NOTES.

# EXTERIOR FIRE RESISTANT PARTITION • HYAC: INSET/ALCOVE UL • 423 . (1 HOUR RATED) (LOAD BEARING) (ERC 620X 4 621X)

ONE HOUR FIREWALL CONSTRUCTION:

-3 5/8" METAL STUDS @ 24" O.C. - 20ga. -3 5/8" CONTINUOUS FLOOR AND CEILING TRACK - 18ga. - FASTEN w/3/8" x 3" WEDGE ANCHOR (2" MIN. EMBEDDMENT) @ 30" O.C. MAX (TOP TRACK MUST FOLLOW SLOPE OF ROOF DECK)

-3 OR 4 ROWS CONTINUOUS 20gg. FURRING CHANNELS (NOTE #2)

-PRE-PAINTED EXTERIOR 236A WALL PANELS

-PRE-PAINTED EXTERIOR 236A WALL PANELS
-DRIP CAP (#T50032)
-1 LAYER 5/8" GYPSUM BOARD (X-RATED) EACH SIDE IT MUST
BE PLACED SUCH THAT ALL JOINTS ARE VERTICAL.
-GYPSUM BOARD SHALL BE ATTACHED TO STUDS, FLOOR
AND CEILING TRACK USING TYPE "S" SELF—TAPPING SCREWS
ALONG EDGES OF BOARD SPACED 8" O.C. AND 12" O.C. IN THE FIELD.
-VINYL OR CASE—IN, DRY OR PRE—MIXED JOINT COMPOUND APPLIED IN
TWO COATS TO JOINTS SCREW—HEADS. PERFORATED PAPER TAPE, 2"
WIDE, EMBEDDED IN FIRST LAYER OF COMPOUND OVER ALL JOINTS.
\*3 1/2" THICK FIRERGLASS INSULATION.

\*3 1/2" THICK FIBERGLASS INSULATION

\*4 MIL POLYETHYLENE VAPOR BARRIER

-SEE NOTE #4 FOR GENERAL STUDWALL CONSTRUCTION NOTES.

NOTE #1: INTENTIONALLY BLANK.

NOTE #2: AS PER WALL CONSTRUCTION NOTES, EXTERIOR STUDWALLS ARE CONSTRUCTED WITH "X" OR "Y" ROWS OF FURRING CHANNELS IF WALL IS LESS THAN 9'-10 1/2" HGT. A.F.F., CONSTRUCT WITH "X" ROWS; OTHERWISE USE "Y".

NOTE #3: "\*" ON THIS SHEET, REFERS TO THE ADDITIONAL MATERIALS REQUIRED FOR INSULATION OF WALL SYSTEM. NOT ALL WALLS ARE INSULATED. VERIFY WITH FLOOR PLANS, INSTALL INSULATION & RELATED MATERIALS ONLY IN WALLS DESIGNATED WITH AN "\*" BESIDE THE DETAIL NUMBER ON THE FLOOR PLAN.

NOTE #4: GENERAL STUDWALL CONSTRUCTION:

A) -- ATTACH STUDS WITH #10 X 5/8" SDF'S EACH SIDE OF TRACK (4 PER STUD).

B) -- WALLS MUST EXTEND FROM FLOOR TO ROOF DECK

AND INTO WALL COLUMN CAVITY.

- TOP TRACK MUST FOLLOW SLOPE OF ROOF LINE.


-			
	DEVICED CTUD TOLON FACTIVEDS TO ASSOCIATE	0/04/45	1011
	REVISED STUD TRACK FASTENERS TO CONCRETE REVISED STUD TRACK FASTENERS	9/24/10	JCM
	REVISED STUD SIZE	8/29/02	BAM
-	REVISE LAYERS, GYPSUM BOARD THICKNESS & UL ON NOTES #8, 9, 10	11/16/01	JRB
	ADDED ERC 620X & 621X TO NOTE #10	08/28/01	JCM
	CHANGED 5/8" TO (2 LAYERS 1/2")	02/21/01	DSF
	REVISIONS	DATE	BY




228 COMMERCE BLVD. STATESVILLE, NC 28625 (800)654-7813 SHEET TITLE:

#### Studwall Notes

DRAWN BY:	APPROVED BY:	DRAWING NUMBER:
scale: NTS	DATE: 11/02/00	ERC610X

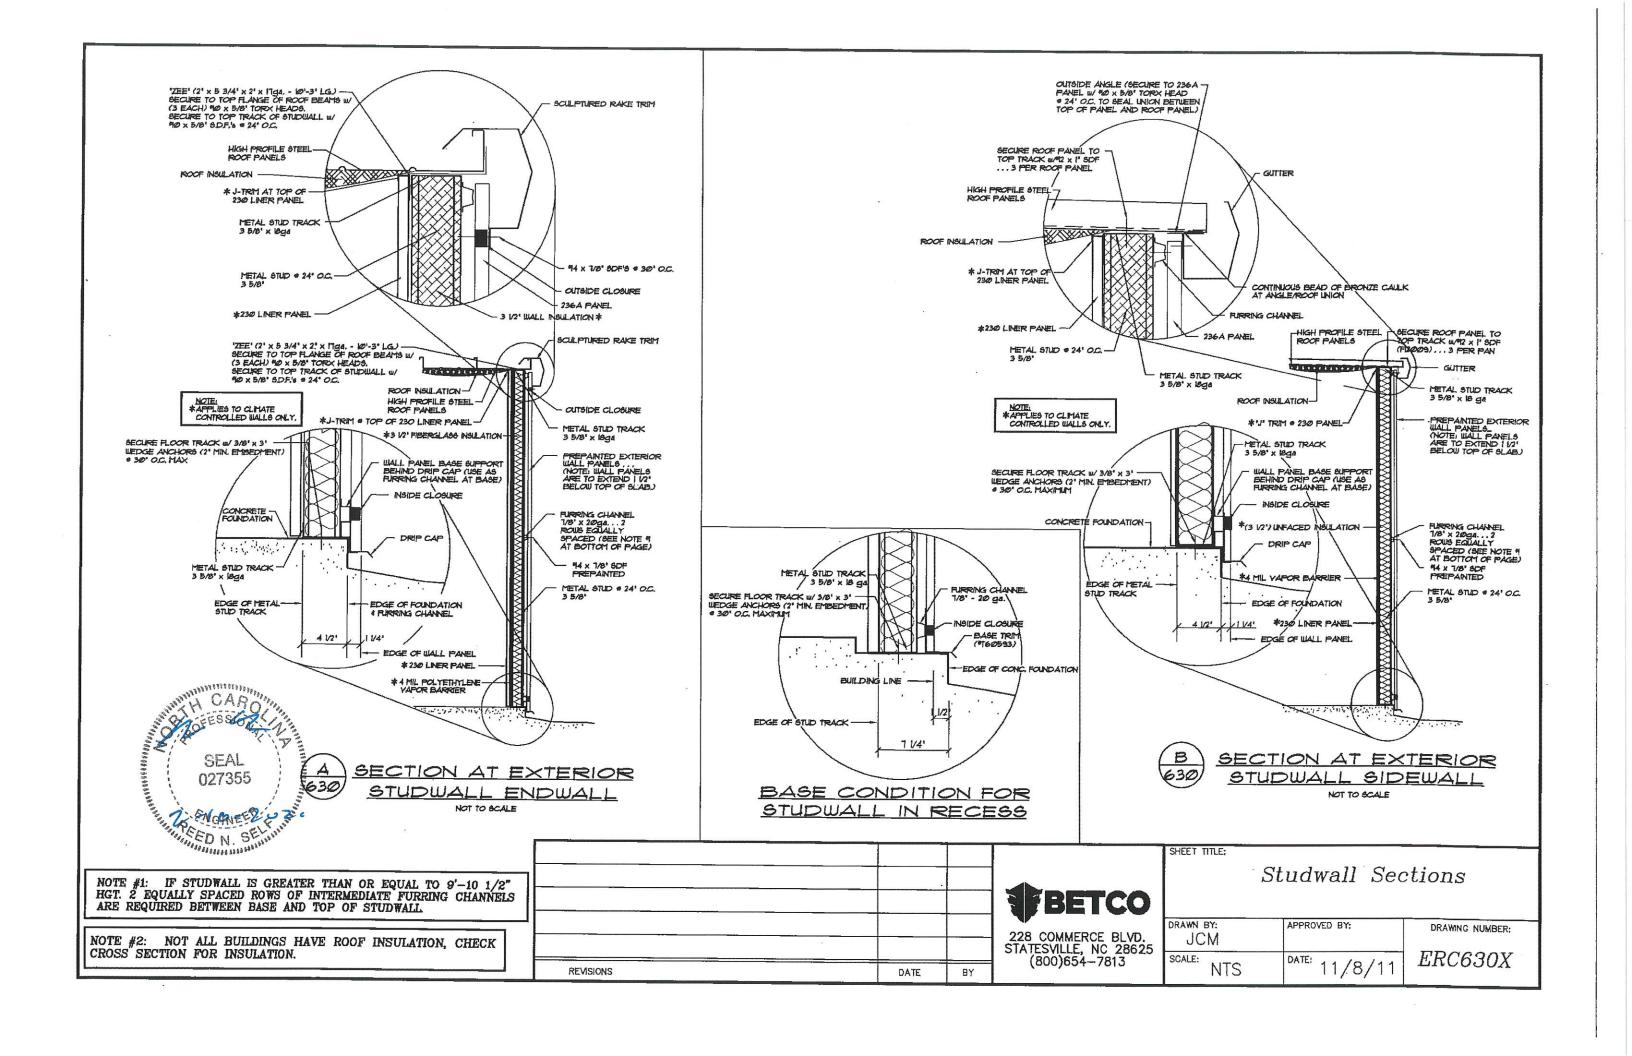

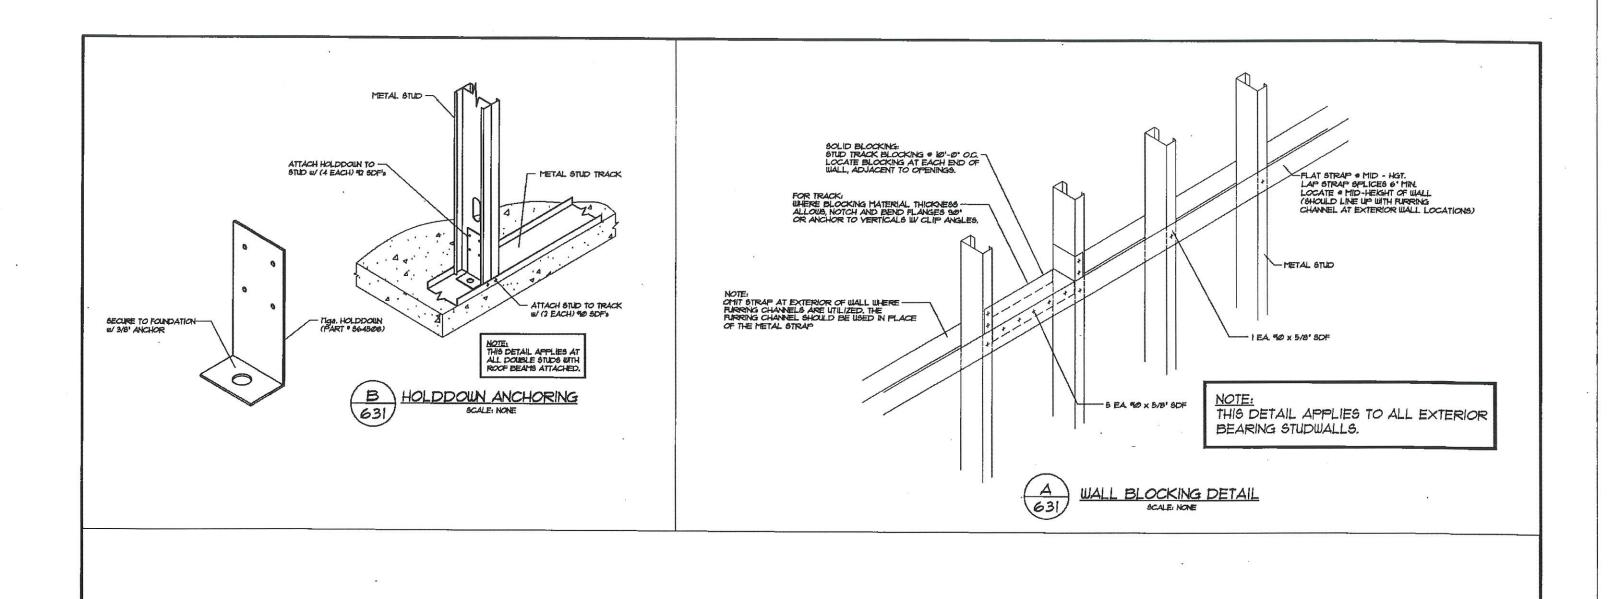




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REVISIONS	DATE	BY

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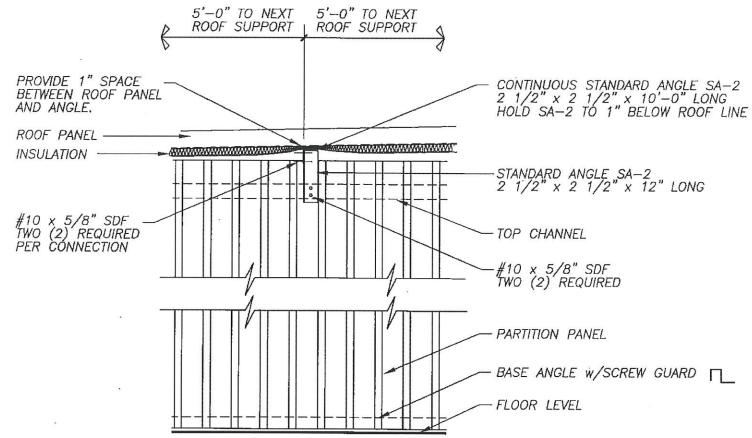
228 COMMERCE BLVD. STATESVILLE, NC 28625 (800)654-7813 SHEET TITLE:

### Studwall Details


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SCALE: NTS	DATE: 11/8/11	ERC631X

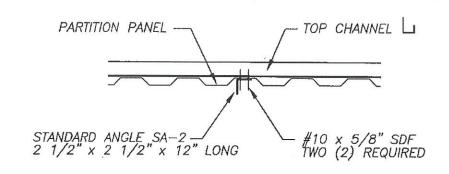


## PLAN VIEW



# ELEVATION AT INTERMEDIATE INSULATION SUPPORT

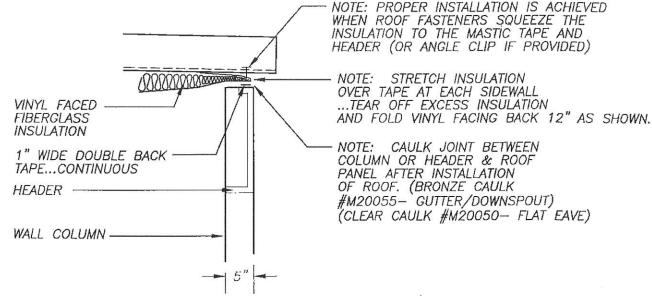

# INSULATION INSTALLATION @ SIDEWALL

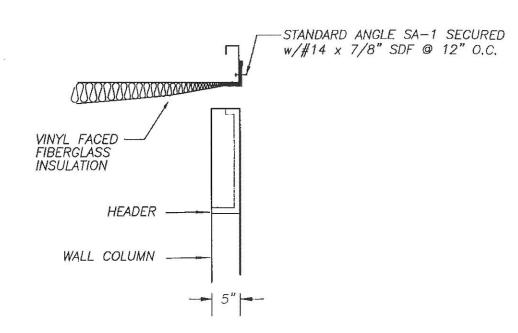

# INSULATION INSTALLATION AT END WALL




ADDED ROOF FASTENER NOTE	4/17/03	JCM
REVISED SA-2 GAP	1/14/03	BAM
⚠ GENERAL REVISIONS	3-8-99	FOX
REVISIONS	DATE .	BY




228 COMMERCE BLVD. STATESVILLE, NC 28625 (800)654-7813 SHEET TITLE:


Insulation installation

DRAWN BY: J Pope	APPROVED BY:	DRAWING NUMBER:
scale: NTS	DATE: 6-27-94	ERC700X

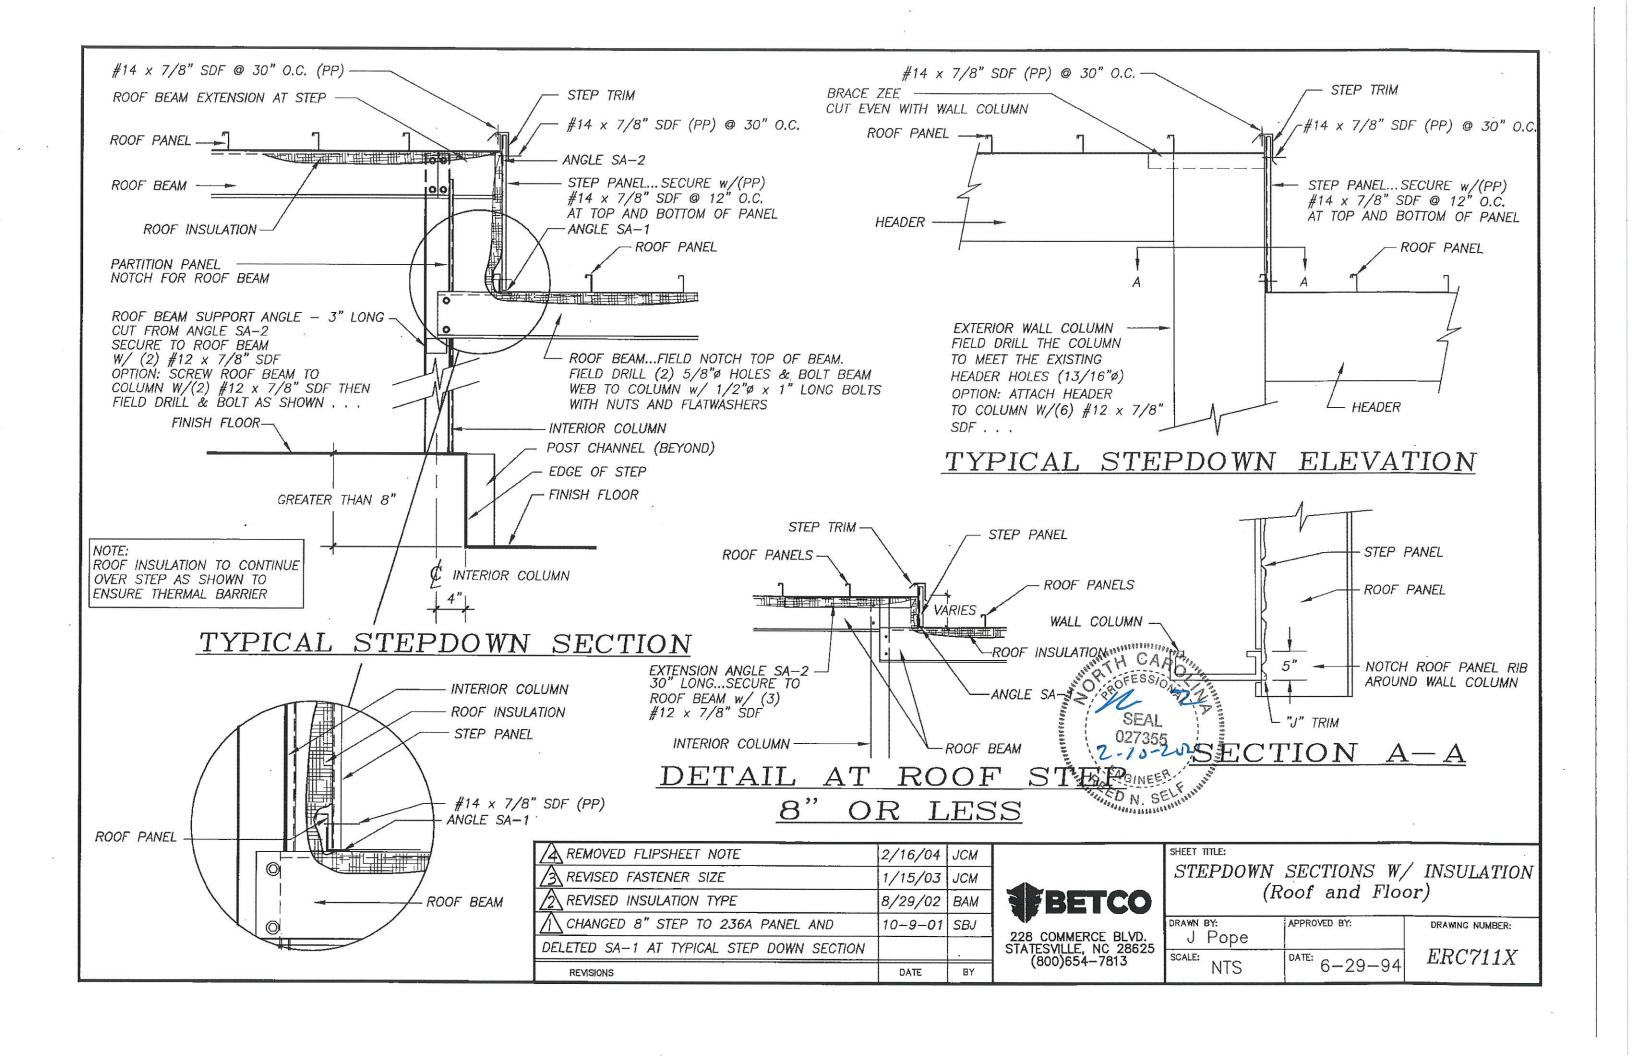

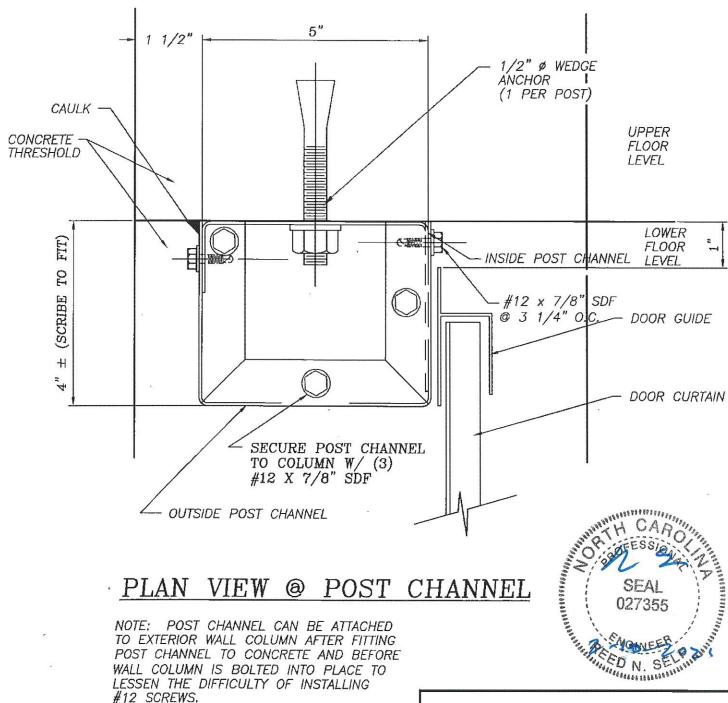

NOTE: SCRIBE OUTSIDE POST CHANNEL (9" LEG) TO FIT AGAINST CONCRETE. THEN APPLY CAULK OVER SEAM TO SEAL CUT EDGES. TRIM BOTTOM AS NEEDED. CAULK AROUND BOTTOM TO SEAL CUT EDGE. FASTEN W/(4) PREPAINTED #14 X 7/8" SDF SCREWS @ 3 1/4" O.C. ON OUTSIDE FACE OF OUTSIDE POST CHANNEL. FASTEN OUTSIDE POST CHANNEL TO WALL COLUMN W/ (3) #12 X 7/8" S.D.F.

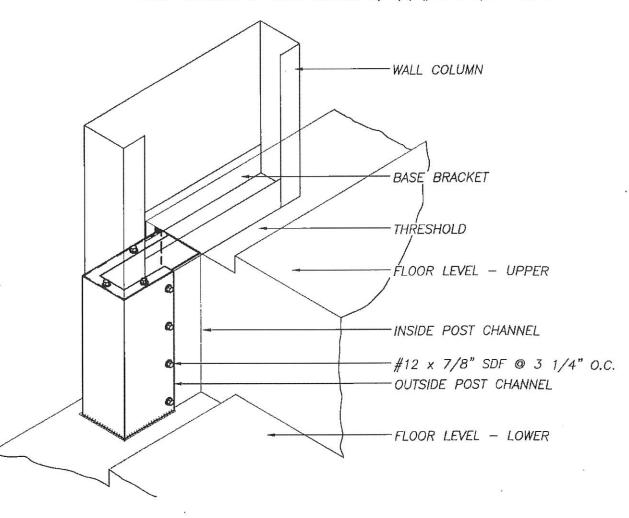

POST CHANNEL DETAIL
AT FLOOR STEP

SHEET TITLE:

A PEVICED EACTENED CITE	1/15 /@22	ICM
REVISED FASTENER SIZE  REVISED FASTENER SIZE	1/15/Ø3 3-8-99	JCM FOX
REVISIONS	DATE	BY



Post Channel Details

DRAWN BY: J Pope	APPROVED BY:	DRAWING NUMBER:
SCALE: NTS	DATE: 6-28-94	ERC712X

