DESIGN LOADS:

REFERENCE: BUILDING CODE OF NORTH CAROLINA (LATEST EDITION)

CLASSIFICATION OF BUILDING: CATEGORY/USE GROUP $_$ \square

FLOOR: 100 PSF

WIND: 144 MPH ASD (IN ACCORDANCE WITH ASCE-7)

WIND 1.0

SEISMIC 1.0 SNOW 1.0

EXPOSURE: C 10 PSF GROUND SNOW:

LATERAL DESIGN CONTROL:

EARTHQUAKE: ____ WIND: $\underline{\times}$

IMPORTANCE FACTOR:

CALCULATED WIND BASE SHEARS (FOR MWYFRS):

Vx= 16.1 K √y= 16.1 K

ANALYSIS PROCEDURE:

EQUIVALENT LATERAL FORCE

SEISMIC DESIGN PARAMETERS:

SPECTRAL RESPONCE ACCELERATION: Sms = 0.188 Sds = 0.125 $Smi = \emptyset.143$ $Sdi = \emptyset.096$

SEISMIC USE GROUP: SEISMIC DESIGN CATEGORY:

SITE CLASSIFACTION:

BASIC STRUCTURAL SYSTEM: BUILDING FRAME SYSTEM

REPONSE MODIFICATION FACTOR: **R**x= 3 **R**y= 3 DEFLECTION AMPLIFICATION FACTOR: Cdx = 3

Cdy= 3

BUILDING HEIGHT LIMIT, FEET: H= NL SEISMIC BASE SHEAR: ∨= 2*0.*5 K

FOUNDATIONS

- 1. PRESUMED SOIL BEARING CAPACITY IS 1500 PSF ON FIRM VIRGIN SOIL OR COMPACTED FILL.
- 2. FILL MATERIAL SHALL BE FREE OF ROOTS. WOOD OR OTHER ORGANIC MATERIAL.
- 3. FILL SHALL BE PLACED IN 8 INCH LIFTS AND COMPACTED TO 95 PERCENT OF THE OPTIMUM DENSITY AS DEFINED BY ASTM D-698.
- 4. PROOFROLLING SHALL BE CONDUCTED FOR BUILDING SUBGRADE USING 10 TON MIN., USING A FULLY LOADED DUMP TRUCK OR OTHER EQUIPMENT APPROVED BY THE OWNERS TESTING AGENCY. PROOFROLLING SHALL BE DONE AFTER A SUITABLE PERIOD

OF DRY WEATHER TO AVOID DEGRADING AN OTHERWISE


ACCEPTABLE SUBGRADE.


- 1. " CJ " DENOTES LOCATION OF CONTROL JOINTS IN SLAB ON GRADE. CONTROL JOINTS IN SLAB ON GRADE SHALL BE SAW CUT.
- 2. ALL CONCRETE WORK SHALL BE DONE IN ACCORDANCE WITH CURRENT ACI BUILDING CODE REQUIREMENTS FOR REINFORCED CONCRETE (ACI 318-14).
- 3. ALL NORMAL WEIGHT CONCRETE SHALL HAVE ASTM C-33 AGGREGATE WITH MAXIMUM UNIT WEIGHT OF 150 PCF. CONCRETE COMPRESSIVE STRENGTH SHALL BE 3000 PSI AT 28 DAYS, MINIMUM.

REINFORCING STEEL


REINFORCING STEEL SHALL BE NEW BILLET STEEL, DEFORMED BARS CONFORMING TO ASTM A-615, GRADE 60.

GENERAL NOTES SCALE: 3/4" = 1'-0" (3

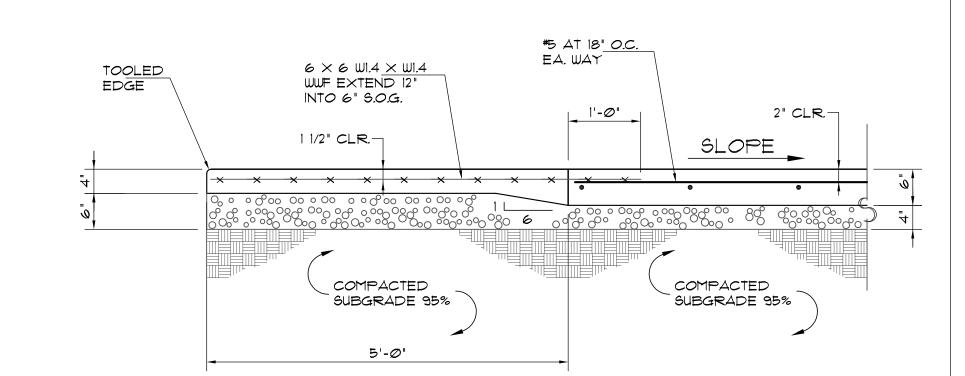

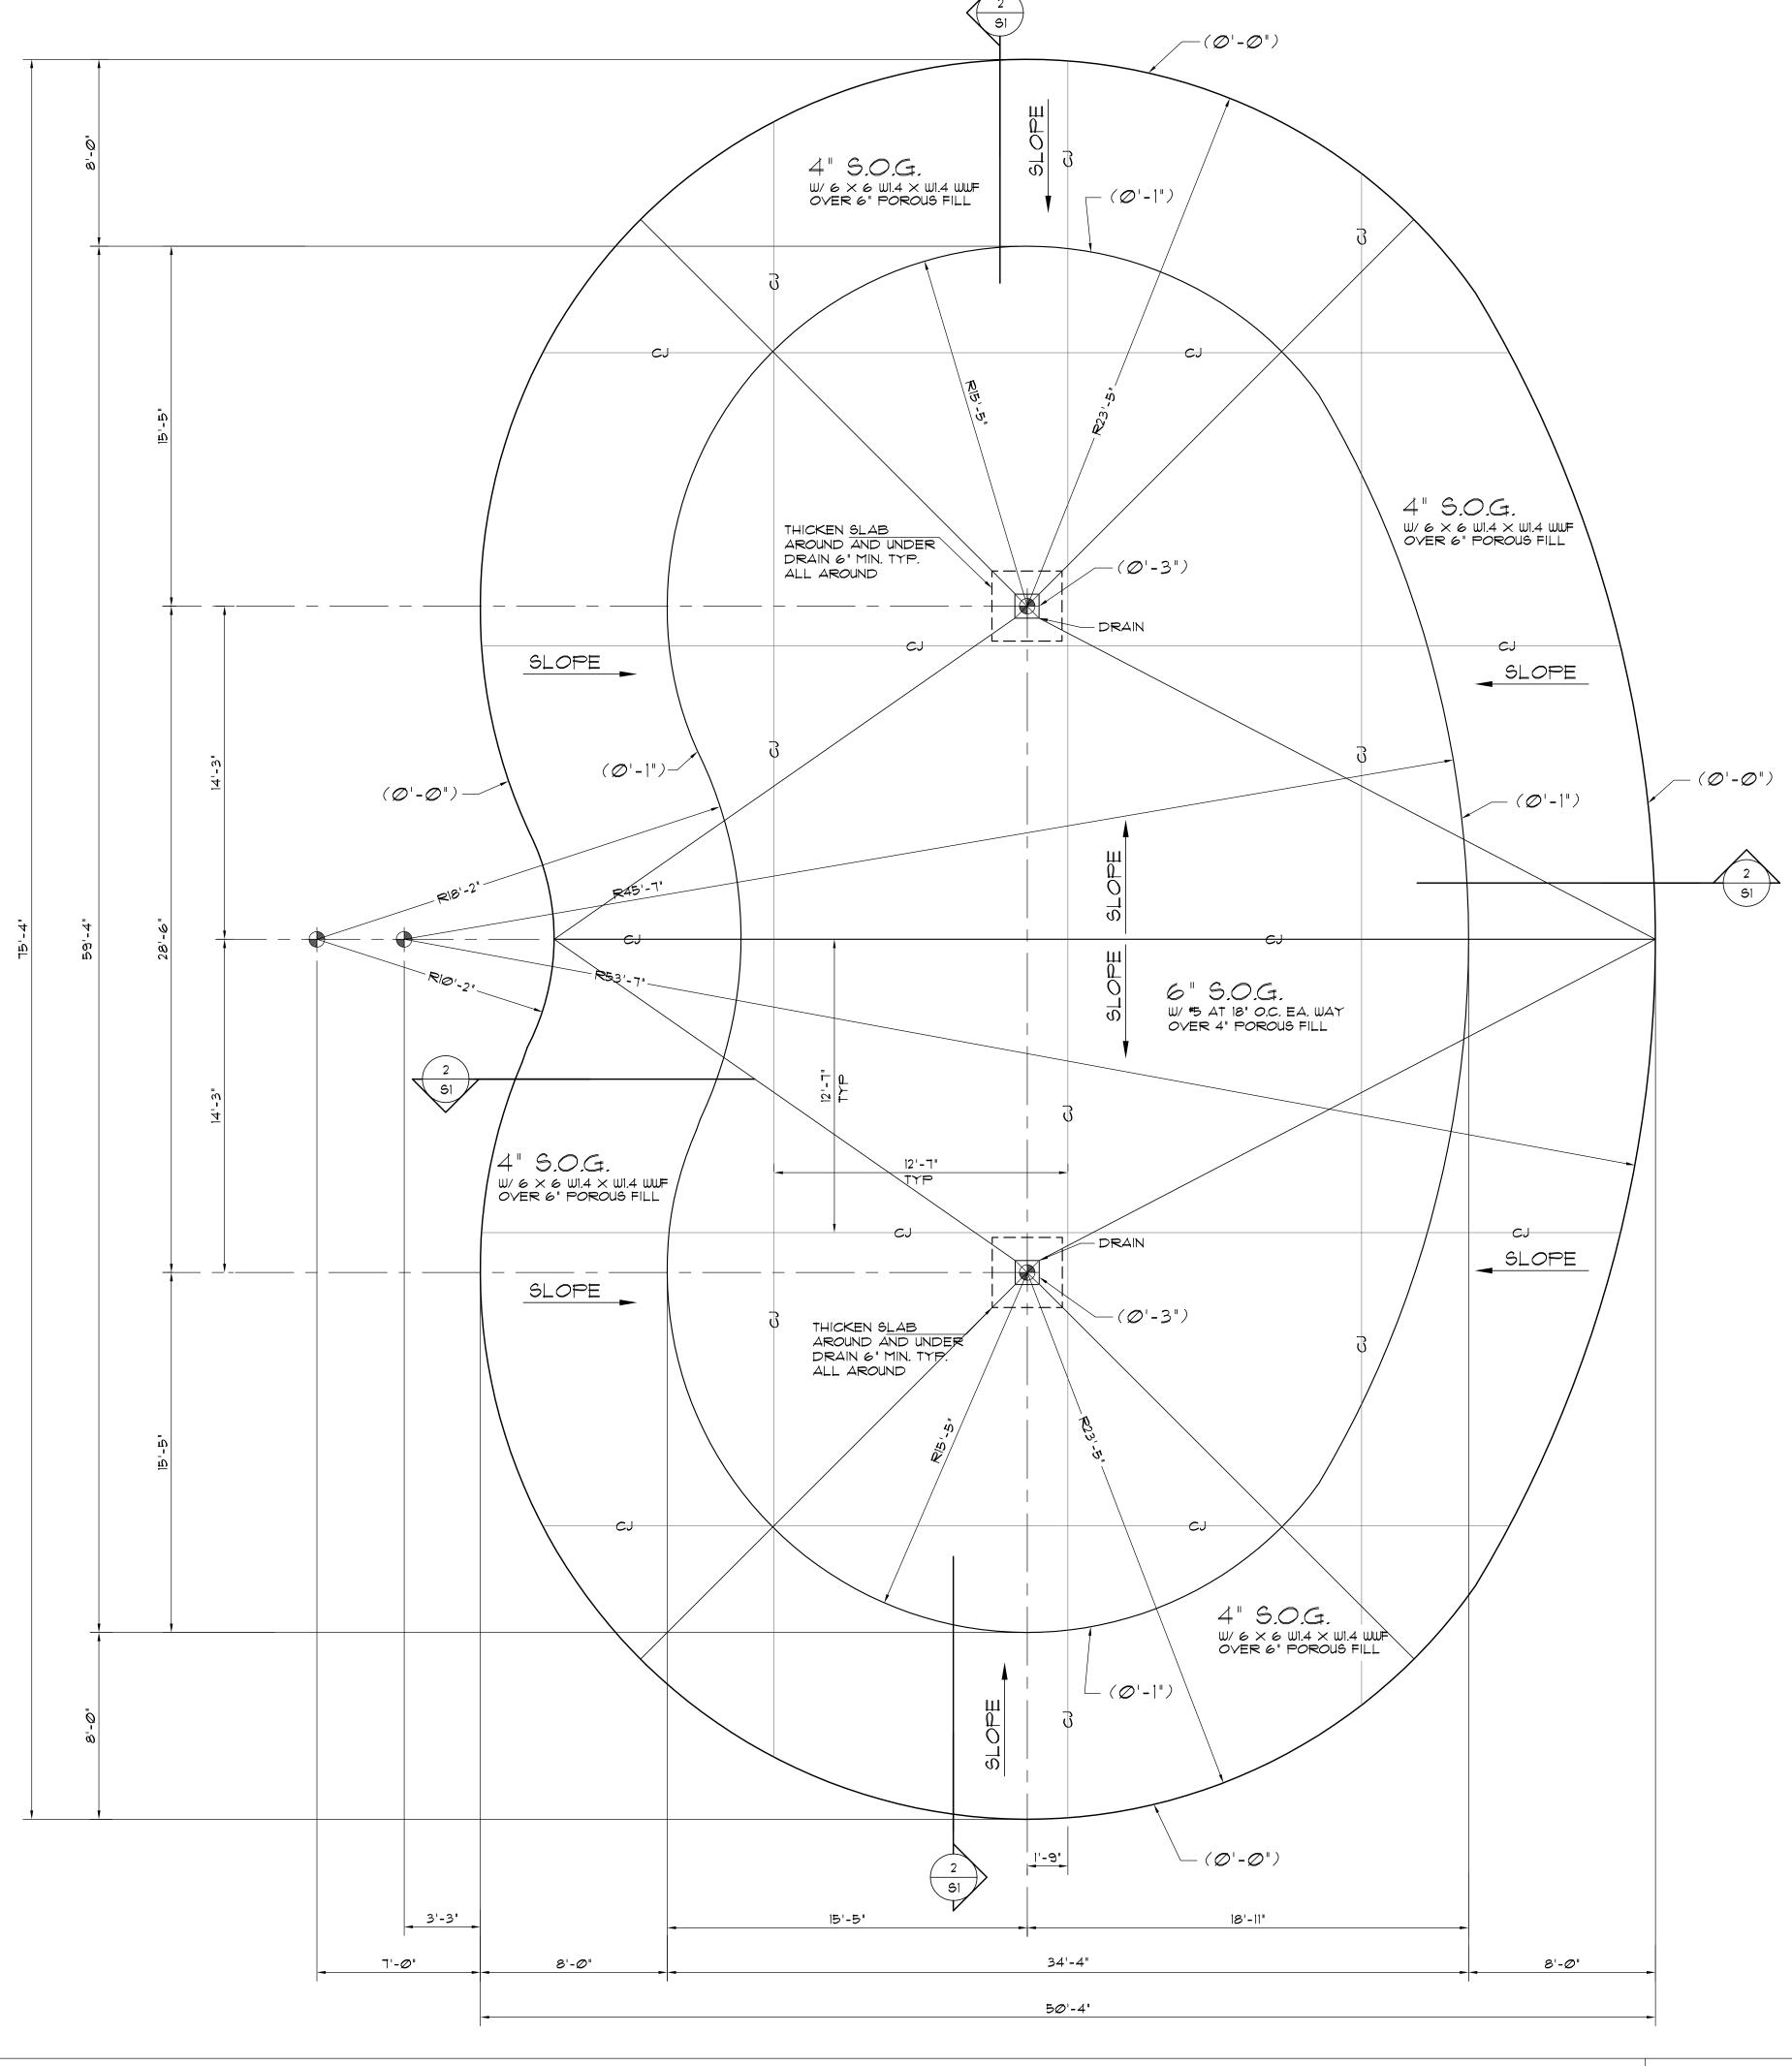

INC

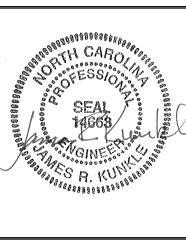

CREATIO SPLASI ERWIN

DATE: FEBRUARY 28, 2020

REVISIONS:

FOUNDATION PLAN

SHEET NUMBER