UL 300 HOOD FIRE SUPPRESSION SYSTEM


PULL STATION DETAIL - 1/2" CONDUIT STRAIGHT UP TO ABOVE CEILING LINE, NO OFFSETS OR BEND - 4" STANDARD ELECTRICAL 42'-48" ABOVE FINISHED FLOOR OR IN ACCORDANCE WITH LOCAL CODE SCREW HOLES AT 2 O'CLOCK AND 8 O'CLOCK Code requires location between 10' and 20' on a normal path of egress to an exit door or inspector approved location NOTE: HEIGHT OF PULL STATION SHOULD BE DETERMINED IN ACCORDANCE WITH AUTHORITY HAVING JURISDICTION.

FIRE SYSTEM OPERATION

- 1. Kitchen hood shall be constructed and installed per NFPA 96.
- 2. Hood Electrical Control Panel and Fire Control System shall shut down kitchen hood make up air fan upon activation of fire extinguishing system. Kitchen hood exhaust fan shall continue to operate or power on upon activation. The hood electrical panel and fire system will provide interlock for
- automatic operation of fire suppression system with: a. Mechanical gas valve (installed by mechanical/plumbing contractor, if gas used)
- b. Hood supply and exhaust fan (wiring by elec) c. Remote manual pull station (by hood fire system distr)
- d. Fire alarm system notification (if Bldg Fire Alarm present, by Fire alarm Contractor) 2. See Hood details for drawings
- 3. All exposed piping with fire suppression system shall be covered with a a chrome sleeve.4. Mechanical contractor shall install conduit in wall for manual pull station. Pull Station shall be
- located at or near a means of egress from the cooking area.
- 5. Fire suppression system shall be in accordance with UL 300.

FIRE SYSTEM INFORMATION - JOB#4556648						
FIRE			.,	FI D\./	INSTALLATION	
SYSTEM NO	TAG	TYPE	SIZE	POINTS	SYSTEM	LOCATION ON HOOD
1		ANSUL R102	3.0/3.0	19	FIRE CABINET LEFT	LEFT, HOOD 1


SYSTEM SIZE: ANSUL-3.0/3.0 TOTAL FP REQUIRED: 19.

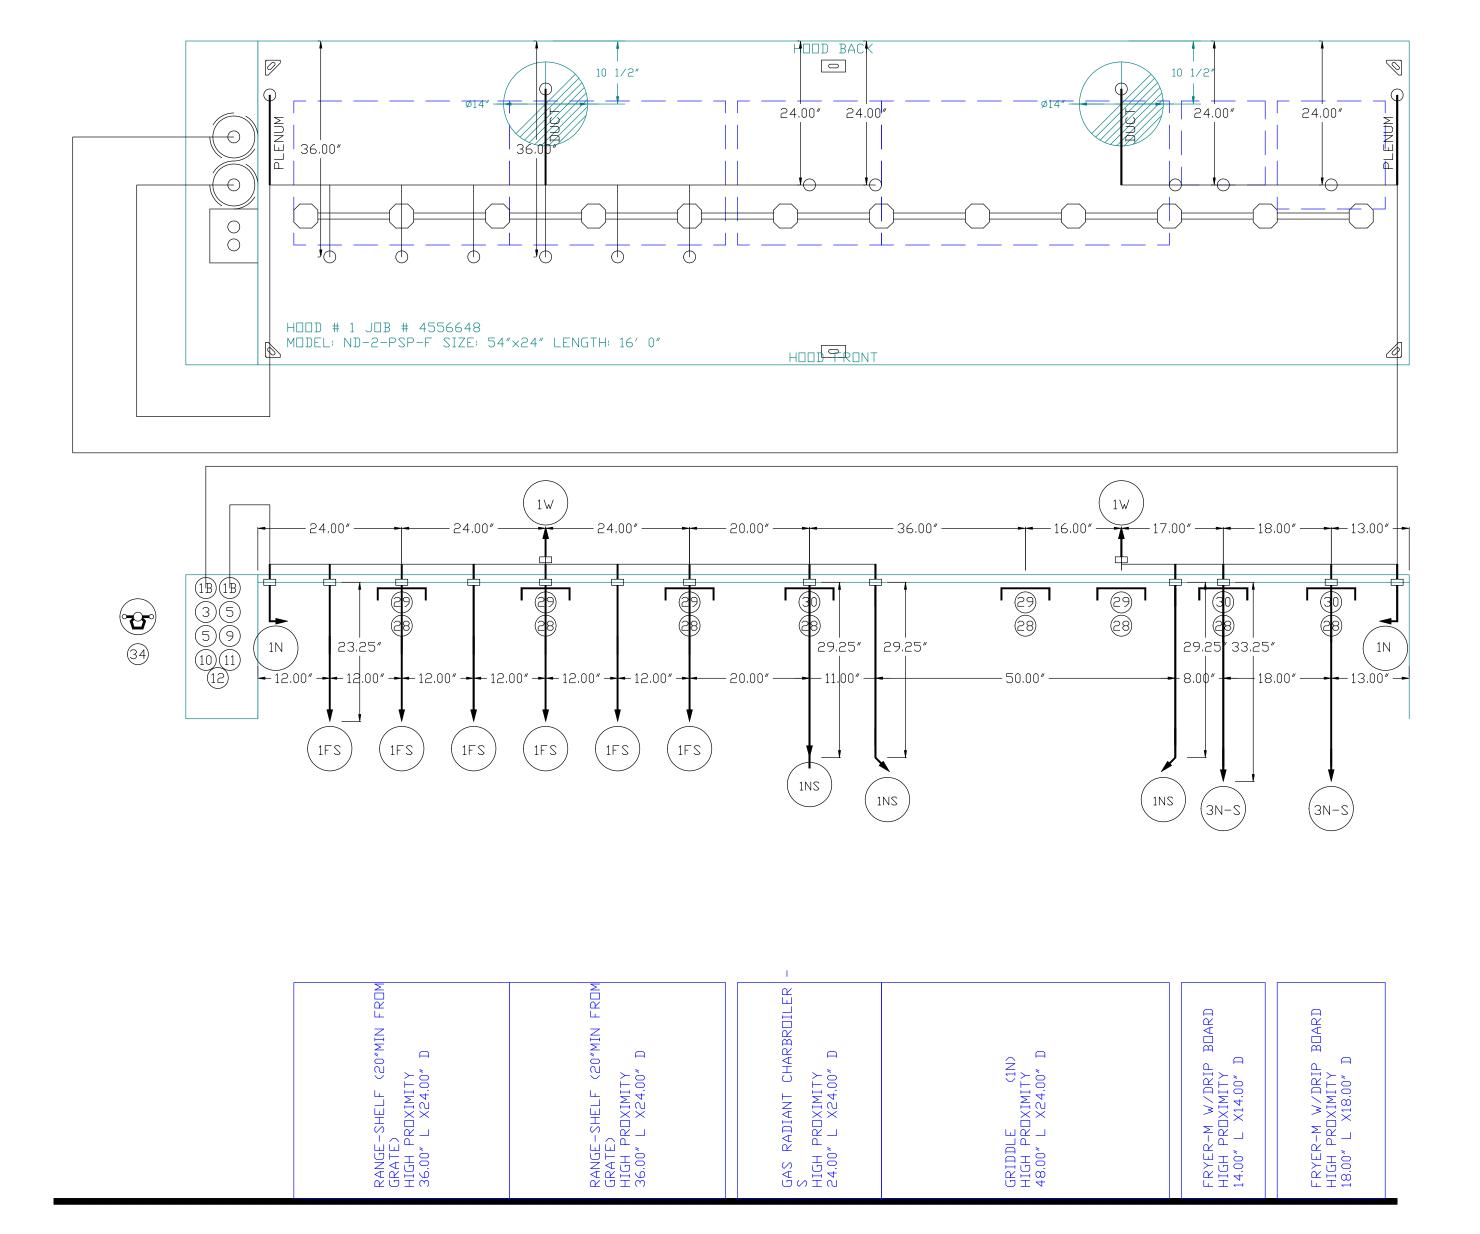


All Fire System Piping will be 3/8" schedule 40 black iron.

NC FIRE CODE 904.11.2

System Interconnection: The Actuation of the fire extinguishing system shall automatically shut down the fuel or electrical power supply to the cooking equipment. The Fuel and electrical supply

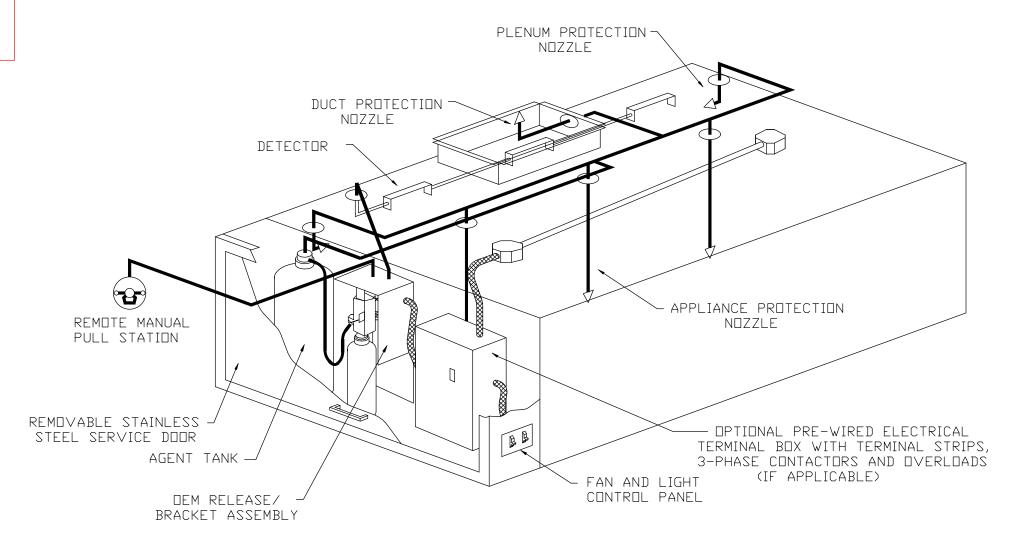

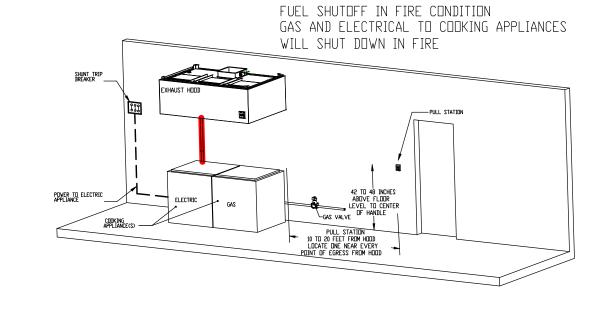

TYPICAL ANSUL R-102 SYSTEM LAYOUT

- FIELD PIPE DROPS AS SHOWN
 SLEEVING, ELBOWS, TEES, AND NOZZLES SUPPLIED BY CAS.
 RELOCATE NOZZLES IF FLOW PATTERN IS BLOCKED BY SHELVING,
- SALAMANDERS, ETC.
- MAXIMUM 9 ELBOWS IN SUPPLY LINE.
- MINIMUM 72 INCHES OF AGENT LINE FROM TANK TO FIRST NOZZLE COVERING A RANGE, FRYER, OR WOK TO REFLECT GENERAL PIPING REQUIREMENTS. IF APPLICABLE, PRE-PIPED CHARBROILER DROPS ARE SHIPPED LOOSE.
- FACTORY PIPING EXTENDS A MAXIMUM OF 6" ABOVE THE TOP OF THE HOOD.
- APPLIANCE DIMENSIONS LISTED REPRESENT THE COOKING SURFACE SIZE, NOT THE OVERALL APPLIANCE SIZE.
- THIS FIRE SYSTEM COMPLIES WITH U.L. 300 REQUIREMENTS.

JOB NAME: EL BURRITO - SHOPPES AT SUMMIT SANFORD, NC ND-2.

SYSTEM SIZE: ANSUL-3.0/3.0 TOTAL FP REQUIRED: 19. HOOD # 1 16' 0.00" LONG \times 54" WIDE \times 24" HIGH.

RISER # 1 SIZE: 14" DIA

RISER # 2 SIZE: 14" DIA. HOOD # 1 METAL BLOW-OFF CAPS INCLUDED

<u>LEGEND - FIRE CABINET ANSUL SYSTEM</u>

1,5 GALLON TANK. 3 GALLON TANK, DEM AUTOMAN RELEASE.

DEM REGULATED ACTUATOR. ANSULEX LIQUID AGENT (3 GAL.). ANSULEX LIQUID AGENT (1.5 GAL.).

DEM REGULATED RELEASE.

CARTRIDGE (101-20). CARTRIDGE (101-10). CARTRIDGE (101-30).

CARTRIDGE (LT-A-101-30) DOUBLE TANK CARTRIDGE.

TEST LINK. DOUBLE MICROSWITCH.

HOSE ASSEMBLY DUCT NOZZLE (430913).

DUCT NOZZLE (419337). NOZZLE ASSEMBLY (419336) NOZZLE ASSEMBLY (419333) NOZZLE ASSEMBLY (419335)

NOZZLE ASSEMBLY (419334). NOZZLE ASSEMBLY (419338) NOZZLE ASSEMBLY (419340)

NOZZLE ASSEMBLY (419339) NOZZLE ASSEMBLY (419343). NOZZLE ASSEMBLY (419342) NOZZLE ASSEMBLY (419341).

DETECTOR BRACKET LOW TEMP FUSIBLE LINK. HIGH TEMP FUSIBLE LINK,

MECHANICAL GAS VALVE. ELECTRICAL GAS VALVE REMOTE MANUAL PULL STATION.

SWIVEL ADAPTOR.

Reviewed For Code Compliance By: D. Banks Wallace

Chief Deputy Fire Marshal

02/05/2021 2:42:02 PM

CAPTIVE-AIRE HOODS ARE BUILT IN COMPLIANCE WITH:



FOR QUESTIONS CONTACT: DEXTER WILSON NORTH CAROLINA REGIONAL OFFICE

PHONE: (984) 222-9587 EMAIL: REG36@CAPTIVEAIRE.COM FAX: (919) 227-5917

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REVISIONS

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DATE: 10/13/2020 DWG.#:

4556648 DRAWN BY:

SCALE: 3/4" = 1'-0"

MASTER DRAWING

SHEET NO.