

NOTE:
PROVIDE LABELING ON EACH
SWITCH NOTING CIRCUIT SERVED.

AUTOMATIC LIGHTING SHUTOFF IS NOT SHOWN IN THE
EGRESS PATH LIGHTING AS ALLOWED PER 905.2.2.1
EXCEPTION #5, WHERE AUTOMATIC SHUTOFF WOULD
ENDANGER OCCUPANT SAFETY.

TIE ALL EXIT AND EMERGENCY LIGHTS
TO NEAREST AVAILABLE UNSWITCHED
LIGHTING CIRCUIT IN THE AREA SERVED.

VERIFY HEIGHT/LOCATION OF ALL SWITCHES
AND DEVICES PRIOR TO INSTALLATION.

1 LIGHTING PLAN
SCALE: 1/4" = 1'-0"

MARK	MANUFACTURER	CATALOG NO.	VOLT.	LAMPS NO. TYPE W	BALLAST TYPE	W/ FIXTURE	REMARKS
A	COLUMBIA	LJT24-35LWG-FSA12F-EDU	120	LED 34	-	34	2X4 LED ECONOMY TROFFER W/FROST ACRYLIC LENS (3000L)
AE	COLUMBIA	LJT24-35LWG-FSA12F-EDU	120	LED 34	-	34	2X4 LED ECONOMY TROFFER W/FROST ACRYLIC LENS (3000L), EMERGENCY BALLAST
B	LITHONIA	IBL-30L-WD-LP835-WGIBL	UNV	LED -	-	245	LED HIGH BAY- W/ WIRE GUARD, STRUCTURE MOUNTED W/ CHAINS; COORD. W/ OWNER
BE	LITHONIA	IBL-30L-WD-LP835-DL1BL-SD125	UNV	LED -	-	245	LED HIGH BAY- WITH LENS, STRUCTURE MOUNTED W/ CHAINS; COORD. W/ OWNER
B1	LITHONIA	IBL-30L-WD-LP835-WGIBL-12412	UNV	LED -	-	245	LED HIGH BAY- WITH WIRE GUARD (EMERGENCY BACK-UP), MOUNTED TO STRUCTURE
E	DUAL LITE	PG	120	LED -	-	17	EMERGENCY EGRESS FIXTURE - DUAL MODE, NORMAL/EMERGENCY OPERATION
F	HUBBELL	NRG-365-4K-U	120	LED 20	-	20	EXTERIOR LED WALL PACK, COLOR BY ARCH
EXIT	MXBRU		120	LED -	-	-	EXIT LIGHT, ARCH TO SELECT COLOR/FINISH
EXIT	SQRXU		120	LED -	-	-	COMBINATION EMERGENCY/EXIT LIGHT, ARCH TO SELECT COLOR/FINISH
EXIT	SQLED		120	LED -	-	-	EMERGENCY LIGHT, ARCH TO SELECT COLOR/FINISH

** OR APPROVED EQUAL. PROVIDE CUT SHEETS FOR OWNER APPROVAL PRIOR TO ORDERING FIXTURES. FOR FLUORESCENT FIXTURES CONTROLLED BY MOTION SENSOR, PROVIDE "PROGRAMMED RAPID START" BALLASTS. CATALOG NUMBERS ARE FOR REFERENCE ONLY, ACTUAL NUMBERS MAY VARY. 'EB' DENOTES ELECTRONIC BALLAST. VERIFY FIXTURE HAS INTEGRAL LOCAL DISCONNECTING MEANS PER NEC 410.130 (G).


PROJECT TITLE
DAWSON ELECTRIC

ADDRESS
CITY, NORTH CAROLINA

PROJECT NO.
1918

DRAWING TITLE
LIGHTING PLAN


PLOT DATE
7/19/2019

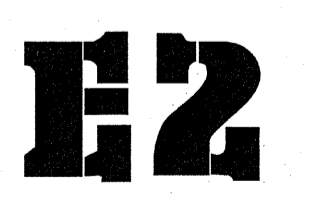

This original sheet is 24" x 36"; other dimensions indicate it has been altered.
All information on this sheet is the property of Weeks Turner Architecture and may not be duplicated in whole or in part without written authorization from Weeks Turner Architecture, 2019

ENGINEER

GW BURKE DESIGN GROUP
CONSULTING ENGINEER
3305-109 Durham Drive
Raleigh, North Carolina
919.771.1916 fax: 919.771.1917
email: benburke@nc.rr.com
Corp. License # C-2652

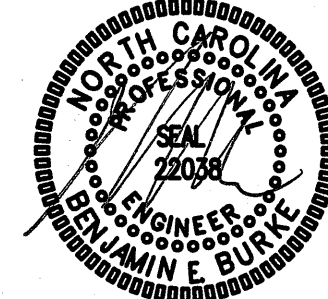

8/7/18

PROJECT TITLE
DAWSON ELECTRIC



ADDRESS
CITY, NORTH CAROLINA

PROJECT NO.
1918

DRAWING TITLE
POWER PLAN

PLOT DATE 7/15/18

This original sheet is 24" x 36"; other drawings in this set are as indicated.
All information on this sheet is the property of Weeks Turner Architecture and may be reproduced in whole or in part without authorization from Weeks Turner Architecture.

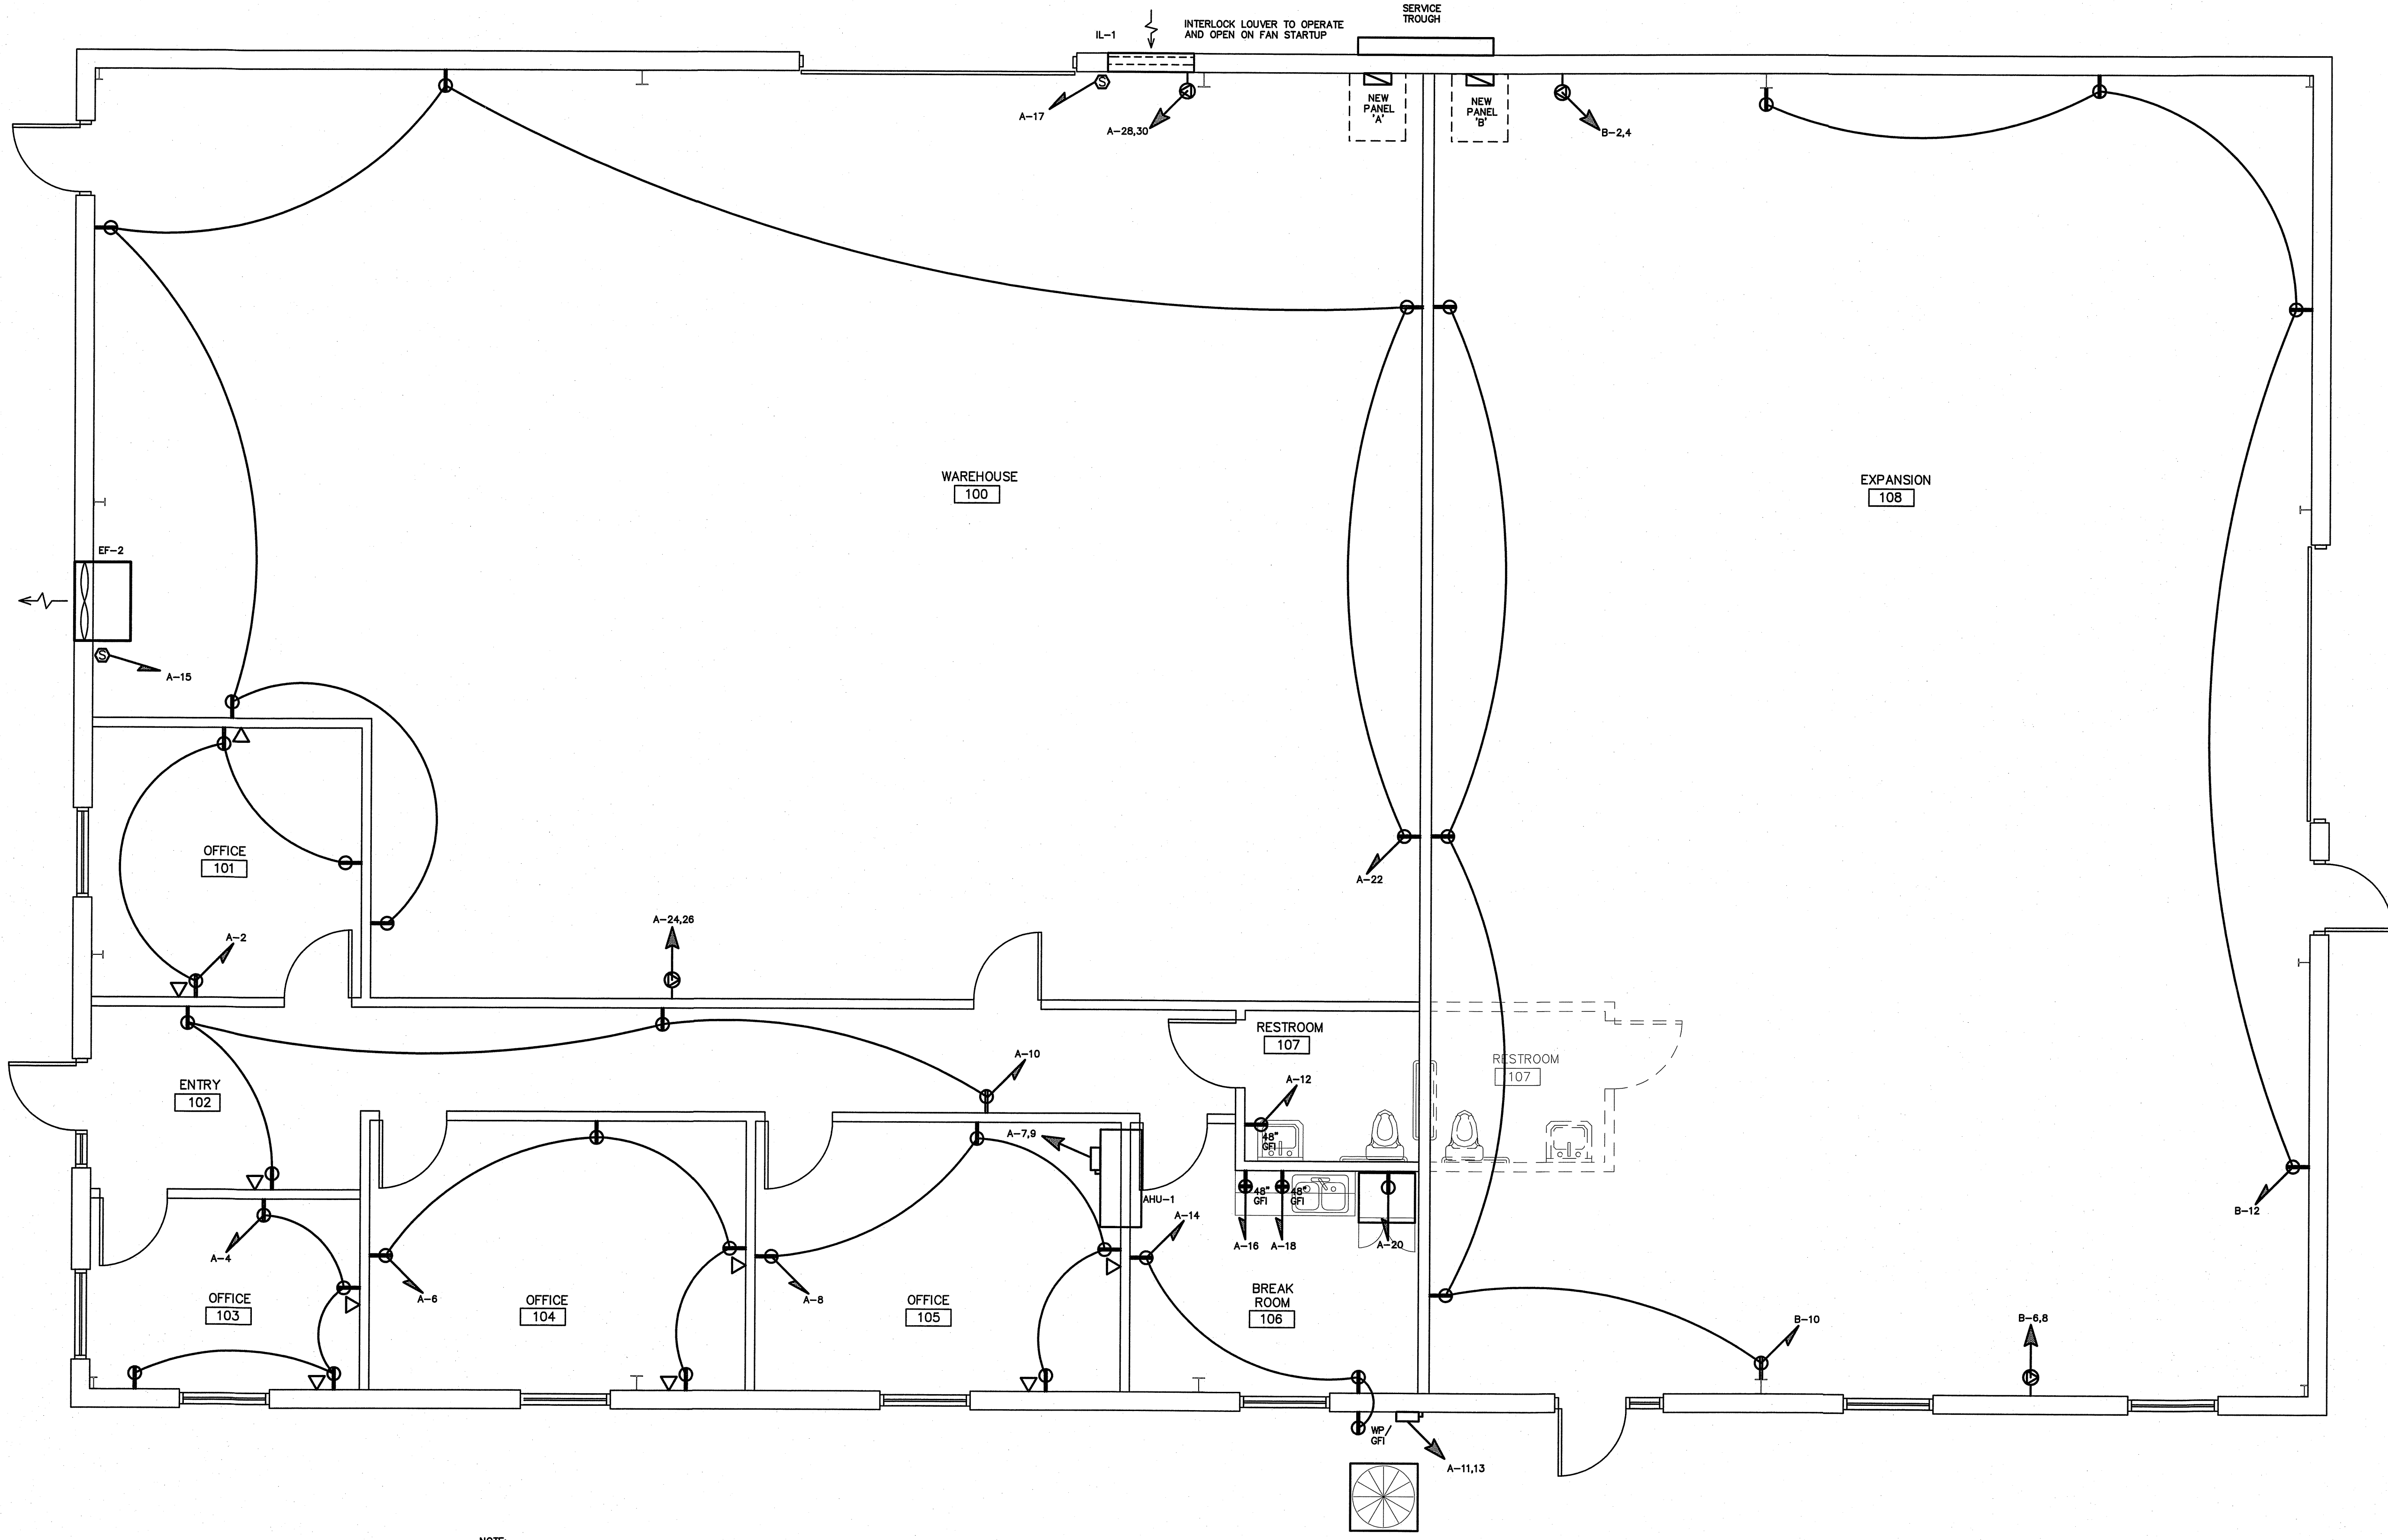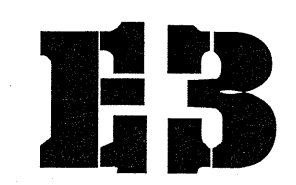

NOTE:
PROVIDE LABELING ON EACH
RECEPTACLE NOTING CIRCUIT SERVED.
VERIFY HEIGHT/LOCATION OF ALL
DEVICES PRIOR TO INSTALLATION.

1 POWER PLAN
SCALE: 1/4" = 1'-0"

NEW PANEL- 'A'		MAKE: CUTLER HAMMER TYPE: PBL1a OR APPROVED EQUAL			RATING: 208/120V 3 PHASE 4 WIRE MOUNTING: SURFACE MINIMUM AIC: VERIFY			M.L.O. MAIN CIRCUIT BREAKER EQUIPMENT GROUND BUS <input checked="" type="checkbox"/> YES <input type="checkbox"/> NO SERVICE ENTRY RATED <input type="checkbox"/> YES <input checked="" type="checkbox"/> NO		
LOAD SERVICE	CKT BRKR	WATTS PER PHASE A B C	CKT NO	NEUTRAL A B C	CKT NO	WATTS PER PHASE A B C	CKT BRKR	LOAD SERVICE	CKT BRKR	
LTS: WAREHOUSE	20A	1470			1			20A REC: OFFICE (101)		
LTS: OFFICE, CONF, BREAK, BATH	20A	710			3			20A REC: OFFICE (103)		
LTS: EXTERIOR	20A		228		5			20A REC: CONFERENCE (104)		
AHU-1	30A	2309			7		540	20A REC: OFFICE (105)		
14.1A MOTOR, 18.1A HEAT	30A	2309			9		720	20A REC: ENTRY (102)		
HP-1	30A		1591		11		180	20A REC: RESTROOM (107)		
14.1A COMP, 1.2A FAN	30A	1591			13		360	20A REC: BREAKROOM (106)		
EF-2	20A		864		15		360	20A REC: BREAKROOM - COUNTER		
IL-1	20A				17		360	20A REC: BREAKROOM - COUNTER		
SPARE	20A				19		1800	20A REC: BREAKROOM - REFRIGERATOR		
SPARE	20A				21		1080	20A REC: WAREHOUSE (100)		
SPARE	20A				23			20A SPEC. REC: WAREHOUSE (100)		
SPARE	20A				25		500			
SPACE					27		500	20A SPEC. REC: WAREHOUSE (100)		
SPACE					29					
SPACE					31			20A SPARE		
SPACE					33			20A SPARE		
SPACE					35			20A SPARE		
SPACE					37			SPACE		
SPACE					39			SPACE		
SPACE					41			SPACE		
SPACE					42			SPACE		
NOTES		SUB-TOTALS 'B'			5370	3883	2319		200A BUS	3740
(G) GFCCI BREAKER								200A LUGS	5370	
								200A FEED	9110	
								VERIFY SIZE	76A	
SUB-TOTALS 'A'					3200	2440		SUB-TOTALS 'A'		
TOTAL CONNECTED LOAD					9110	7083	4759	TOTAL CONNECTED LOAD		
					76A	59A	40A	AMPS/PHASE		

NEC ALLOWABLE DEMAND FACTORS		DIVERSIFIED LOAD SUMMARY			
① DEMAND FACTORS PER NEC 220	② LARGEST OF: NEC TABLE 220.12 OR CONNECTED LOAD	LOAD TYPE	DEMAND FACTOR (G)	A	B
③ NEC TABLE 220.56	④ NEC 220.51	GENERAL LIGHTING	125%	1836	888
⑤ NEC 220.43A, 200 VA/LINEAR FT	⑥ NON-COINCIDENT LOADS, LARGEST OF THE TWO LOADS IS COUNTED	TRACK LIGHTING	125%	888	285
		GENERAL USE	125%	3740	3200
		RECEPTACLES	125%	3883	2440
		MOTORS AND EQUIPMENT	125%	1833	1080
		WATER HEATERS	100%	551	426
		KITCHEN EQUIPMENT	100%	1882	1882
		FIX. ELEC. SPACE HEAT.	100%	1882	1882
		SHOW WINDOW LIGHTS	125%		
		SIGN	125%		
		MISC	100%		
		PHASE (TOTAL VA)		8844	7476
		TOTAL AMPS		82A	62A

NOTE:
THE ALL SERVICE GROUNDS AND TROUGH CASE GROUND TOGETHER (PER NEC 250-58) THE TROUGH GROUND SHALL BE BONDED TO THE SERVICE NEUTRAL IN THE TROUGH. THREE SERVICE CONDUCTORS WITH ONE NEUTRAL SHALL BE RUN TO EACH SERVICE DISCONNECT. A BONDING STRAP SHALL BE PROVIDED IN EACH DISCONNECT TO BOND THE GROUND AND NEUTRAL BUSES. A GROUND WIRE WILL BE RUN WITH THE BRANCH CONDUCTORS FROM THE SERVICE DISCONNECT TO THE INDIVIDUAL LOADS SERVED.

NEW PANEL- 'B'		MAKE: CUTLER HAMMER TYPE: PBL1a OR APPROVED EQUAL			RATING: 208/120V 3 PHASE 4 WIRE MOUNTING: SURFACE MINIMUM AIC: VERIFY			M.L.O. MAIN CIRCUIT BREAKER EQUIPMENT GROUND BUS <input checked="" type="checkbox"/> YES <input type="checkbox"/> NO SERVICE ENTRY RATED <input type="checkbox"/> YES <input checked="" type="checkbox"/> NO		
LOAD SERVICE	CKT BRKR	WATTS PER PHASE A B C	CKT NO	NEUTRAL A B C	CKT NO	WATTS PER PHASE A B C	CKT BRKR	LOAD SERVICE	CKT BRKR	
LTS: EXPANSION	20A	980			1			20A SPEC. REC: EXPANSION (108)		
SPARE	20A				3			20A		
SPARE	20A				5		500	20A SPEC. REC: EXPANSION (108)		
SPARE	20A				7		900	20A REC: EXPANSION - GEN. USE (108)		
SPARE	20A				9		900	20A REC: EXPANSION - GEN. USE (108)		
SPARE	20A				11			20A		
SPARE	20A				13			20A		
SPARE	20A				15			20A		
SPACE					17			20A		
SPACE					19			20A		
SPACE					21			20A		
SPACE					23			20A		
SPACE					25			20A		
SPACE					27			20A		
SPACE					29			20A		
SPACE					31			20A		
SPACE					33			20A		
SPACE					35			20A		
SPACE					37			SPACE		
SPACE					39			SPACE		
SPACE					41			SPACE		
NOTES		SUB-TOTALS 'B'			980			200A BUS	1000	
								200A LUGS	980	
								200A FEED	1980	
								VERIFY SIZE	17A	
SUB-TOTALS 'A'					1400	1400		SUB-TOTALS 'A'		
TOTAL CONNECTED LOAD					1980	1400	1400	TOTAL CONNECTED LOAD		
					17A	12A	12A	AMPS/PHASE		


NEC ALLOWABLE DEMAND FACTORS		DIVERSIFIED LOAD SUMMARY			
① DEMAND FACTORS PER NEC 220	② LARGEST OF: NEC TABLE 220.12 OR CONNECTED LOAD	LOAD TYPE	DEMAND FACTOR (G)	A	B
③ NEC TABLE 220.56	④ NEC 220.51	GENERAL LIGHTING	125%	1225	1225
⑤ NEC 220.43A, 200 VA/LINEAR FT	⑥ NON-COINCIDENT LOADS, LARGEST OF THE TWO LOADS IS COUNTED	TRACK LIGHTING	125%	1225	1225
		GENERAL USE	125%	1000	1400
		RECEPTACLES	125%	1400	1400
		MOTORS AND EQUIPMENT	125%		
		WATER HEATERS	100%		
		KITCHEN EQUIPMENT	100%		
		FIX. ELEC. SPACE HEAT.	100%		
		SHOW WINDOW LIGHTS	125%		
		SIGN	125%		
		MISC	100%		
		PHASE (TOTAL VA)		2225	1400
		TOTAL AMPS		19A	12A

RISER WIRING SCHEDULE

- 1 200A: 4-#3/0 IN 2" CONDUIT
- 2 200A: 4-#3/0, 1-#6 CU GND, IN 2 1/2" CONDUIT
- 3 #3/0 CU GND TO BUILDING STEEL, FOUNDATION STEEL AND METALLIC WATER MAIN AND #6 CU GND TO 10' X 5/8" DRIVEN GROUND ROD

NOTE:
UNLESS OTHERWISE NOTED ALL OTHER CIRCUITS ARE 20A, 120VOLT. PROVIDE 2-#12, 1-#12 CU GND IN 1/2" CONDUIT.
SEE EQUIPMENT SCHEDULES FOR ADDITIONAL WIRE SIZES.


VERIFY AVAILABLE FAULT CURRENT AT SERVICE LOCATION WITH LOCAL POWER COMPANY. PROVIDE INFORMATION TO ENGINEER TO CALCULATE MINIMUM PANEL AIC RATING PRIOR TO RELEASING GEAR. AIC RATING ON PANELS ARE FOR PERMIT REVIEW AND PRICING ONLY. EC SHALL PROVIDE LABELING INDICATING FAULT CURRENT AT SERVICE ENTRY AND ON ALL PANELS PRIOR TO ENERGIZING.

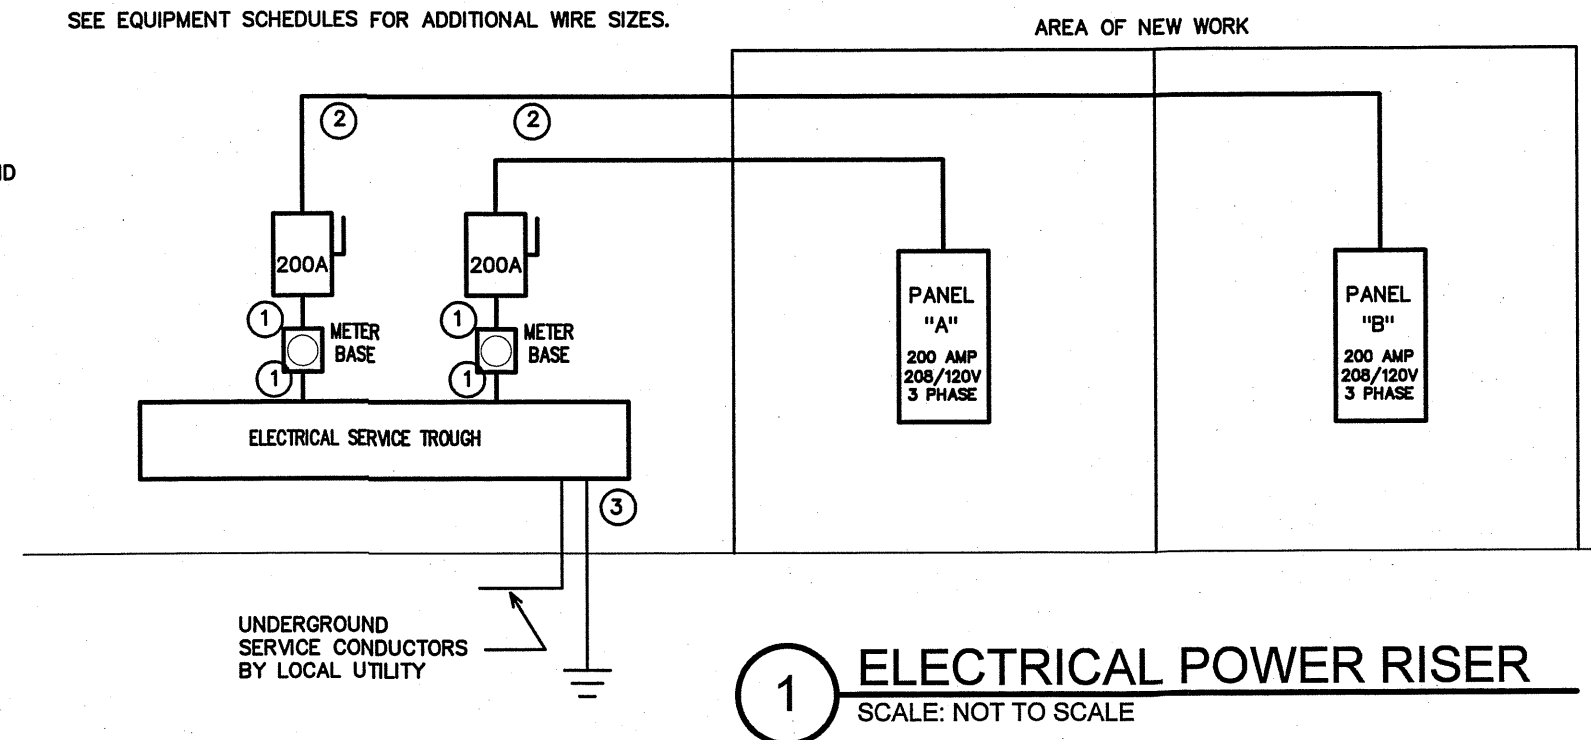

WEEKS TURNER ARCHITECTURE

WEEKS TURNER ARCHITECTURE, PA
3305-109 Durham Drive
Raleigh, North Carolina 27603
919.779.9797 fax: 919.779.0826
www.weeksturner.com

ENGINEER
BURKE DESIGN GROUP, P.A.
CONSULTING ENGINEERS
3305-109 Durham Drive
Raleigh, North Carolina 27603
919.771.1916 fax: 919.779.0826
email: benburke@nc.rr.com
Corp. License # C-2652

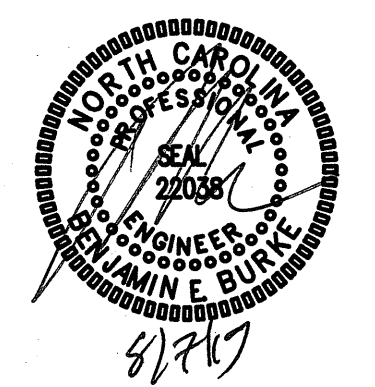

PROJECT TITLE
DAWSON ELECTRIC

ADDRESS
CITY, NORTH CAROLINA

PROJECT NO.
1918

DRAWING TITLE
PANELS & RISER

14

PLOT DATE 7/19/2019

This original sheet is 24" x 36"; other dimensions indicate it has been altered.
All information on this sheet is the property of Weeks Turner Architecture and may not be duplicated in whole or in part without written authorization from Weeks Turner Architecture, 2019