

APPENDIX B :	2018 NC BUILDING C	CODE SUMMARY
NAME OF PROJECT: ADDRESS: ANDERSON CREEKCLUB - FAIRWAY POINT DRIVE, NORTH CAROLINA OWNER/AUTHORIZED AGENT: ANDY BARR PHONE NUMBER: 910-454-4688 E-MAIL: ANDYBARR@YAHOO.COM OWNED BY: □ CITY/COUNTY ■ PRIVATE □ STATE	PERCENTAGE OF WALL OPENING CALCULATIONS FIRE SEPARATION DISTANCE DEGREE OF OPENINGS ALLOWABLE AREA (%) ACTUAL SHOWN ON PLANS (%) (FEET) FROM PROPERTY LINES PROTECTION (TABLE 705.8) > 20' UP, S 75 28/2,021=1.4	LIST OF DRAWINGS INFORMATIONAL
CONTACT: ANDREW W. PRIVETTE DESIGNER FIRM NAME COUNTY OF HARNETT STATE COUNTY OF HARNETT STATE LICENSE PHONE E-MAIL	> 20' UP, S 75 320/I,649=19.4 > 20' UP, S 75 390/I,649=23.6 > 20' UP, S 75 5/2,021=0.2 LIFE SAFETY SYSTEM REQUIREMENTS	G-101 COVER SHEET G-102 LIFE SAFETY PLAN & ACCESSIBLE GUIDELINES G-103 UL-L528 1HR FLOOR-CEILING ASMY. (1 OF 2) G-104 UL-L528 1HR FLOOR-CEILING ASMY. (2 OF 2)
ARCHITECTURAL DESIGNED TO BUILD ANDREW W. PRIVETTE 3877 910-485-8567 ANDY@DESIGNEDTOBUILD.COM CIVIL BY OWNER UNDER SEPARATE COVER	EMERGENCY LIGHTING: EXIT SIGNS: FIRE ALARM: SMOKE DETECTION SYSTEMS: CARBON MONOXIDE DETECTION: YES NO PARTIAL - SEE MECHANICAL ON NO PARTIAL - SEE MECHANICAL	G-105 UL-P522 1HR ROOF-CEILING ASMY. G-106 UL-U356 1HR EXT. WALL ASMY. G-107 UL-U341 1HR TENANT SEPARATION ASMY.
OTHER: (TRUSS, PRECAST, PRE-ENGINEERED, INTERIOR DESIGN, ETC.) 2018 NC BUIDLING CODE: NEW BUILDING SHELL/CORE IST TIME INTERIOR COMPLETION ADDITION PHASED CONSTRUCTION-SHELL CORE ALTERATION LEVEL HISTORIC PROPERTY REPAIR ALTERATION LEVEL CHANGE OF USE CHAPTER 14 ALTERATION LEVEL CONSTRUCTED: (DATE) CURRENT USE(S) (CH 3): PROPOSED USE(S) (CH 3):	LIFE SAFETY PLAN REQUIREMENTS LIFE SAFETY PLAN SHEET NUMBER: G-I02 FIRE AND/OR SMOKE RELATED WALL LOCATION (CH 7) ASSUMED AND REAL PROPERTY LINE LOCATIONS (IF NOT ON THE SITE PLAN) EXTERIOR WALL OPENING AREA WITH RESPECT TO DISTANCE TO ASSUMED PROPERTY LINES (S 705.8) OCCUPANCY USE FOR EACH AREA AS IT RELATES TO OCCUPANT LOAD CALCULATION (T 1004.1.1) OCCUPANT LOADS FOR EACH AREA EXIT ACCESS TRAVEL DISTANCES (1017) COMMON PATH OF TRAVEL DISTANCES (T 1006.2.1 &T 1006.3.2(I)) DEAD END LENGTHS (1020.4) CLEAR EXIT WIDTHS FOR EACH EXIT DOOR MAXIMUM CALCULATED OCCUPANT LOAD CAPACITY EACH EXIT DOOR CAN ACCOMMODATE BASED ON EGRESS WIDTH (S 1005.3) ACTUAL OCCUPANT LOAD FOR EACH EXIT DOOR	STRUCTURAL S-1 NOTES & SPECIFICATIONS S-2 FOUNDATION PLAN S-3 SECOND FLOOR FRAMING PLAN S-4 THIRD FLOOR FRAMING PLAN S-5 ROOF FRAMING PLAN S-6 WALL SECTIONS & DETAILS
BUILDING DATA CONSTRUCTION TYPE:	■ A SEPARATE SCHEMATIC PLAN INDICATING WHERE FIRE RATED FLOOR/CEILING AND/OR ROOF/CEILING STRUCTURE IS PROVIDED FOR PURPOSES OF OCCUPANCY SEPARATION □ LOCATION OF DOORS WITH PANIC HARDWARE (I010.1.10) □ LOCATION OF DOORS WITH DELAYED EGRESS LOCKS AND AMOUNT OF DELAY (I010.1.9.7) □ LOCATION OF DOORS WITH ELECTROMAGNETIC EGRESS LOCKS (I010.1.9.9) □ LOCATION OF DOORS WITH HOLD-OPEN DEVICES ■ LOCATIONS OF EMERGENCY ESCAPE WINDOWS (I030) □ THE SQUARE FOOTAGE OF EACH FIRE AREA (202) □ THE SQUARE FOOTAGE OF EACH SMOKE COMPARTMENT FOR OCCUPANCY CLASSIFICATION I-2 (407.5) □ NOTE CODE EXCEPTIONS OR TABLE NOTES THAT MAY HAVE BEEN UTILIZED REGARDING ITEMS ABOVE	S-7 STRUCTURAL DETAILS ARCHITECTURAL A-101 FIRST FLOOR PLAN A-102 SECOND FLOOR PLAN A-103 THIRD FLOOR PLAN
2ND FLOOR 7,234 7,234 MEZZANINE . . IST FLOOR 5,374 5,374 BASEMENT . . TOTAL . . 19,842 . .	ACCESSIBLE DWELLING UNITS (II07) TOTAL UNITS	A-104 ROOF PLAN A-201 EXTERIOR ELEVATIONS A-301 WALL SECTIONS A-302 FOUNDATION SECTIONS
ALLOWABLE AREA PRIMARY OCCUPANCY CLASSIFICATION(S): ASSEMBLY	ACCESSIBLE PARKING (II06) LOT OR NUMBER OF PARKING SPACES NUMBER OF ACCESSIBLE SPACES PROVIDED TOTAL NUMBER PARKING AREA REQUIRED PROVIDED REGULAR WITH VAN WITH 8' ACCESSIBLE PROVIDED ACCESSIBLE ACCESS ISLE ACCESS ISLE ACCESS ISLE PROVIDED TOTAL NUMBER ACCESSIBLE PROVIDED ACCESSIBLE PROVIDED ACCESS ISLE	ELECTRICAL E-1 ELECTRICAL FIRST FLOOR PLAN E-2 LIGHTING FIRST FLOOR PLAN & SCHEDULES E-3 ELECTRICAL SECOND FLOOR PLAN E-4 LIGHTING SECOND FLOOR PLAN
MERCANTILE □ Residential □ R-2 □ R-3 □ R-4 STORAGE □ S-I MODERATE □ S-2 LOW □ HIGH-PILED □ REPAIR GARAGE UTILITY AND MISCELLANEOUS □ □ ENCLOSED □ REPAIR GARAGE ACCESSORY OCCUPANCY CLASSIFICATION(S): N/A INCIDENTAL USES (TABLE 509): N/A SPECIAL USES (CH 4): □ 403 □ 404 □ 406 □ 407 □ 408 □ 409 □ 410 □ □ □ □ □ 416 □ 417 □ 419 ■ 420 □ □ □ □ 426 □ 427 □ 428 □ 430 SPECIAL PROVISIONS (CH5): □ 510.2 □ 510.3 □ 510.5 □ 510.6 □ 510.7 □ 510.9 □ 430	PLUMBING FIXTURE REQUIREMENTS USE WATERCLOSET LAVATORY SHOWER / TUB KITCHEN SINK AUTOMATIC CLOTHES WASHER CONNECTION REQUIRED: R-2 PER DWELLING UNIT PER DWELLING	E-/ ELECTRICAL NOTES, PANELS & RISERS
MIXED OCCUPANCY: ■ NO □ YES SEPARATION: HR EXCEPTION:. □ NON-SEPARATED USE (508.3) □ SEPARATED USE (508.4) - SEE BELOW FOR AREA CALCULATIONS FOR EACH STORY, THE AREA OF THE OCCUPANCY SHALL BE SUCH THAT THE SUM OF THE RATIOS OF THE ACTUAL FLOOR AREA OF EACH USE DIVIDED BY THE ALLOWABLE FLOOR AREA FOR EACH USE SHALL NOT EXCEED I. ACTUAL AREA OF OCCUPANCY A ALLOWABLE AREA OF OCCUPANCY B	SPECIAL APPROVALS SPECIAL APPROVAL: (LOCAL JURISDICTION, DEPARTMENT OF INSURANCE, OSC, DPI, DHHS, ICC, ETC., DESCRIBE BELOW) NOT REQUIRED .	FA-2 FIRE ALARM SECOND FLOOR PLAN FA-3 FIRE ALARM THIRD FLOOR PLAN FA-4 FIRE ALARM RISERS & DETAILS
STORY NO. DESCRIPTION AND USE (A) (B) (C) (D) AREA FOR ALLOWABLE AREA FOR ALLOWABLE AREA FOR AREA FOR AREA PER STORY 506.2 ⁴ FRONTAGE AREA PER STORY (ACTUAL) AREA INCREASE 1.5 OR UNLIMITED 2.3	ENERGY SUMMARY ENERGY REQUIREMENTS: The following data shall be considered minimum and any special attribute required to meet the energy code shall also be provided. Each Designer shall furnish the required portions of the project information for the plan data sheet. If performance method, state the annual energy cost for the standard reference design versus the annual energy cost for the proposed design. Existing building envelope complies with code: [If checked, the remainder of this section is not applicable.]	MECHANICAL M-1 HVAC FIRST FLOOR PLAN & SCHEDULES M-2 HVAC SECOND FLOOR PLAN M-3 HVAC THIRD FLOOR PLAN M-4 HVAC NOTES, DETAILS & SPECIFICATIONS
A. PERIMETER WHICH FRONTS A PUBLIC WAY OR OPEN SPACE HAVING 20 FEET MINIMUM WIDTH = ALL (F) B. TOTAL BUILDING PERIMETER = ALL (P) C. RATIO (F/P) = 1.0 (F/P) D. MINIMUM WIDTH OF PUBLIC WAY = 30 (W) E. PERCENT OF FRONTAGE INCREASE I _r = 100 (F/P - 0.25) x W/30 = 75 (%) ² UNLIMITED AREA APPLICABLE UNDER CONDITIONS OF SECTION 507. ³ MAXIMUM BUILDING AREA = TOTAL NUMBER OF STORIES IN THE BUILDING x D (MAXIMUM 3 STORIES) SECTION 506.2. ⁴ THE MAXIMUM AREA OF OPEN PARKING GARAGES MUST COMPLY WITH TABLE 406.5.4. THE MAXIMUM AREA OF AIR TRAFFIC CONTROL TOWERS MUST COMPLY WITH THE TABLE 412.3.1. ⁵ FRONTAGE INCREASE IS BASED ON THE UNSPRINKLERED AREA VALUE IN TABLE 506.2.	EXISTING BUILDING: PROVIDE COMPLIES WITH CODE: (IF CHECKED, THE REMAINDER OF THIS SECTION IS NOT APPLICABLE.) EXEMPT BUILDING: PROVIDE CODE OR STATUTORY REFERENCE: CLIMATE ZONE: 3-A 4-A 5-A METHOD OF COMPLIANCE: ENERGY CODE: PERFORMANCE PRESCRIPTIVE ASHRAE 90.1 PERFORMANCE PRESCRIPTIVE OTHER: PERFORMANCE (SPECIFY SOURCE).	PLUMBING P-1 WATER FIRST FLOOR PLAN & NOTES P-2 WASTE FIRST FLOOR PLAN & SCHEDULES P-3 WATER SECOND FLOOR PLAN & SCHEDULES
ALLOWABLE HEIGHT ALLOWABLE SHOW ON PLANS CODE REFERENCE BUILDING HEIGHT IN FEET 60 27'-3" TABLE 504.3 BUILDING HEIGHT IN STORIES 3 3 TABLE 504.4	ROOF (EACH ASSEMBLY) DESCRIPTION OF ASSEMBLY: ASPHALT SHINGLES ON WOOD TRUSSES W/ G.W.B. CEILING U-VALUE OF TOTAL ASSEMBLY: 0.0241 R-VALUE OF INSULATION: 38 SKYLIGHTS IN EACH ASSEMBLY: N/A U-VALUE OF SKYLIGHT: N/A TOTAL SQUARE FOOTAGE OF SKYLIGHTS IN EACH ASSEMBLY: N/A	P-4 WASTE SECOND FLOOR PLAN & SCHEDULES P-5 WATER THIRD FLOOR PLAN & SCHEDULES P-6 WASTE THIRD FLOOR PLAN & RISERS
FIRE PROTECTION REQUIREMENTS Fire	WALLS, ABOVE GRADE (EACH ASSEMBLY) DESCRIPTION OF ASSEMBLY: VINYL SIDING OVER WOOD FRAMING W/ SHEATHING (EXTERIOR) & G.W.B. (INTERIOR) U-VALUE OF TOTAL ASSEMBLY: 0.62 R-VALUE OF INSULATION: 15 OPENINGS (WINDOWS OR DOORS WITH GLAZING) U-VALUE OF ASSEMBLY: 0.35 SOLAR HEAT GAIN COEFFICIENT: 0.30 PROJECTION FACTOR: 0.0 ASSUMED DOOR R-VALUES: 0.35	
COLUMNS, GIRDERS AND TRUSSES 0 0 0	WALLS, BELOW GRADE (EACH ASSEMBLY) DESCRIPTION OF ASSEMBLY: N/A U-VALUE OF TOTAL ASSEMBLY: N/A R-VALUE OF INSULATION: N/A FLOORS (EACH ASSEMBLY) DESCRIPTION OF ASSEMBLY: N/A U-VALUE OF TOTAL ASSEMBLY: N/A R-VALUE OF INSULATION: N/A	
WEST	SLAB ON GRADE (EACH ASSEMBLY) DESCRIPTION OF ASSEMBLY: CONCRETE SLAB ON GRADE WITH PERIMETER INSULATION U-VALUE OF TOTAL ASSEMBLY: 0.10 R-VALUE OF INSULATION: 10 HORIZONTAL/VERTICLE REQUIREMENT: N/A SLAB HEATED: NO	
ROOF-CEILING ASSEMBLY		
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1920 FT. BRAGG ROAD
FAYETTEVILLE,
NORTH CAROLINA 28303
TELE. (910) 485-8567
andy@designedtobuild.com

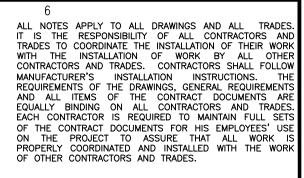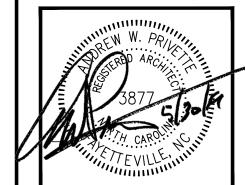

STORY, TEN-UNIT BUILDING 310 GALLERY DRIVE

FAIRWAY POINTE at THREE—STORY, 310 GA SPRING LAKE,

JOB CODE: 18FAIRWAY-10
DRAWN BY: S.S.TOPE
CHECKED BY: A. PRIVETTE
COPYRIGHT:
DESIGNED TO BUILD

COVER SHEET &

NC BUILDING
CODE SUMMARY

G-101



ANDREW W. PRIVETTE, ARCHITECT

1920 FT. BRAGG ROAD - FAYETTEVILLE, N.C. 28303 - (910) 485-8567




MAY 30, 2019


Reviewed For Code Compliance By:

D. Banks Wallace

Chief Deputy Fire Marshal

07/30/2019 11:12:03 AM

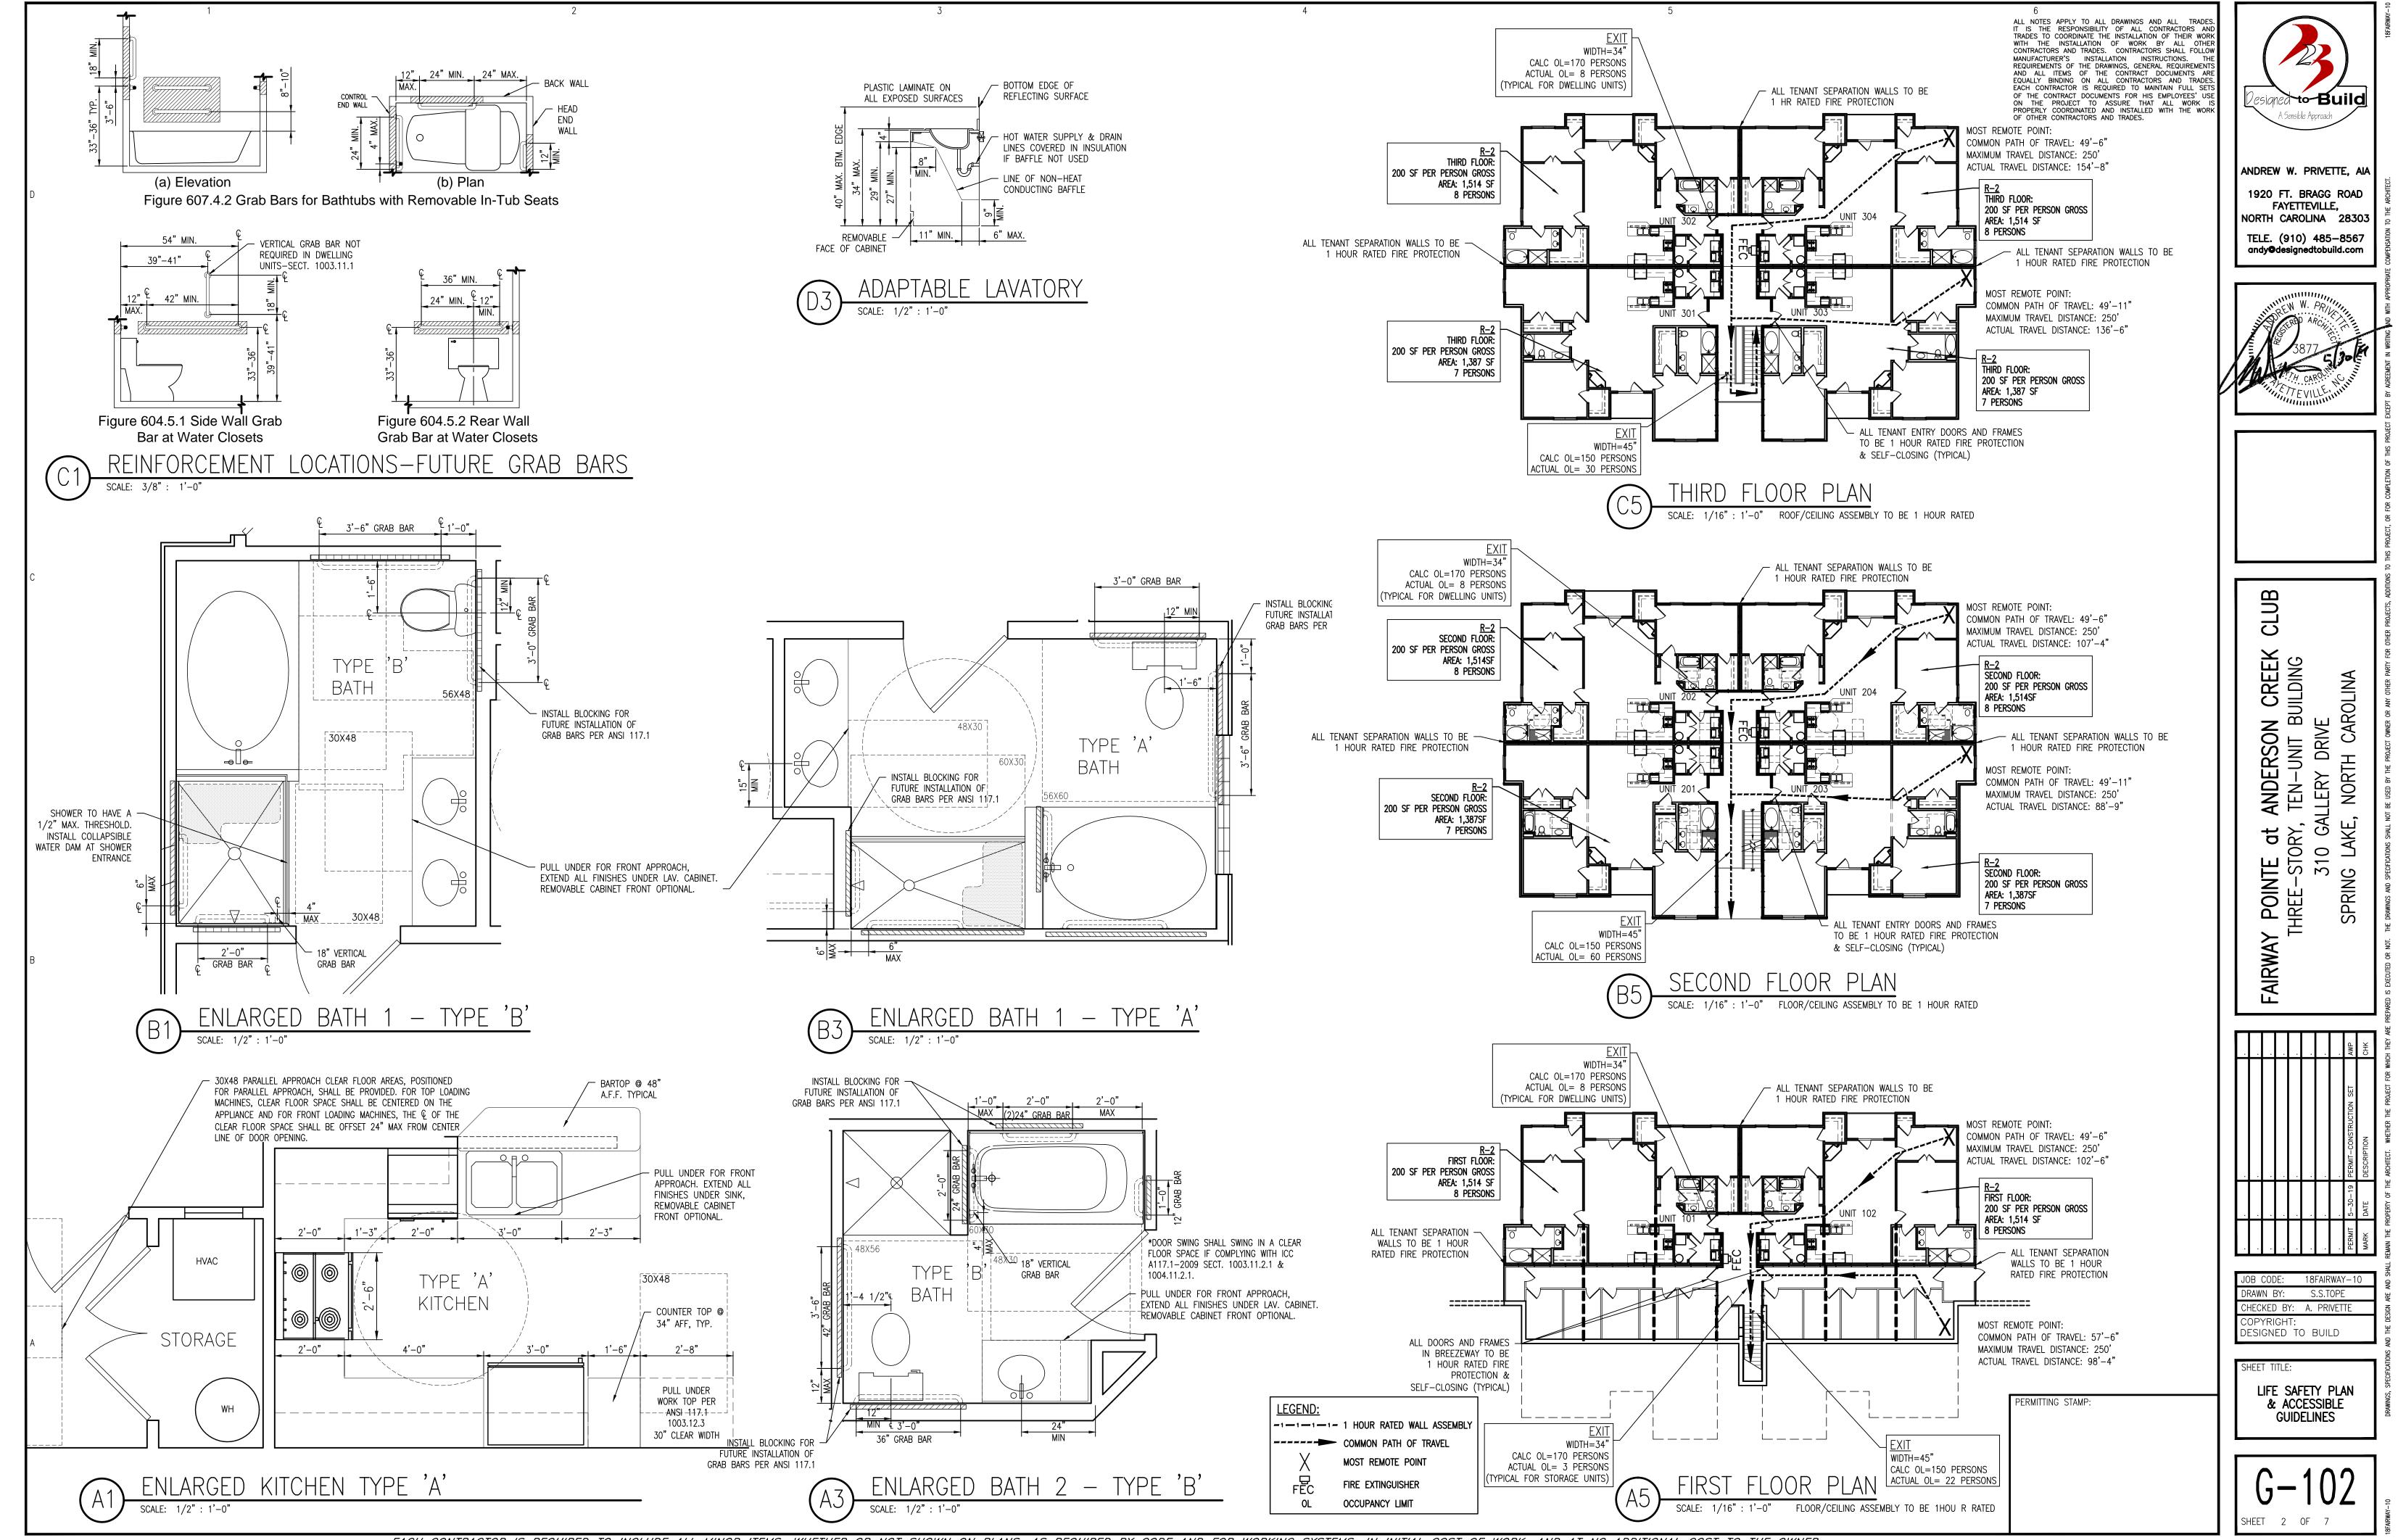

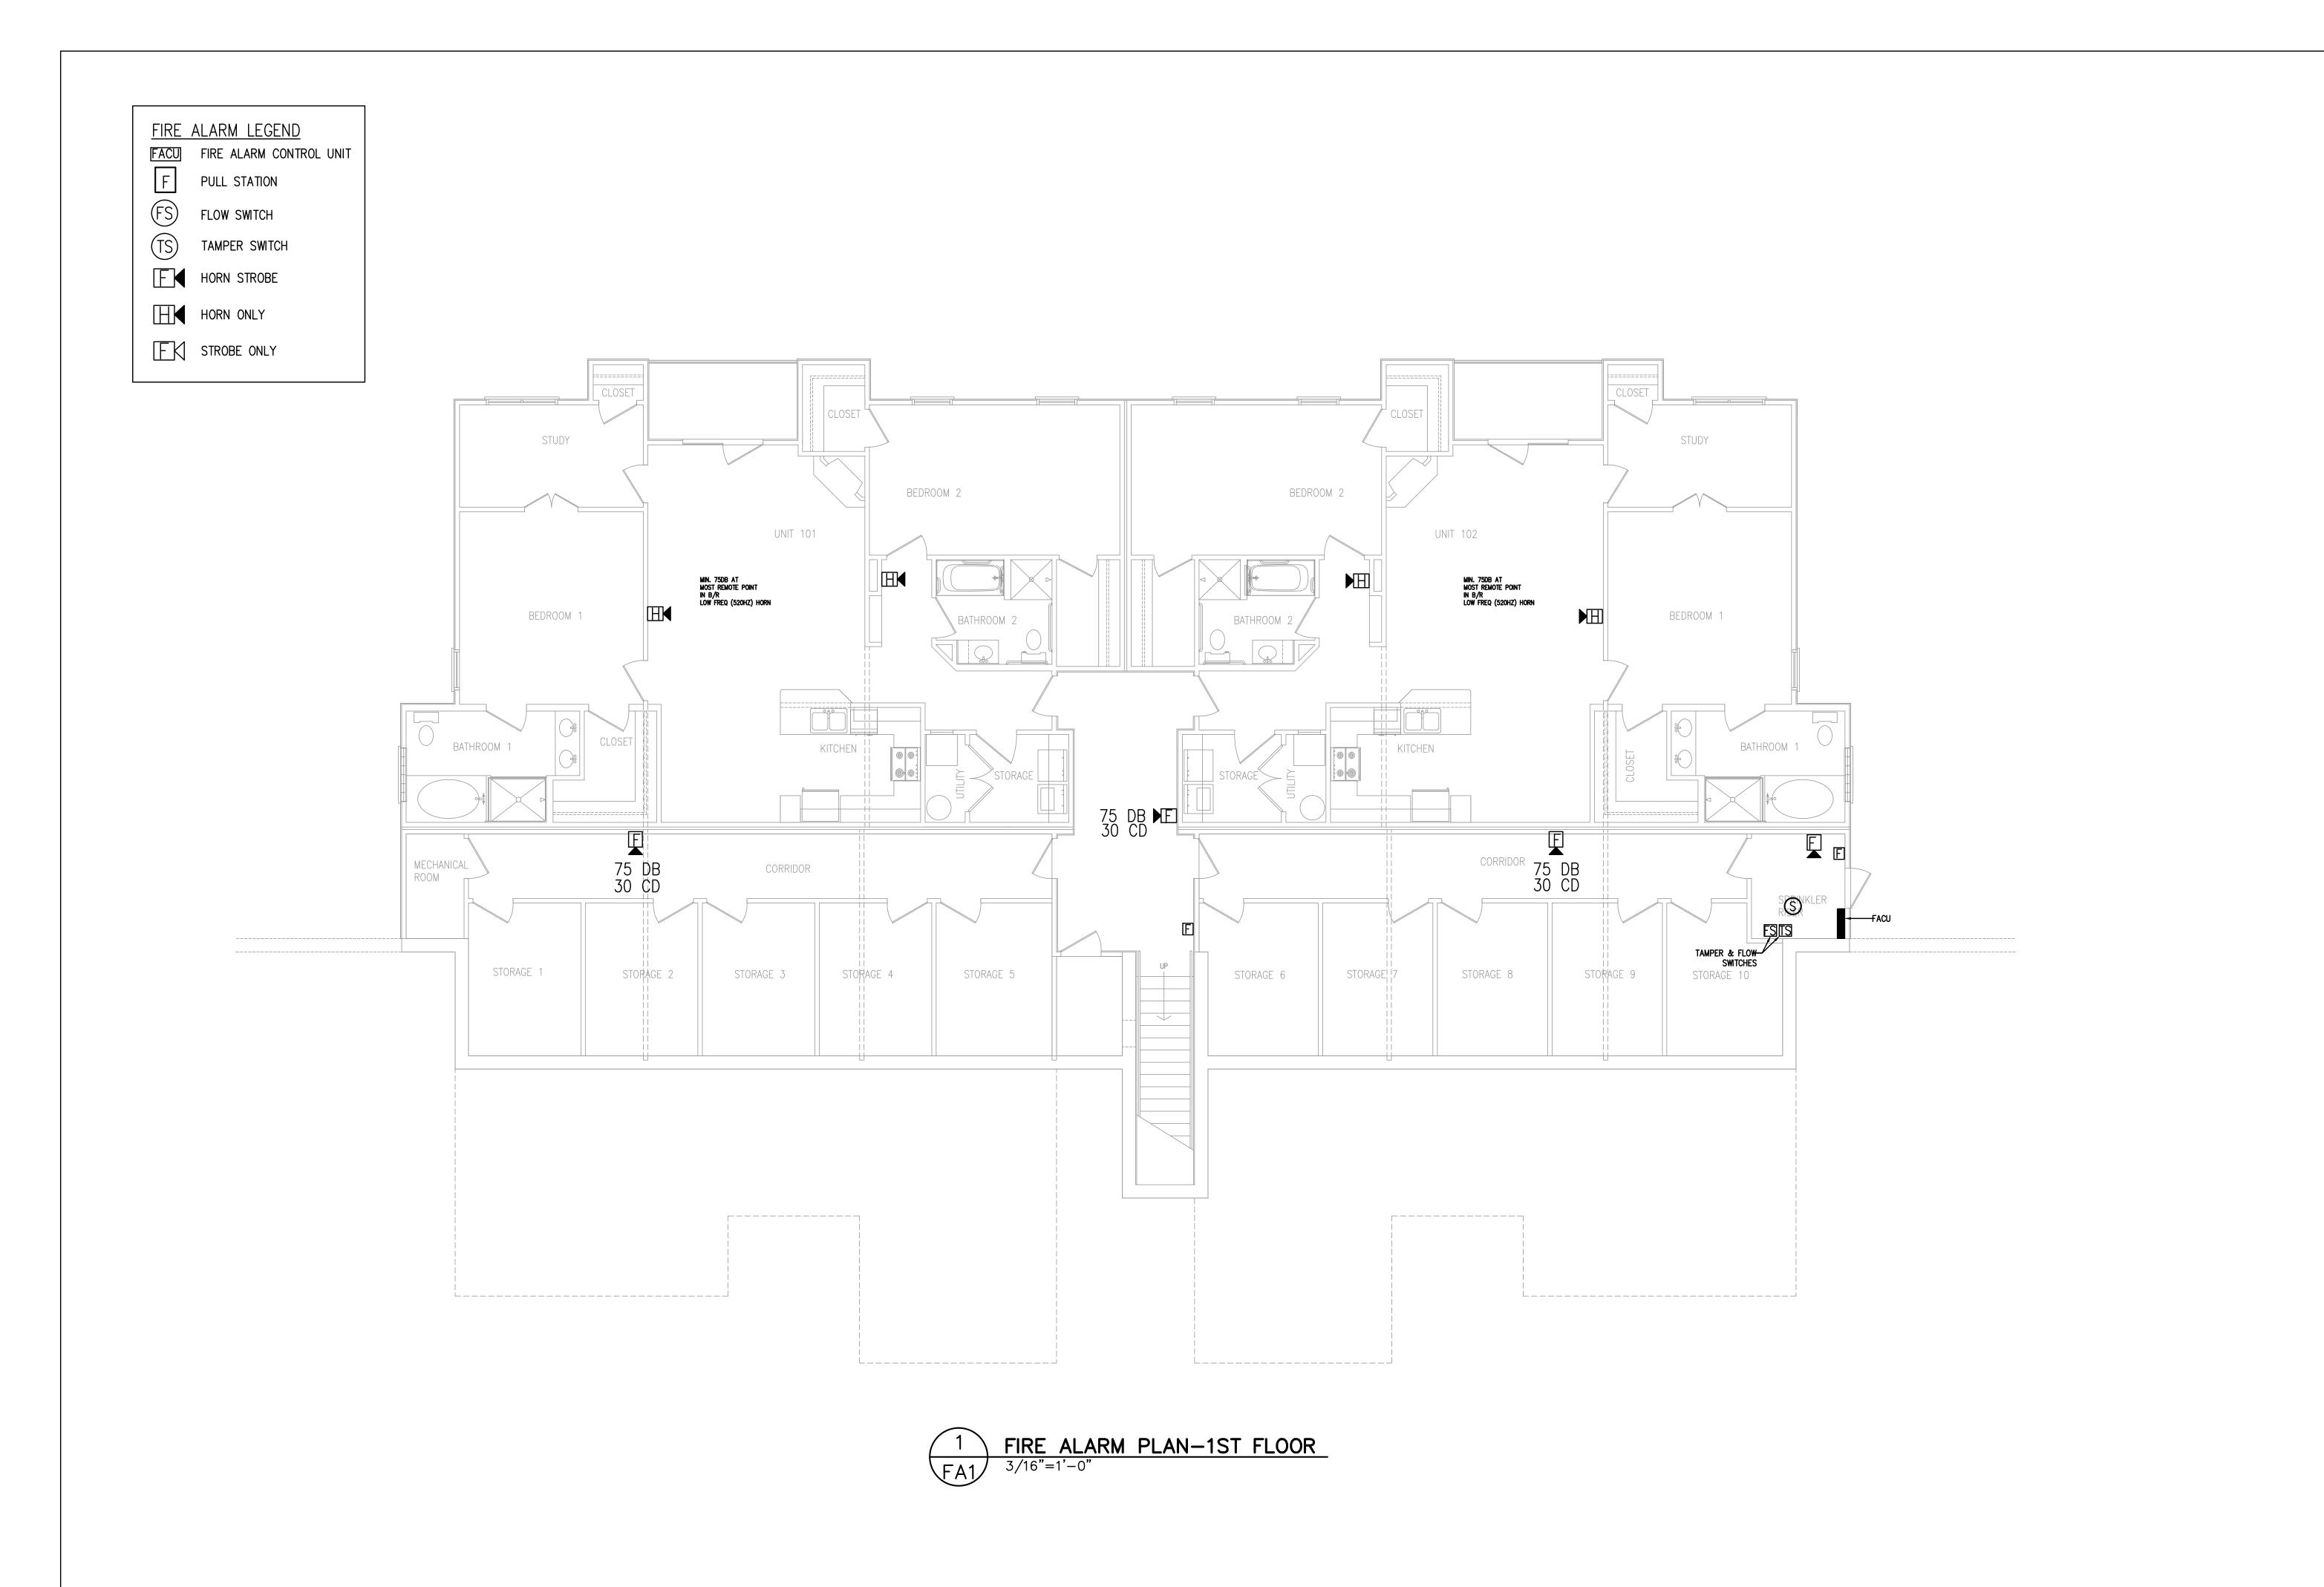

Jun 03, 2019

Engineering, Plains Coastal
295 Locklear Road
P.O. Box 1117
Pembroke, NC 2837
Voice: 910-521-727
Fax: 910-775-007

FE 5 - VERSION 2013
PY, TEN-UNIT BUILDING
RIVE, BUILDING #330
RIVE, BUILDING #330
RIVE, BUILDING #330
RIVE, BUILDING #330

FAIRWAY FTHREE-GALLE GALLE ANDERSON

JOB CODE: 2019–051 DRAWN BY: CHECKED BY: SHEET TITLE: FIRE ALARM PLAN FIRST FLOOR

MAY 22, 2019

FIRE ALARM LEGEND

FACU FIRE ALARM CONTROL UNIT

PULL STATION

FLOW SWITCH

HORN STROBE HORN ONLY


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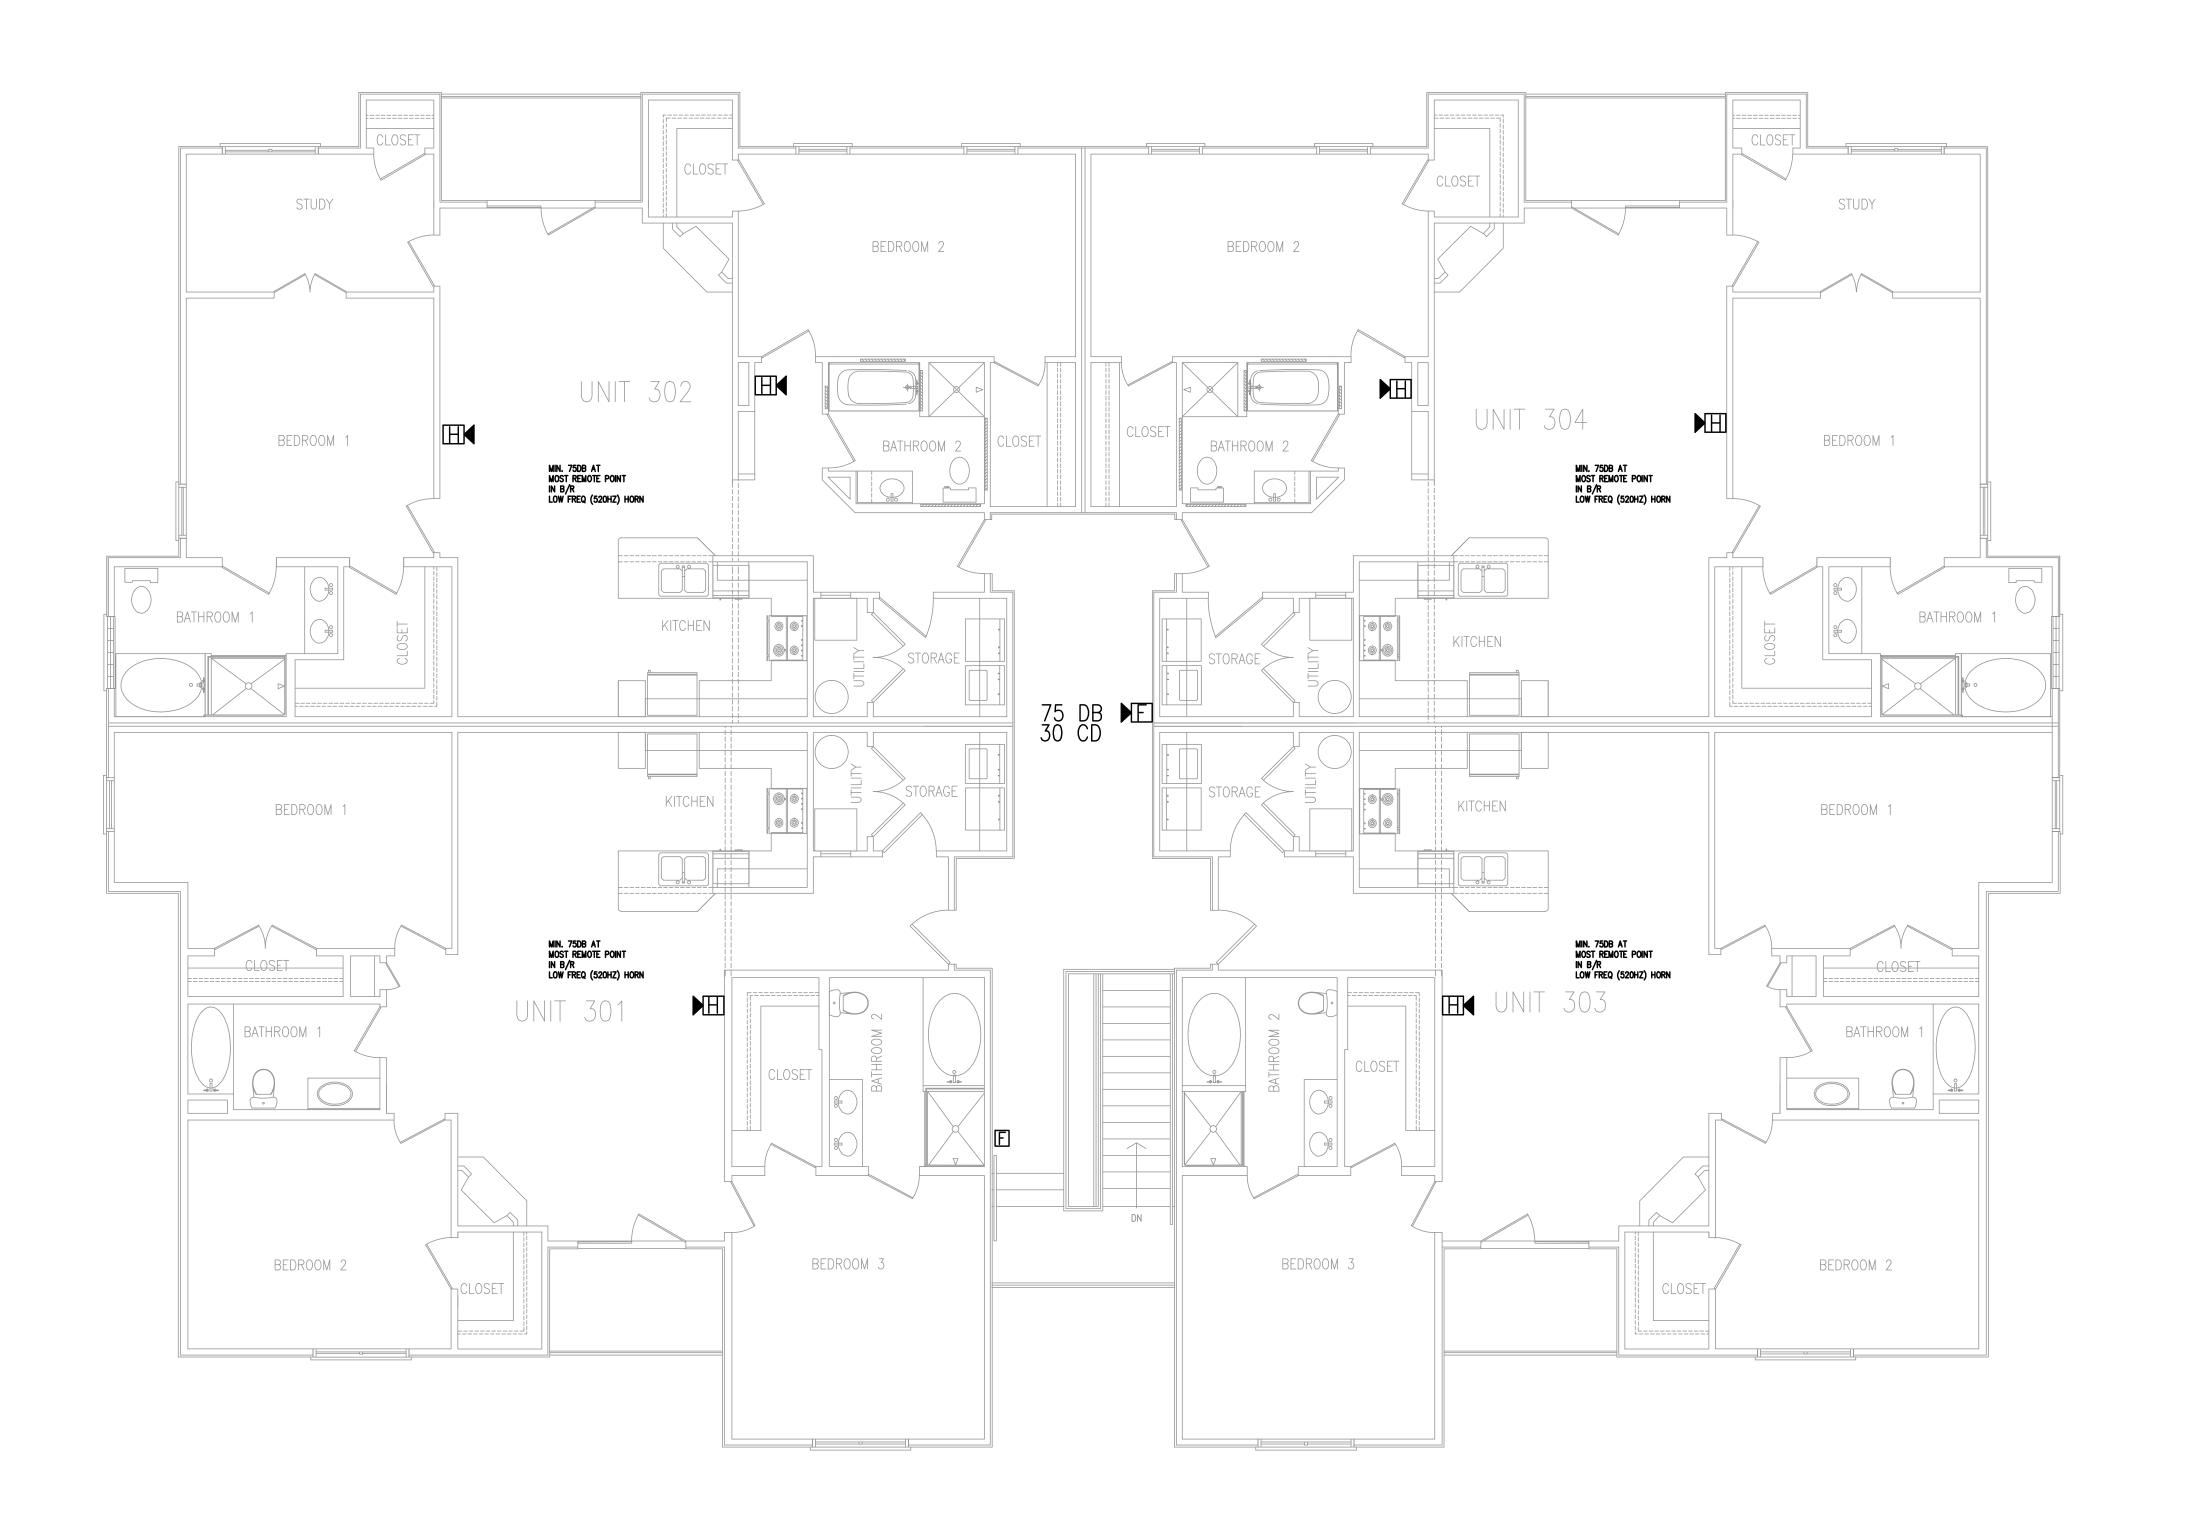
Jun 03, 2019

VERSION 2013 UNIT BUILDING

FAIRWAY JOB CODE: 2019-051

DRAWN BY:
CHECKED BY:
SHEET TITLE:
FIRE ALARM PLAN
SECOND FLOOR



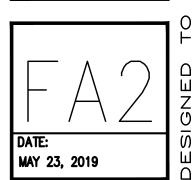

1 FIRE ALARM PLAN-3RD FLOOR
FA3 3/16"=1'-0"

Coastal Plains Engineering, P.A.

295 Locklear Road
P.O. Box 1117
Pembroke, NC 28372
Voice: 910-521-7213
Fax: 910-775-0076
www.coastalplainseng.com

Jun 03, 2019


FAIRWAY POINTE 5 – VERSION 2013 THREE-STORY, TEN-UNIT BUILDING GALLERY DRIVE, BUILDING #330 ANDERSON CREEK CLUB, NORTH CAROLINA

JOB CODE: 2019-051


DRAWN BY:
CHECKED BY:
SHEET TITLE:
FIRE ALARM PLAN
THIRD FLOOR


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MAY 23, 2019


NFPA 72 AND ADA DEVICE INSTALLATION REQUIREMENTS

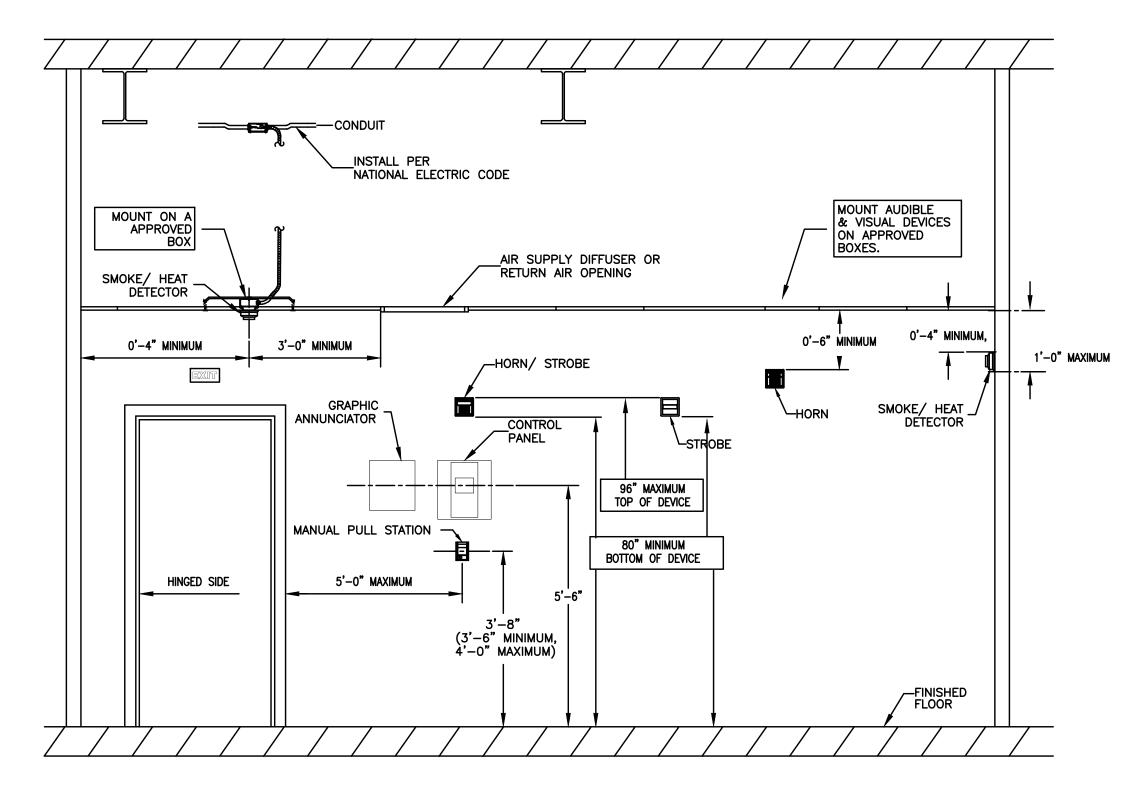


FA4 N.T.S. TIRE ALARM DEVICE MOUNTING HEIGHTS

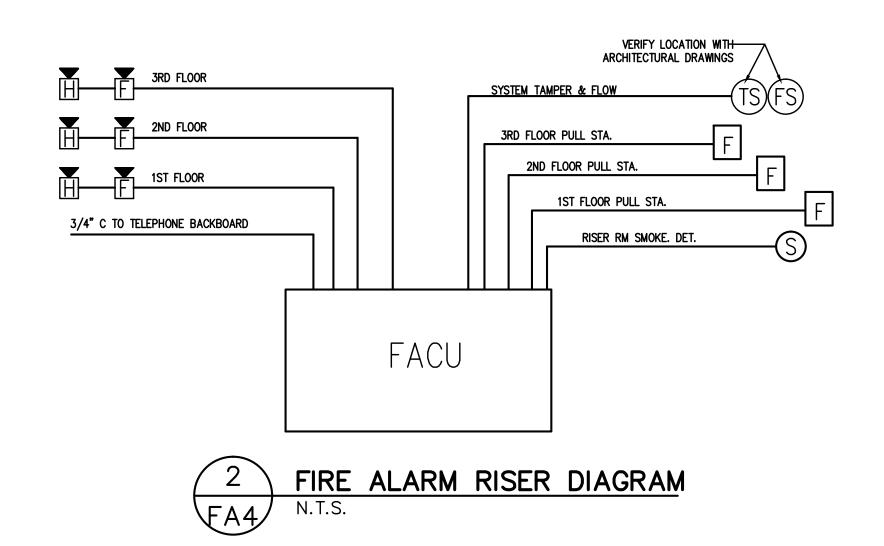

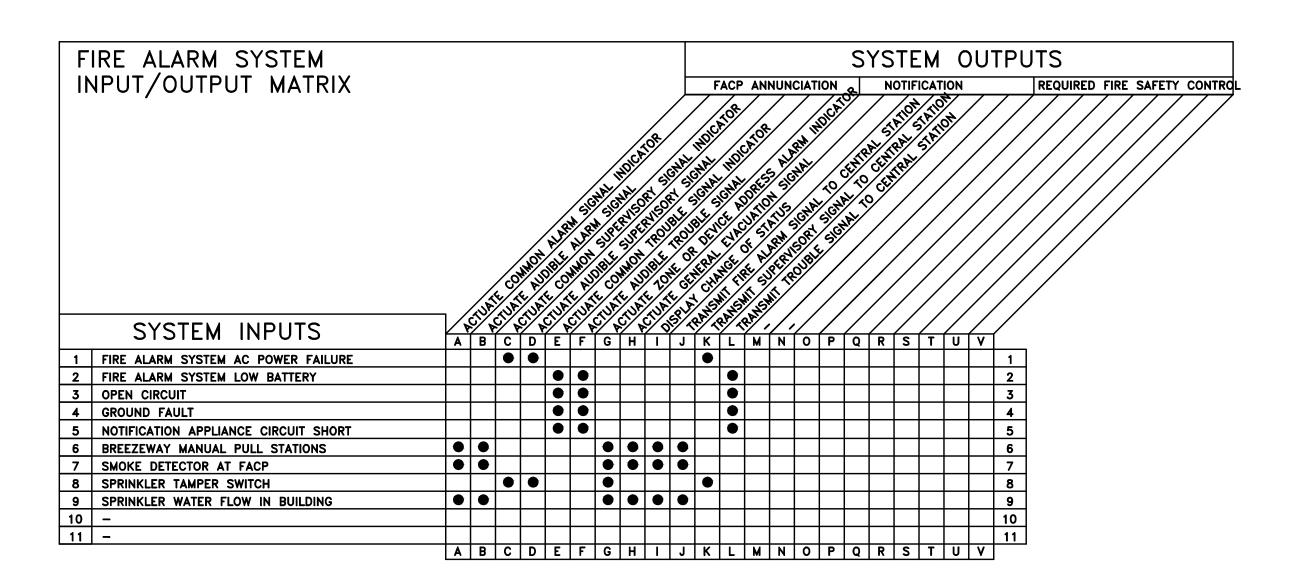

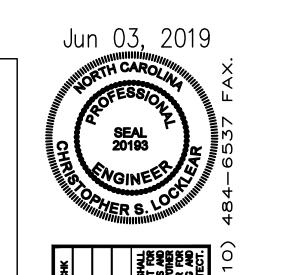

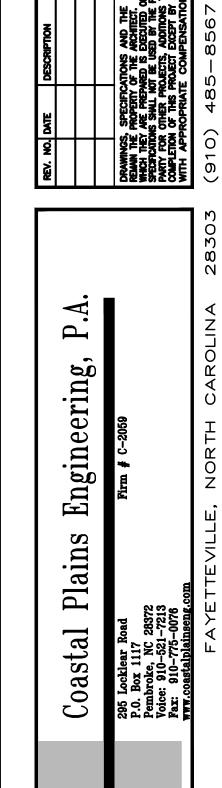

FAIRWAY POINTE 5 - VERSION 2013 THREE-STORY, TEN-UNIT BUILDING GALLERY DRIVE, BUILDING #330 ANDERSON CREEK CLUB, NORTH CAROLINA

JOB CODE: 2019-051

DRAWN BY:
CHECKED BY:
SHEET TITLE:
FIRE ALARM DETAILS

DATE:
MAY 23, 2019