



SCHULTE BUILDING SYSTEMS

17600 BADTKE ROAD
 HOCKLEY, TEXAS 77447
 281-304-6111 office
 281-304-6113 fax

BUILDING DESCRIPTION

BUILDING SIZE: 75.00' x 108.83' x 20.00' SLOPE: 1.0:1.2
 BUILDING SIZE: _____ SLOPE: _____
 BUILDING SIZE: _____ SLOPE: _____
 (BUILDING DIMENSIONS ARE NOMINAL, REFER TO PLANS)

This is to certify that this structure is designed utilizing the loads indicated and applied as required by the building code shown below. The certification is limited to the structural design of the framing and covering parts manufactured by the building manufacturer and is specified in the contract. Accessory items such as doors, window, louvers, translucent panels, and ventilators are not included. Also excluded are other parts of the project not provided by the building manufacturer such as foundations, masonry walls, mechanical equipment and erection of the building. The building should be erected on a properly designed foundation in accordance with the building manufacturer's design manual, the attached drawings and good erection practices.

Design Code IBC 15 / NBC 18

General Loads
 Roof Dead Load (D) 3.000 psf
 Roof Collateral Load (C) 6 psf
 Roof Live Load (Lr) 20.000 psf
 Tributary Live Load Reduction Yes
 Snow Load Flat-Roof Snow Load (P_f) 12.6000 psf
 Ground Snow Load (P_g) 15.0000 psf
 Snow Exposure Factor (C_e) 1
 Snow Load Importance Factor (I_s) 1.0000
 Thermal Factor (C_t) 1.20

Wind Load
 Wind Speed (V 3S) N/A mph 90.6277 mph
 Wind Speed (Vult & Vasd) 117.0000 mph
 Occupancy / Risk Category II - Normal
 Wind Exposure Category C
 Internal Pressure Coefficient (GCp1) +/-0.55
 Wind Enclosure Fortified
 Wind Importance Factor N/A
 Seismic Load
 Seismic Importance Factor (I_e) 1.00
 Spectral Response Accelerations (S_a and S₁) 0.1750 0.0840
 Site Class D
 Spectral Response Coefficients (S_{ds} and S_{d1}) 0.1967 0.1344
 Seismic Design Category C
 Basic Seismic-Force-Resisting System(s) *

Total Design Base Shear (V) 5.80 Kips 5.90 Kips
 Seismic Response Coefficient(s) (C_s) 0.0623 0.0623
 Response Modification Factor(s) (R) 3.0000 3.0000
 Analysis Procedure: Equivalent Lateral Force

* STEEL SYSTEMS NOT SPECIFICALLY DETAILED FOR SEISMIC RESISTANCE

PANEL, TRIM AND FRAMING INFORMATION

ROOF PANELS
 TYPE: TS-324 GAUGE: 24 COLOR: Galvalume
 UL90 CERTIFICATION: Yes (By Others)
 INSULATION: 4 in. (By Others)
 MASTIC: STD.
 IF STANDING SEAM: CLIP TYPE: High Float

WALL PANELS
 TYPE: PBR GAUGE: 26 COLOR: Light Stone
 INSULATION: 6 in. (By Others)
ROOF LINER PANELS
 TYPE: U GAUGE: 26 COLOR: Commodity White
 HEIGHT: FULL

FASCIA PANELS
 TYPE: N/A GAUGE: N/A COLOR: N/A

SOFFIT PANELS
 TYPE: N/A GAUGE: N/A COLOR: N/A

PARTITION PANELS
 TYPE: N/A GAUGE: N/A COLOR: N/A

TRIM
 RAKE: Saddle Tan
 EAVE: Saddle Tan
 GUTTER: Saddle Tan
 DOWNSPOUT: Saddle Tan
 VALLEY GUTTER: Saddle Tan
 HEADER: Saddle Tan
 SILL: Saddle Tan
 JAMB: Saddle Tan
 BASE TRIM: Saddle Tan
 CORNER: Saddle Tan
 LINER: Saddle Tan
 SOFFIT: Saddle Tan
 FASCIA SILL: Saddle Tan
 CAP TRIM: Saddle Tan

PRIMARY FRAMING
 (MAIN FRAMES & ENDWALL FRAMES)
 (WIND COLUMNS & BENTS)
 Red-Oxide

SECONDARY FRAMING
 (GIRTS, EAVE STRUTS, PURLINS DOOR/FRAMED OPENG. & CLIPS ETC.)
 Red-Oxide

DN 9 Loads, as noted, are as given within order documents and are applied in general accordance with the applicable provisions of the model code and/or specification indicated. Neither the manufacturer nor the certifying engineer declares or attests that the loads as designated are proper for local provisions that may apply or for site specific parameters. The manufacturer's engineer's certification is limited to designs supplied by and/or engineer of record for the overall construction project.


DN 18 X-Bracing is to be installed to a taut condition with all slack removed. Do not tighten beyond this state.

DN 19 The framing as shown at this elevation is not designed for future expansion. Corresponding frame reactions are calculated based upon actual tributary area.

DN 28 The framed opening support members provided are designed ONLY for wind load forces exerted "normal (perpendicular) to the opening". No additional loads are included.

ISSUE	PAGE	DESCRIPTION
A	C1 OF 2	COVER PAGE
A	C2 OF 2	NOTES PAGE
0	F1 OF 2	ANCHOR ROD PLAN
0	F2 OF 2	REACTIONS
A	E1 OF 11	ROOF FRAMING
A	E2 OF 11	ROOF SHEETING
A	E3 OF 11	CROSS SECTION
A	E4 OF 11	CROSS SECTION
A	E5 OF 11	CROSS SECTION
A	E6 OF 11	SIDEWALL ELEVATION
A	E7 OF 11	SIDEWALL ELEVATION
A	E8 OF 11	ENDWALL ELEVATION
A	E9 OF 11	ENDWALL/PARTITION ELEVATION
A	E10 OF 11	ROOF LINER
A	E11 OF 11	ENDWALL ELEVATION
A	D1 OF 5	DETAIL DRAWINGS
A	D2 OF 5	DETAIL DRAWINGS
A	D3 OF 5	DETAIL DRAWINGS
A	D4 OF 5	DETAIL DRAWINGS
A	D5 OF 5	DETAIL DRAWINGS

IAS Certification Accredited
 Certification # MB-188

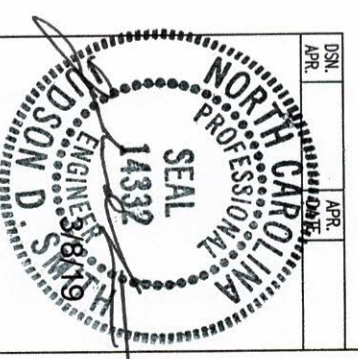

DRAWING STATUS

FOR APPROVAL: THESE DRAWINGS, BEING FOR APPROVAL, ARE BY DEFINITION NOT FINAL, AND ARE FOR CONCEPTUAL REPRESENTATION ONLY. NO PERMIT DOCUMENTS, ONLY DRAWINGS ISSUED FOR CONSTRUCTION CAN BE CONSIDERED AS COMPLETE.

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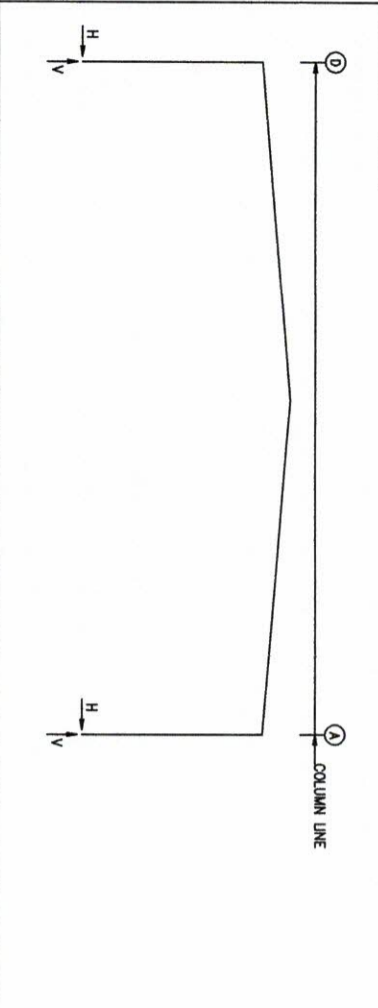
NO.	DATE	REVISIONS	DESCRIPTION	BY	CHK'D
A	3/6/19		FOR PERMIT	WSC	DNV

SCHULTE BUILDING SYSTEMS
 17600 Badtke Road - Hockley, Texas 77447
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 www.schultebuildingsystems.com

ENGINEER RUTY REEDIN, DESIGN BUILDERS, LLC
 ADDRESS: 1400 SUNDAY DR. STE 109
 FLOUJAY VARIANA, NC 27507
 PHONE: 147-2388

DATE 3/4/19
SCALE N.T.S.
SHEET NO. C1 of 2
ISSUE A

FRAME LINES: 2 3 4 5



RIGID FRAME: MAXIMUM REACTIONS, ANCHOR ROOFS, & BASE PLATES

Frame Line	Col Line	Load Id	Hmax	Vmax	Hmin	Vmin	Boft(h)	Boe-Plate(h)	Width	Length	Thick	Groat (h)
2*	D	6	16.1	29.0	-11.3	-19.1	4	0.750	10.00	11.00	0.500	0.0
	A	2	11.3	-19.1	-16.1	29.0	4	0.750	10.00	11.00	0.500	0.0
Frame lines: 2 3												

RIGID FRAME: MAXIMUM REACTIONS, ANCHOR ROOFS, & BASE PLATES

Frame Line	Col Line	Load Id	Hmax	Vmax	Hmin	Vmin	Boft(h)	Boe-Plate(h)	Width	Length	Thick	Groat (h)
4	D	6	13.4	23.5	-7.5	-11.8	4	0.750	8.000	9.500	0.500	0.0
	A	2	7.5	-11.8	-13.4	23.5	4	0.750	8.000	9.500	0.500	0.0
Frame lines: 2 3												

RIGID FRAME: MAXIMUM REACTIONS, ANCHOR ROOFS, & BASE PLATES

Frame Line	Col Line	Load Id	Hmax	Vmax	Hmin	Vmin	Boft(h)	Boe-Plate(h)	Width	Length	Thick	Groat (h)
5	D	6	4.3	10.0	-2.1	-4.4	4	0.750	10.00	11.00	0.500	0.0
	A	4	2.1	-4.4	-4.3	10.0	4	0.750	10.00	11.00	0.500	0.0
Frame lines: 2 3												

ENDWALL COLUMN: BASIC COLUMN REACTIONS (k)

Frame Line	Col Line	Load Id	Hmax	Vmax	Hmin	Vmin	Boft(h)	Boe-Plate(h)	Width	Length	Thick	Groat (h)
1	D	3	1.0	2.7	-2.0	-6.7	4	0.750	10.00	11.00	0.500	0.0
	A	2	2.0	-6.7	-2.0	2.7	4	0.750	10.00	11.00	0.500	0.0
Frame lines: 2 3												

ENDWALL COLUMN: MAXIMUM REACTIONS, ANCHOR ROOFS, & BASE PLATES

Frame Line	Col Line	Load Id	Hmax	Vmax	Hmin	Vmin	Boft(h)	Boe-Plate(h)	Width	Length	Thick	Groat (h)
1	D	3	3.0	0.0	0.0	0.0	4	0.750	8.000	10.00	0.375	0.0
	A	2	0.0	0.0	0.0	0.0	4	0.750	8.000	10.00	0.375	0.0
Frame lines: 2 3												

ENDWALL COLUMN: MAXIMUM REACTIONS, ANCHOR ROOFS, & BASE PLATES

Frame Line	Col Line	Load Id	Hmax	Vmax	Hmin	Vmin	Boft(h)	Boe-Plate(h)	Width	Length	Thick	Groat (h)
1	D	7	2.6	4.8	-2.4	-3.6	4	0.750	8.000	10.00	0.375	0.0
	A	9	0.0	-4.8	2.6	3.6	4	0.750	8.000	10.00	0.375	0.0
Frame lines: 2 3												

ENDWALL COLUMN: MAXIMUM REACTIONS, ANCHOR ROOFS, & BASE PLATES

Frame Line	Col Line	Load Id	Hmax	Vmax	Hmin	Vmin	Boft(h)	Boe-Plate(h)	Width	Length	Thick	Groat (h)
1	D	10	5.3	-9.0	8	-5.0	4	0.750	8.000	10.00	0.375	0.0
	A	11	0.0	9.0	-8	5.0	4	0.750	8.000	10.00	0.375	0.0
Frame lines: 2 3												

RIGID FRAME: BASIC COLUMN REACTIONS (k)

Frame Line	Col Line	Load Id	Dead	Wind	Seismic	Panel Shear	Note
4	D	2.2	4.4	3.2	5.5	6.4	10.9
	A	-2.2	-4.4	-3.2	-5.5	-6.4	-10.9
Frame lines: 2 3							

BUILDING BRACING REACTIONS

Loc	Wall	Col Line	Horz	Wind	Seismic	Panel Shear	Note
1	LEW	A	3.4	4.1	5.0	1.4	1.8
		B	3.4	4.1	5.0	1.4	1.8
(a) Wind bent in bay, base above finish floor (b) Rigid frame of endwall (c) Brooding in roof to rigid frame							

NOTES FOR REACTIONS

Building reactions are based on the following building data:

- Width (ft) = 75.0
- Length (ft) = 20.0 / 20.0
- Eave Height (ft) = 10.7 / 1.0
- Roof Slope (rise/run) = 3.0
- Dead Load (psf) = 6.0
- Collateral Load (psf) = 20.0
- Roof Live Load (psf) = 12.0
- Frame Live Load (psf) = 12.6
- Snow Load (psf) = 117.0
- Wind Speed (mph) = IBC 15 / NBC 18
- Wind Code = C
- Exposure = P
- Closed/Open = N.A.
- Importance Wind = 1.00
- Importance Seismic = 1.00
- Seismic Zone = C
- Seismic Coeff (F_wS_s) = 0.28

REVISIONS

NO.	DATE	DESCRIPTION	BY	CHKD
0	3/6/19	FOR CONSTRUCTION		

SCHULTE BUILDING SYSTEMS

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 PHONE: 281.304.6111 877.251.2534
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 RALEIGH, NC 27607
 PHONE: 919.875.1100
 FAX: 919.875.1101

ENGINEER SEAL
 NORTH CAROLINA PROFESSIONAL SEAL
 14332
 EDSON D.

DRAWING STATUS

EDR APPROVAL: THESE DRAWINGS, BEING FOR APPROVAL, ARE BY DEFINITION NOT FINAL, AND ARE FOR CONSTRUCTION INTERPRETATION OF THE PROJECT DOCUMENTS. ONLY DRAWINGS ISSUED FOR CONSTRUCTION CAN BE CONSIDERED AS COMPLETE.

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EDR CONSTRUCTION: COMPLETE.

REVISIONS

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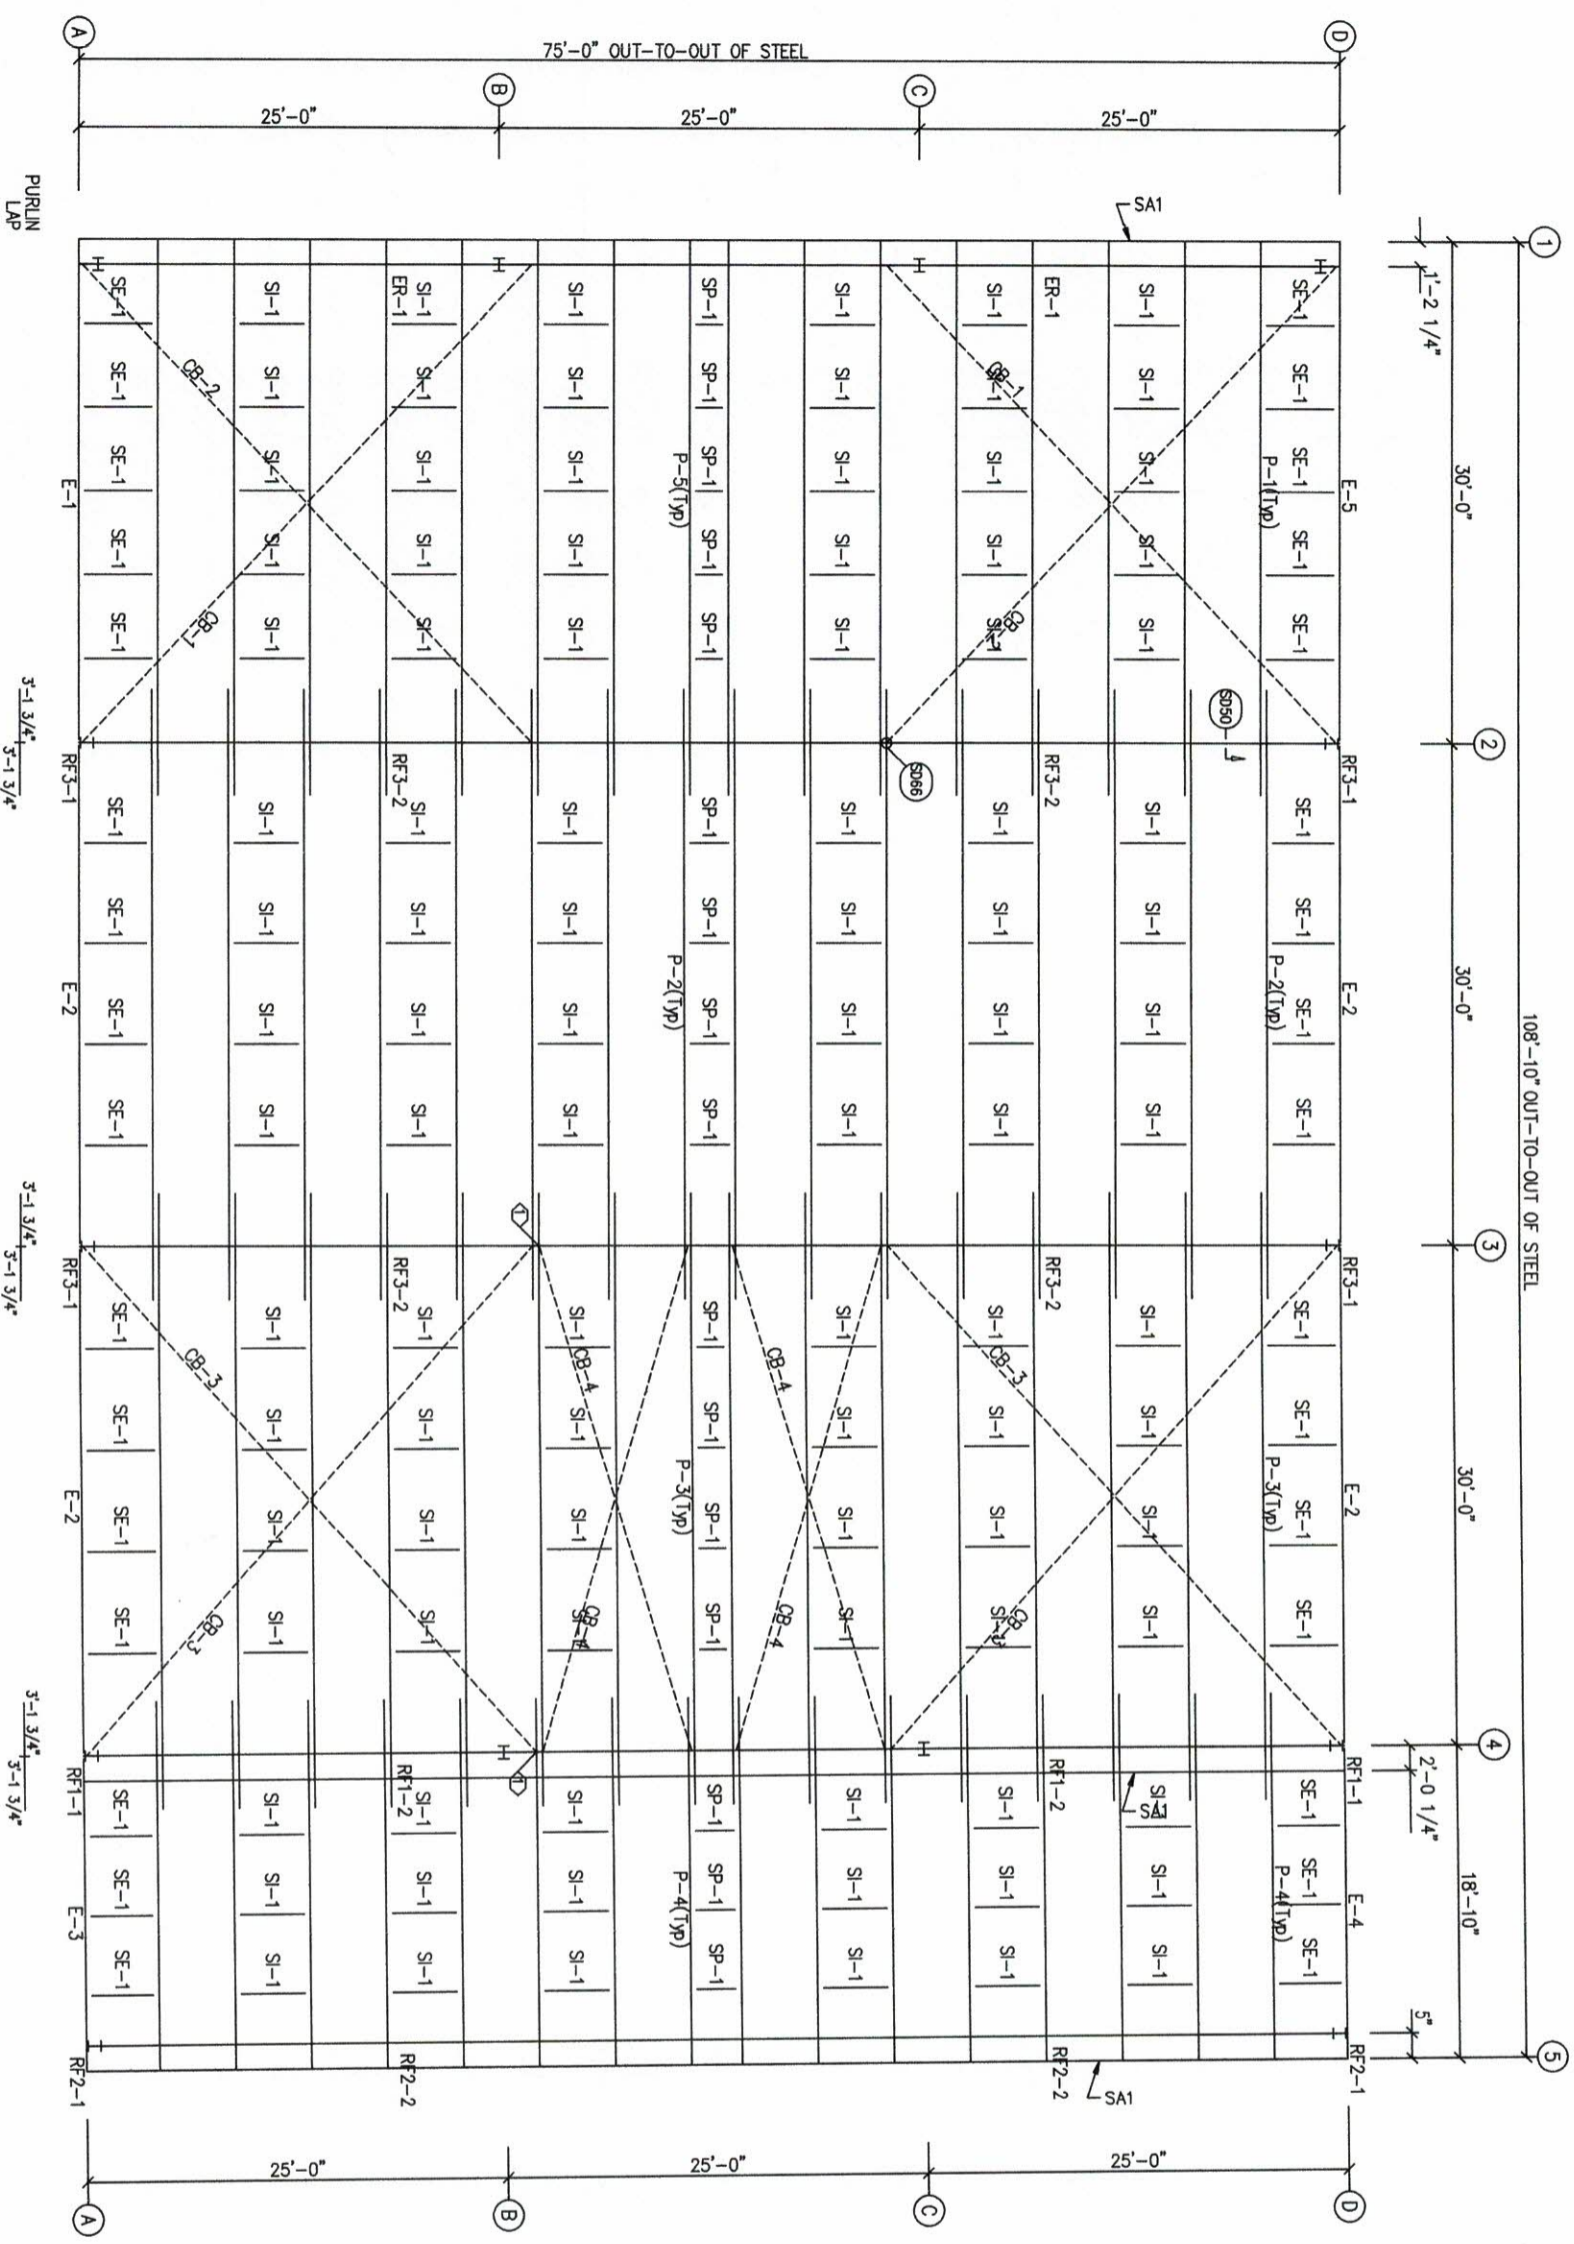
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 EDSON D.

SPECIAL BOLTS

MEMBER TABLE	MARK	PART	QUAN	TYPE	DIA	LENGTH	WASH
P-1	10X25Z12		4	A307	1/2"	1 1/4"	0
P-2	10X25Z12		4	A307	1/2"	1 1/4"	0
P-3	10X25Z14		4	A307	1/2"	1 1/4"	0
P-4	10X25Z14		4	A307	1/2"	1 1/4"	0
P-5	10X25Z12		4	A307	1/2"	1 1/4"	0
E-1	10E12		4	A307	1/2"	1 1/4"	0
E-2	10E12		4	A307	1/2"	1 1/4"	0
E-3	10E14		4	A307	1/2"	1 1/4"	0
E-4	10E14		4	A307	1/2"	1 1/4"	0
E-5	10E12		4	A307	1/2"	1 1/4"	0
CB-1	CB80250		4	A307	1/2"	1 1/4"	0
CB-2	CB80250		4	A307	1/2"	1 1/4"	0
CB-3	CB80313		4	A307	1/2"	1 1/4"	0
CB-4	CB80250		4	A307	1/2"	1 1/4"	0
SP-1	BRZ-1		4	A307	1/2"	1 1/4"	0
SE-1	BRZ-1		4	A307	1/2"	1 1/4"	0



ROOF FRAMING PLAN

MEMBER	DESCRIPTION	MARK	NO.	SIZE	DESCRIPTION	MARK	NO.
MEMBER	DESCRIPTION	MARK	NO.	SIZE	DESCRIPTION	MARK	NO.
MEMBER	DESCRIPTION	MARK	NO.	SIZE	DESCRIPTION	MARK	NO.
MEMBER	DESCRIPTION	MARK	NO.	SIZE	DESCRIPTION	MARK	NO.
MEMBER	DESCRIPTION	MARK	NO.	SIZE	DESCRIPTION	MARK	NO.

- ERECTOR NOTES:
- 1) Roof Bracing equally spaced in bays (As Shown), panel to purlin struts (if Required) with clip.
 - 2) Do not attach roof with clip.
 - 3) Triple-Lok seam is required.

DRAWING STATUS

<input type="checkbox"/>	DESIGN APPROVAL	DATE	BY
<input type="checkbox"/>	CONSTRUCTION APPROVAL	DATE	BY
<input type="checkbox"/>	FINAL DRAWING	DATE	BY


REVISIONS


NO.	DATE	DESCRIPTION	BY	CHKD
A	3/6/19	FOR PERMIT	WCS	DIV

SBS SCHULTE BUILDING SYSTEMS

17800 Buckle Road - Houston, Texas 77047
 PHONE: 281.304.6111 877.257.2534
 FAX: 281.304.6113
 www.schultebuildingsystems.com

PROJECT: ROOF FRAMING
 CLIENT: GADD HAULING
 ADDRESS: 1400 SUNDAY DR. STE109
 FLOQUAY VARNIA, NC 27807
 DATE: 3/4/19 N.T.S.
 DESIGNED BY: JBH
 CHECKED BY: JBH
 DRAWN BY: JBH
 SCALE: AS SHOWN
 SHEET NO.: 147388
 OF 11

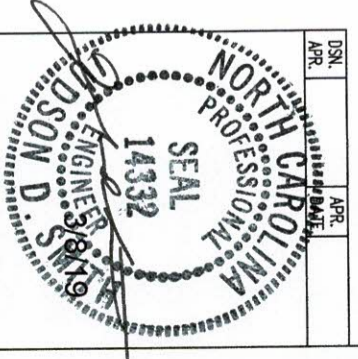

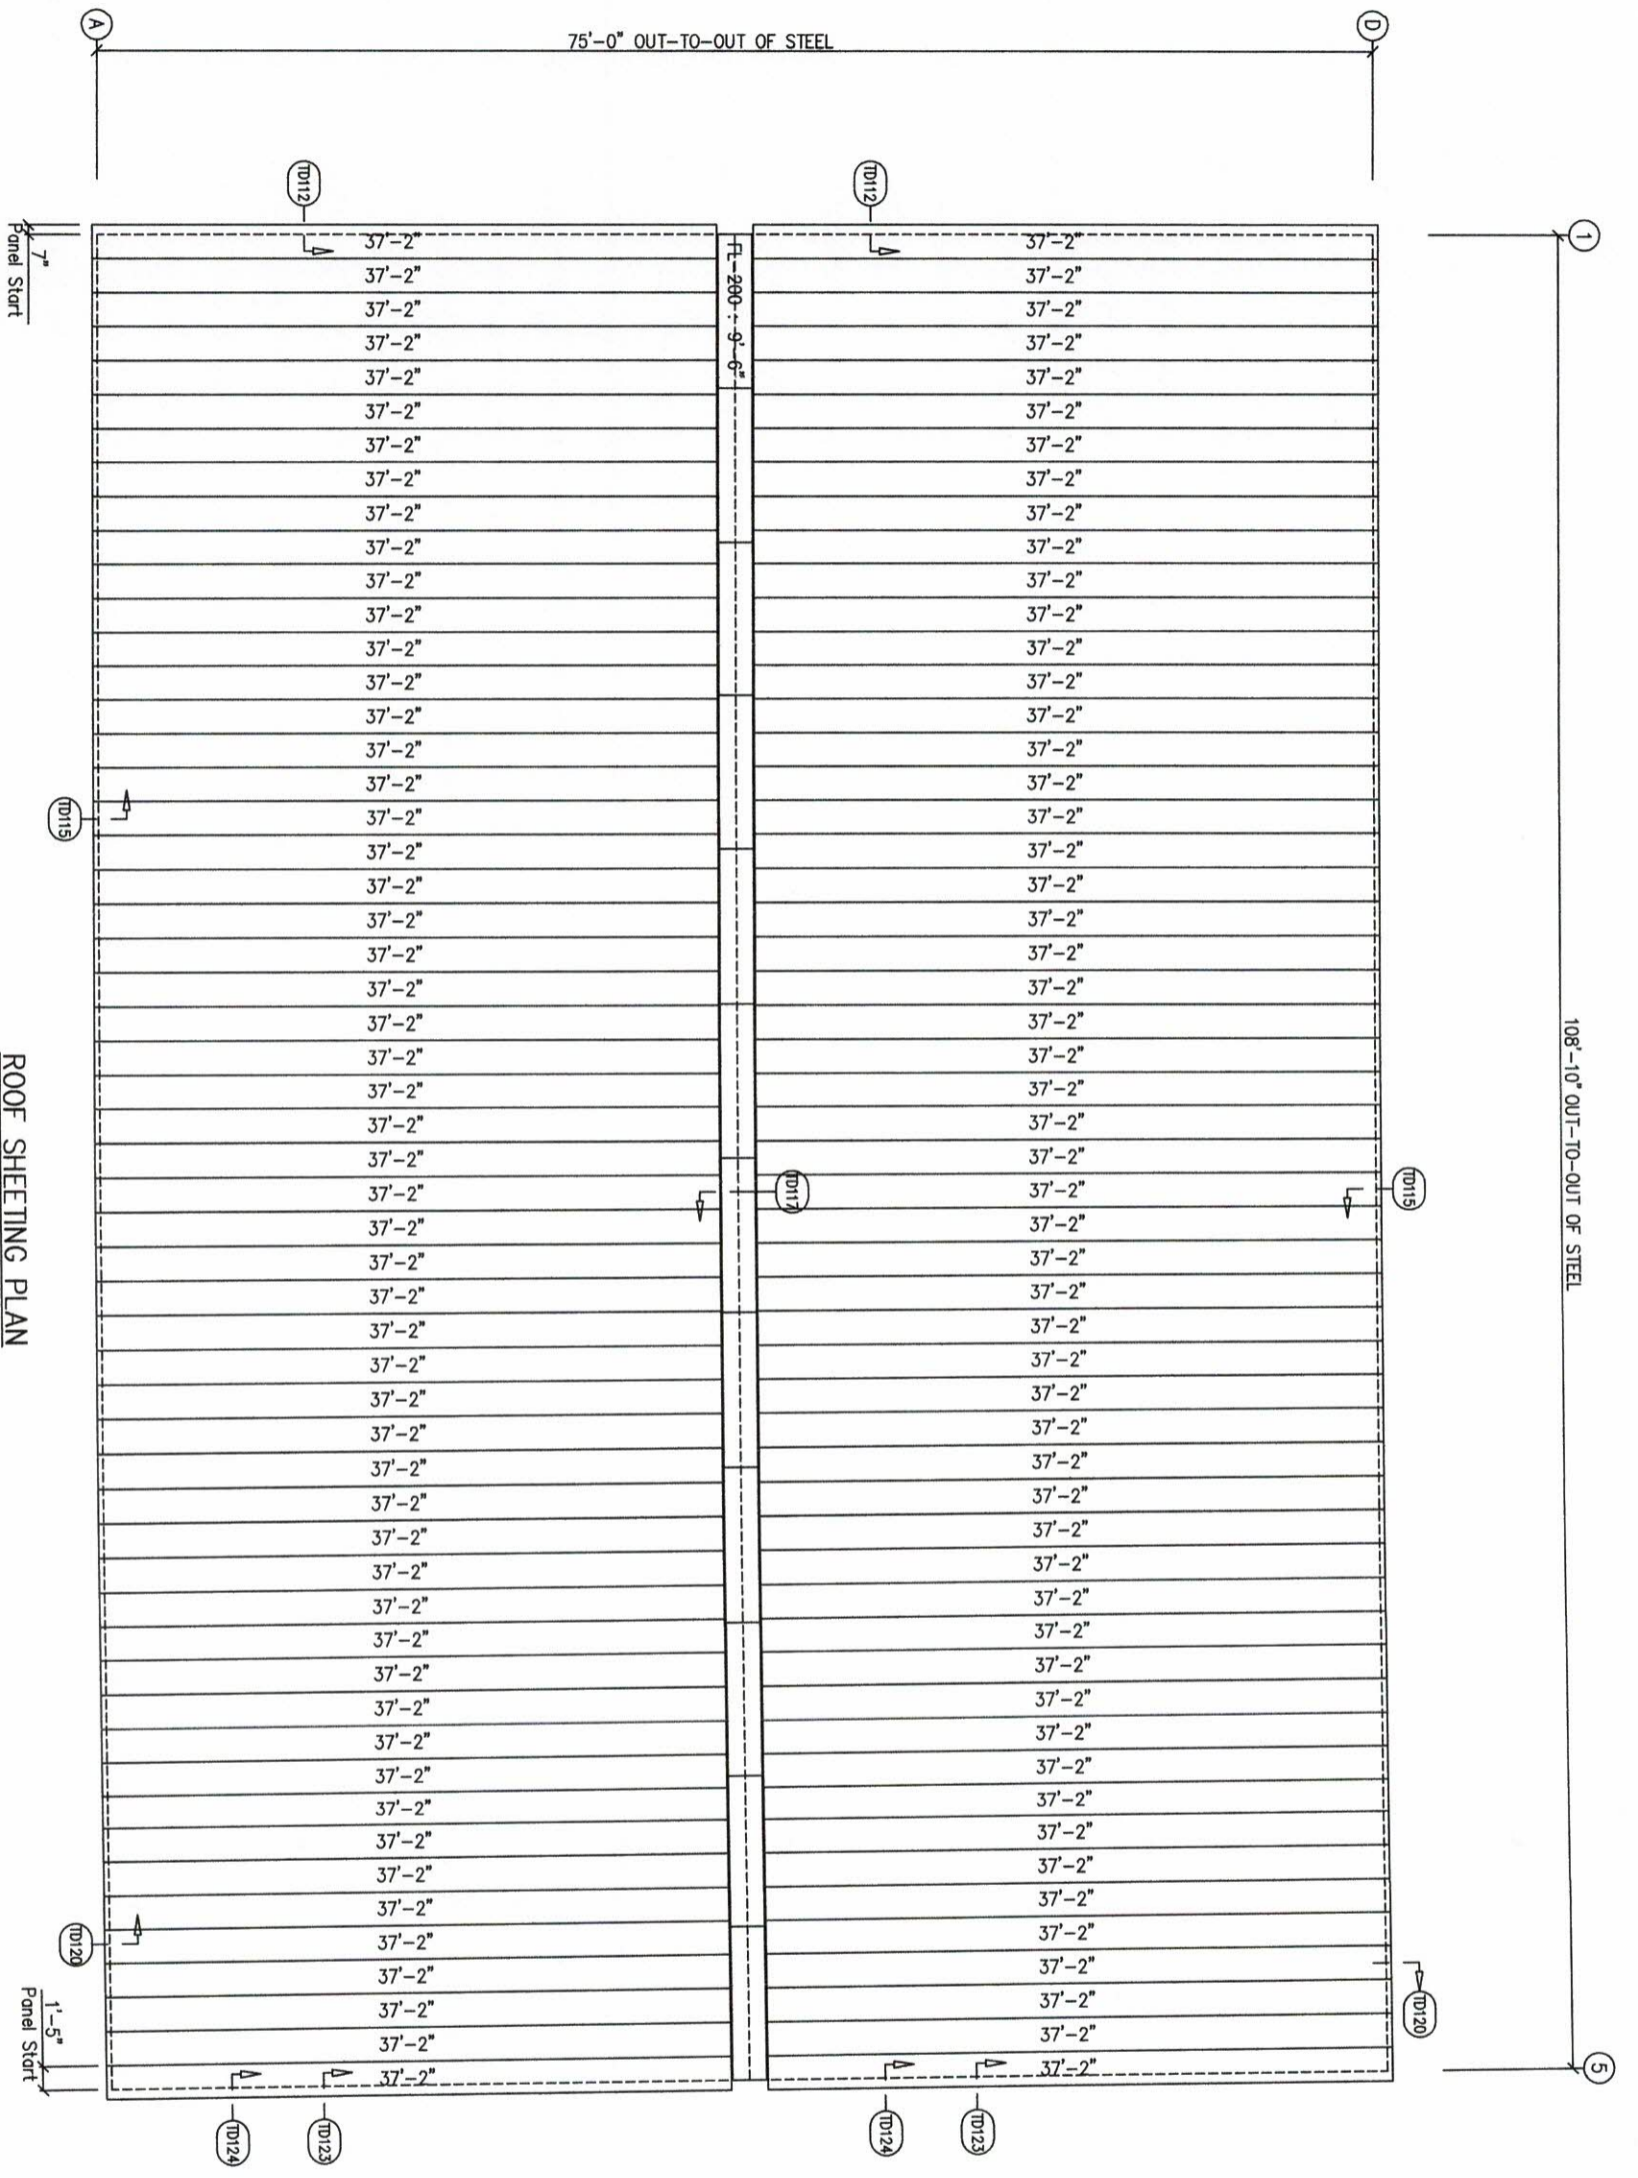


ROOF SHEETING PLAN
 PANELS: 24 Ga. TS-324 Color : Galvalume (UL-90)
 Triple-Lok seam is required.

DRAWING STATUS	
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<input type="checkbox"/>	FOR CONSTRUCTION: FINAL DRAWINGS.

NO.	DATE	REVISIONS	DESCRIPTION	BY	CHK'D
A	3/6/19	FOR PERMIT		WSC	DIY

SBS	SCHULTE BUILDING SYSTEMS
17000 Boulder Road - Hockley, Texas 77447	17000 Boulder Road - Hockley, Texas 77447
PHONE: 281.304.6111 877.257.2534	PHONE: 281.304.6111 877.257.2534
FAX: 281.304.6113	FAX: 281.304.6113
www.schultebuilding.com	www.schultebuilding.com
PROJECT: ROOF SHEETING	PROJECT: ROOF SHEETING
DATE: 3/4/19	DATE: 3/4/19
SCALE: N.T.S.	SCALE: N.T.S.
DRN: JSH	DRN: JSH
CHK: JSH	CHK: JSH
DATE: 3/4/19	DATE: 3/4/19
SCALE: N.T.S.	SCALE: N.T.S.
NO. 147388	NO. 147388
SHEET NO. 11	SHEET NO. 11
OF 11	OF 11

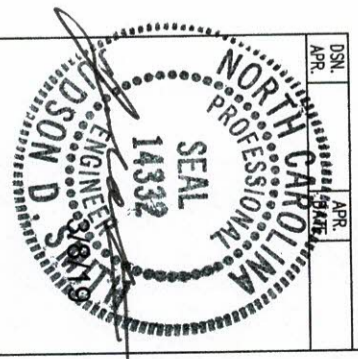


SPLICE PLATE & BOLT TABLE										
Mark	Qty	Top	Bot	Int	Type	Dia	Length	Width	Thick	Length
SP-1	4	4	4	2	A325	7/8"	2'-1 1/2"	8"	5/8"	2'-6 15/16"
SP-2	4	4	4	0	A325	3/4"	2'-1 1/2"	8"	1/2"	2'-2 7/8"

FLANGE BRACES: FBxx (1 or 2)
 xx=length(in)
 (1) One Side; (2) Two Sides
 B - 2X2X1/8

MEMBER TABLE						
Mark	Web Depth	Start/End	Thick	Web Plate	Length	Outside Flange
RF1-1	8'-7 24/0	0.188	204.2	27.4	8 x 1 1/4" x 229.8	
RF1-2	24.0/21.7	0.313	177.5	27.5	8 x 5/16" x 32.3	
	20.0/20.0	0.188	240.0	27.5	8 x 1 1/4" x 165.5	
		0.184	240.0	27.5	8 x 5/16" x 252.0	

CONNECTION PLATES	
<input type="checkbox"/>	Mark/Part
<input type="checkbox"/>	Q1-87
<input type="checkbox"/>	Q1-85

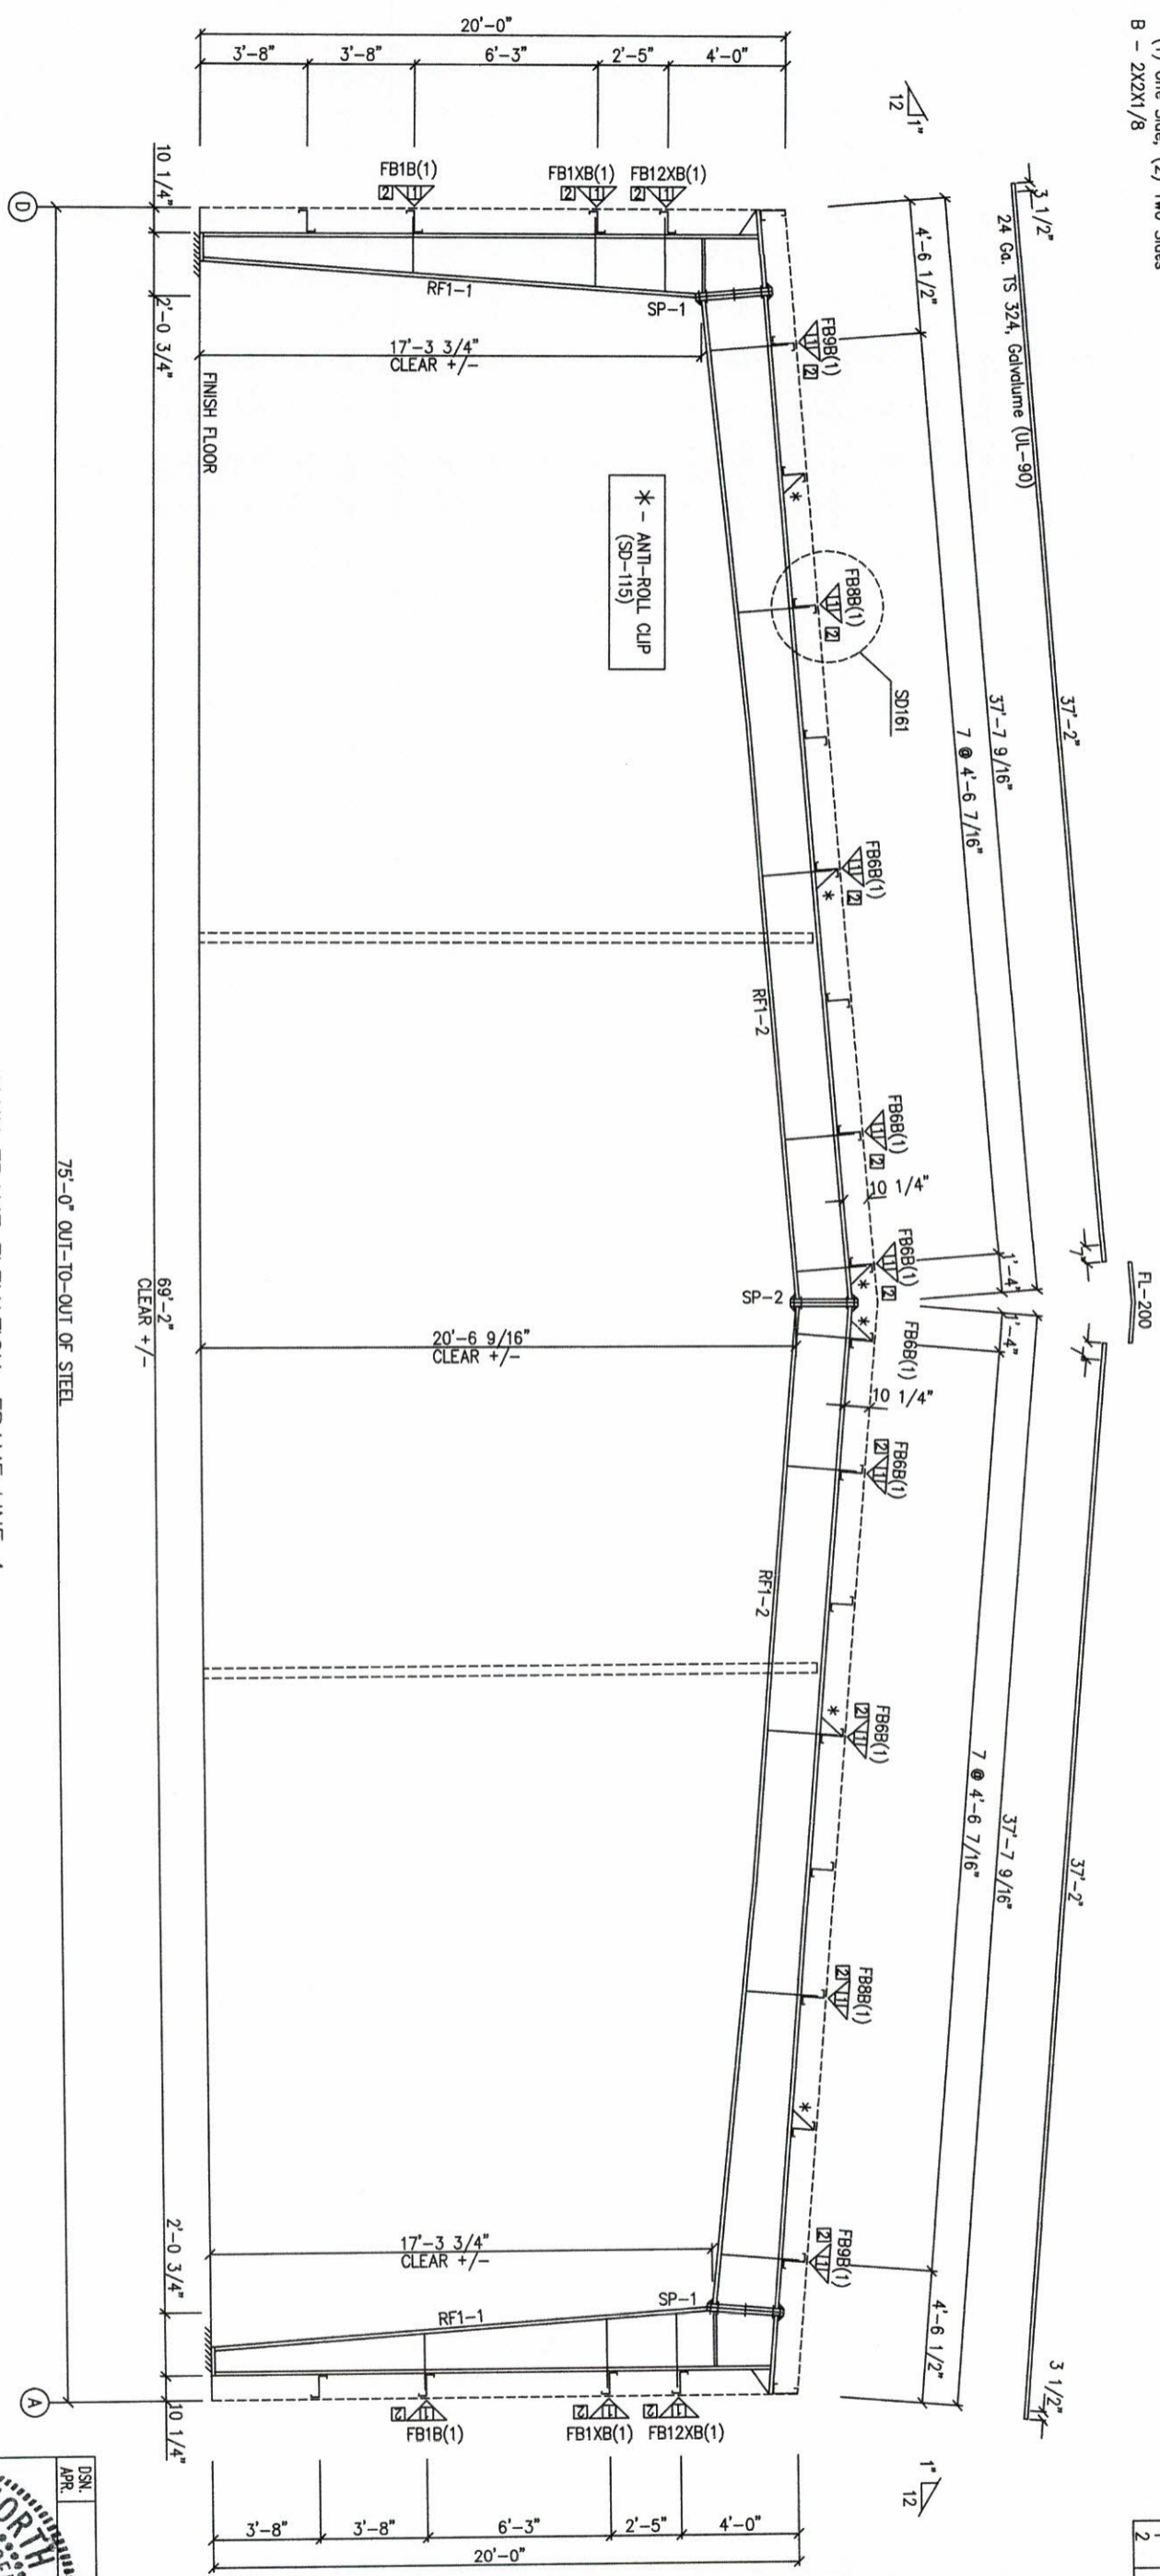

MAIN FRAME ELEVATION: FRAME LINE 4

GENERAL NOTES:
 SEE ROOF FRAMING PLAN AND SIDEWALL ELEVATIONS FOR MAIN FRAME PIECE MARKS.

DRAWING STATUS		
<input type="checkbox"/>	FOR APPROVAL	DATE
<input type="checkbox"/>	FOR PERMIT	DATE
<input checked="" type="checkbox"/>	FOR CONSTRUCTION	DATE


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 FAX: 281.304.6113
 www.SchulteBuildingSystems.com

DESIGNER	CHECKED	DATE	SCALE
RALEIGH, NC 27807	3/4/19	N.T.S.	

CUSTOMER: RILEY PIEDMONT DESIGN BUILDERS, LLC
 ADDRESS: 1400 SUNDAY DR., STE109
 RALEIGH, NC 27807
 SHEET NO. 147388
 OF 11 A




SPLICE PLATE & BOLT TABLE										
Mark	Qty	Top	Bot	Int	Type	Dia	Length	Width	Thick	Length
SP-1	4	4	4	2	A325	1"	2'-1 1/2"	10"	5/8"	2'-7 3/8"
SP-2	4	4	4	2	A325	3/4"	2	8"	1/2"	2'-6 7/8"

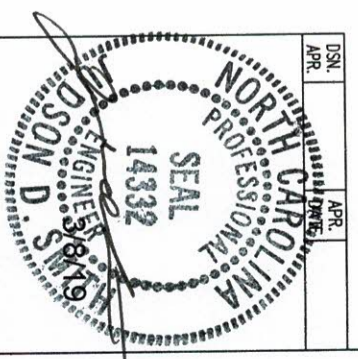FLANGE BRACES: FBxx (1 or 2)
 xx=length(in)
 (1) One Side; (2) Two Sides
 B - 2X2X1/8

MEMBER TABLE						
Mark	Web Depth	Start/End	Thick	Length	Web Plate	Outside Flange
RF3-1	10.0/24.0	0.188	203.9	10 x 5/16" x 229.8	10 x 5/16" x 204.4	
RF3-2	24.0/21.7	0.313	27.7	8 x 5/16" x 165.4	8 x 1/2" x 189.4	
	24.0/24.0	0.250	177.4	8 x 5/16" x 165.4	8 x 1/4" x 226.0	
	24.0/24.0	0.164	240.0	8 x 3/8" x 252.0		

CONNECTION PLATES	
1	Mark/Part
2	Q1-87
	Q1-85

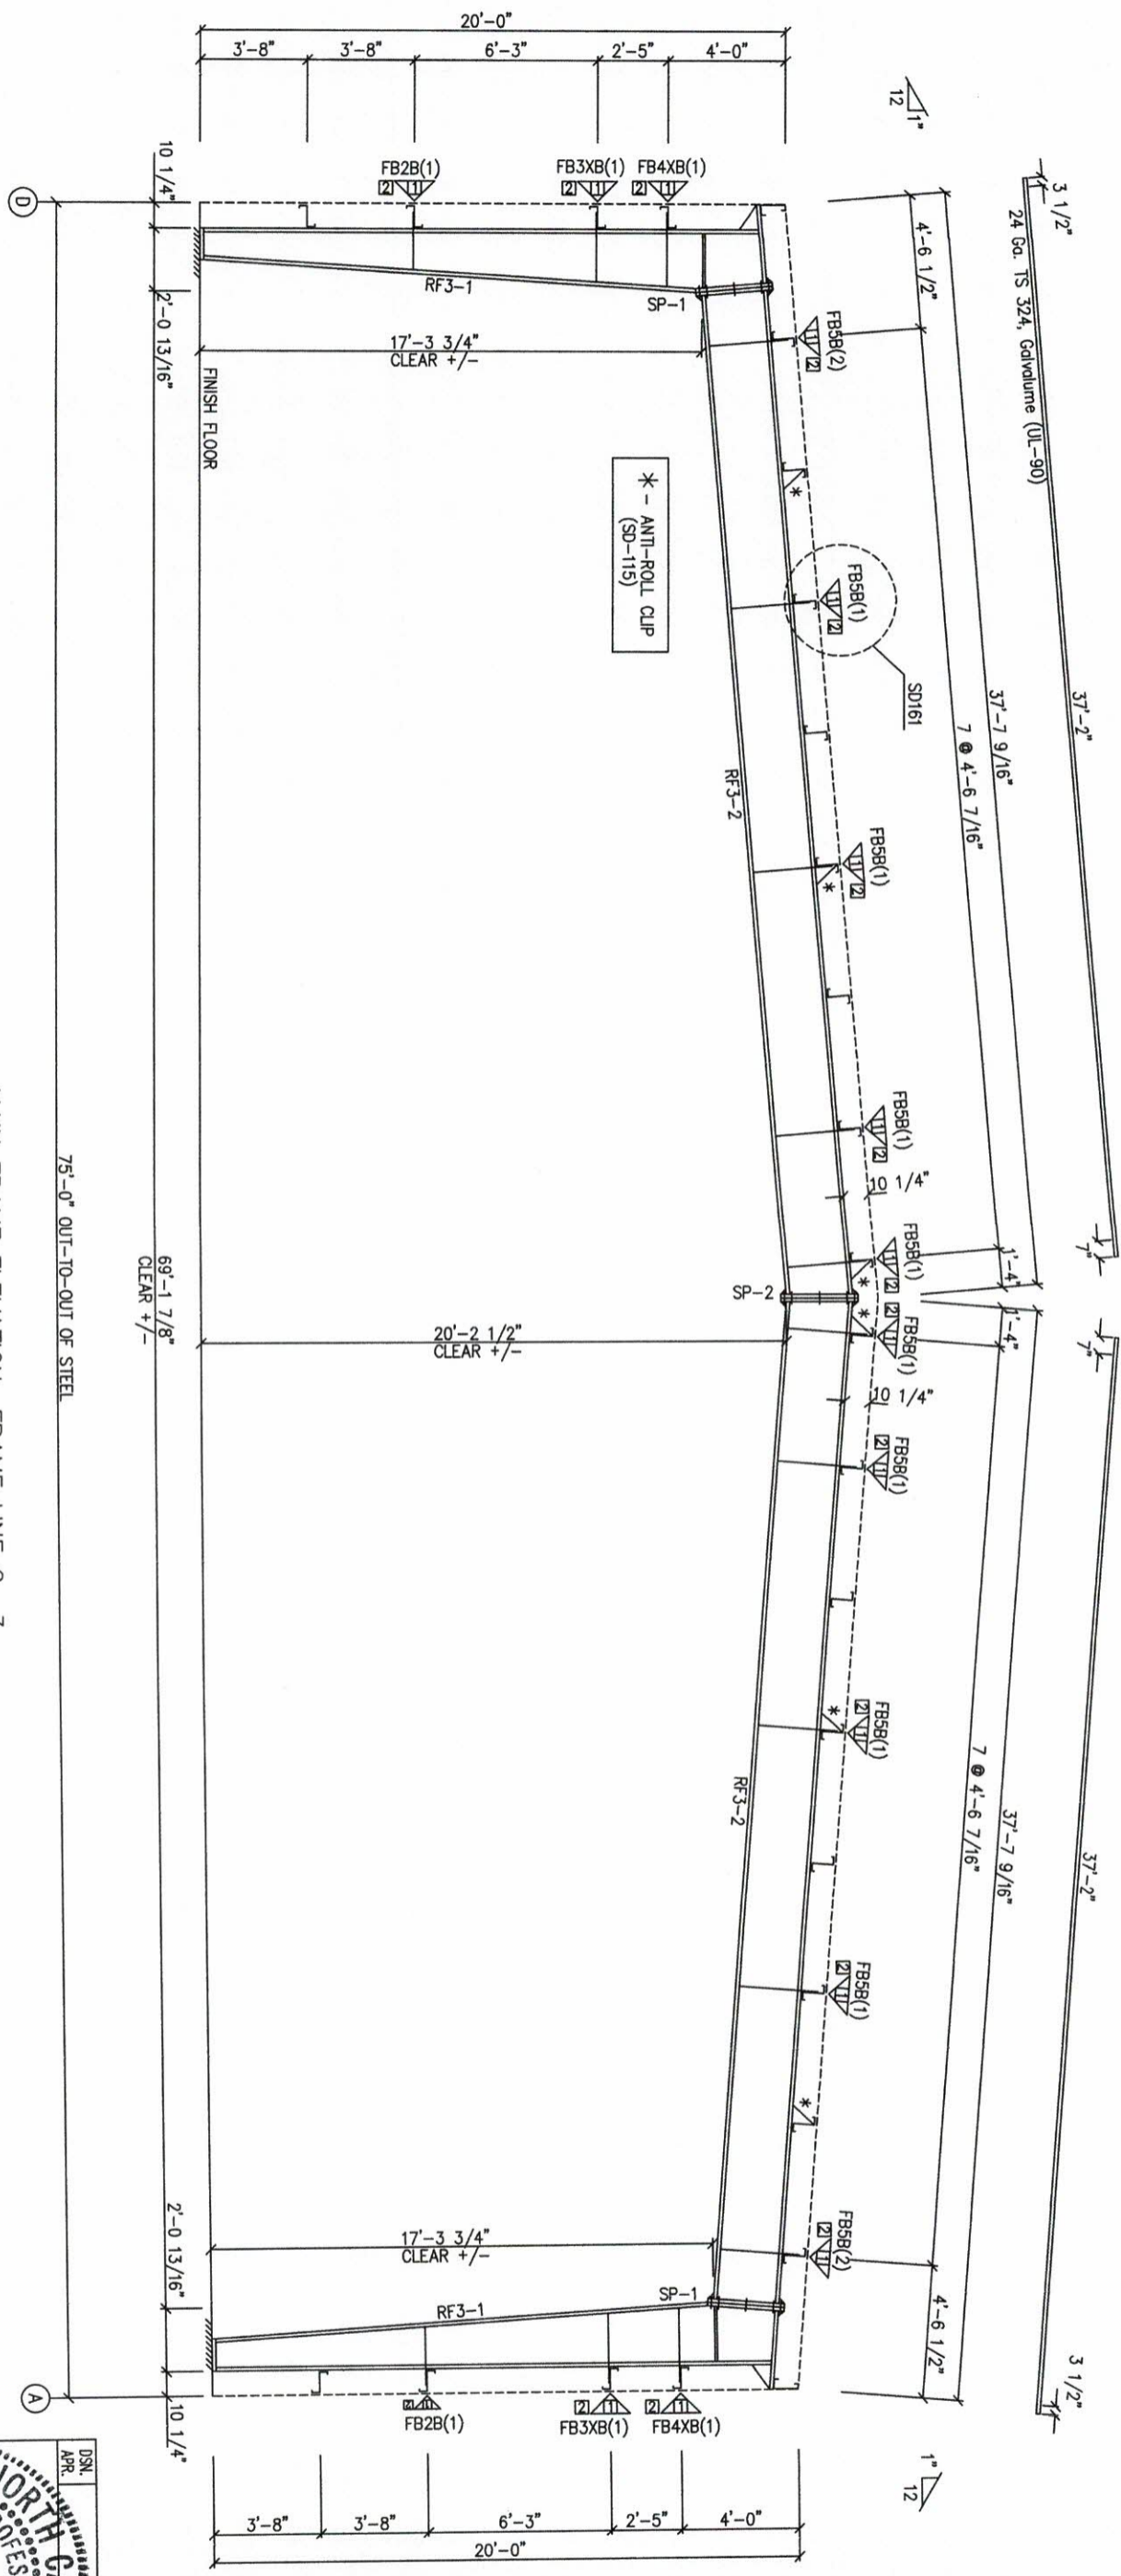

MAIN FRAME ELEVATION: FRAME LINE 2 3


GENERAL NOTES:
 SEE ROOF FRAMING PLAN AND SIDEWALL ELEVATIONS FOR MAIN FRAME PIECE MARKS.

DRAWING STATUS		
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<input type="checkbox"/>	FOR CONSTRUCTION	DATE

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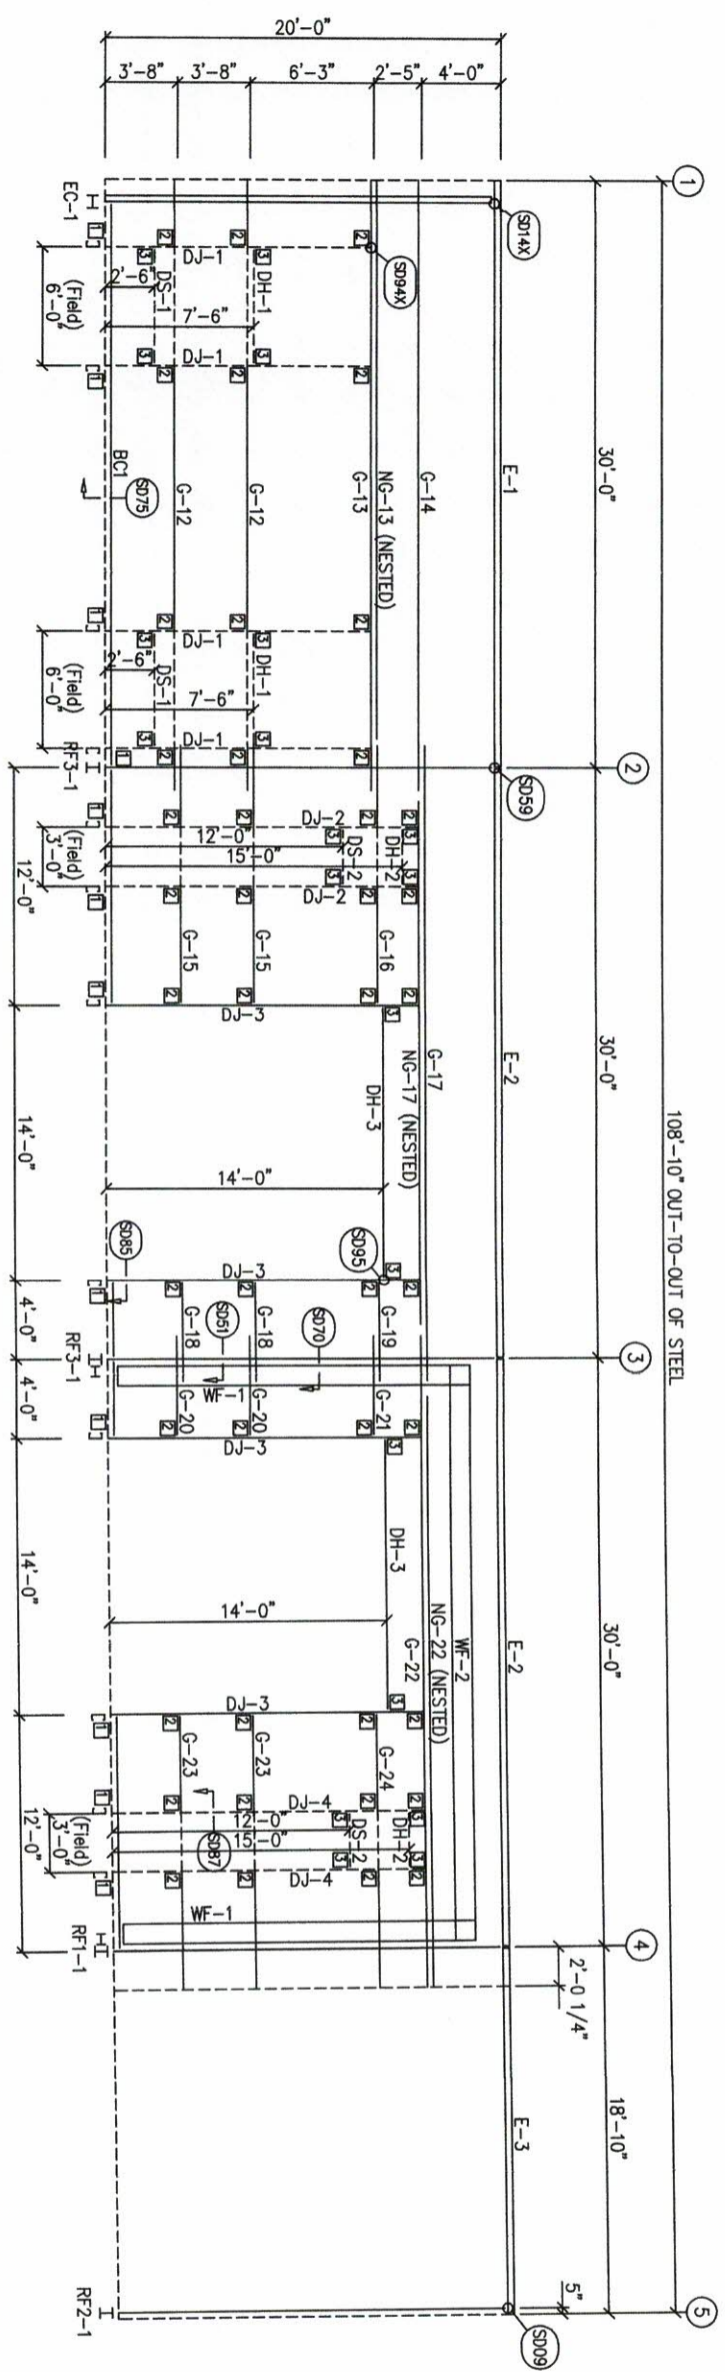


SBS SCHULTE BUILDING SYSTEMS
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 PHONE: 281.304.6111 877.257.2534
 FAX: 281.304.6113
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NO.	DATE	DESCRIPTION	BY	CHKD
A	3/7/19	FOR PERMIT		

FRAME LINE A	QUAN	TYPE	DIA	LENGTH
WF-1	8	A325	5/8"	2 1/2"
WF-2	10	A325	5/8"	1 1/2"
WF-3	10	A325	5/8"	1 1/2"


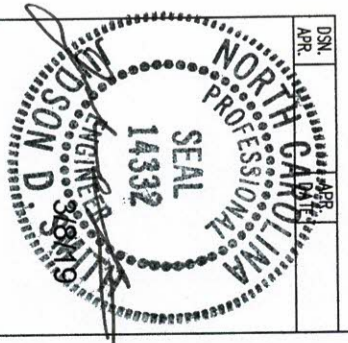
108'-10" OUT-TO-OUT OF STEEL



MEMBER TABLE	FRAME LINE A	PART
WF-1	W128x41	
WF-2	W128x41	
DJ-1	10X35C14	
DJ-2	10X35C12	
DJ-3	10X35C14	
DJ-4	10X35C14	
DH-1	10X35C16	
DH-2	10X35C16	
DH-3	10X35C16	
DS-1	10X35C16	
DS-2	10X35C16	
E-1	10E12	
E-2	10E12	
E-3	10E14	
G-12	10X35Z16	
G-13	10X35Z12	
G-14	10X35Z14	
G-15	10X35Z16	
G-16	10X35Z12	
G-17	10X35Z12	
NG-17	10X35Z12	
G-18	10X35Z16	
G-19	10X35Z12	
G-20	10X35Z12	
G-21	10X35Z14	
G-22	10X35Z12	
NG-22	10X35Z12	
G-23	10X35Z12	
G-24	10X35Z14	

CONNECTION PLATES	FRAME LINE A	MARK/PART
1	CL-104	
2	CL-103	
3	CL-100	

SIDEWALL FRAMING: FRAME LINE A

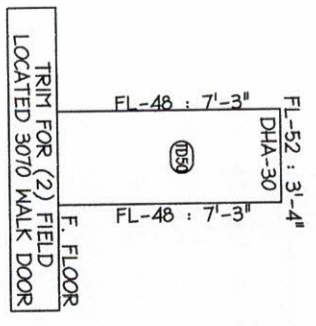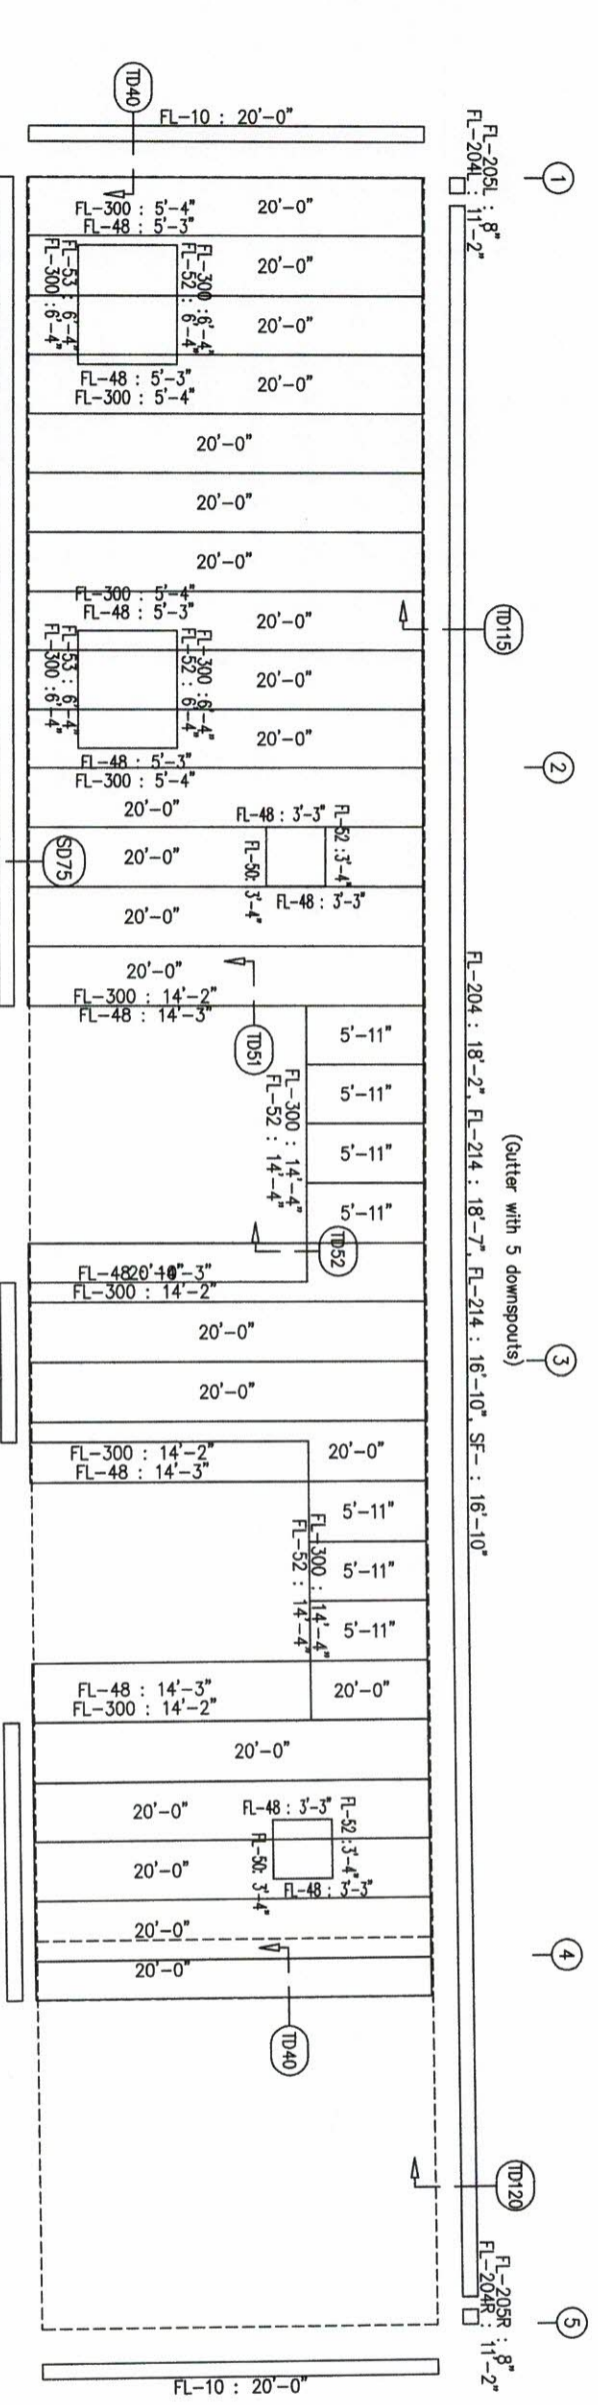

SIDEWALL SHEETING & TRIM: FRAME LINE A

PANELS: 26 Ga. PBR - Light Stone

GENERAL NOTES:
 TRIM IS FIGURED WITH 2" TRIM LAP UNLESS NOTED ON A DETAIL.
 FIELD CUT PANELS AT FRAMED OPENINGS, WALKDOORS, AND WINDOWS.
 FORMED BASE TRIM (IF USED) TO BE FIELD MITERED AT CORNERS.
 BEVEL CUT ENDWALL PANELS AS REQUIRED.
 FIELD SLOT GIRTS AS REQUIRED FOR CABLE BRACE CLEARANCE.

DRAWING STATUS

EOR APPROVAL, THESE DRAWINGS BEING FOR APPROVAL, ARE BY DEFINITION NOT FINAL, AND ARE FOR CONCEPTUAL REPRESENTATION ONLY. PERMIT DOCUMENTS, ONLY DRAWINGS ISSUED FOR CONSTRUCTION CAN BE CONSIDERED AS COMPLETE.
 EOR PERMIT, THESE DRAWINGS BEING FOR PERMIT ARE BY DEFINITION NOT FINAL, AND ARE FOR CONCEPTUAL REPRESENTATION ONLY. PERMIT DOCUMENTS, ONLY DRAWINGS ISSUED FOR CONSTRUCTION CAN BE CONSIDERED AS COMPLETE.
 EXH. CONSTRUCTION, EXH. DRAWINGS.

NO.	DATE	REVISIONS	DESCRIPTION	BY	CHK'D
A	3/6/19		FOR PERMIT	MSC/DV	

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 17800 Boodle Road - Humble, Texas 77447
 PHONE: 281.304.6111 877.257.2534
 FAX: 281.304.6113
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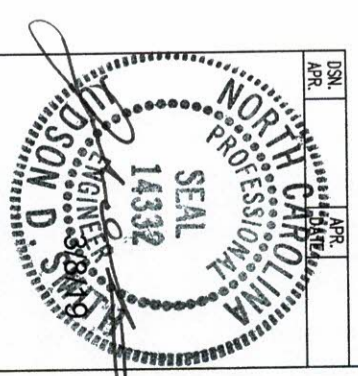
SBS SCHULTE BUILDING SYSTEMS

DESIGNER: RUBY PEDINI DESIGN BUILDERS, LLC
 ADDRESS: 1400 SANDY DR., STE 109
 RALEIGH, NC 27607
 PHONE: 919.881.1111
 FAX: 919.881.1111

PROJECT: GOOD HAULING
 LOCATION: FLOQUAY VARIAN, NC 27526
 DATE: 3/4/19
 N.T.S.

DRAWN BY: JBH
 CHECKED BY: JBH
 DATE: 3/4/19
 N.T.S.


28 NC REG. NO. 147398
 SHEET NO. 14
 OF 11




FRAME LINE D	QUAN	TYPE	DIA	LENGTH
WF-1	8	A325	3/8"	2 1/2"
WF-1	10	A325	5/8"	1 1/2"
WF-1	10	A325	5/8"	1 1/2"

MEMBER TABLE	FRAME LINE D	PART
WF-1	WF-1	W12x41
WF-2	WF-2	W12x41
DJ-1	DJ-1	10X35C14
DJ-2	DJ-2	10X35C14
DJ-3	DJ-3	10X35C16
DJ-4	DJ-4	10X35C16
DH-1	DH-1	10X35C16
DH-2	DH-2	10X35C16
DH-3	DH-3	10X35C16
DS-1	DS-1	10X35C16
DS-2	DS-2	10X35C16
E-2	E-2	10E12
E-4	E-4	10E14
E-5	E-5	10E12
G-12	G-12	10X35Z16
G-13	G-13	10X35Z12
G-14	G-14	10X35Z14
G-15	G-15	10X35Z16
G-16	G-16	10X35Z12
G-25	G-25	10X35Z12
G-26	G-26	10X35Z12
G-27	G-27	10X35Z12
G-28	G-28	10X35Z16
G-29	G-29	10X35Z12

CONNECTION PLATES	FRAME LINE D	MARK/PART
1	CL-104	
2	CL-103	
3	CL-100	

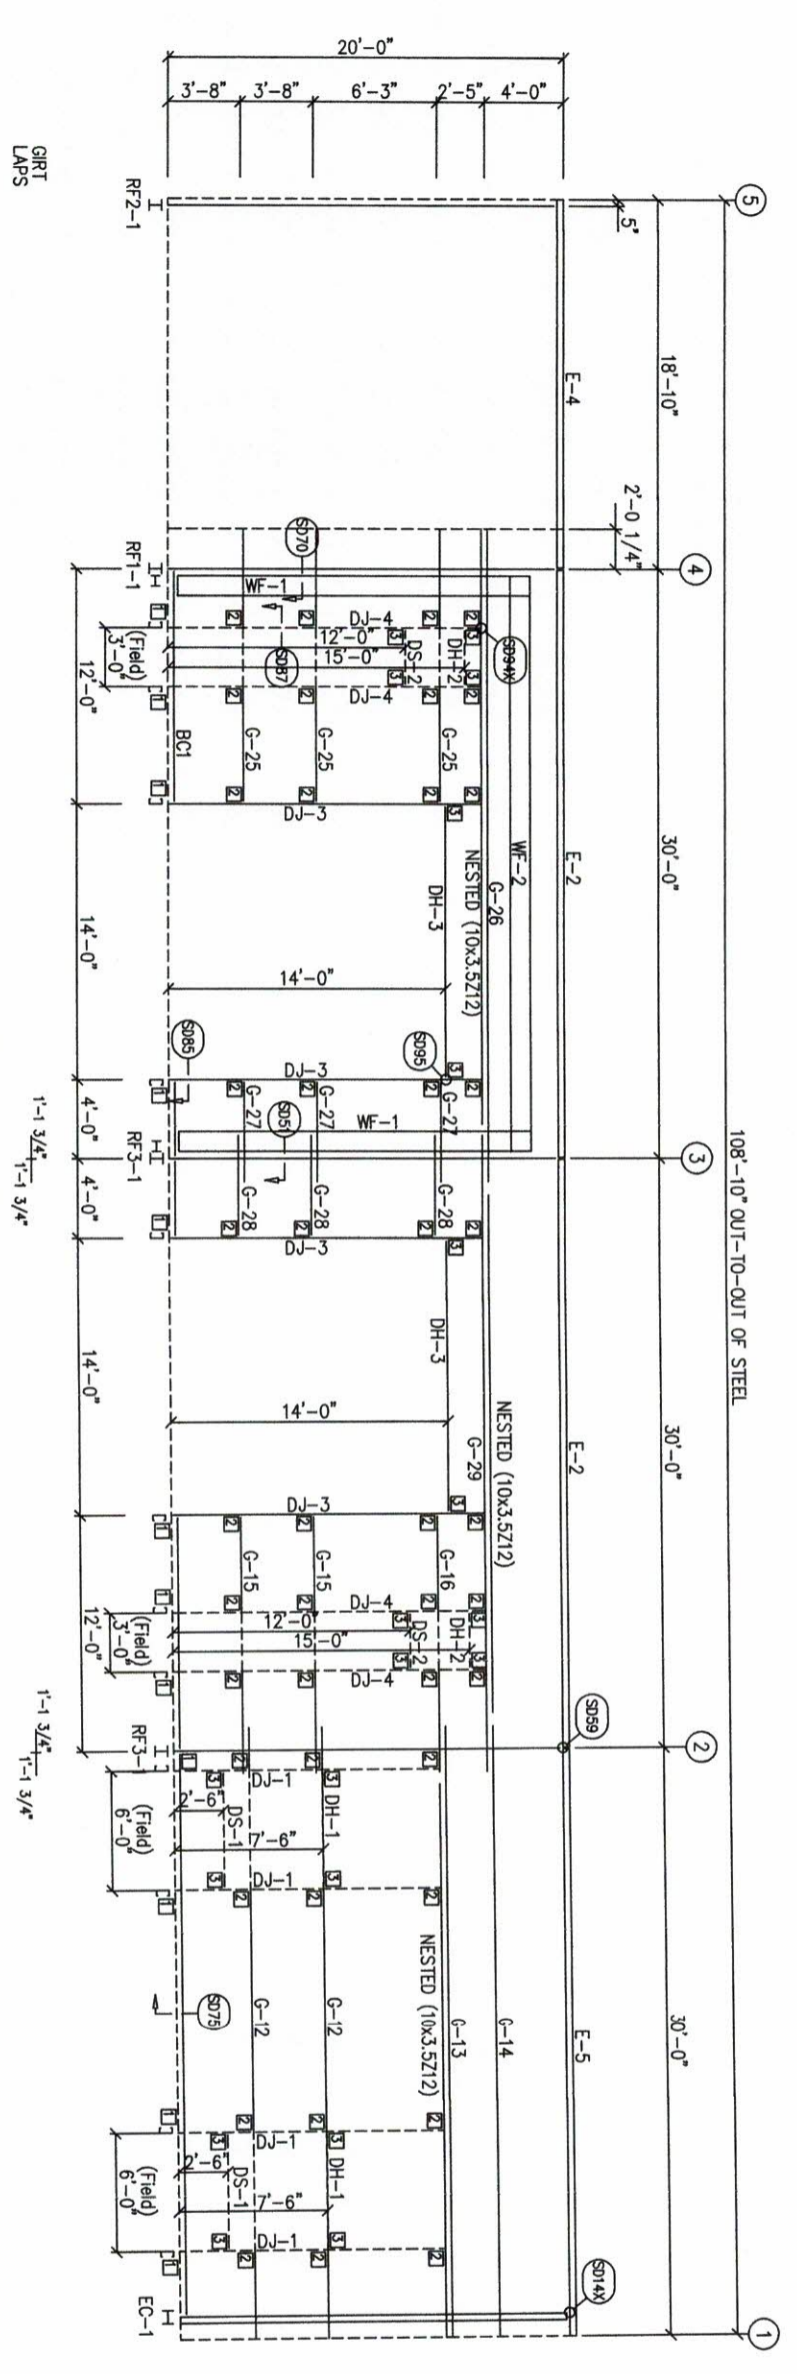


SIDEWALL FRAMING: FRAME LINE D

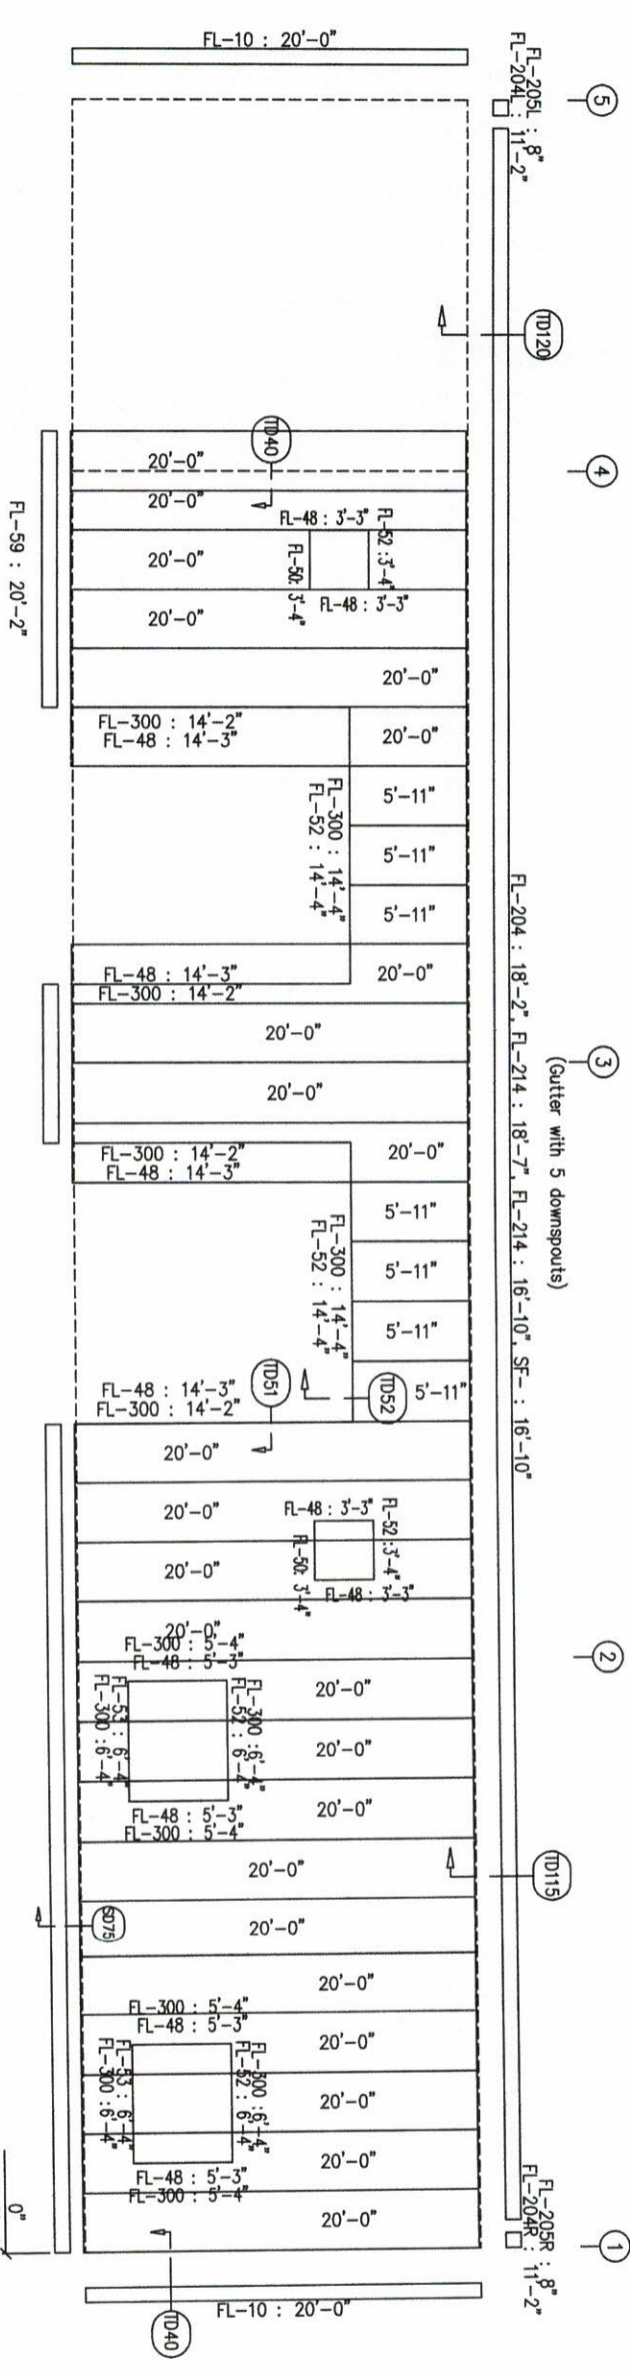

SIDEWALL SHEETING & TRIM: FRAME LINE D

PANELS: 26 Ga. PBR - Light Stone

TRIM FOR (2) FIELD LOCATED 30/10 WALK DOOR

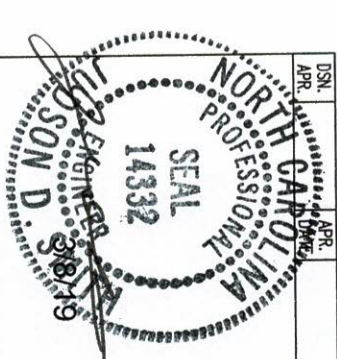

GENERAL NOTES:
TRIM IS FIGURED WITH 2" TRIM LAP UNLESS NOTED ON A DETAIL.
FIELD CUT PANELS AT FRAMED OPENINGS, WALKDOORS, AND WINDOWS.
FORMED BASE TRIM (IF USED) TO BE FIELD WATERED AT CORNERS.
BEVEL CUT ENDWALL PANELS AS REQUIRED.
FIELD SLOT GRITS AS REQUIRED FOR CABLE BRACE CLEARANCE.

DRAWING STATUS	
<input type="checkbox"/>	FOR APPROVAL
<input type="checkbox"/>	FOR CONSTRUCTION
<input checked="" type="checkbox"/>	FINAL

NO.	DATE	DESCRIPTION	BY	CHKD
A	3/6/19	FOR PERMIT	WSC/DV	

SCHULTE BUILDING SYSTEMS
17600 Red Oak Road - Houston, Texas 77047
PHONE: 281.304.6111 877.257.2534
FAX: 281.304.6113


SBS
SBS ENGINEERS
147398

PROJECT: GARD HALLING DRIVE
ADDRESS: 1400 SANDWAY DR, STE 109
Raleigh, NC 27607


DATE: 3/4/19
SCALE: N.T.S.

DESIGNER: REFER TO C1
CHECKED: RALPH PERINI DESIGN BUILDERS, LLC
DATE: 3/4/19
SCALE: N.T.S.

* - ANTI-ROLL CLIP
(SD-115)

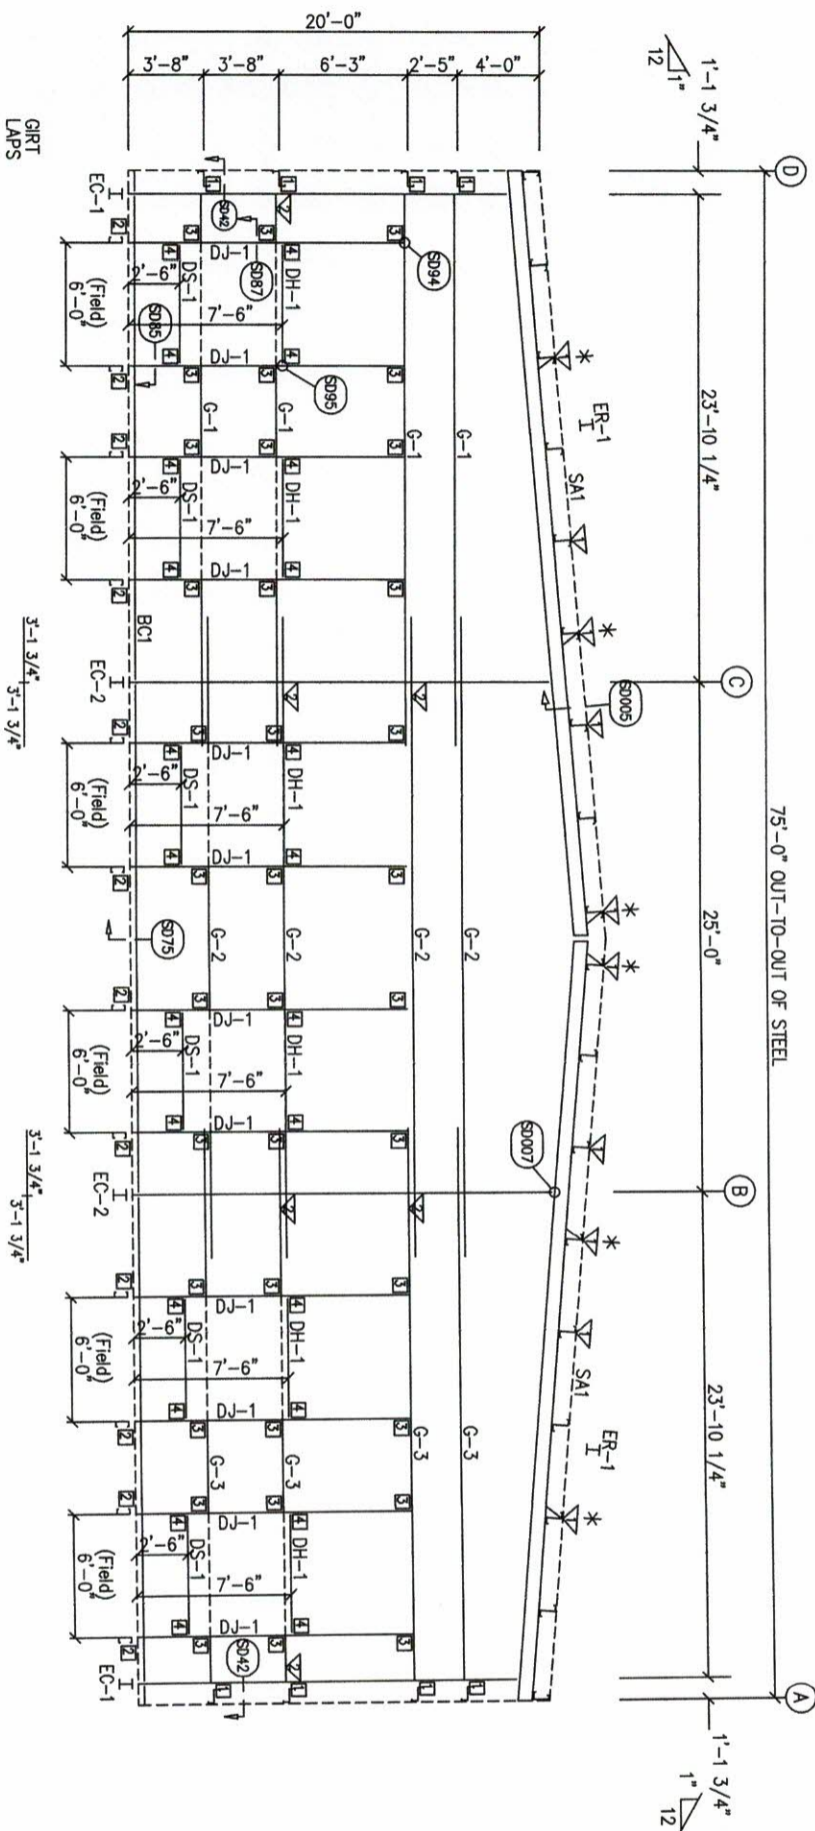


ENDWALL FRAMING: FRAME LINE 1

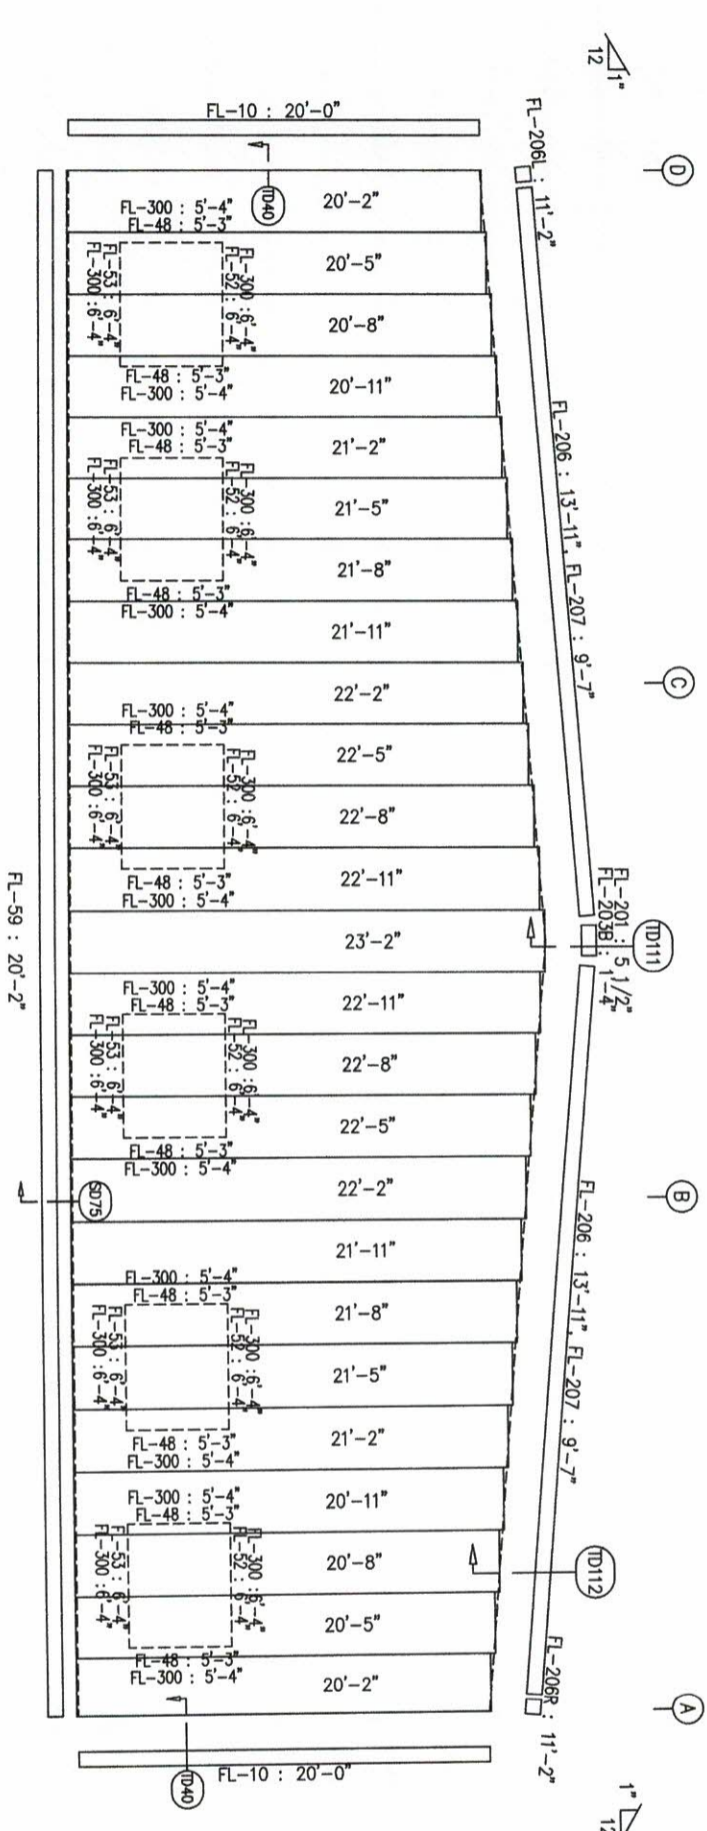

ENDWALL SHEETING & TRIM: FRAME LINE 1

PANELS: 26 Ga. PBR - Light Stone

GENERAL NOTES:
TRIM IS FIGURED WITH 2" TRIM LAP UNLESS NOTED ON A DETAIL.
FIELD CUT PANELS AT FRAMED OPENINGS, WALKDOORS, AND WINDOWS.
FORMED BASE TRIM (IF USED) TO BE FIELD MITERED AT CORNERS.
BEVEL CUT ENDWALL PANELS AS REQUIRED.
FIELD SLOT GIRTS AS REQUIRED FOR CABLE BRACE CLEARANCE.

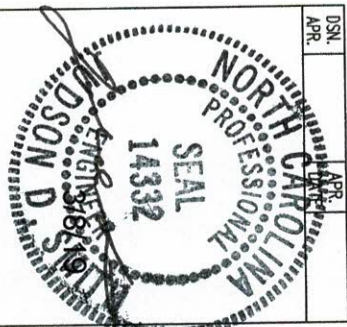

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SBS SCALE MODEL SYSTEMS




DESCRIPTION: ENDWALL ELEVATION
PROJECT: GARD HALLING
OWNER: RALPH PERINI DESIGN BUILDERS, LLC
ADDRESS: 1400 SANDWAY DR, STE 102
FLOUQUAY VARIANA, NC 27526
DATE: 3/4/19 N.T.S.
SCALE: 3/4" = 1'-0"
SHEET NO: 147288
DATE: 3/4/19 N.T.S.

BOLT TABLE	FRAME LINE 4	QUAN	TYPE	DIA	LENGTH
LOCATION	Columns/Ref	10	A325	3/8"	1 1/4"

FLANGE BRACE TABLE	FRAME LINE 4	LENGTH
V/D MARK	CL-103	2-9 1/4"
FBSA	CL-100	2-9 1/4"

CONNECTION PLATES	FRAME LINE 4
V/D MARK/PART	CL-103
CL MARK/PART	CL-100







MEMBER TABLE	FRAME LINE 4	PART
MARK	W10X15	W10X15
EC-3	10X35C14	10X35C14
DJ-5	10X25C16	10X25C16
DH-4	10X25Z14	10X25Z14
G-2	10X25Z14	10X25Z14
G-4	10X25Z14	10X25Z14
G-5	10X25Z14	10X25Z14
G-6	10X25Z14	10X25Z14
G-7	10X25Z14	10X25Z14
G-8	10X25Z14	10X25Z14

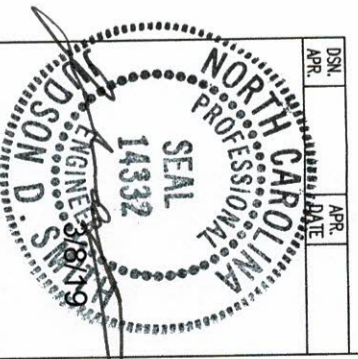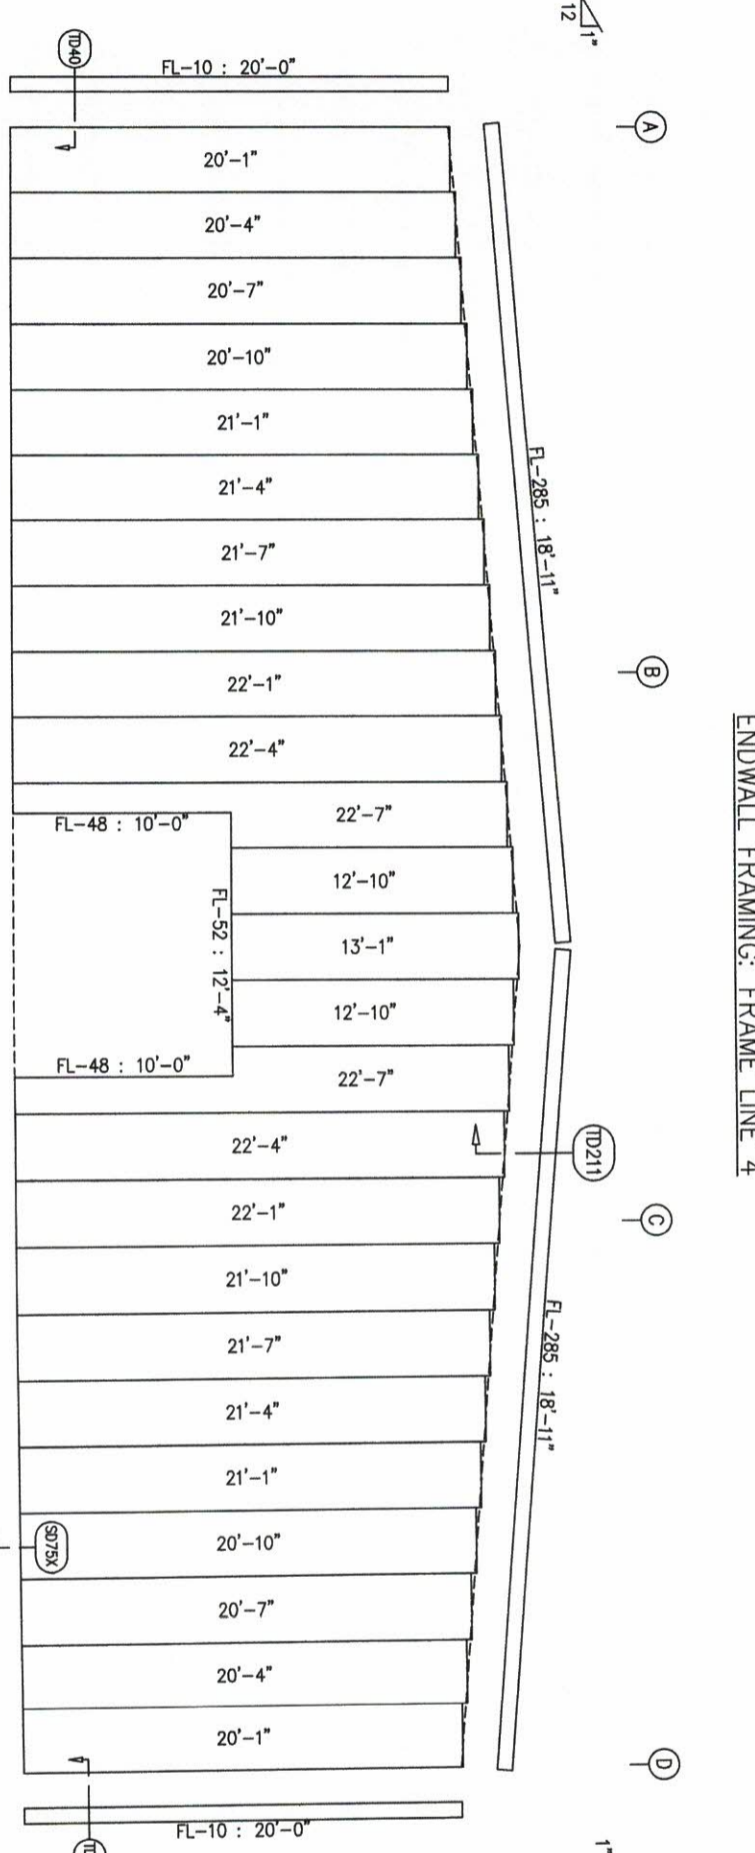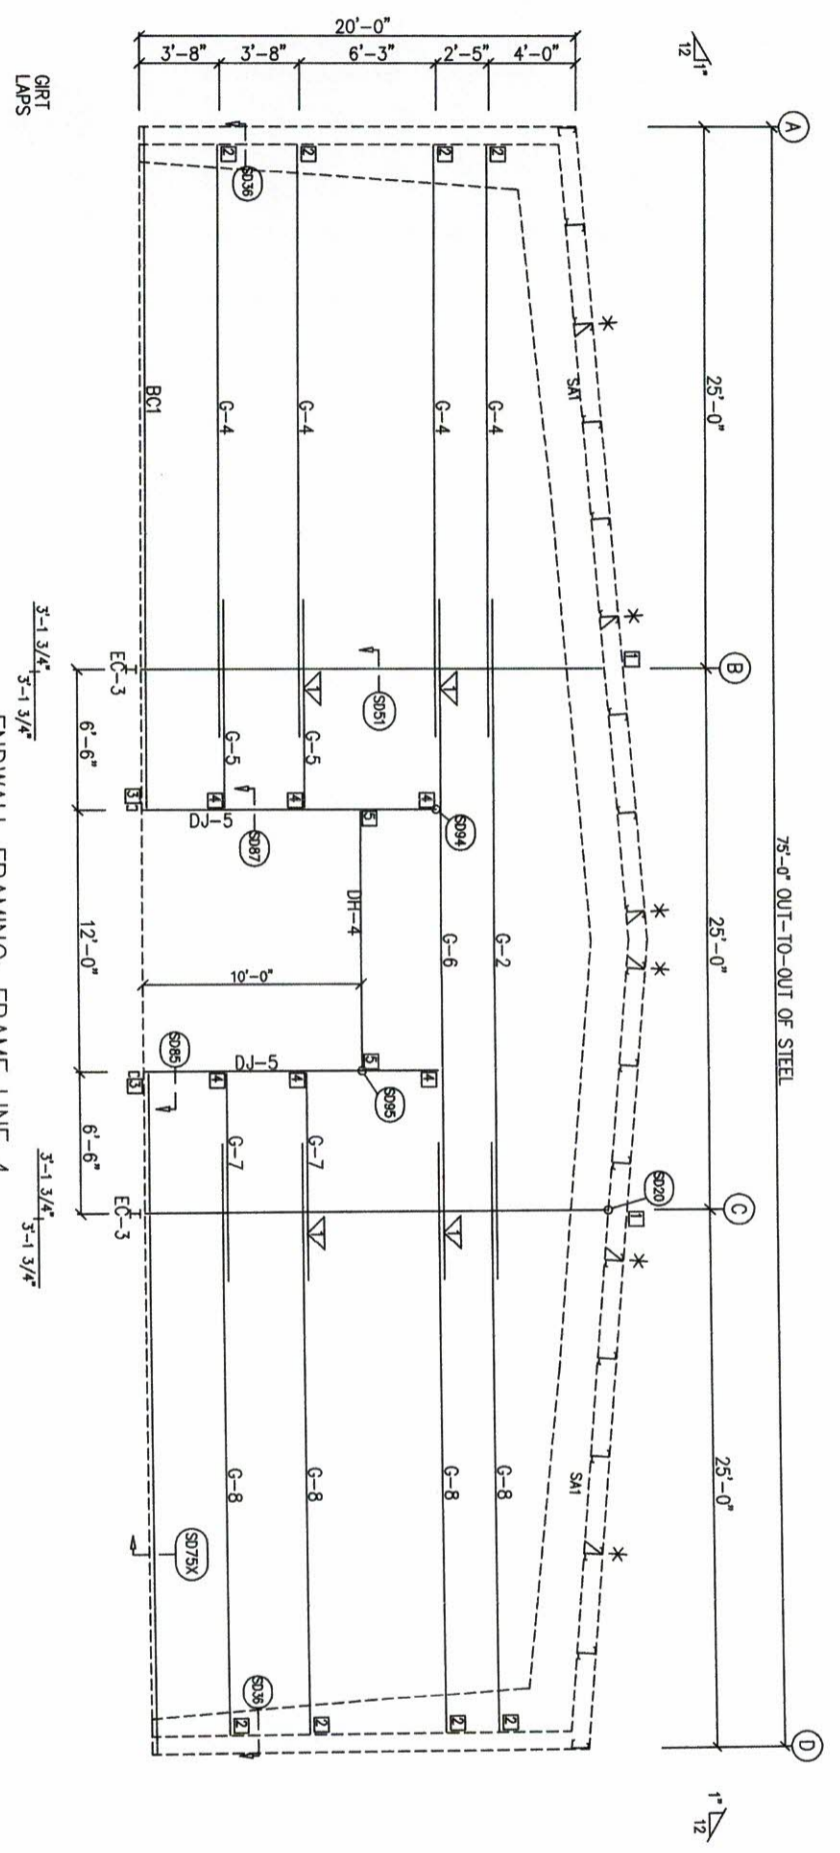

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DRAWING STATUS		REVISIONS	
NO.	DATE	DESCRIPTION	BY
A	3/6/19	FOR PERMIT	MSJ/DV

GENERAL NOTES:
 TRIM IS FIGURED WITH 2" TRIM LAP UNLESS NOTED ON A DETAIL.
 FIELD CUT PANELS AT FRAMED OPENINGS, WALKDOORS, AND WINDOWS.
 FORMED BASE TRIM (IF USED) TO BE FIELD MITERED AT CORNERS.
 BEVEL CUT ENDWALL PANELS AS REQUIRED.
 FIELD SLOT GIRTS AS REQUIRED FOR CABLE BRACE CLEARANCE.

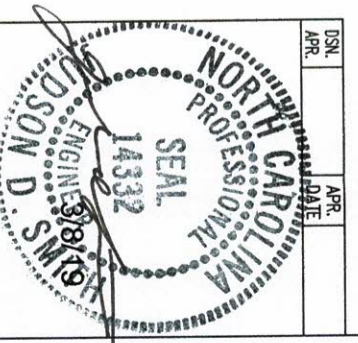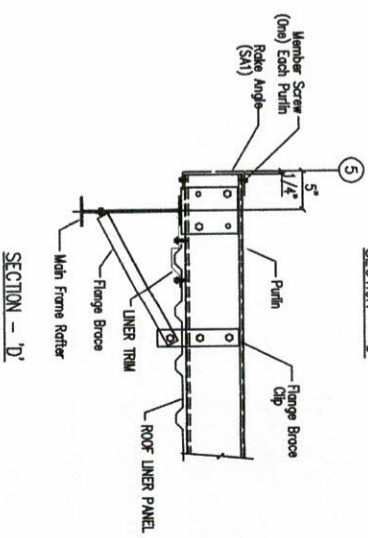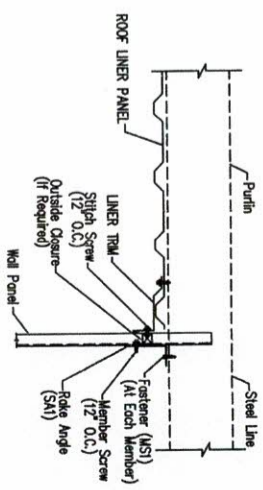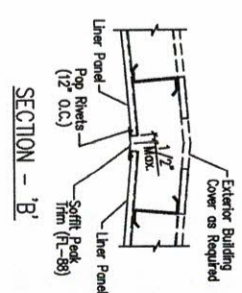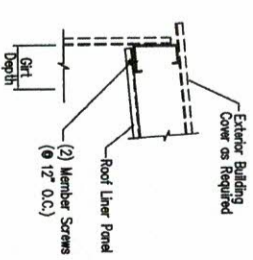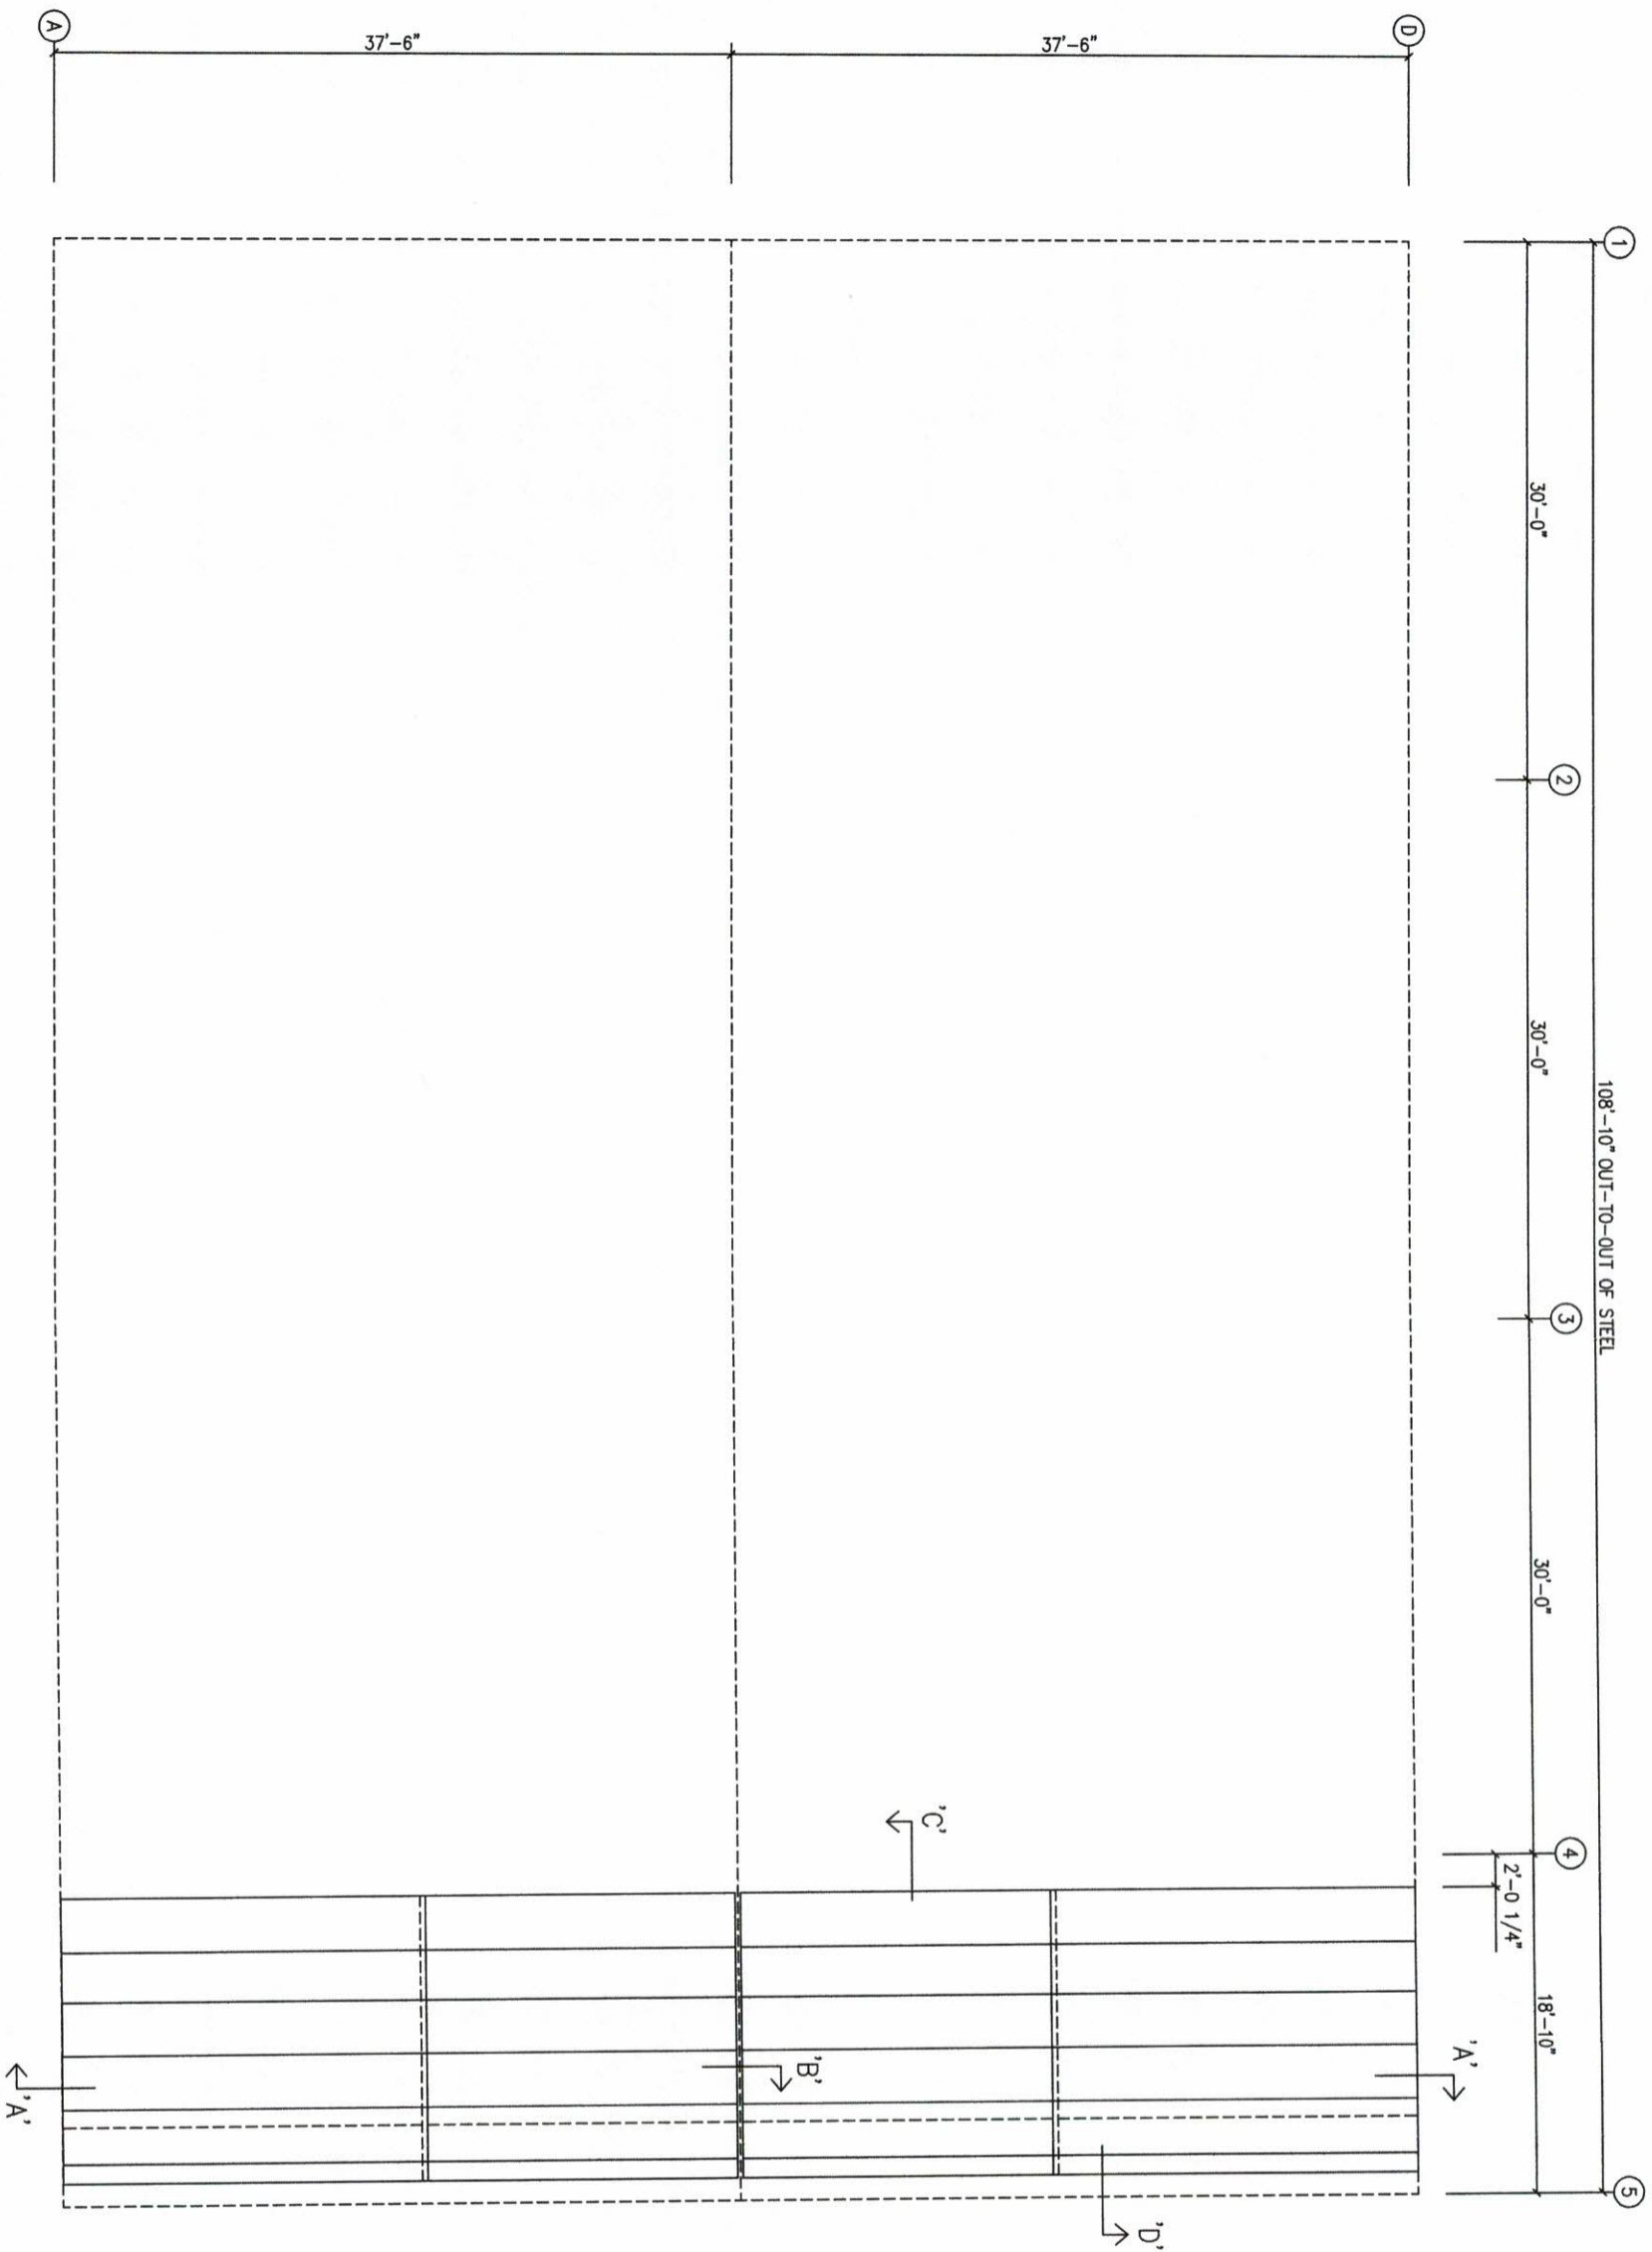

ROOF LINER SHEETING PLAN
 PANELS: 26 Ga. U - Commodity White

DRAWING STATUS

EBR APPROVAL. THESE DRAWINGS, BEING FOR APPROVAL, ARE BY DEFINITION NOT FINAL, AND ARE FOR CONCEPTUAL REPRESENTATION OF A PROJECT. ONLY DRAWINGS ISSUED FOR CONSTRUCTION CAN BE CONSIDERED AS COMPLETE.

FOR PERMIT. THESE DRAWINGS, BEING FOR PERMIT, ARE BY DEFINITION NOT FINAL, AND ARE FOR CONCEPTUAL REPRESENTATION OF A PROJECT. ONLY DRAWINGS ISSUED FOR CONSTRUCTION CAN BE CONSIDERED AS COMPLETE.


FOR CONSTRUCTION. THESE DRAWINGS, BEING FOR CONSTRUCTION, ARE BY DEFINITION NOT FINAL, AND ARE FOR CONCEPTUAL REPRESENTATION OF A PROJECT. ONLY DRAWINGS ISSUED FOR CONSTRUCTION CAN BE CONSIDERED AS COMPLETE.

NO.	DATE	REVISIONS	BY	CHKD
A	3/6/19	FOR PERMIT	WSC/DIV	


SCHULTE BUILDING SYSTEMS
 17800 Badley Road - Hockley, Texas 77447
 PHONE: 281.304.6111 877.257.2534
 FAX: 281.304.6113
 www.schultebuilding.com

PROJECT: ROOF LINER
CLIENT: GAD HAULING
LOCATION: 7780 YARCO DRIVE
 FLOUJAY VARIANA, NC 27526
DATE: 3/4/19 N.T.S.
SCALE:
DESIGNER: RUTY PREDM DESIGN BUILDERS, LLC
ADDRESS: 1400 SUNDAY DR, STE109
 RALEIGH, NC 27607
PH: 919.488.1473
SCALE: E10 of 11
ISSUE: A

* - ANTI-ROLL CLIP (SD-115)

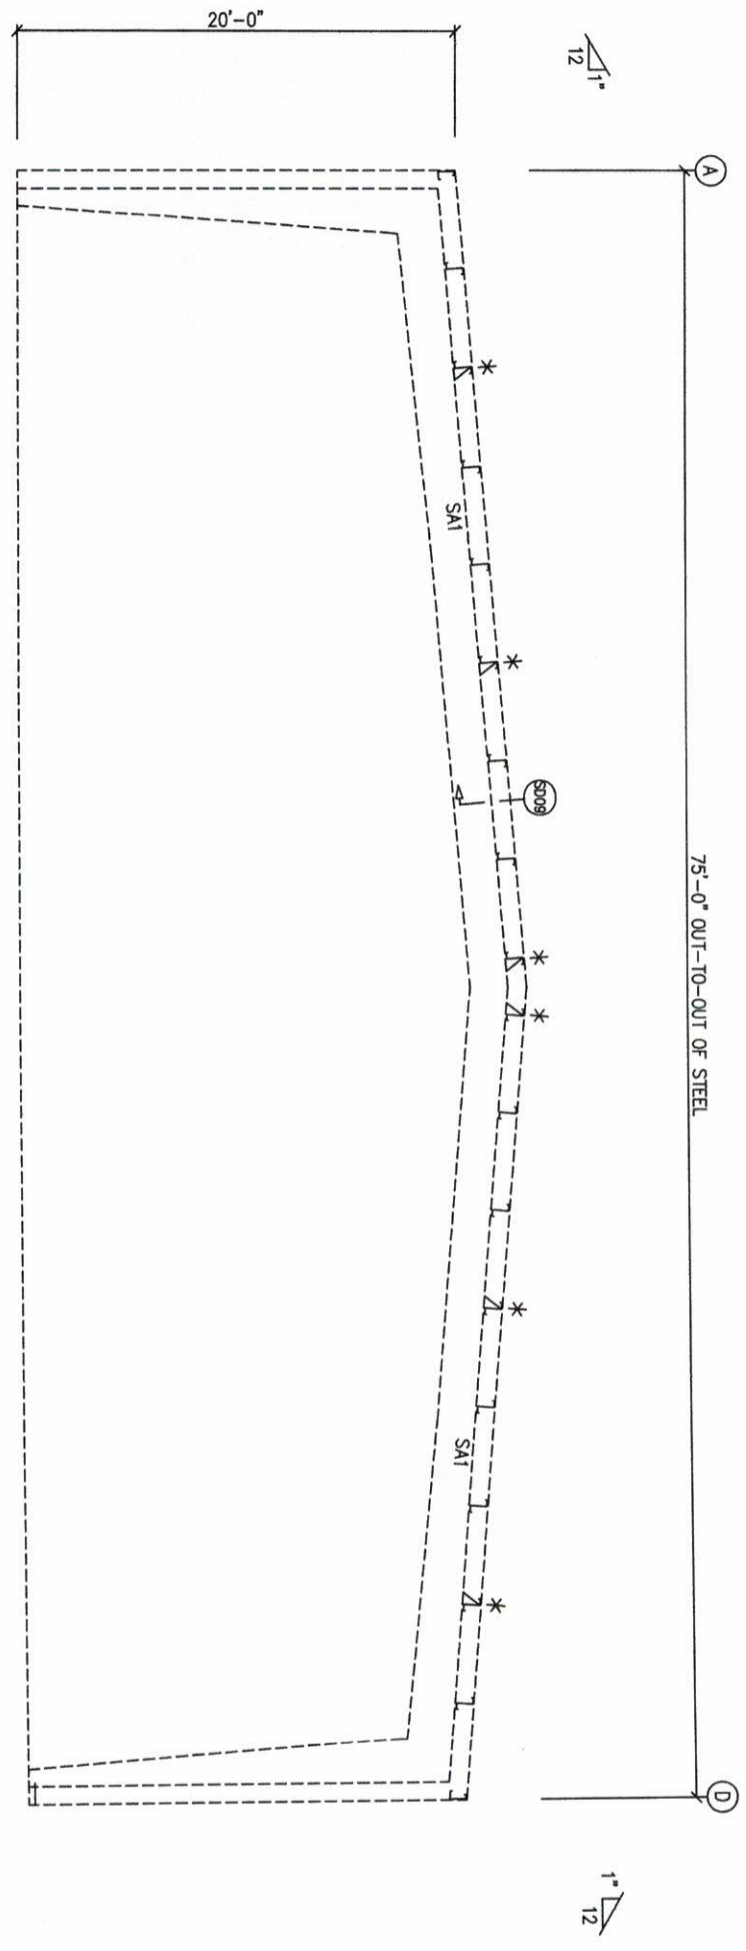

ENDWALL FRAMING: FRAME LINE 5

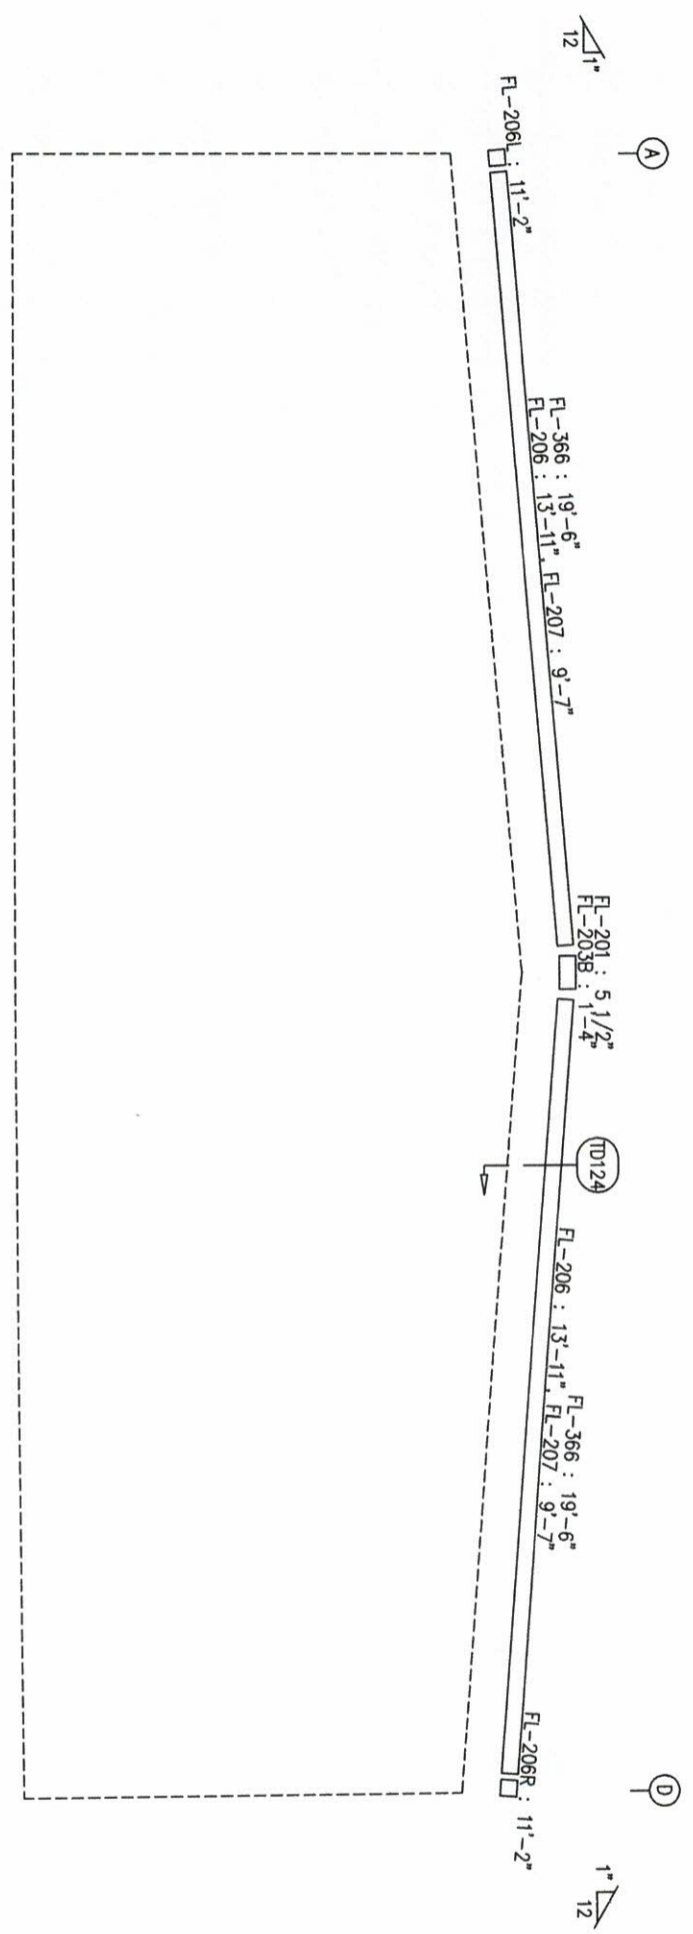

ENDWALL TRIM: FRAME LINE 5






GENERAL NOTES:
 TRIM IS FIGURED WITH 2" TRIM LAP UNLESS NOTED ON A DETAIL.
 FIELD CUT PANELS AT FRAMED OPENINGS, WALKDOORS, AND WINDOWS.
 FORMED BASE TRIM (IF USED) TO BE FIELD MITERED AT CORNERS.
 BEVEL CUT ENDWALL PANELS AS REQUIRED.
 FIELD SLOT GIRTS AS REQUIRED FOR CABLE BRACE CLEARANCE.

DRAWING STATUS		REVISIONS		DESCRIPTION		BY / DATE	
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<input type="checkbox"/>	FOR ENGINEER						
<input type="checkbox"/>	FOR CONTRACTOR						

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ENGINEER'S SEAL
 NORTH CAROLINA PROFESSIONAL SEAL
 14332
 DODSON, D.

PROJECT: GAD HULLING
 LOCATION: 7180Y JARCO DRIVE
 FLUQUAY VARIANA, NC 27526
 DATE: 3/4/19
 SCALE: N.T.S.
 SHEET NO. 147388
 EIT of 11 A

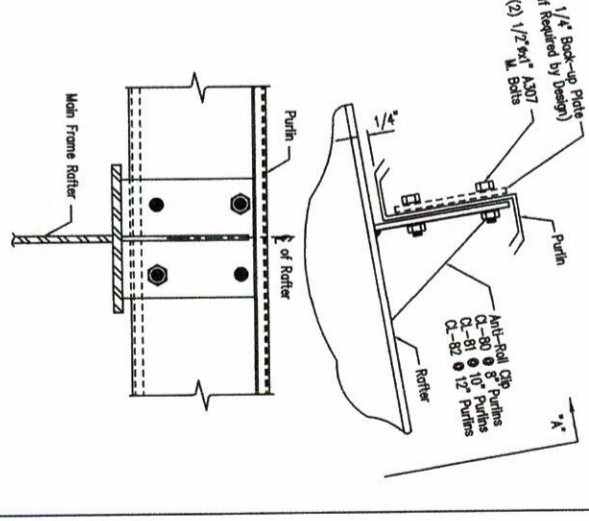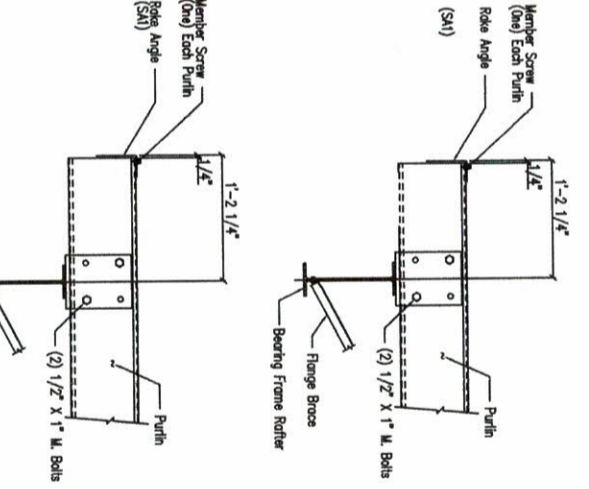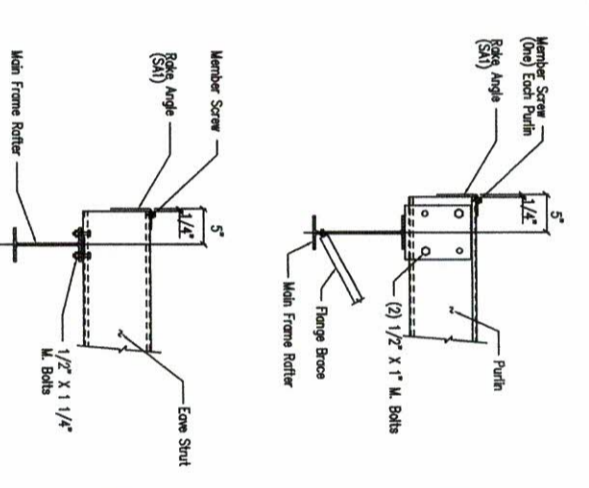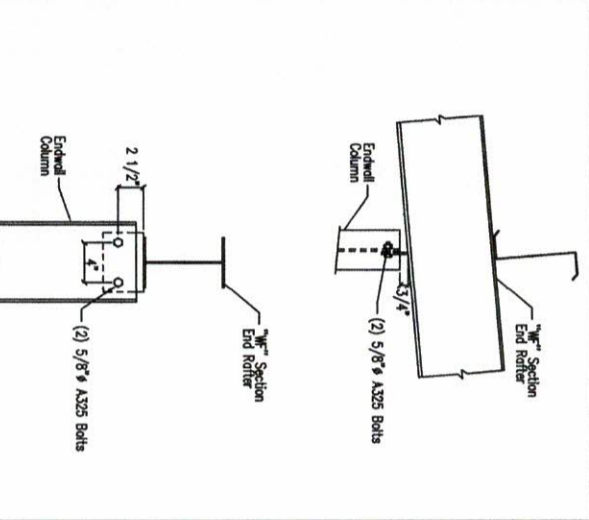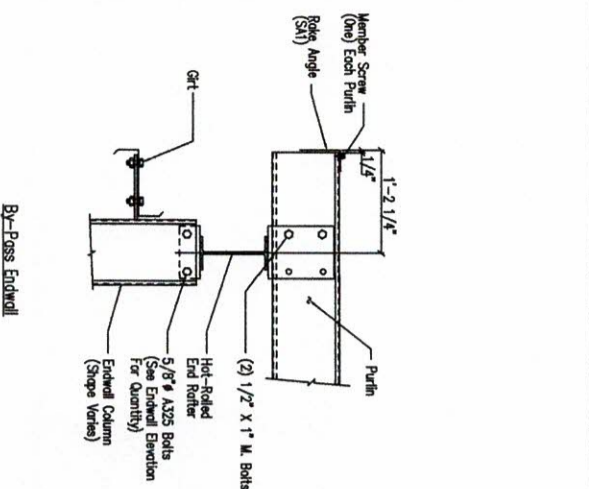




Section Thru Rake w/Hot Rolled Rafter
DRAWING NO. SD5

Hot Rolled Column to Hot Rolled Rafter
DRAWING NO. SD7

Main Frame Rafter Connection
PURLIN & EAVE STRUT CONNECTION
DRAWING NO. SD009

Main Frame Rafter Connection
PURLIN & EAVE STRUT CONNECTION
DRAWING NO. SD14X

Purlin to Anti-Roll Clip Connection
DRAWING NO. SD115

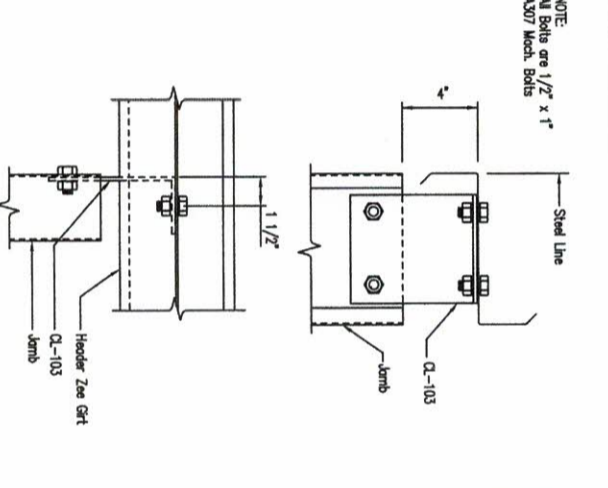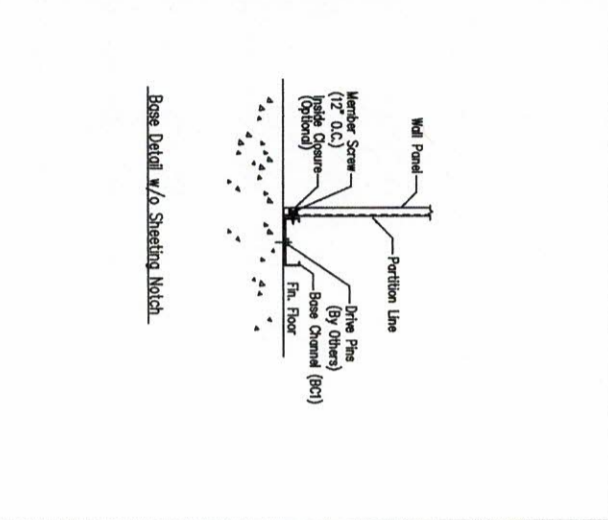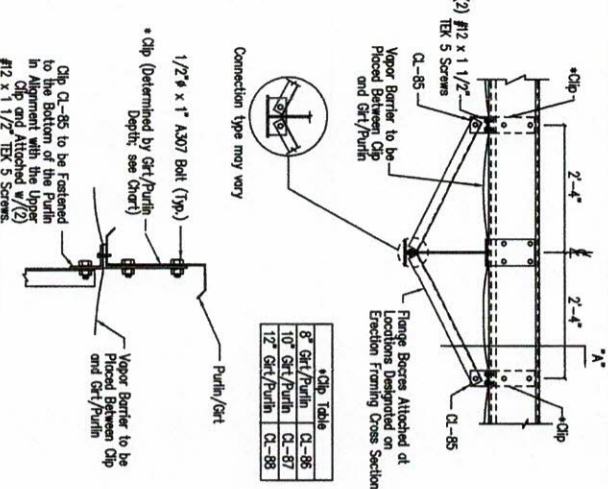

Interior Girt/Purlin Frange Brace Attachment for Insulation
DRAWING NO. SD161

Base Channel w/o Trim
DRAWING NO. SD75X

Jamb to Header Girt
DRAWING NO. SD94

GENERAL NOTES:
SEE ELEVATIONS FOR TRIM MARKS, LENGTHS, LOCATION, AND QUANTITY.
ALL TAPE SEALANT IS CONTINUOUS UNLESS NOTED.
TRIM MARKS FOR RAKE, SLOPE AND LEAK TRIM TO BE INSTALLED BEFORE ROOF INSULATION.
FRAMING SHALL BE INSTALLED TO BE SHOWN.
A 1\"/>

NOTE: If insulation is required install trim first.
NOTE: A minimum of 1/4\"/>

NOTE: All bolts are 1/2\"/>

DRAWING STATUS


NO.	DATE	DESCRIPTION	BY	CHKD
A	3/6/19	FOR PERMIT	WSC	DV

SCHULTE BUILDING SYSTEMS
17800 Bottle Road - Hockley, Texas 77447
PHONE: 281.304.6111 877.257.2534
FAX: 281.304.6113
www.schultebuilding.com


SBS
SCALE: N.T.S.
DATE: 3/4/19

SEAL
3/8/19
DODSON D. ENGINEER
NORTH CAROLINA PROFESSIONAL SEAL


DESIGNER	RYLTY PEDINI DESIGN BUILDERS, LLC
ADDRESS	1400 SANDY DR. STIC09
LOCATION	RALEIGH, NC 27607
PH	147.398
DI	of 5
ISSUE	A

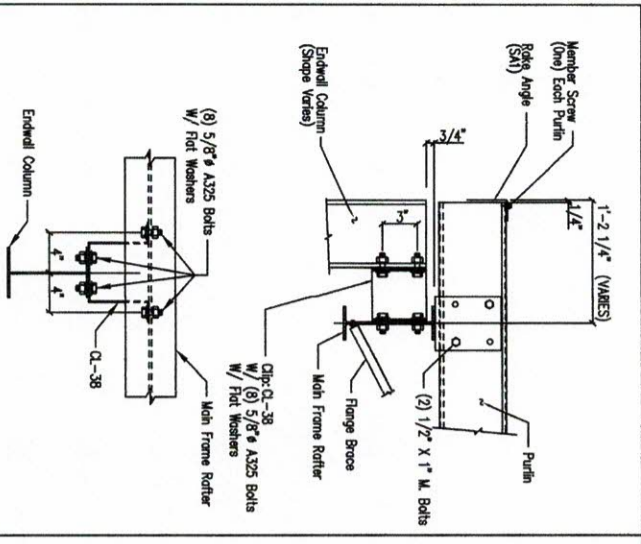


W.F. Column to Main Frame Rafter Connection
 DRAWING NO. SD20
 By-Pass Standard

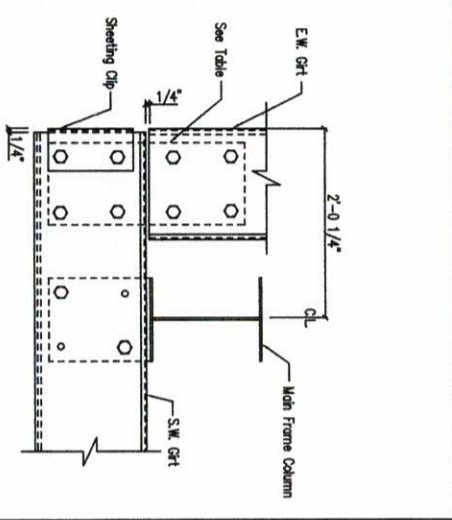


Section of W.F. Corner Column
 DRAWING NO. SD36
 Flush Endwall

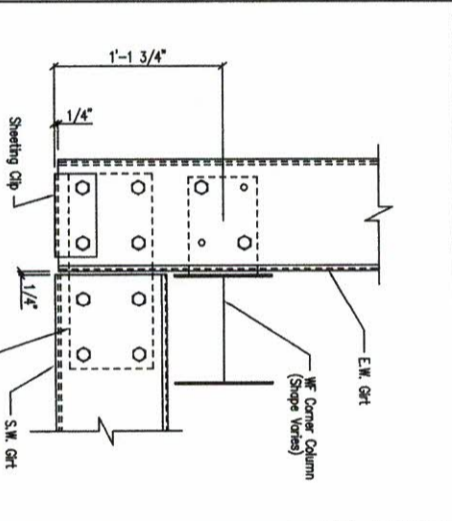


Section of W.F. Corner Column
 DRAWING NO. SD42
 By-Pass Endwall

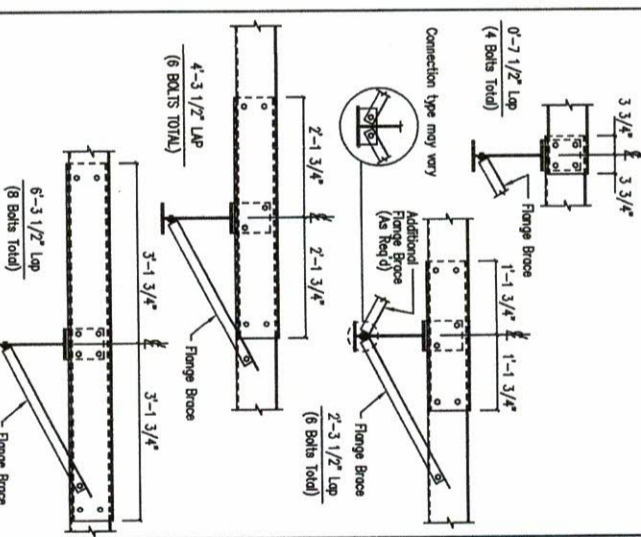


Interior Bay Purlin Framing
 DRAWING NO. SD50
 Flush Endwall

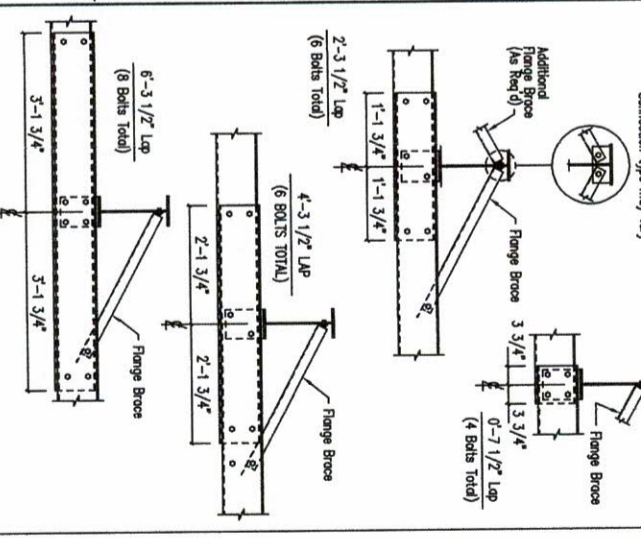


Interior Bay Girt Framing
 DRAWING NO. SD51
 Flush Endwall

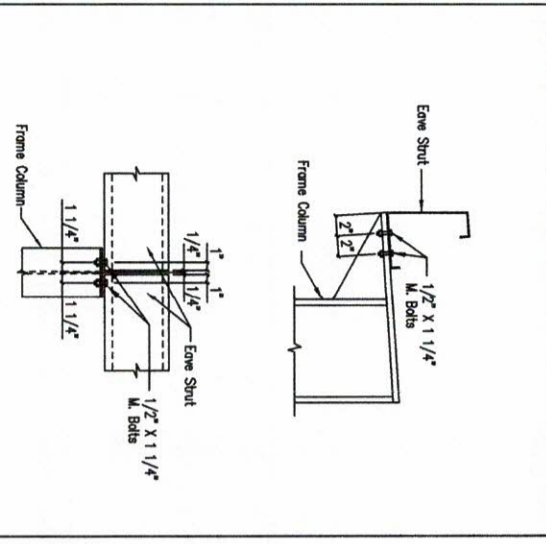


Eave Strut of Interior Column
 DRAWING NO. SD59
 By-Pass Standard

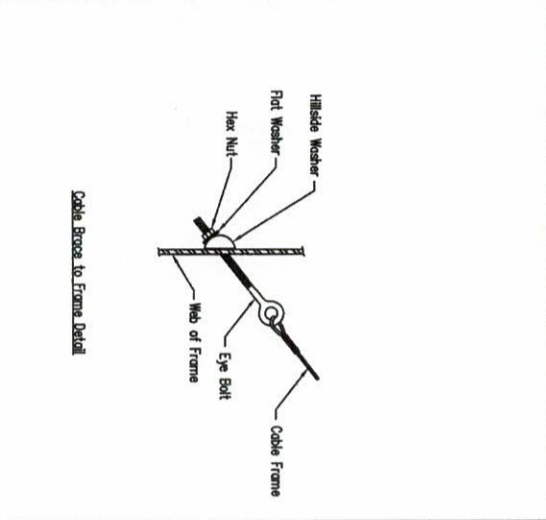


Cable or Rod Brace to Frame Connection
 DRAWING NO. SD66
 Flush Endwall

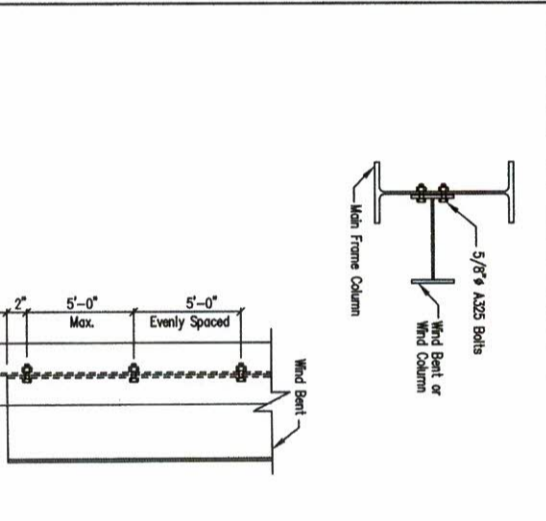

Wind Column/Bent Frame Detail
 DRAWING NO. SD70
 Flush Endwall

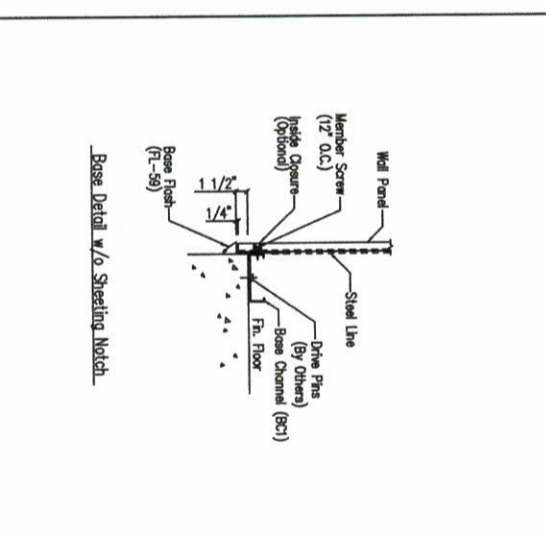

Base Channel w/Trim
 DRAWING NO. SD75
 Flush Endwall

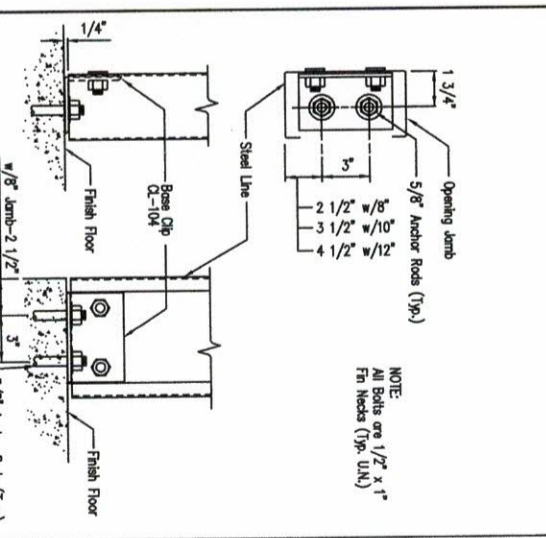

Jamb to Floor
 DRAWING NO. SD85
 Flush Endwall

GENERAL NOTES:
 SEE ELEVATIONS FOR TRIM MARKS, LENGTHS, LOCATION, AND QUANTITY.
 ALL TIE SEALANTS IS CONTINUOUS UNLESS NOTED.
 WALL PANELS, POP RIVETS, AND EAVE TRIM TO BE INSTALLED BEFORE ROOF INSULATION.
 FOR CLARITY OF DETAILS, ROOF INSULATION IS NOT SHOWN.
 ALL DIMENSIONS ARE IN FEET AND INCHES (F'-INCHES) UNLESS OTHERWISE SPECIFIED ON THE WORK ORDER.
 *TRIM PROFILE MAY VARY.

DRAWING STATUS

NO.	DATE	FOR PERMIT	BY
A	3/6/19		WCS/DV

FOR APPROVAL:
 THESE DRAWINGS, BEING FOR APPROVAL, ARE BY DEFINITION NOT FINAL, AND ARE FOR CONCEPTUAL REPRESENTATION ONLY. THEIR USE FOR CONSTRUCTION SHALL BE AT THE USER'S RISK. THE USER SHALL BE RESPONSIBLE FOR OBTAINING ALL NECESSARY PERMITS AND FOR VERIFYING THAT ALL DIMENSIONS AND CONDITIONS SHOWN ON THESE DRAWINGS ARE COMPLETELY ACCURATE AND CORRECT FOR THE PROJECT AND SITE CONDITIONS. THE USER SHALL BE RESPONSIBLE FOR OBTAINING ALL NECESSARY PERMITS AND FOR VERIFYING THAT ALL DIMENSIONS AND CONDITIONS SHOWN ON THESE DRAWINGS ARE COMPLETELY ACCURATE AND CORRECT FOR THE PROJECT AND SITE CONDITIONS. THE USER SHALL BE RESPONSIBLE FOR OBTAINING ALL NECESSARY PERMITS AND FOR VERIFYING THAT ALL DIMENSIONS AND CONDITIONS SHOWN ON THESE DRAWINGS ARE COMPLETELY ACCURATE AND CORRECT FOR THE PROJECT AND SITE CONDITIONS.

REVISIONS

NO.	DATE	DESCRIPTION	BY
A	3/6/19	FOR PERMIT	WCS/DV

SCHULTE BUILDING SYSTEMS
 17800 Badley Road - Houston, Texas 77447
 Phone: 281.304.6111 877.257.2534
 Fax: 281.304.6113
 www.schultebuilding.com


ISBS
 SCHULTE BUILDING SYSTEMS


SCHULTE BUILDING SYSTEMS
 1400 SANDWAY DR., STE109
 RALEIGH, NC 27607
 PH: 919.833.1111
 FAX: 919.833.1112
 WWW: www.schultebuilding.com

PROJECT: GOOD HAULING
LOCATION: FLOQUAY VARIANA, NC 27526
DATE: 3/4/19
SCALE: N.T.S.


DESIGNER: RUBY PREDIN, DCSRA BUILDERS, LLC
CHECKED BY: JH
DATE: 3/4/19
SCALE: N.T.S.

ISSUE: A

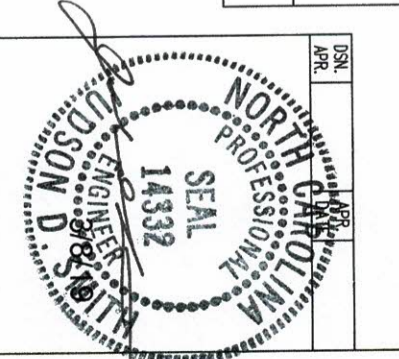


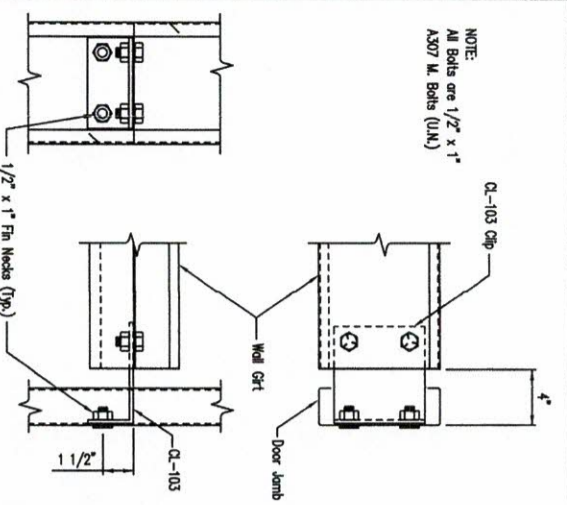


Girt to Jamb (Bolted Clips)
DRAWING NO. **SD87**

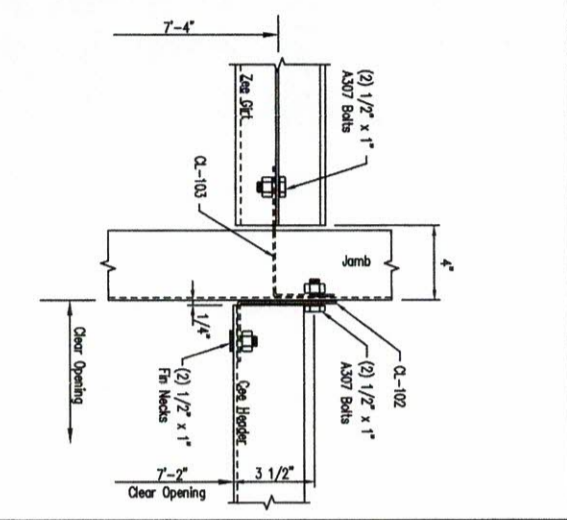


Header to Jamb at 7'-2"
DRAWING NO. **SD88**

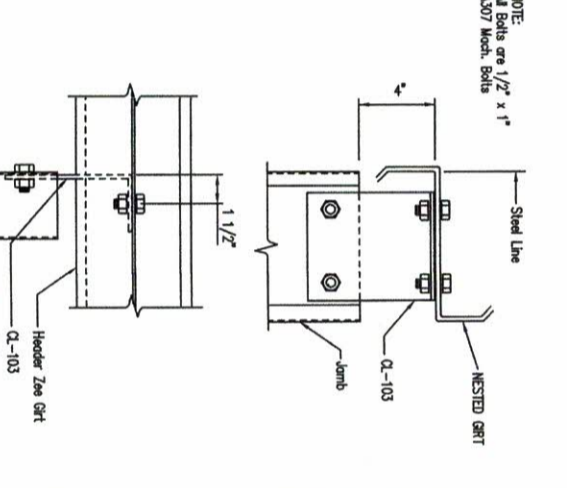


Jamb to Nested Girt
DRAWING NO. **SD94X**

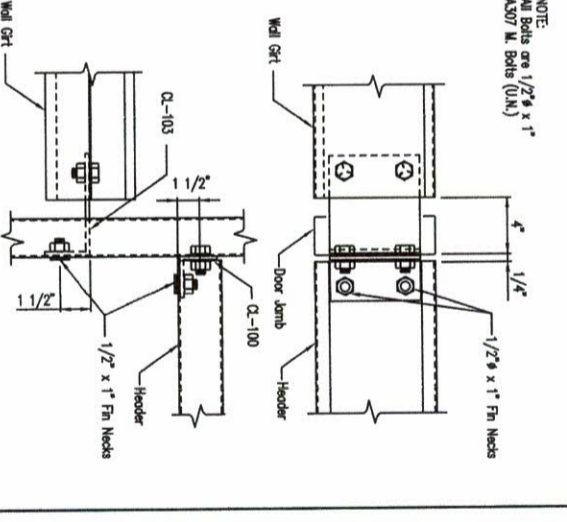


Girt/Header to Jamb (Bolted Clips)
DRAWING NO. **SD95**

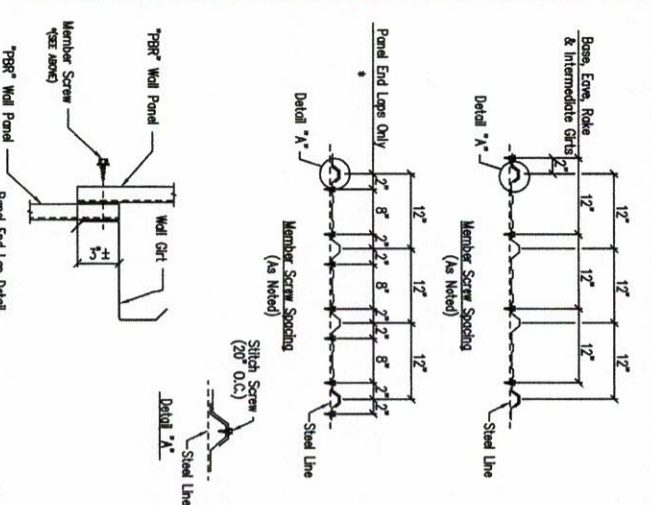


Fastener Location "PBR" Panel at Wall
DRAWING NO. **TD1**

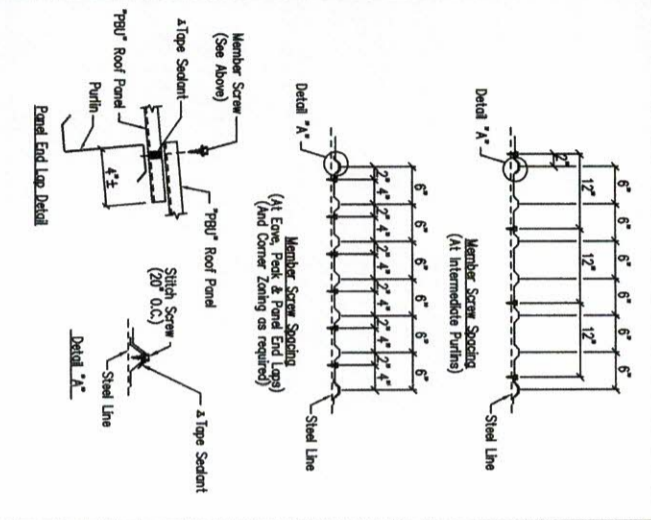


Fastener Location "PBU" Panel at Roof
DRAWING NO. **TD6**

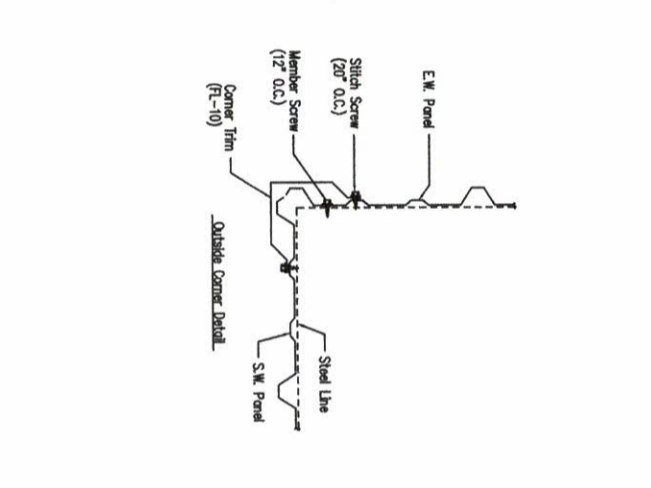

Section at Corner - PBR
DRAWING NO. **TD40**

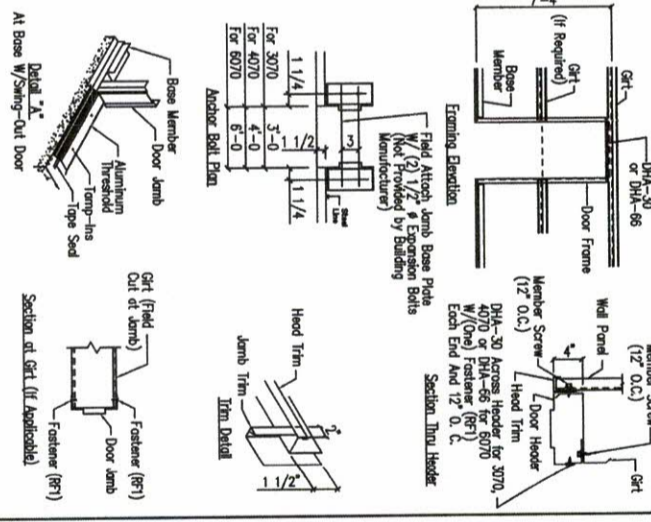

Personnel Doors (Walk Door Sections)
DRAWING NO. **TD50**

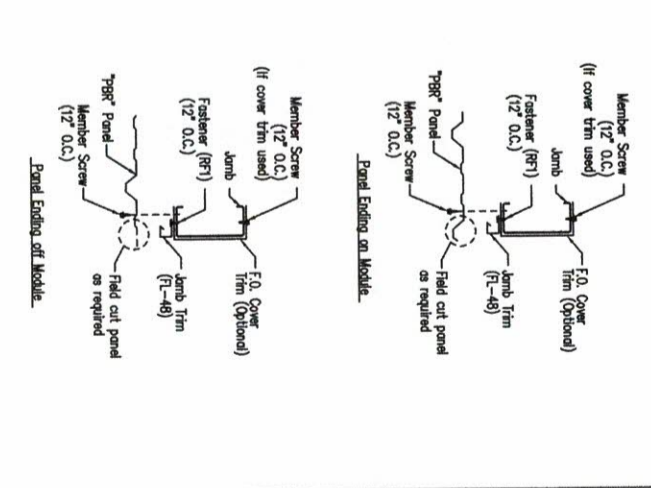

Jamb Detail for Framed Opening - PBR
DRAWING NO. **TD51**

NOTE: All Bolts are 1/2" x 1" A307 Mod. Bolts

Roof Fasteners: #14 x 7/8" Self Drilling Screw Laptek - Silich Screw
 Long Life Fasteners: #12 x 1 1/4" Self Drilling Screw - Member Screw
 Wall Fasteners: #14 x 7/8" Self Drilling Screw Laptek - Silich Screw
 Long Life Fasteners: #12 x 1 1/4" Self Drilling Screw - Member Screw
 Trim Fasteners: #14 x 7/8" Self Drilling Screw Laptek - Silich Screw
 Long Life Fasteners: #12 x 1 1/4" Self Drilling Screw - Member Screw
 Lister Fasteners: #14 x 7/8" Self Drilling Screw Laptek - Silich Screw
 Long Life Fasteners: #12 x 1 1/4" Self Drilling Screw - Member Screw
 Partition Fasteners: #14 x 7/8" Self Drilling Screw Laptek - Silich Screw
 Long Life Fasteners: #12 x 1 1/4" Self Drilling Screw - Member Screw
 Self Fasteners: #14 x 7/8" Self Drilling Screw Laptek - Silich Screw
 Long Life Fasteners: #12 x 1 1/4" Self Drilling Screw - Member Screw
 Steel to Steel Fasteners: #12 x 1" Self Drilling Screw w/O Washer - Member Screw (MS)

RFI: #10-16 x 1" Self Drilling Screw w/O Washer

NOTE: Refer to Details and Sections for specific screw types, locations, and spacing.

Screw Size Note
DRAWING NO. **TD000**

GENERAL NOTES:
 SET ELEVATIONS FOR TRIM MARKS, LENGTHS, LOCATION, AND QUANTITY.
 ALL FASTENERS ARE TO BE INSTALLED BEFORE ROOF INSULATION.
 WALL PANELS FOR FINISH ROOMS ARE TO BE SHIPPED TO THE WORK AREA.
 ALL WIRE SHALL BE 3/32" WIRE GALV. (OPTIONAL) MUST BE SPECIFIED ON THE WORK ORDER.
 * TRIM PROFILE MAY VARY.

NO.	DATE	DESCRIPTION	BY (C/D)	CHK'D BY
A	3/6/19	FOR PERMIT	MSJ	OV

DRAWING STATUS

FOR APPROVAL. THESE DRAWINGS, BEING FOR APPROVAL, ARE BY DEFINITION NOT FINAL, AND ARE FOR CONCEPTUAL REPRESENTATION ONLY. THEY DO NOT CONSTITUTE A CONTRACT. ONLY DRAWINGS ISSUED FOR CONSTRUCTION CAN BE CONSIDERED AS COMPLETE.

FOR PERMIT. THESE DRAWINGS, BEING FOR PERMIT, ARE BY DEFINITION NOT FINAL, AND ARE FOR CONCEPTUAL REPRESENTATION ONLY. THEY DO NOT CONSTITUTE A CONTRACT. ONLY DRAWINGS ISSUED FOR CONSTRUCTION CAN BE CONSIDERED AS COMPLETE.

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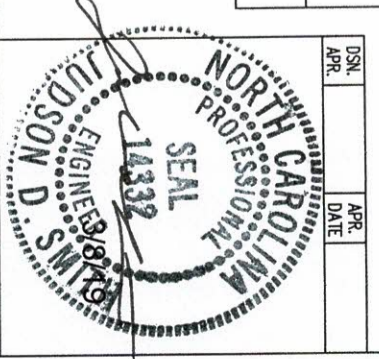
SCHULTE BUILDING SYSTEMS
 17900 Badley Road - Humble, Texas 77447
 PHONE: 281.304.6111 877.257.2534
 FAX: 281.304.6113
 www.schultebuilding.com






ISBS
 1400 SUNDAY DR, STE 109
 RALEIGH, NC 27607
 PHONE: 919.875.1111
 www.isbs.com

ORDER REF TO CI
 ORDER: RIFTY PEEM DESIGN BUILDERS, LLC
 ADDRESS: 1400 SUNDAY DR, STE 109
 RALEIGH, NC 27607
 PHONE: 919.875.1111
 www.isbs.com






DATE: 3/4/19
DATE: 3/4/19
DATE: 3/4/19

DATE: APR 19 2019
DATE: APR 19 2019
DATE: APR 19 2019



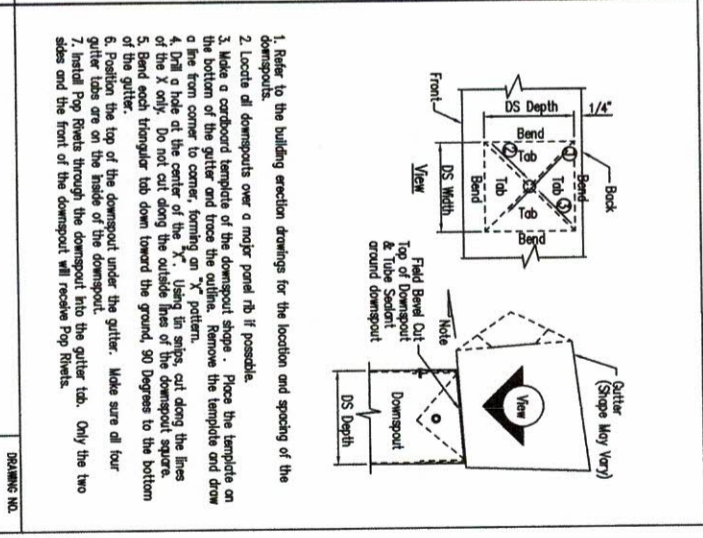
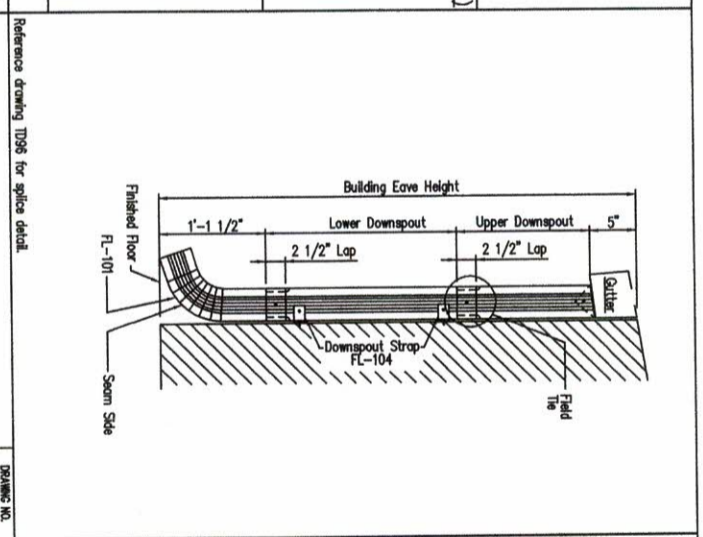
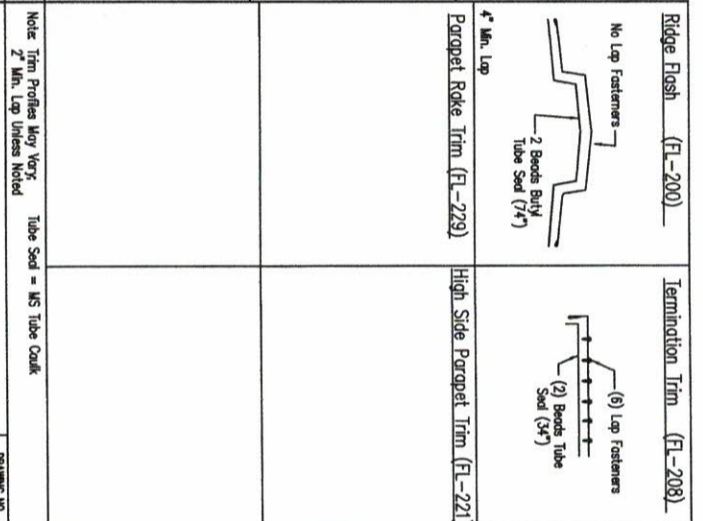
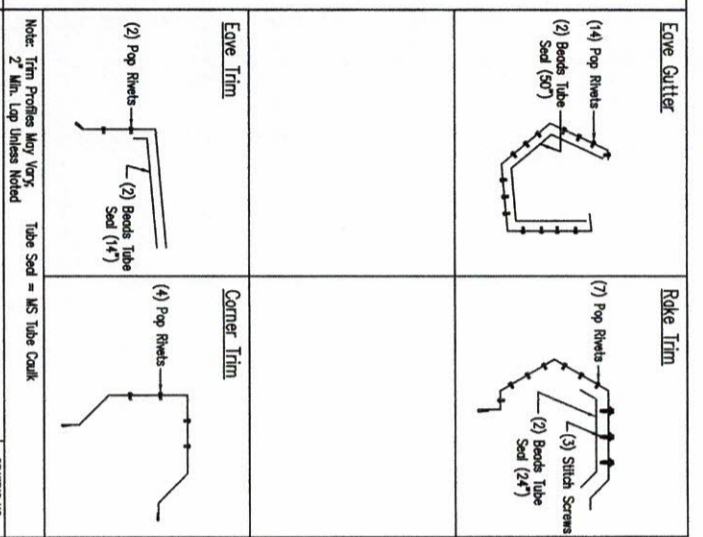
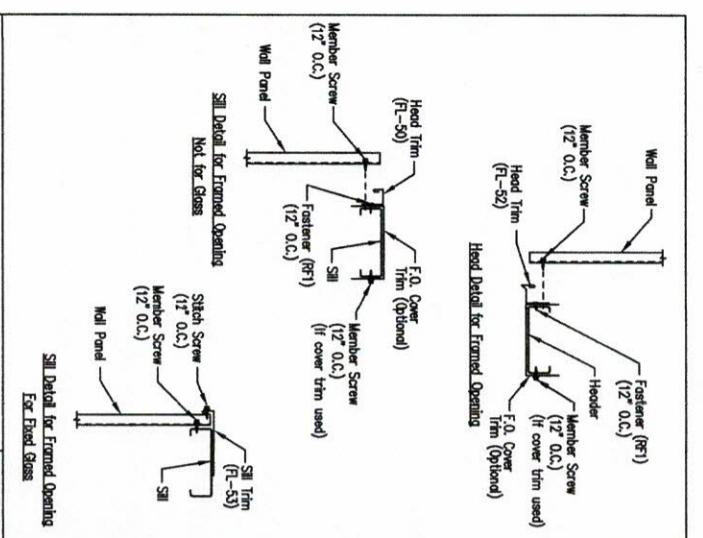


1. Refer to the building erection drawings for the location and spacing of the downspouts.
 2. Locate all downspouts over a major panel if possible.
 3. Make a cardboard template of the downspout shape. Place the template on the bottom of the gutter and trace the outline. Remove the template and draw a line from corner to corner, forming an "X" pattern.
 4. Drill a hole at the center of the "X". Using tin snips, cut along the lines of the "X" only. Do not cut along the outside lines of the downspout square.
 5. Bend each triangular tab down toward the ground, 90 degrees to the bottom of the gutter.
 6. Position the top of the downspout under the gutter. Make sure all four gutter tabs are on the inside of the downspout.
 7. Initial Pop Rivets through the downspout into the gutter tab. Only the two sides and the front of the downspout will receive Pop Rivets.

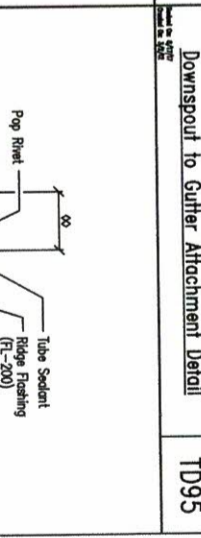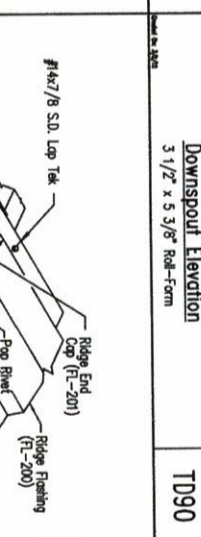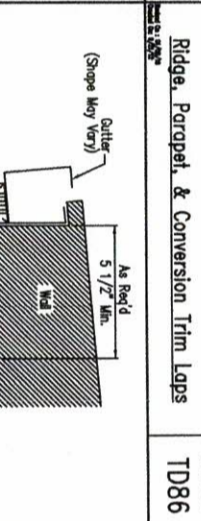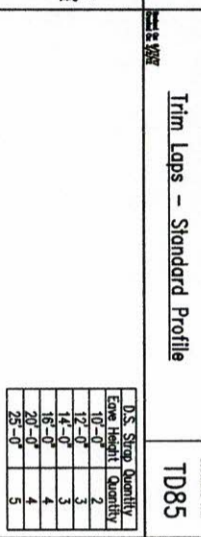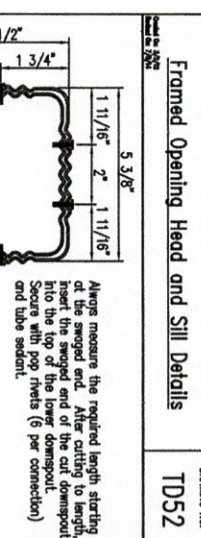

*ORDER TABLE

Stripoff	NS-324	NS-216
Rake Part	RS4438	RS4238
SA1	RS4438	RS4338
SA2	RS4600	RS4500

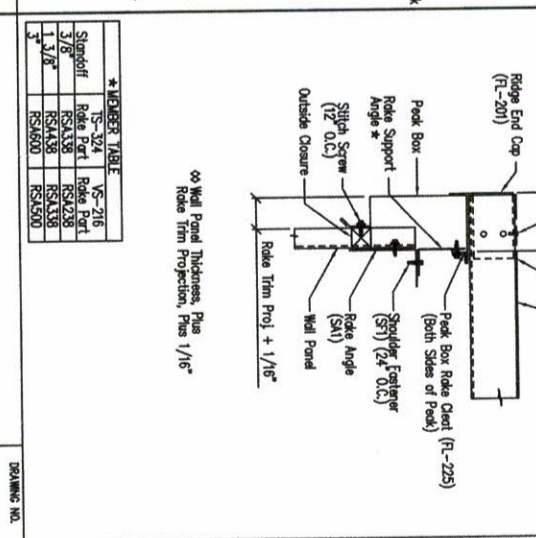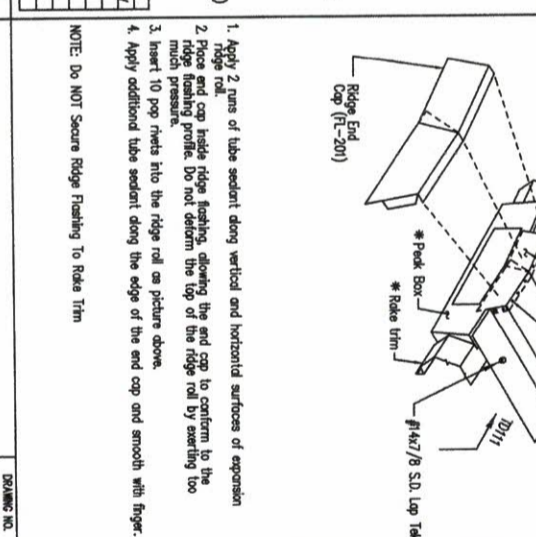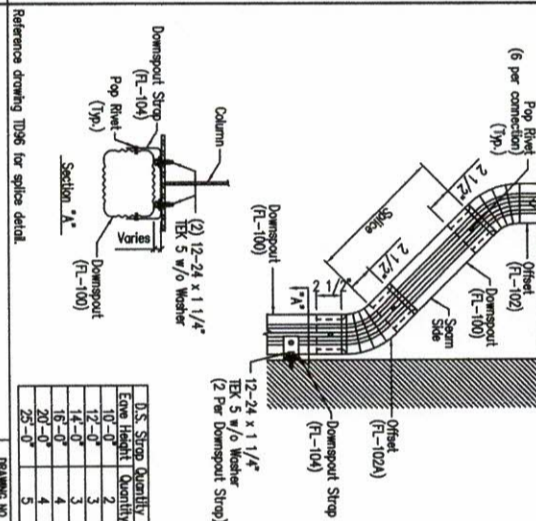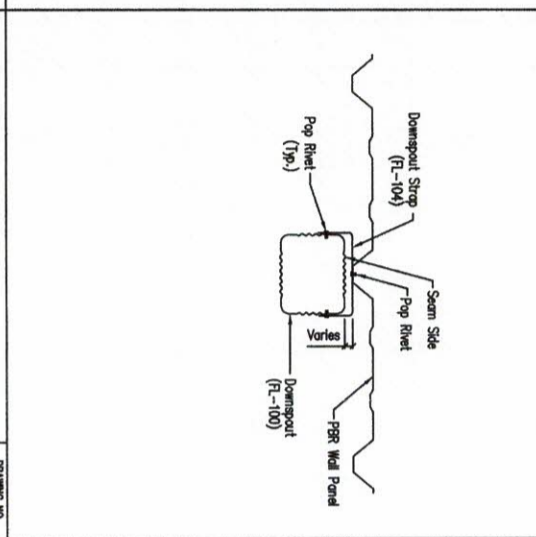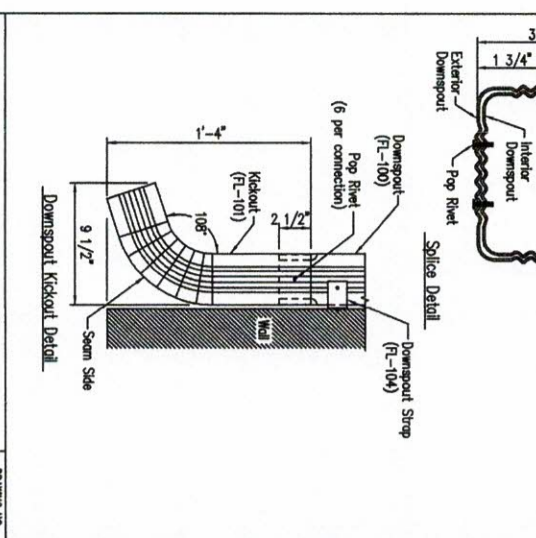

*ORDER TABLE

Stripoff	NS-324	NS-216
Rake Part	RS4438	RS4238
SA1	RS4438	RS4338
SA2	RS4600	RS4500

GENERAL NOTES:
 SEE ELEVATIONS FOR TRIM MARKS, LENGTHS, LOCATION, AND QUANTITY.
 ALL TAPE SEALANT IS CONTINUOUS UNLESS NOTED.
 WALL PANELS, POP RIVETS, AND EAVE TRIM TO BE INSTALLED BEFORE ROOF INSULATION.
 4x4 W/ 3/8\"/>

Downspout Kickout and Splice Detail
 DRAWING NO. TD96
 3 1/2\"/>

Downspout Strap Attachment Detail - PBR
 DRAWING NO. TD98
 3 1/2\"/>

Full Height Open Wall
 DRAWING NO. TD100
 3 1/2\"/>

Expansion End Cap Assembly
 DRAWING NO. TD110
 3 1/2\"/>

Expansion Ridge Cap - IS-324/NS-216
 DRAWING NO. TD111
 3 1/2\"/>

DRAWING STATUS


NO.	DATE	FOR PERMIT	BY (C/D)
A	3/6/19		

REVISIONS

NO.	DATE	DESCRIPTION	BY (C/D)

SCHULTE BUILDING SYSTEMS
 17000 Boodle Road - Houston, Texas 77041
 PHONE: 281-304-6111 877-257-2534
 FAX: 281-304-6113
 www.schultebuilding.com

SEAL
 NORTH CAROLINA PROFESSIONAL ENGINEERS
 44332
 JUDSON D. S. ENGINEER
 APR. DATE

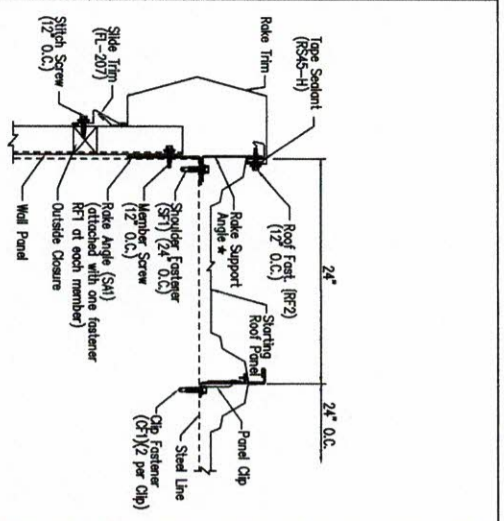


*** MEMBER TABLE**

Standard Part	3/8"	RS4338
Standard Part	1 3/8"	RS4438

Starting Rake Detail - TS-324
Standard Rake - Sheeted Wall (On Module)

DRAWING NO. TD112

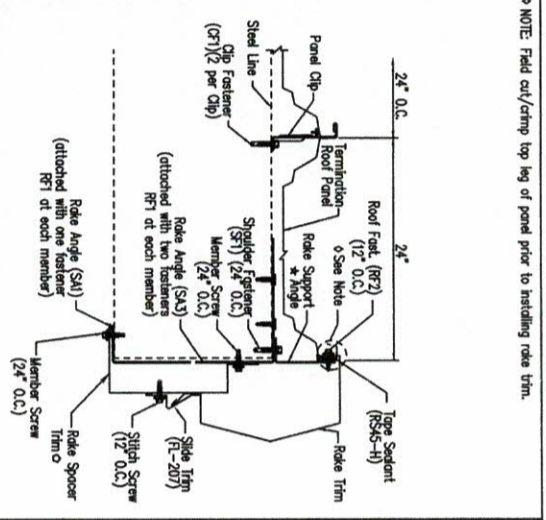


*** MEMBER TABLE**

Standard Part	3/8"	RS4338
Standard Part	1 3/8"	RS4438

Finish Rake Detail - TS-324
Standard Rake - Open Wall (On Module)

DRAWING NO. TD123

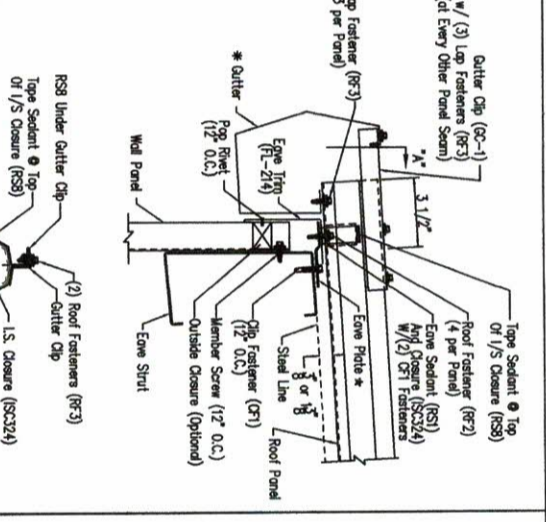


*** MEMBER TABLE**

Standard Part	3/8"	EP338
Standard Part	1 3/8"	EP338


Low Eave Detail - TS-324
Standard Gutter - Sheeted Wall

DRAWING NO. TD115

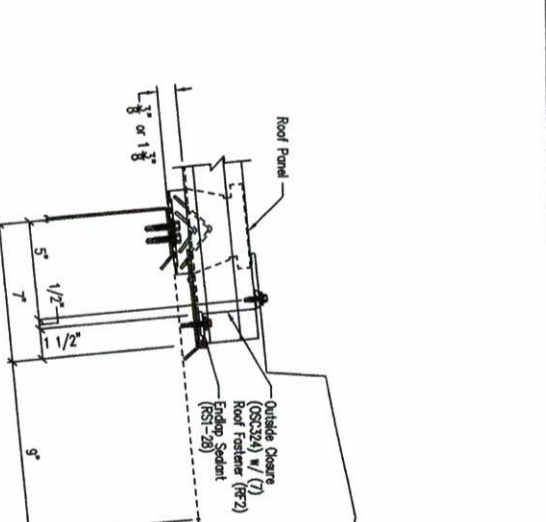


Ridge Detail - TS-324

DRAWING NO. TD117

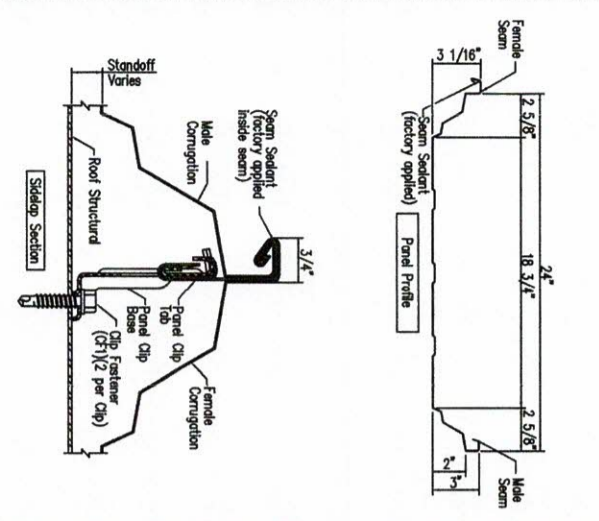


Roof Panel Sections - TS-324
TripleLock™ Seam

DRAWING NO. TD118

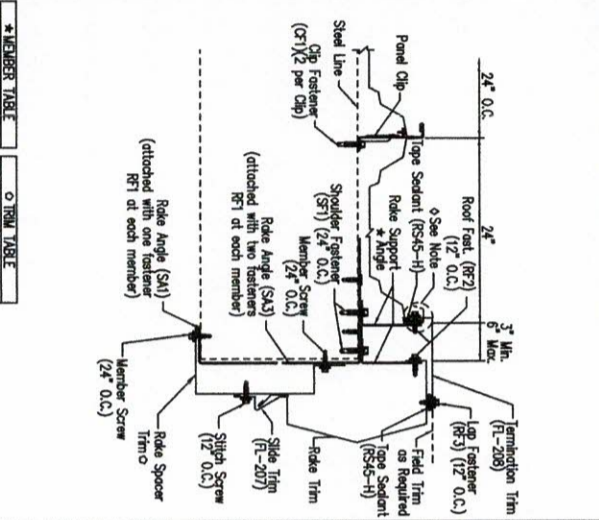


Finish Rake Detail - TS-324
Standard Rake - Open Wall (Off Module)

DRAWING NO. TD124

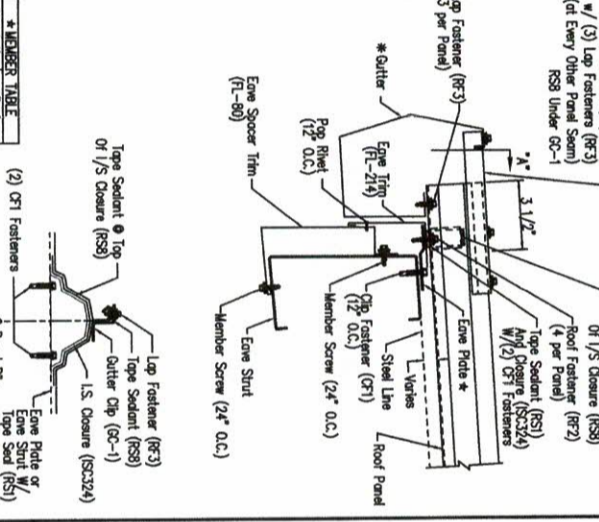


Low Eave Detail - TS-324
Standard Gutter - Open Wall

DRAWING NO. TD120

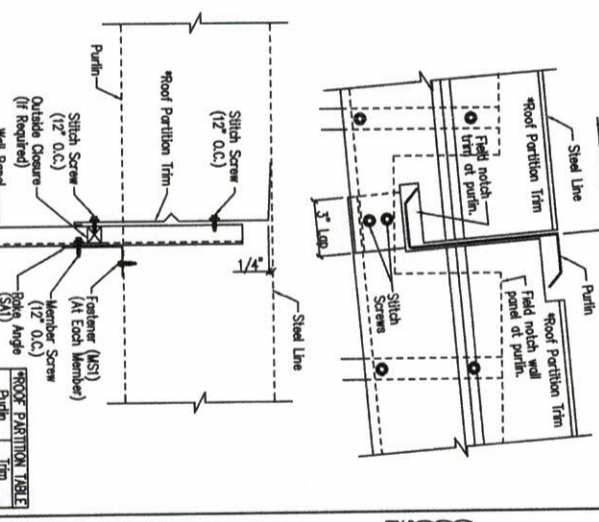

Roof Partition Trim Details

DRAWING NO. TD211

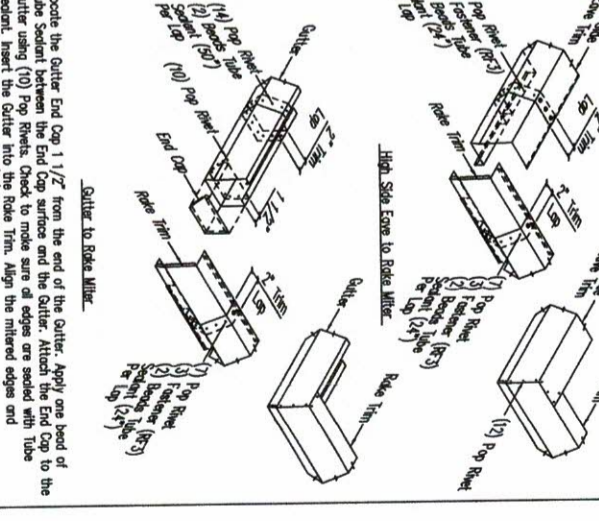

TS-324/NS-216 Standard Trim Detail

DRAWING NO. TD291

GENERAL NOTES:
SEE ELEVATIONS FOR TRIM MARKS, LENGTHS, LOCATION, AND QUANTITY.
ALL TAPE SEALANT IS CONTINUOUS UNLESS NOTED. INSTALLED BEFORE ROOF INSULATION.
FROM MANUFACTURER'S INSTRUCTIONS TO BE SHOWN.
4" WIDE x 3/32" TAPE SEAL (OPTIONAL) MUST BE SPECIFIED ON THE WORK ORDER.
* TRIM PROFILE MAY VARY.

DRAWING STATUS

NO.	DATE	FOR PERMIT	BY	CHK'D
A	3/6/19		WSC	WSC

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17900 Barba Road - Houston, Texas 77447
PHONE: 281.304.6111 877.257.2534
FAX: 281.304.6113
www.schultebuildingsystems.com

REVISIONS

NO.	DATE	DESCRIPTION	BY	CHK'D
A	3/6/19		WSC	WSC

DESIGNER: RUTY PEDINI DESIGN BUILDERS, LLC
PROJECT: GARD HALLING
ADDRESS: 1400 SUNDAY DR. STE 109
LOCATION: FLOQUAY VARIAN, NC 27526
DATE: 3/4/19
SCALE: N.T.S.
DRN. NO.: 147588
APR. DATE: 05 of 5
APP.: A

SEAL: NORTH CAROLINA PROFESSIONAL ENGINEERS
14332
JUDSON D.