

**LEGEND - DEMOLITION**

- EXISTING WALL TO REMAIN
- EXISTING CONSTRUCTION TO BE DEMOLISHED
- EXISTING DOOR TO REMAIN
- EXISTING DOOR TO BE DEMOLISHED
- EXISTING CASEWORK OR OTHER ITEM TO BE DEMOLISHED
- EXISTING WORK TO REMAIN



**GENERAL NOTES - DEMOLITION**

- A. FIELD VERIFY ALL DIMENSIONS AND EXISTING CONDITIONS.
- B. REMOVE EXISTING CEILINGS, LIGHT FIXTURES, MECHANICAL DUCTWORK, FIRE ALARM DEVICES, SMOKE DETECTORS, ETC., UNLESS OTHERWISE NOTED.
- C. SEE STRUCTURAL, PLUMBING, MECHANICAL, ELECTRICAL AND FIRE ALARM DRAWINGS FOR DEMOLITION PLANS AND NOTES.
- D. THE CONTRACTOR SHALL REMOVE SUCH EXISTING WORK AS CALLED FOR IN CONTRACT OR AS REQUIRED TO CLEAR THE AREAS FOR NEW CONSTRUCTION.
- E. ALL DEMOLITION WORK SHALL BE PERFORMED WITH 'DUE CARE AND DILIGENCE' AS TO PREVENT THE ARBITRARY DESTRUCTION OR INTERRUPTION OF CONCEALED UTILITIES WHICH ARE INTENDED TO REMAIN IN USE AND THE ROUTING OF WHICH COULD NOT BE DETERMINED UNTIL DEMOLITION WAS STARTED. ALL SUCH DISCOVERIES OF UTILITIES DURING THE DEMOLITION PROCESS WHICH ARE IN A LOCATION DIFFERENT FROM THAT INDICATED, OR ARE UNIDENTIFIED, SHALL BE REPORTED TO THE ARCHITECT PRIOR TO REMOVAL FOR FINAL DISPOSITION.
- F. WORK DESIGNATED TO REMAIN SHALL BE PROTECTED FROM DAMAGE AND PATCHED OR REPAIRED SHOULD DAMAGE OCCUR.
- G. WHERE EXISTING ITEMS ARE TO BE RELOCATED, EXTREME CARE SHALL BE TAKEN TO PREVENT DAMAGE DURING THE REMOVAL.
- H. ALL DEBRIS BECOMES THE PROPERTY OF THE CONTRACTOR AND SHALL BE REMOVED DAILY FROM THE PREMISES AT THE CONTRACTOR'S EXPENSE AND BE DISPOSED OF ACCORDING TO LOCAL CODES AND GOVERNING AUTHORITIES. VERIFY SALVAGE MATERIALS WITH THE OWNER'S REPRESENTATIVE.
- I. CONTRACTOR SHALL CONSULT OTHER TRADES PRIOR TO COMMENCING THIS WORK TO AVOID CONFLICT.
- J. DEMOLITION DRAWINGS ARE DIAGRAMMATIC AND SHOW INTENT OF WORK TO BE DONE. CONTRACTOR SHALL PROVIDE ALL MATERIALS, EQUIPMENT, LABOR REQUIRED AND COST FOR REMOVAL OF ALL SYSTEMS CALLED FOR IN CONTRACT.
- K. ALL EXISTING CONSTRUCTION SHALL REMAIN UNLESS NOTED OTHERWISE.
- L. CONTRACTOR TO PATCH AND REPAIR ALL AREAS AFFECTED BY THE DEMOLITION.
- M. REMOVE ALL CONSTRUCTION SHOWN ON THE DRAWINGS AS EXISTING TO BE REMOVED, INCLUDING, BUT NOT LIMITED TO, FLOORING, PARTITIONS, INCLUDING ELEMENTS OCCURRING ABOVE THE FINISHED CEILING(S), HANGERS, STRAPS AND OTHER ACCESSORY OBJECTS CONNECTED WITH THE ITEMS BEING REMOVED.
- N. ON REMAINING WALLS ADJACENT TO THOSE BEING DEMOLISHED, EXISTING BASE SHALL BE REMOVED BACK TO NEAREST INSIDE CORNER AND WALLS SHALL BE REPAIRED SO AS TO CREATE A SMOOTH SURFACE READY TO RECEIVE NEW BASE.

**SHEET KEYNOTES**

- D1 REMOVE EXISTING CONCRETE STEPS AND RETAINING WALLS.
- D2 REMOVE EXISTING HANDRAIL(S) AND/OR GUARD RAIL(S).
- D3 REMOVE EXISTING SUMP PUMP.
- D4 REMOVE EXISTING LANDSCAPING.
- D5 REMOVE EXISTING CONCRETE SIDEWALK AND/OR BRICK PAVERS AS REQUIRED FOR NEW CONSTRUCTION. STOCK PILE BRICKS FOR RE-USE.
- D6 REMOVE EXISTING LOUVER AND REMOVE WALL BELOW LOUVER AS REQUIRED FOR NEW CONCRETE SLAB.
- D7 REMOVE EXISTING OUTDOOR FURNISHING. DELIVER TO OWNER.
- D8 REMOVE EXISTING WALL(S).
- D9 REMOVE EXISTING DOOR AND FRAME.
- D10 REMOVE PORTION OF EXISTING CMU AND/OR BRICK WALL AS REQUIRED FOR NEW CONSTRUCTION. SEE STRUCTURAL DRAWINGS.
- D11 REMOVE EXISTING PLASTER CEILING SYSTEM THROUGHOUT UNLESS OTHERWISE NOTED.
- D12 REMOVE EXISTING TOILET PARTITIONS AND DOORS.
- D14 REMOVE EXISTING PLUMBING FIXTURES. SEE PLUMBING DRAWINGS.
- D15 REMOVE EXISTING CEILING LIGHT FIXTURES AND FIRE ALARM DEVICES THROUGHOUT UNLESS OTHERWISE NOTED. SEE ELECTRICAL AND FIRE ALARM DRAWINGS.
- D16 REMOVE EXISTING STOOP, CONCRETE STEPS, AND RAILINGS.
- D17 REMOVE EXISTING WINDOW AND CAST STONE SILL.
- D18 REMOVE EXISTING WINDOW AND CAST STONE SILL. STORE WINDOW FOR RELOCATION.
- D19 REMOVE EXISTING STAIRS.
- D20 REMOVE EXISTING BASE AND/OR WALL CABINETS.
- D21 REMOVE EXISTING FLOOR FINISH THROUGHOUT UNLESS OTHERWISE NOTED. PREPARE FOR NEW FINISH.
- D22 REMOVE EXISTING APPLIANCES. DELIVER TO OWNER.
- D23 REMOVE EXISTING CEILING MECHANICAL DIFFUSERS THROUGHOUT UNLESS OTHERWISE NOTED. SEE MECHANICAL DRAWINGS.
- D24 REMOVE EXISTING STOREFRONT AND DOORS.
- D25 REMOVE EXISTING PORCH FLOOR AND FLOOR STRUCTURE.
- D26 REMOVE EXISTING HANDRAILS AT EXISTING STAIRS.
- D27 REMOVE EXISTING CMUBRICK WALL. PROVIDE HEADER ABOVE FINISH CEILING TO SUPPORT MASONRY ABOVE. SEE STRUCTURAL DRAWINGS.
- D29 REMOVE EXISTING DOORS AND FRAME. STORE DOORS FOR POSSIBLE RELOCATION.
- D30 REMOVE EXISTING FRAME SURROUND AT OPENING. WALL TO BE CLOSED AS NOTED.
- D32 REMOVE EXISTING BIKE RACK. REINSTALL IN NEW LOCATION AS SHOWN AT END OF PROJECT.
- D33 REMOVE EXISTING WINDOW, CAST STONE SILL AND CAST STONE SURROUND AT JAMBS AND HEADER. REMOVE BRICK/CMU BELOW WINDOW AND PREPARE FOR INSTALLATION OF NEW STOREFRONT ENTRY.

E  
D  
C  
B  
A

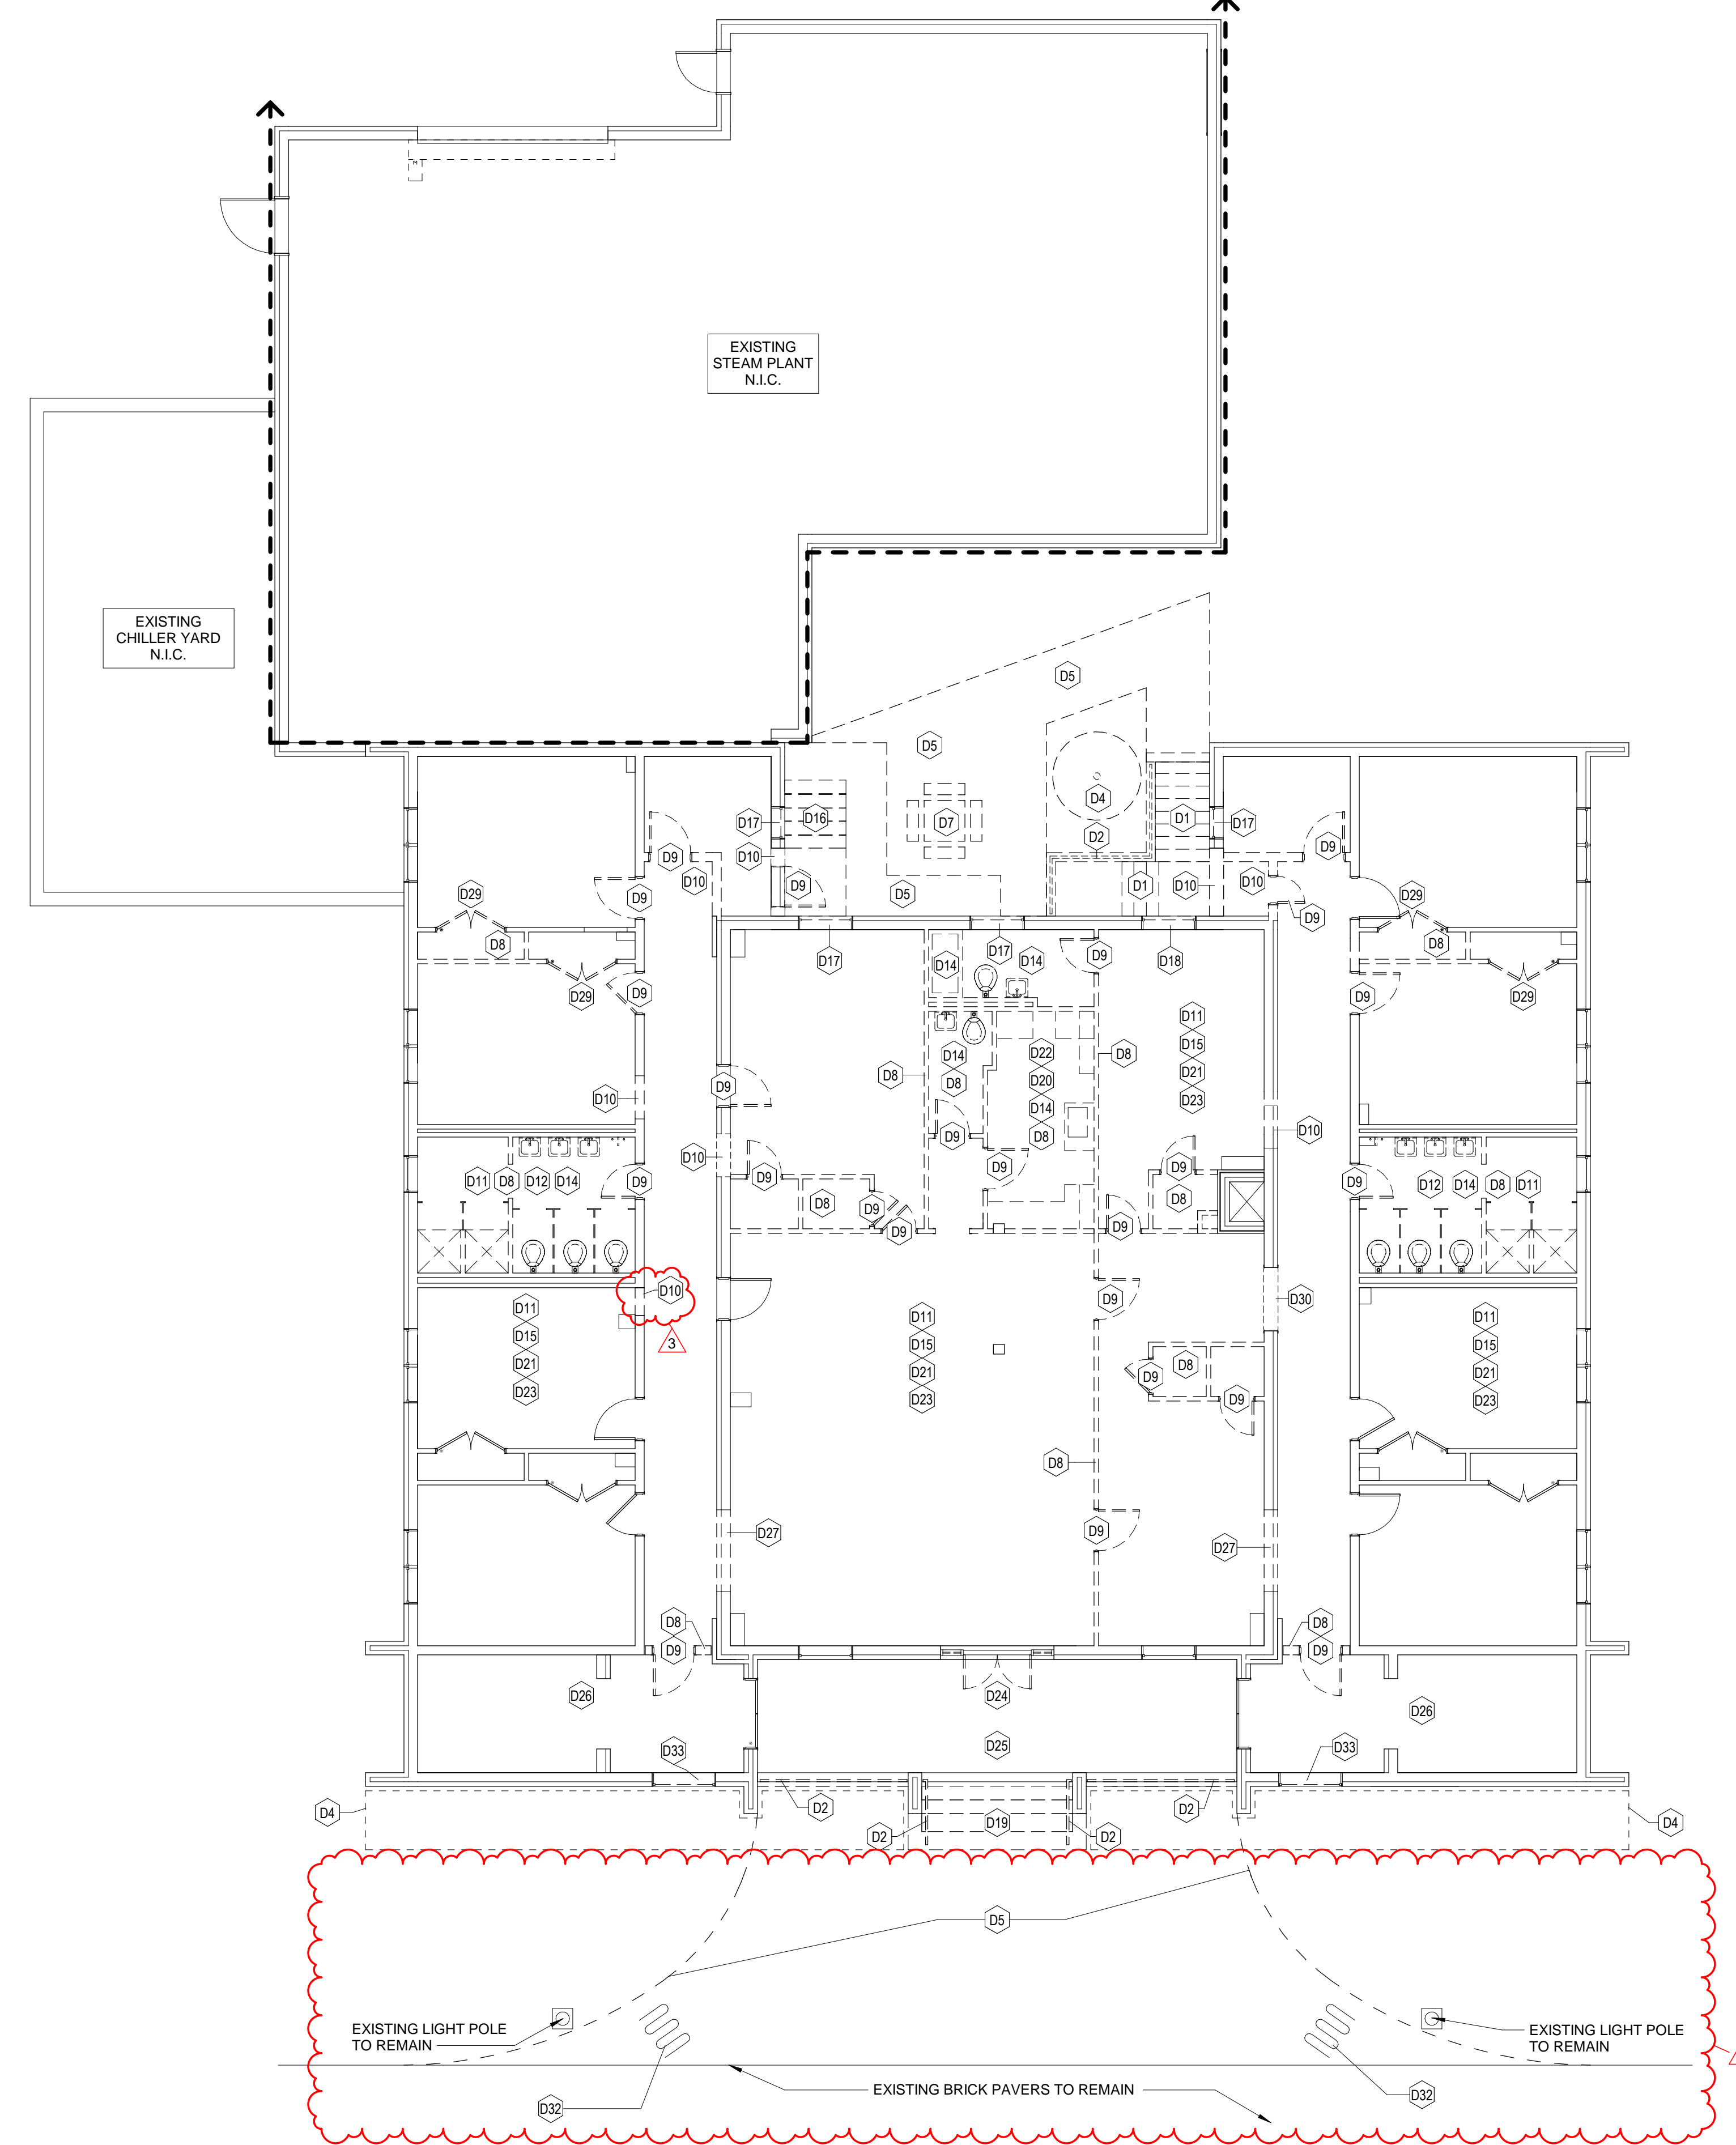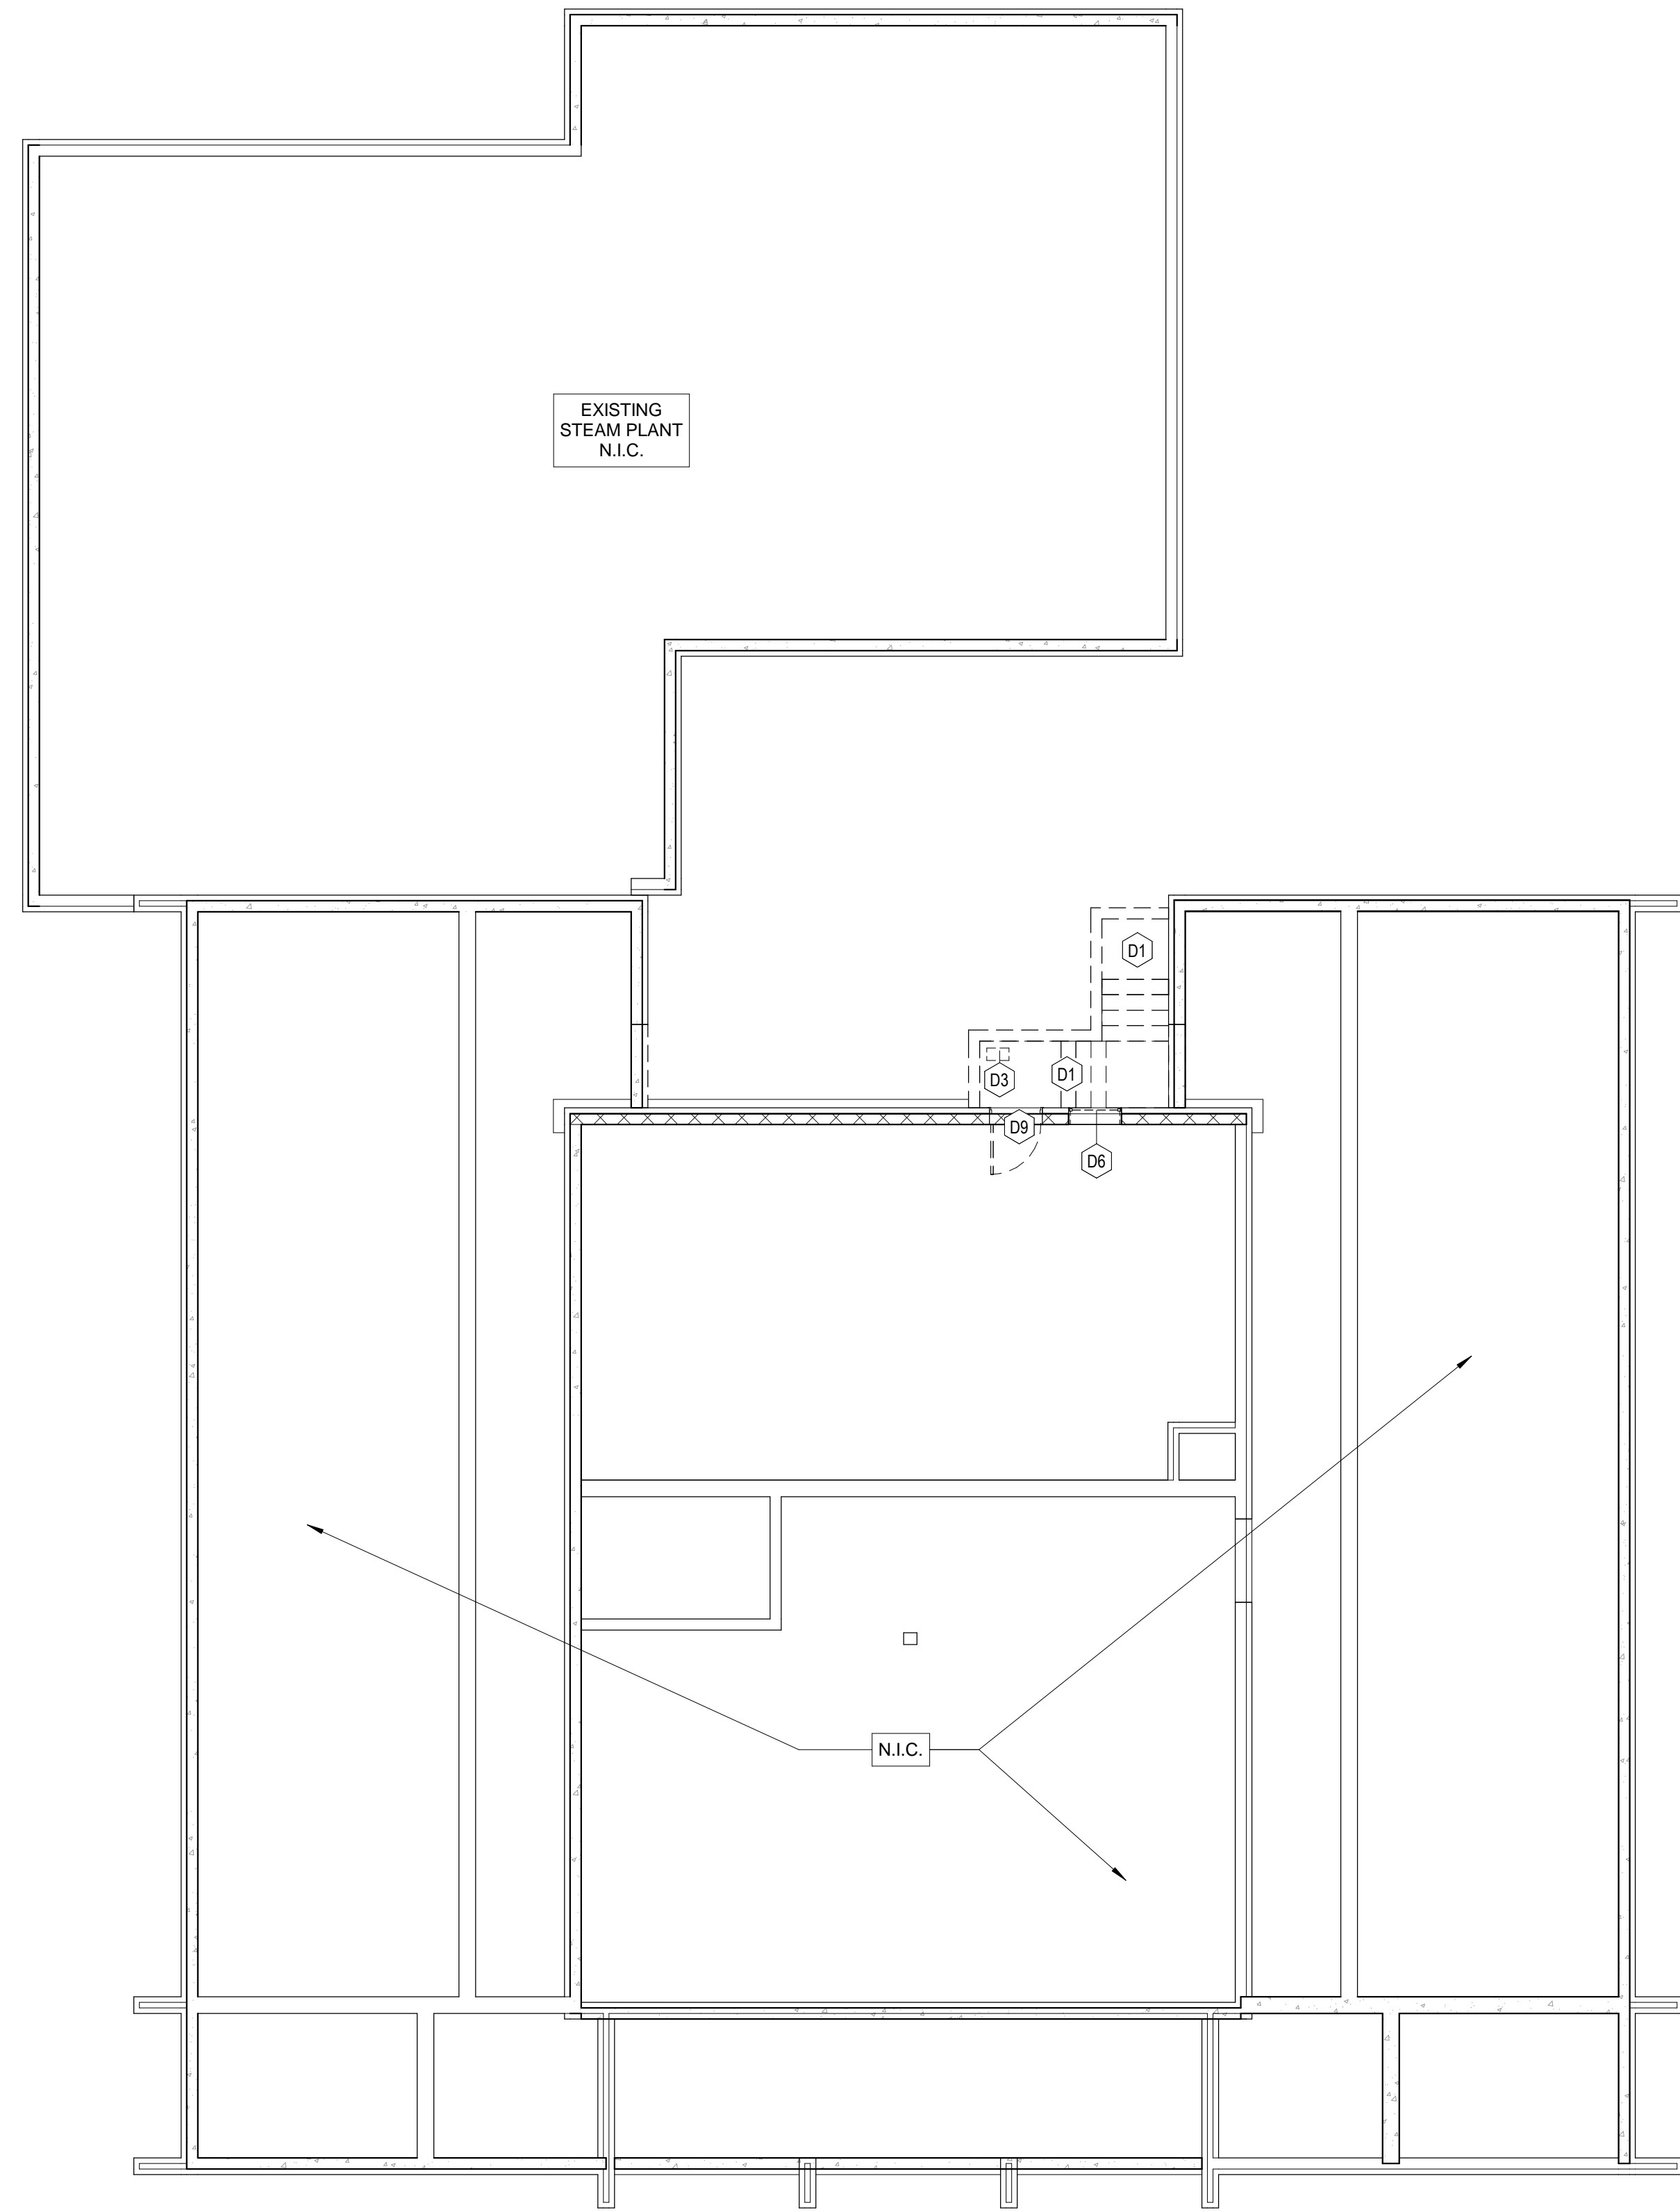

1A Level 0 - Demolition  
AD111 1/8" = 1'-0"

4A Level 1 - Demolition  
AD111 1/8" = 1'-0"

**LITTLE**  
DIVERSIFIED ARCHITECTURAL CONSULTING

410 Blackwell Street, Suite 10  
Durham, NC 27701  
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ISSUE FOR  
**Demolition Plans**

ISSUE DATE  
05.24.2018

NO.	REASON	DATE
1	Pricing Set	06.29.18
2	AV Revisions by Owner and Quality Control	08.20.18
3	Revisions by Owner	09.11.18

PROJECT TEAM  
PRINCIPAL IN CHARGE  
**ROB KLINE/DINST, AIA**  
PROJECT MANAGER  
**SHANE WEBSTER, AIA**

DESIGN TEAM  
**LITTLE**  
PROJECT NAME  
**CAMPBELL UNIVERSITY DAY HALL RENOVATIONS**

PROJECT NO.  
**513.9660.00**

SHEET TITLE  
**DEMOLITION FLOOR PLANS - LEVELS 0 AND 1**

SHEET NUMBER  
**AD111**

**LEGEND - DEMOLITION**

- EXISTING WALL TO REMAIN
- EXISTING CONSTRUCTION TO BE DEMOLISHED
- EXISTING DOOR TO REMAIN
- EXISTING DOOR TO BE DEMOLISHED
- EXISTING CASEWORK OR OTHER ITEM TO BE DEMOLISHED
- EXISTING WORK TO REMAIN

**GENERAL NOTES - DEMOLITION**

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**SHEET KEYNOTES**

D8	REMOVE EXISTING WALL(S)	D23	REMOVE EXISTING CEILING MECHANICAL DIFFUSERS THROUGHOUT UNLESS OTHERWISE NOTED. SEE MECHANICAL DRAWINGS.
D9	REMOVE EXISTING DOOR AND FRAME.	D29	REMOVE EXISTING DOORS AND FRAME. STORE DOORS FOR POSSIBLE RELOCATION.
D10	REMOVE PORTION OF EXISTING CMU AND/OR CMU/BRICK WALL AS REQUIRED FOR NEW CONSTRUCTION. SEE STRUCTURAL DRAWINGS.	D31	REMOVE EXISTING ASPHALT SHINGLES. PREPARE FOR NEW SHINGLES.
D11	REMOVE EXISTING PLASTER CEILING SYSTEM THROUGHOUT UNLESS OTHERWISE NOTED.		
D12	REMOVE EXISTING TOILET PARTITIONS AND DOORS.		
D14	REMOVE EXISTING PLUMBING FIXTURES. SEE PLUMBING DRAWINGS.		
D15	REMOVE EXISTING CEILING LIGHT FIXTURES AND FIRE ALARM DEVICES THROUGHOUT UNLESS OTHERWISE NOTED. SEE ELECTRICAL AND FIRE ALARM DRAWINGS.		
D17	REMOVE EXISTING WINDOW AND CAST STONE SILL.		
D18	REMOVE EXISTING WINDOW AND CAST STONE SILL. STORE WINDOW FOR RELOCATION.		
D21	REMOVE EXISTING FLOOR FINISH THROUGHOUT UNLESS OTHERWISE NOTED. PREPARE FOR NEW FINISH.		


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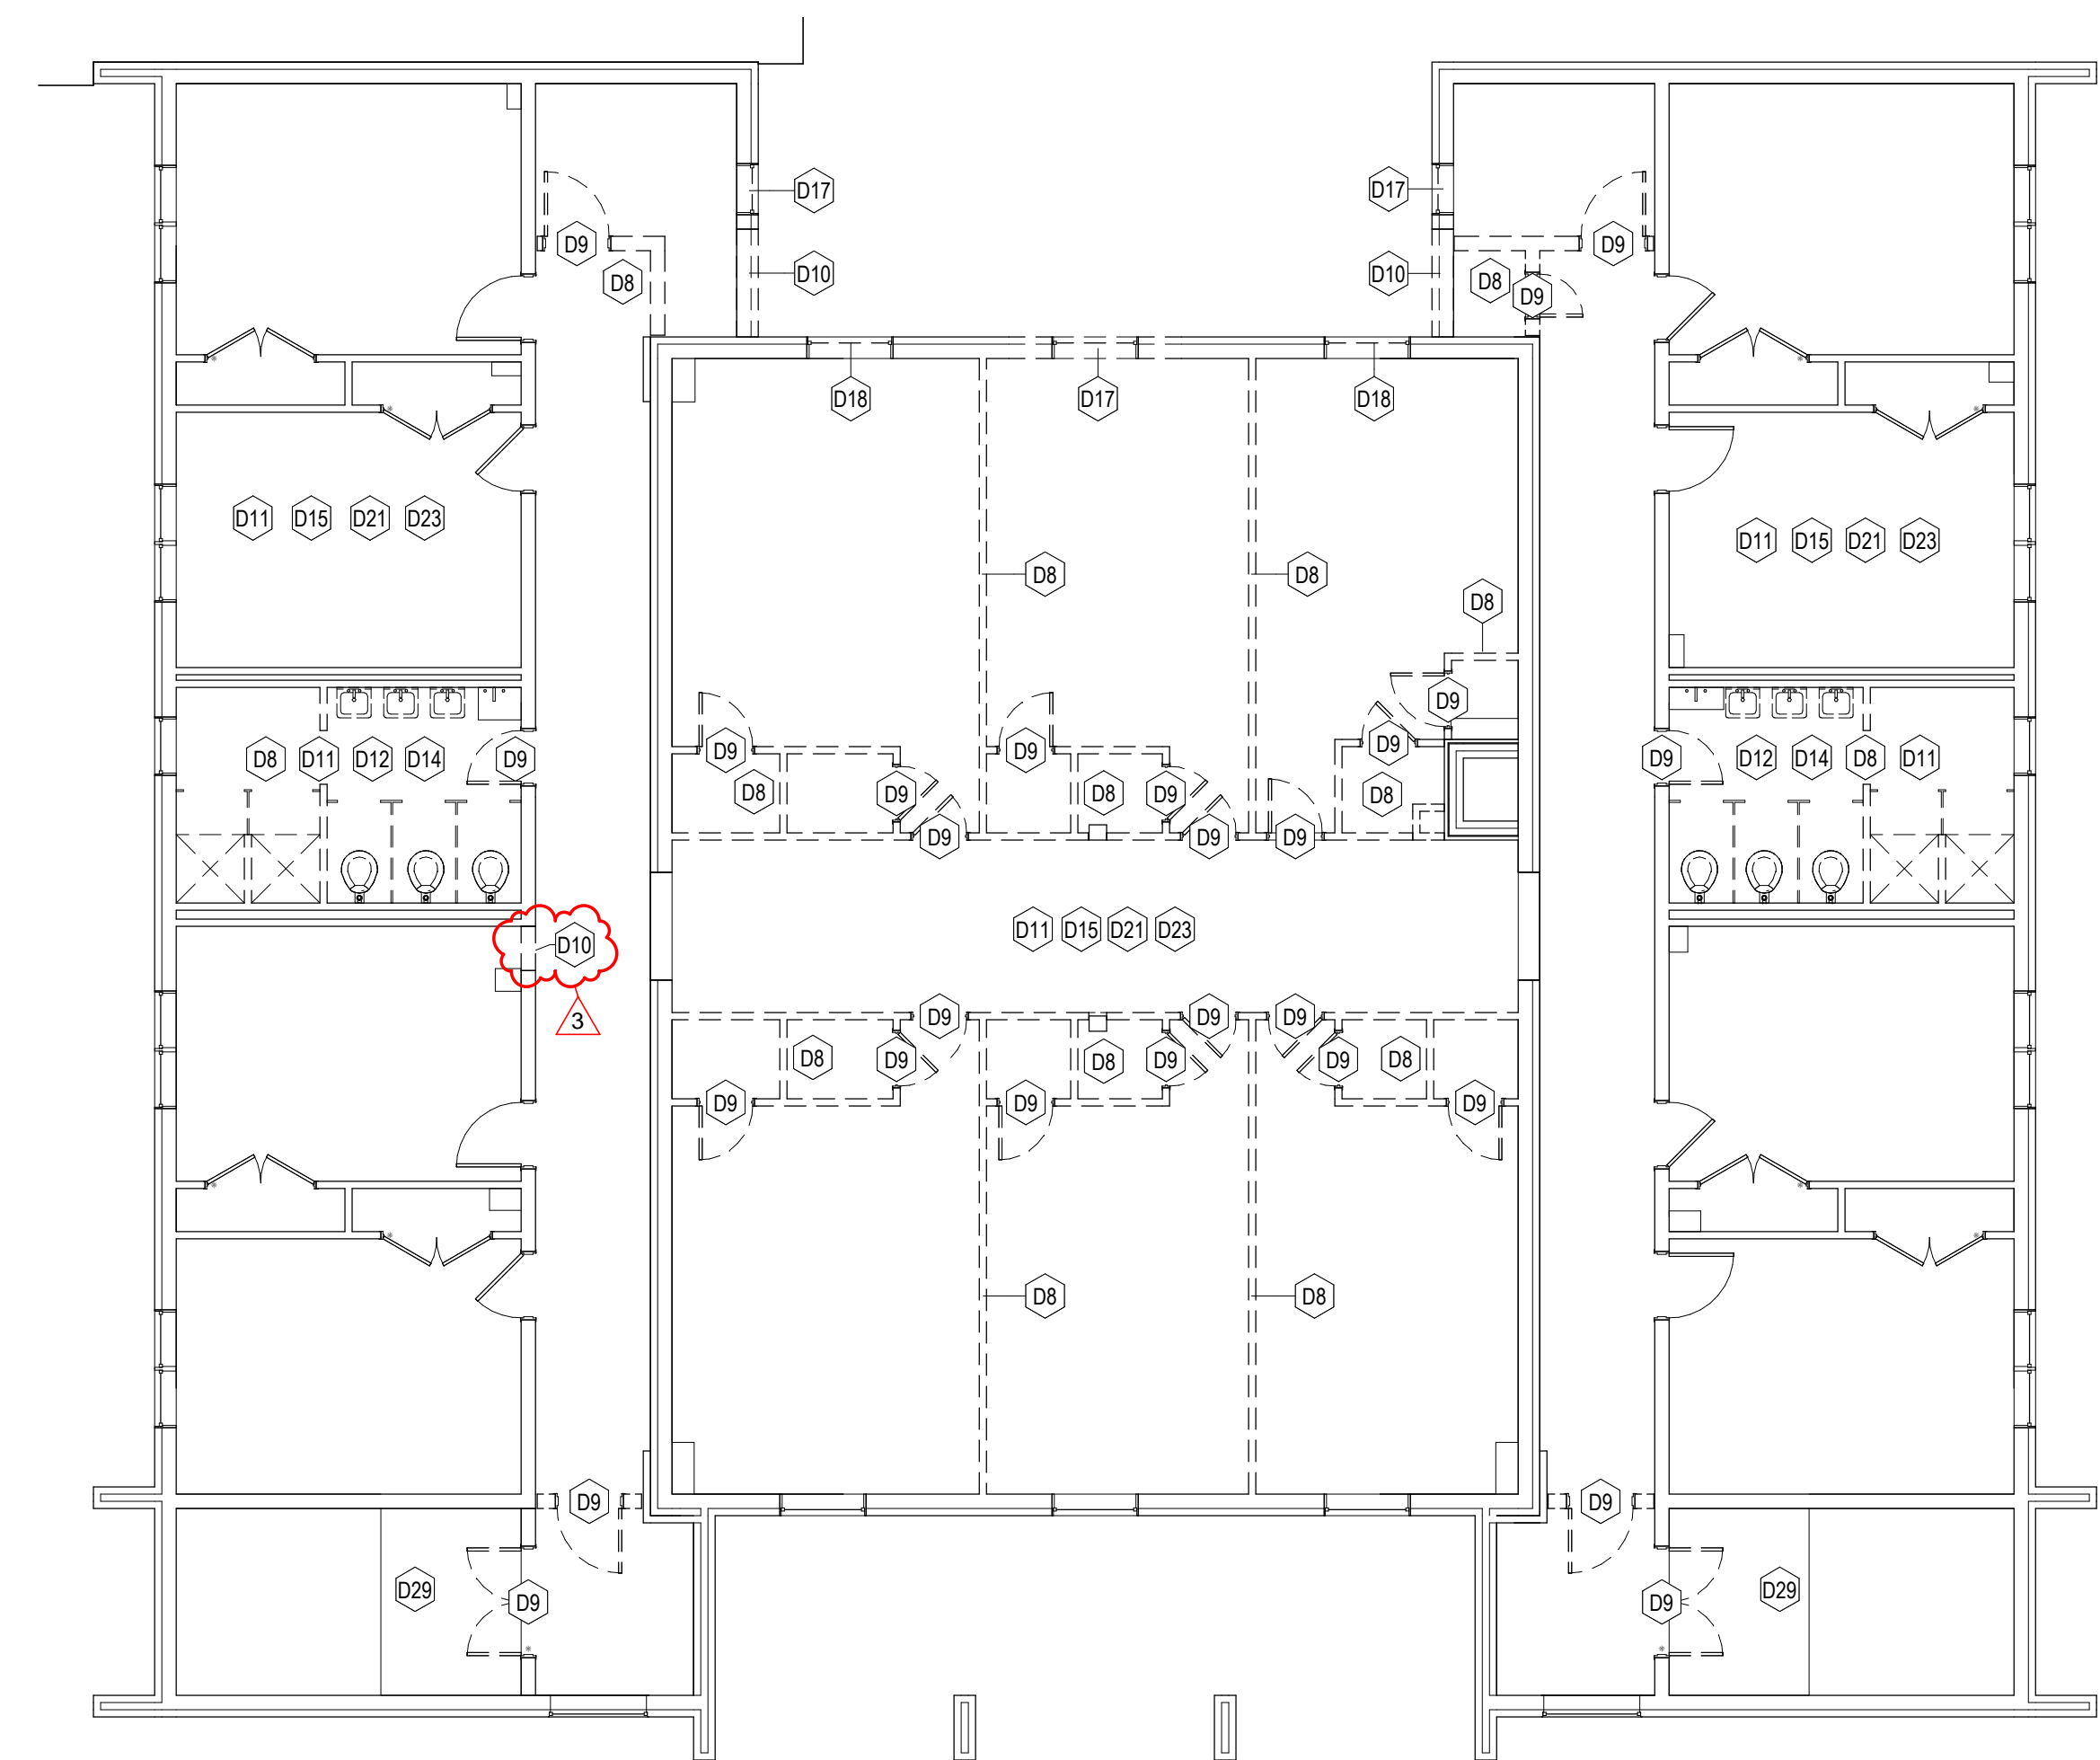
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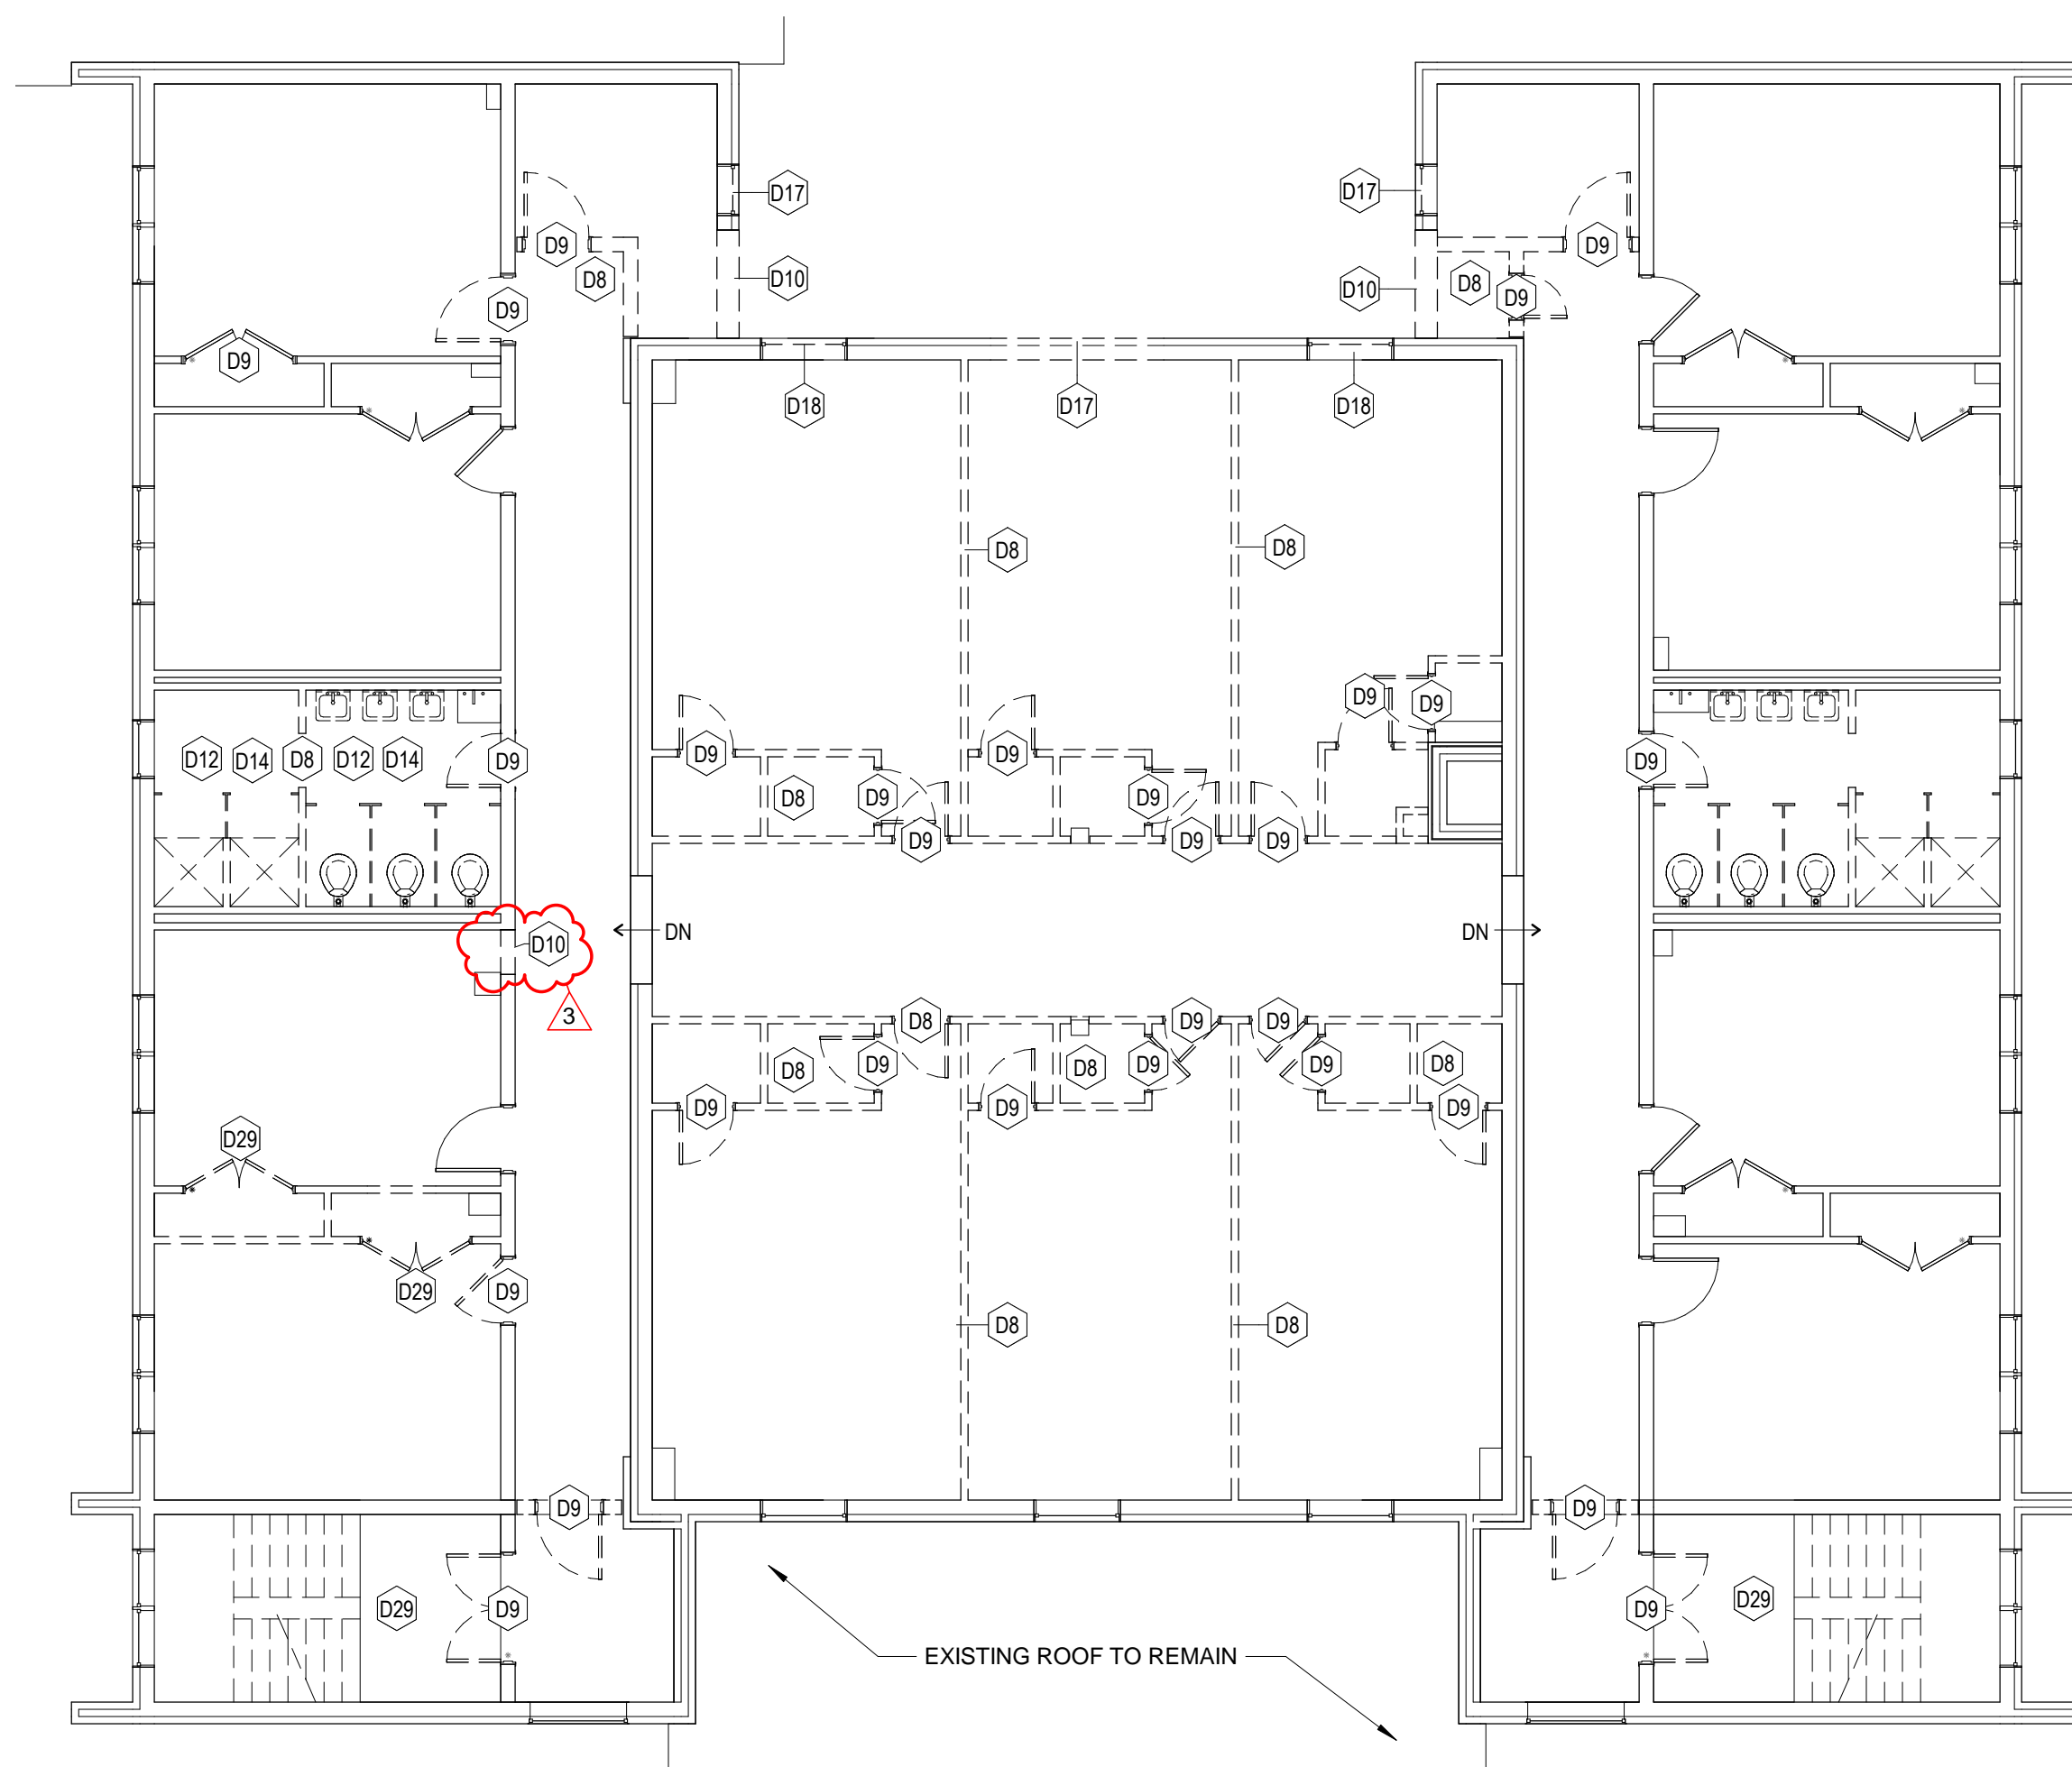
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**4C Roof Plan - Demolition**  
AD112 1/8" = 1'-0"



**1A Level 2 - Demolition**  
AD112 1/8" = 1'-0"



**4A Level 3 - Demolition**  
AD112 1/8" = 1'-0"

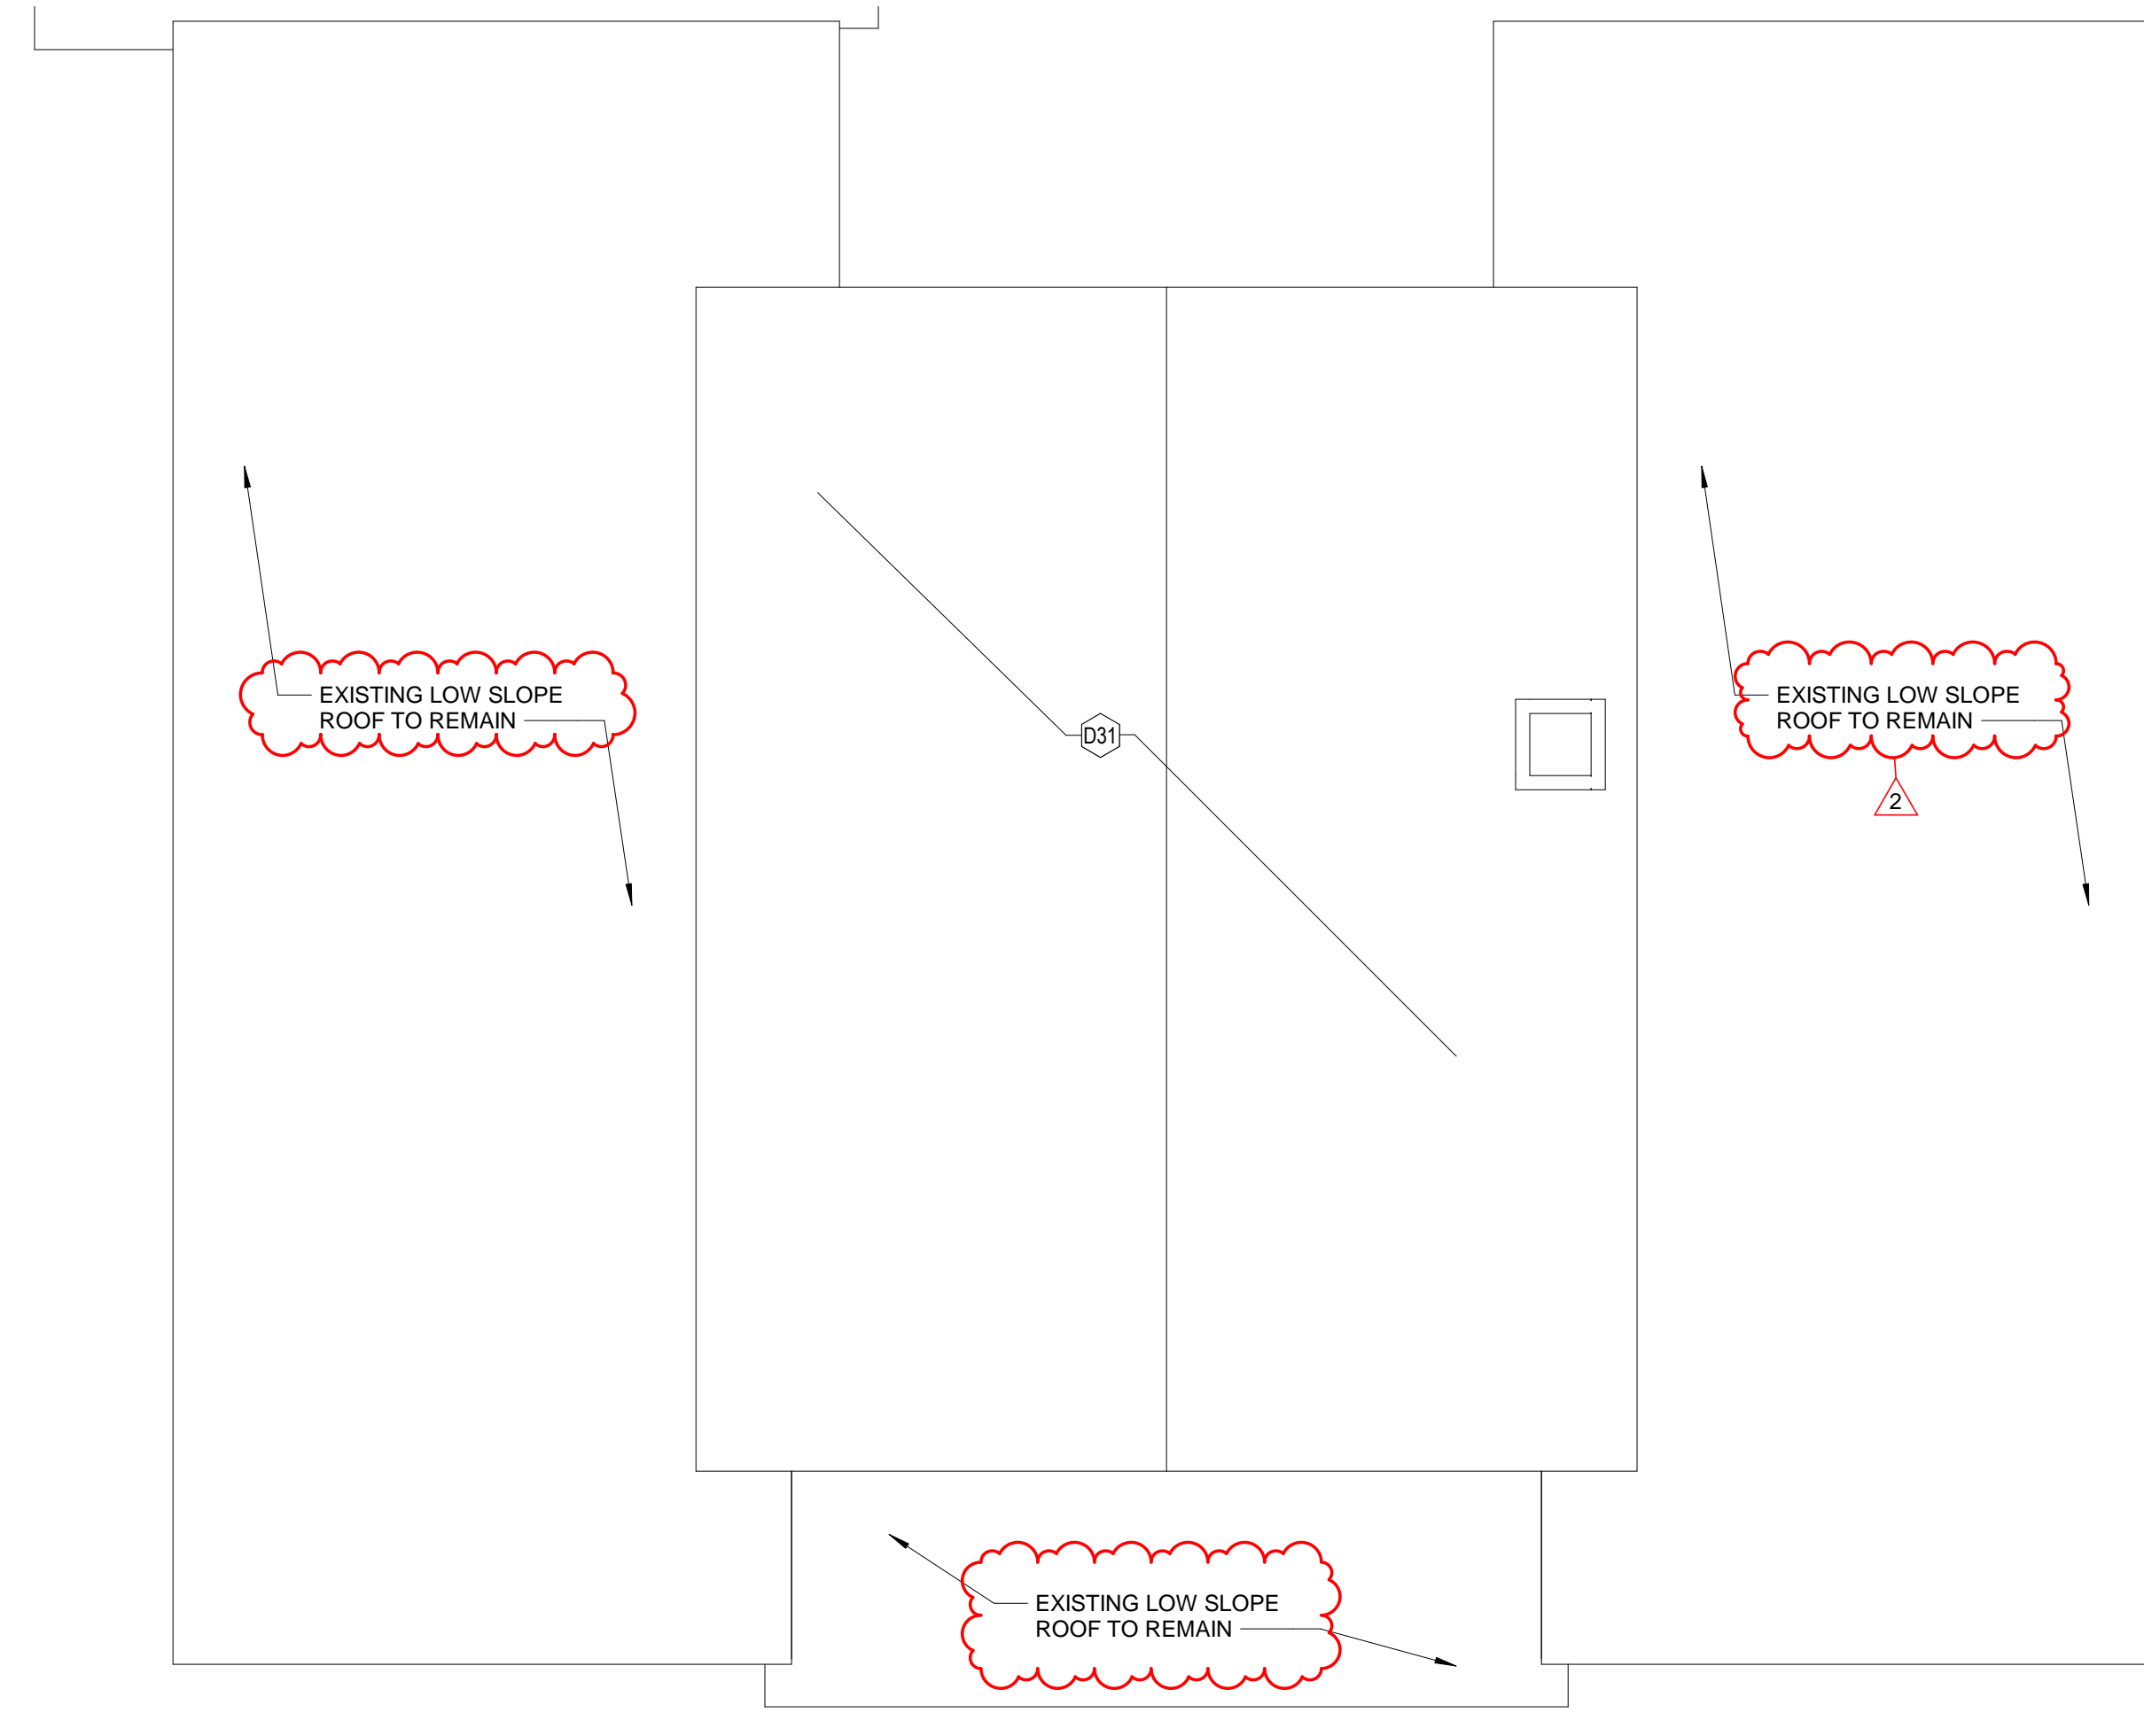

ISSUE FOR  
**Demolition Plans**

ISSUE DATE  
**05.24.2018**

NO.	REASON	DATE
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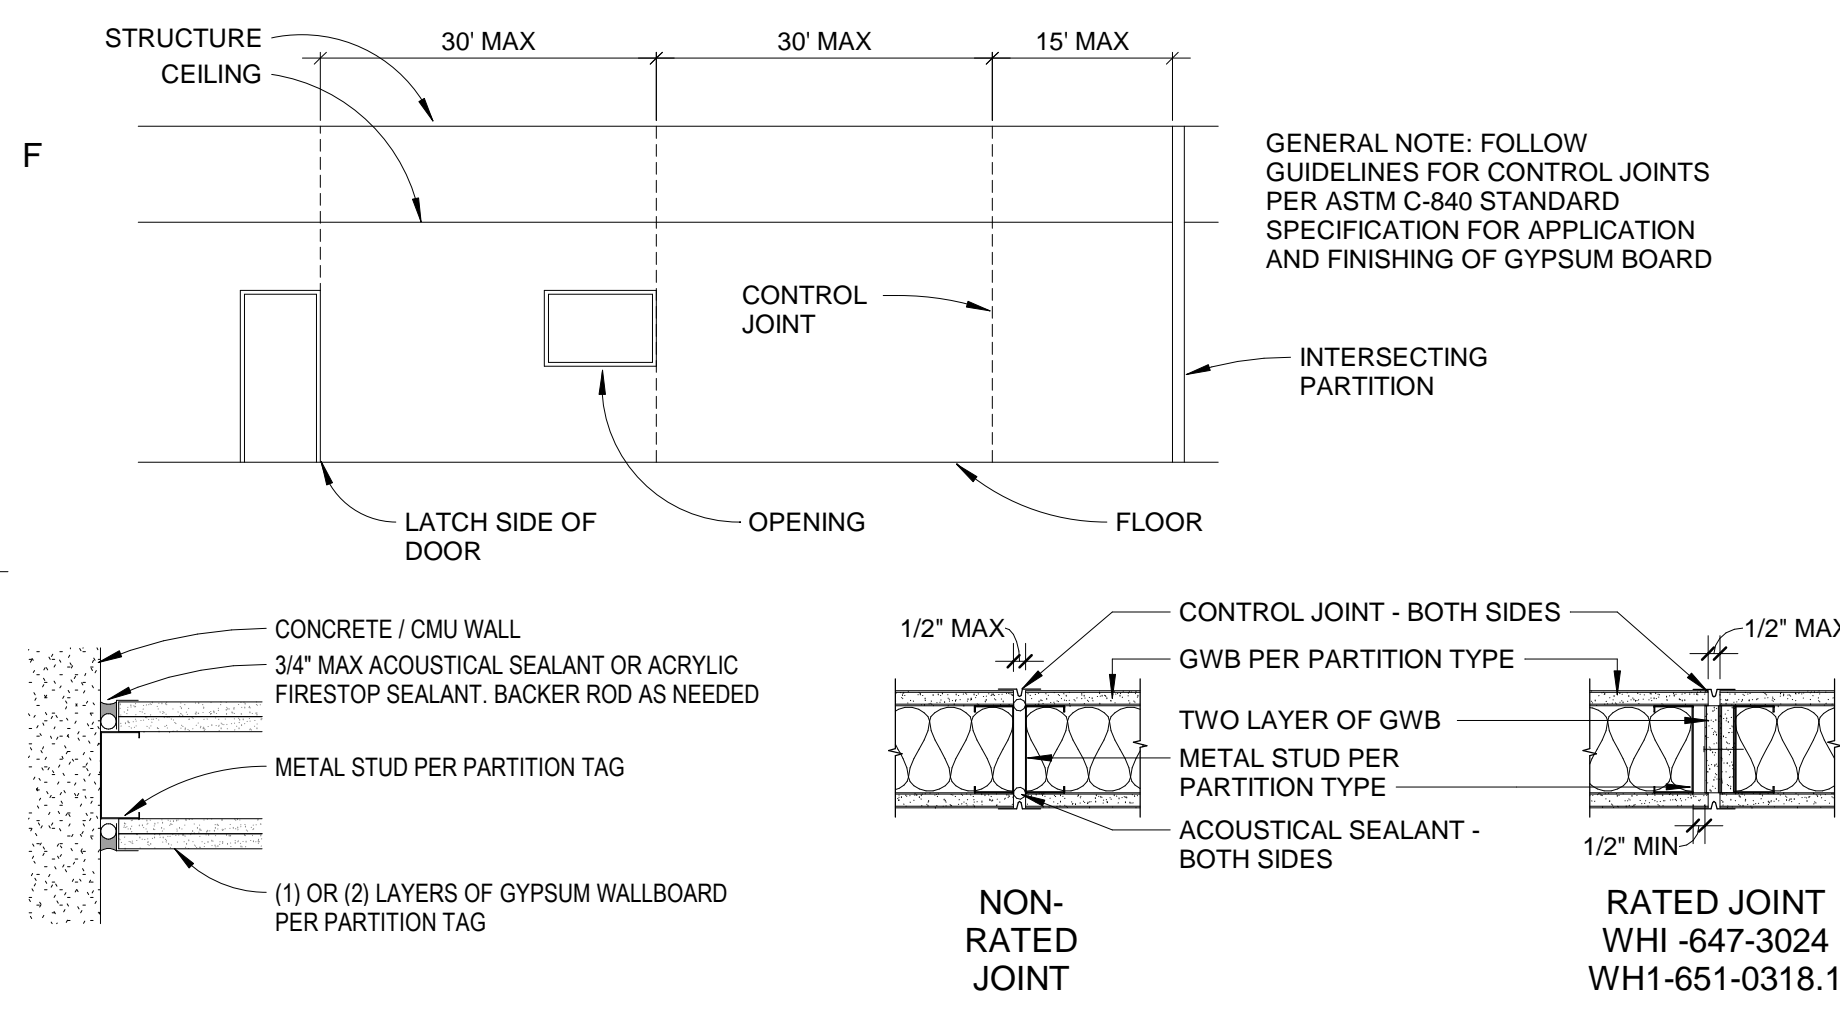
PROJECT NO.  
**513.9660.00**

SHEET TITLE  
**DEMOLITION FLOOR PLANS - LEVELS 2 AND 3. DEMOLITION ROOF PLAN**

SHEET NUMBER  
**AD112**

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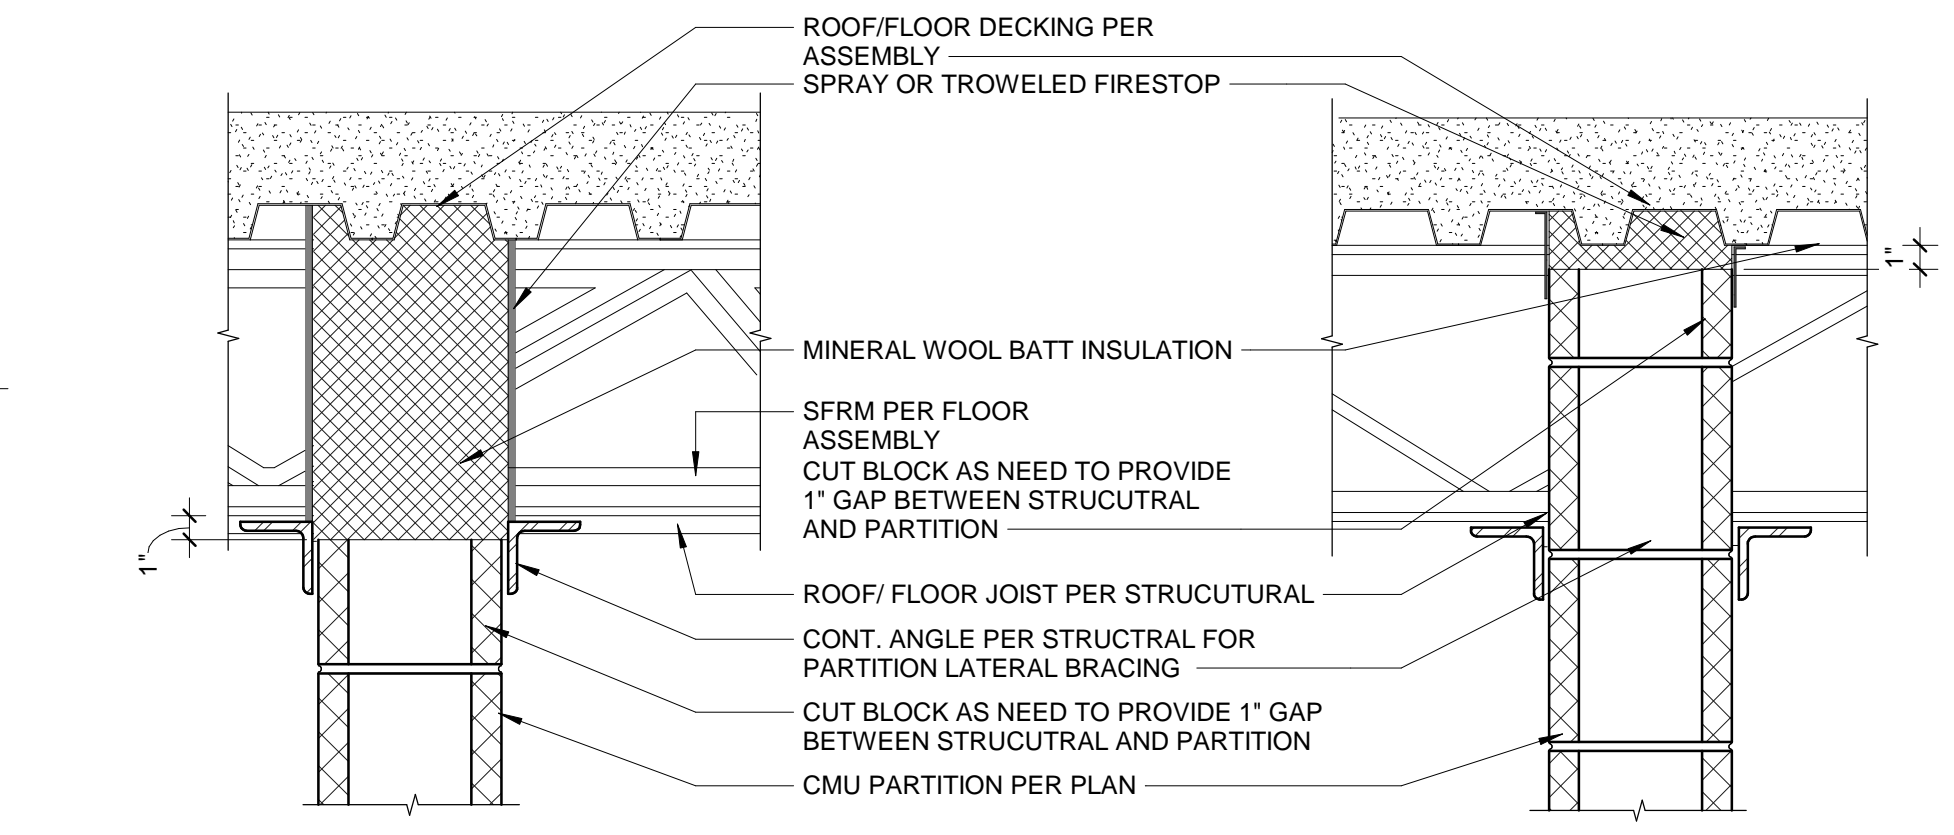
**GWB CONTROL JOINTS**



GENERAL NOTE: FOLLOW GUIDELINES FOR CONTROL JOINTS PER ASTM C-840 STANDARD SPECIFICATION FOR APPLICATION AND FINISHING OF GYPSUM BOARD


CONTROL JOINT - BOTH SIDES  
GWB PER PARTITION TYPE  
TWO LAYER OF GWB  
METAL STUD PER PARTITION TYPE  
ACOUSTICAL SEALANT - BOTH SIDES  
1/2" MIN  
CONTROL JOINT - RATED JOINT  
WHI-647-3024  
WHI-651-0318.1

**CMU HEAD CONDITIONS**




**CMU PARTITION RATED HEAD DETAIL AT JOIST / BEAM**

**HEAD - CMU - PARALLEL TO DECKING**

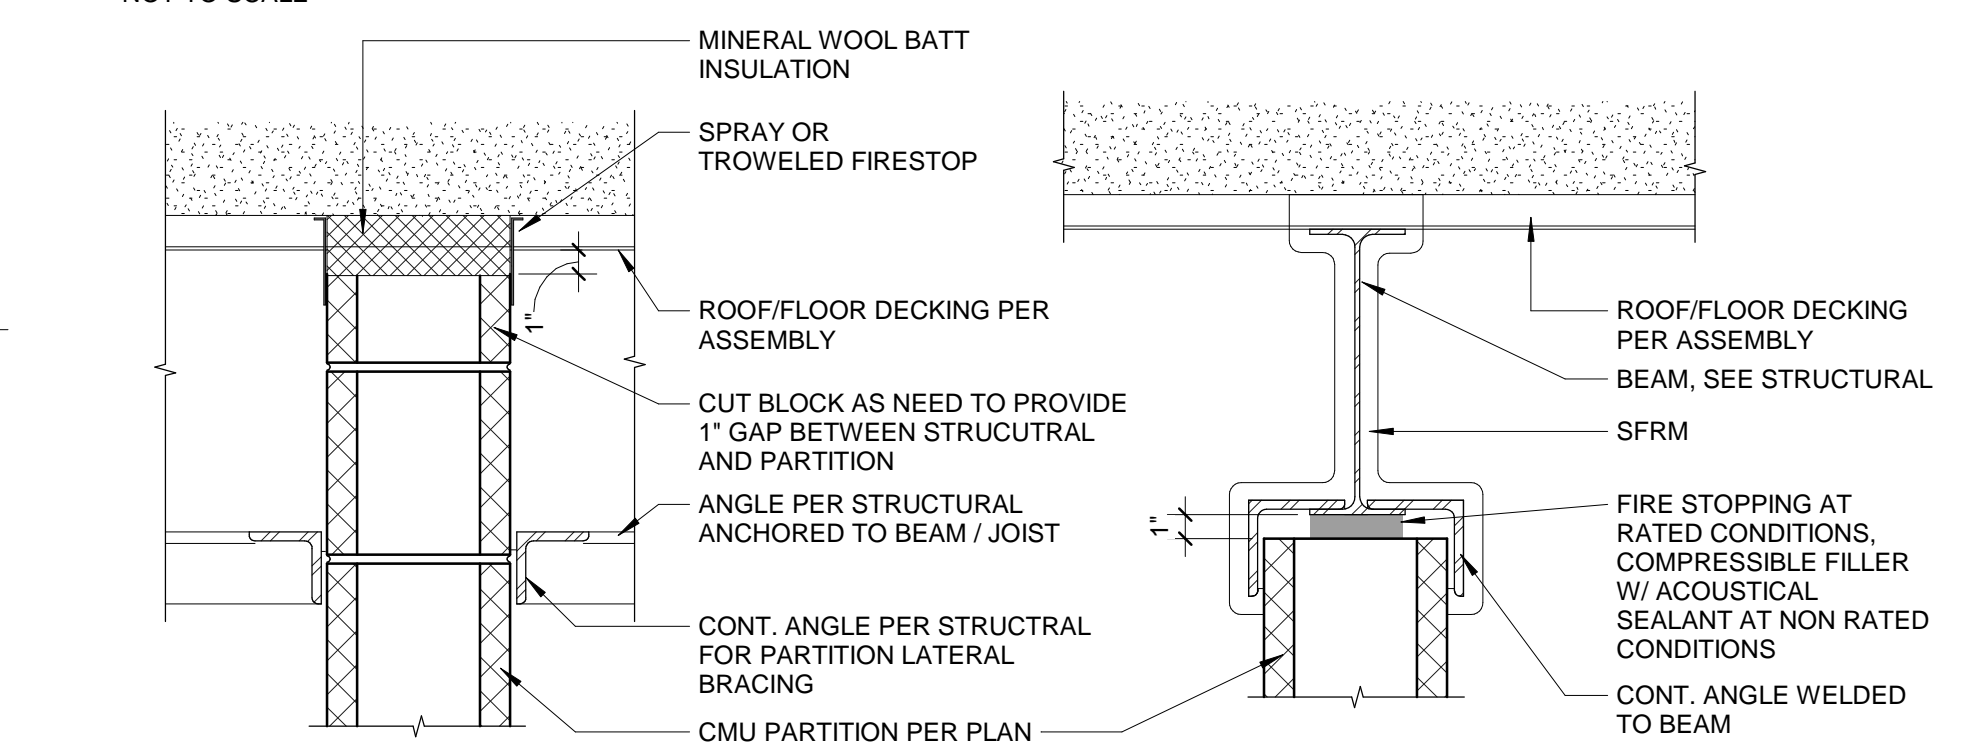

**CMU PARTITION RATED HEAD DETAIL AT JOIST / BEAM**

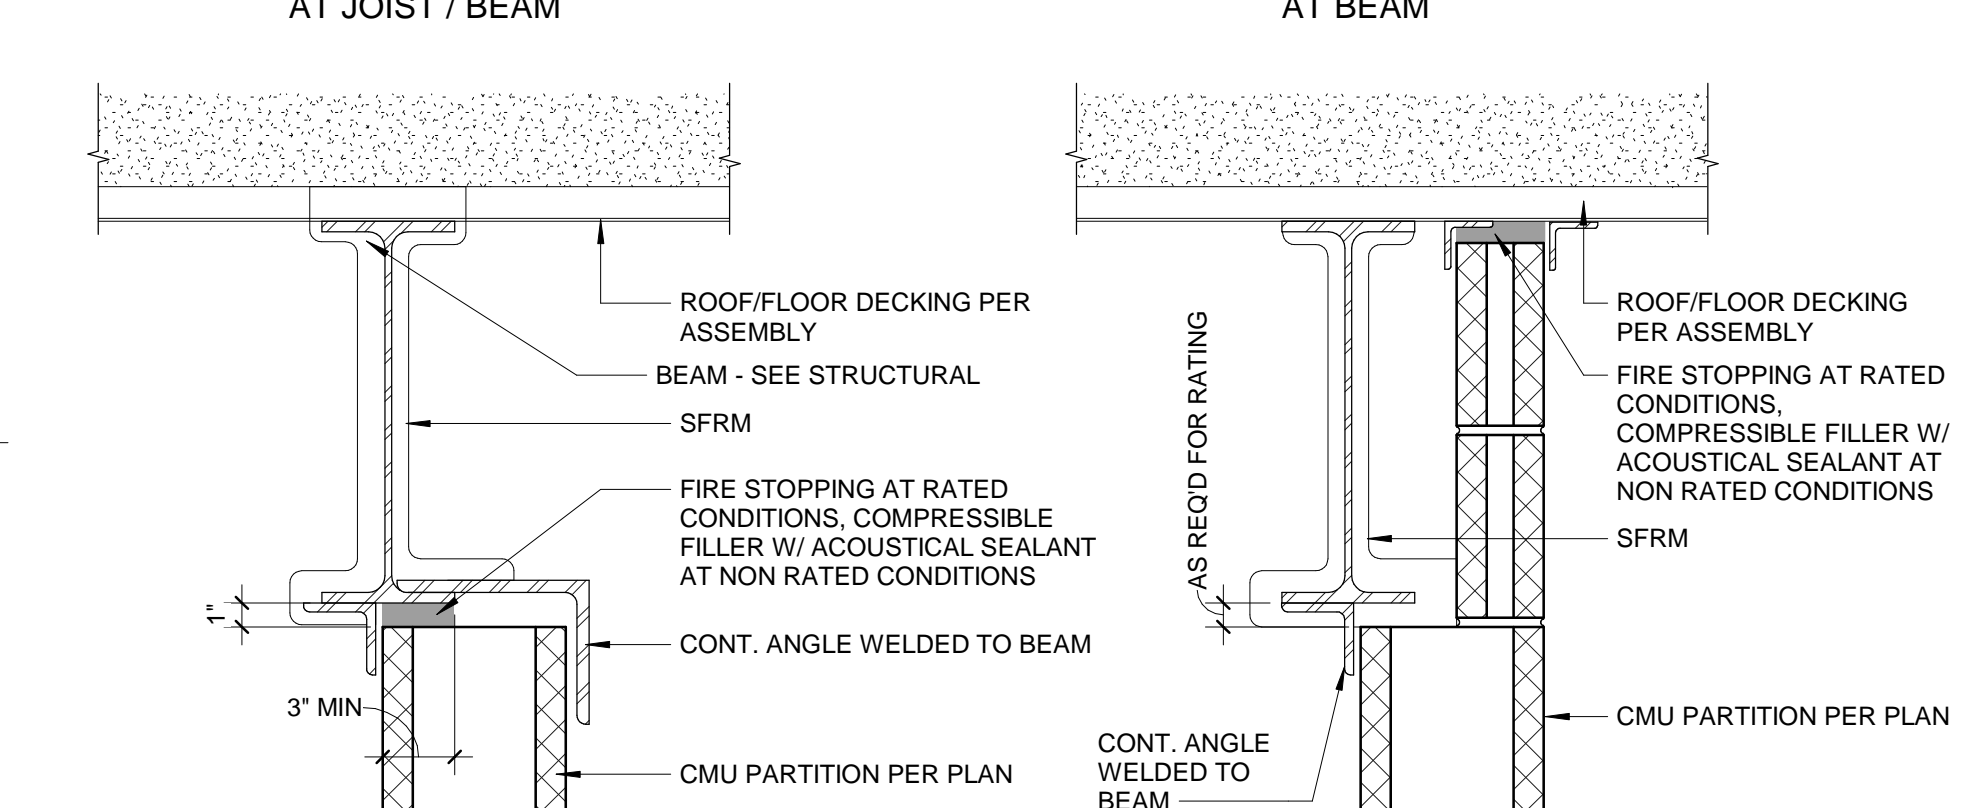


**CMU PARTITION HEAD DETAIL OFFSET UNDER BEAM**

**HEAD - CMU RATED - PERPENDICULAR TO DECKING**




**GWB PARTITION, DEFLECTION TRACK**

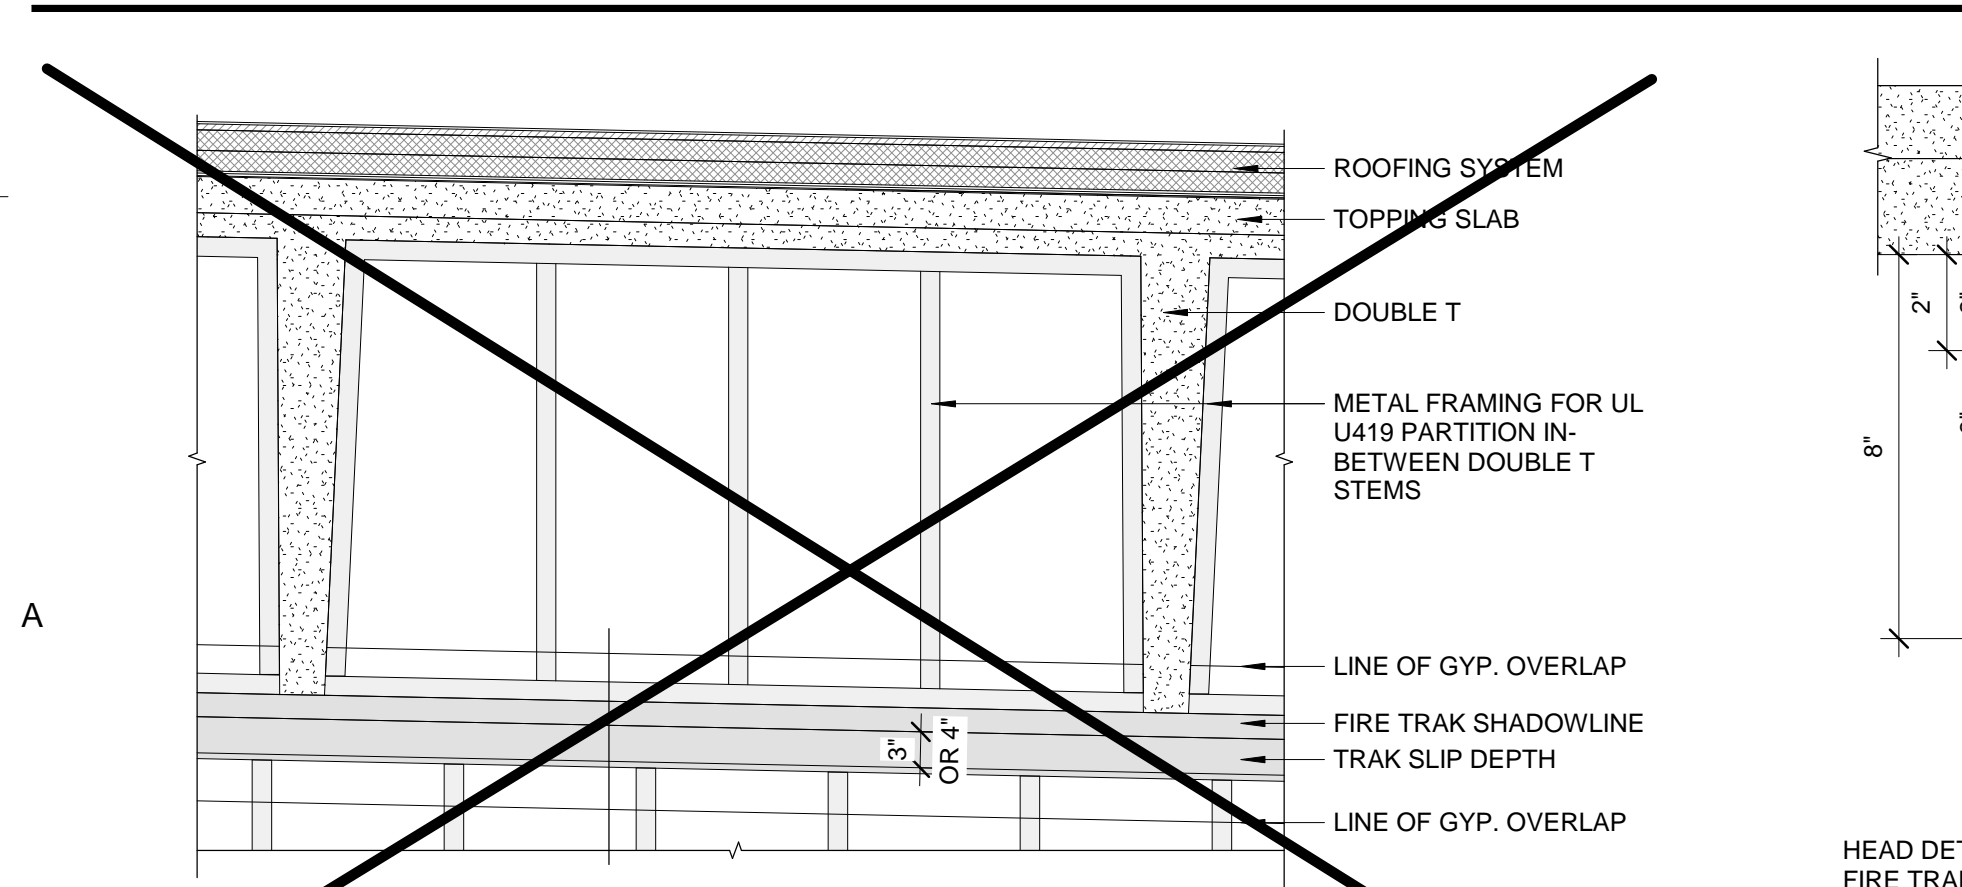


**HEAD OF WALL FRAMING - PRECAST T / DOUBLE-T**

**CMU CONTROL JOINTS**

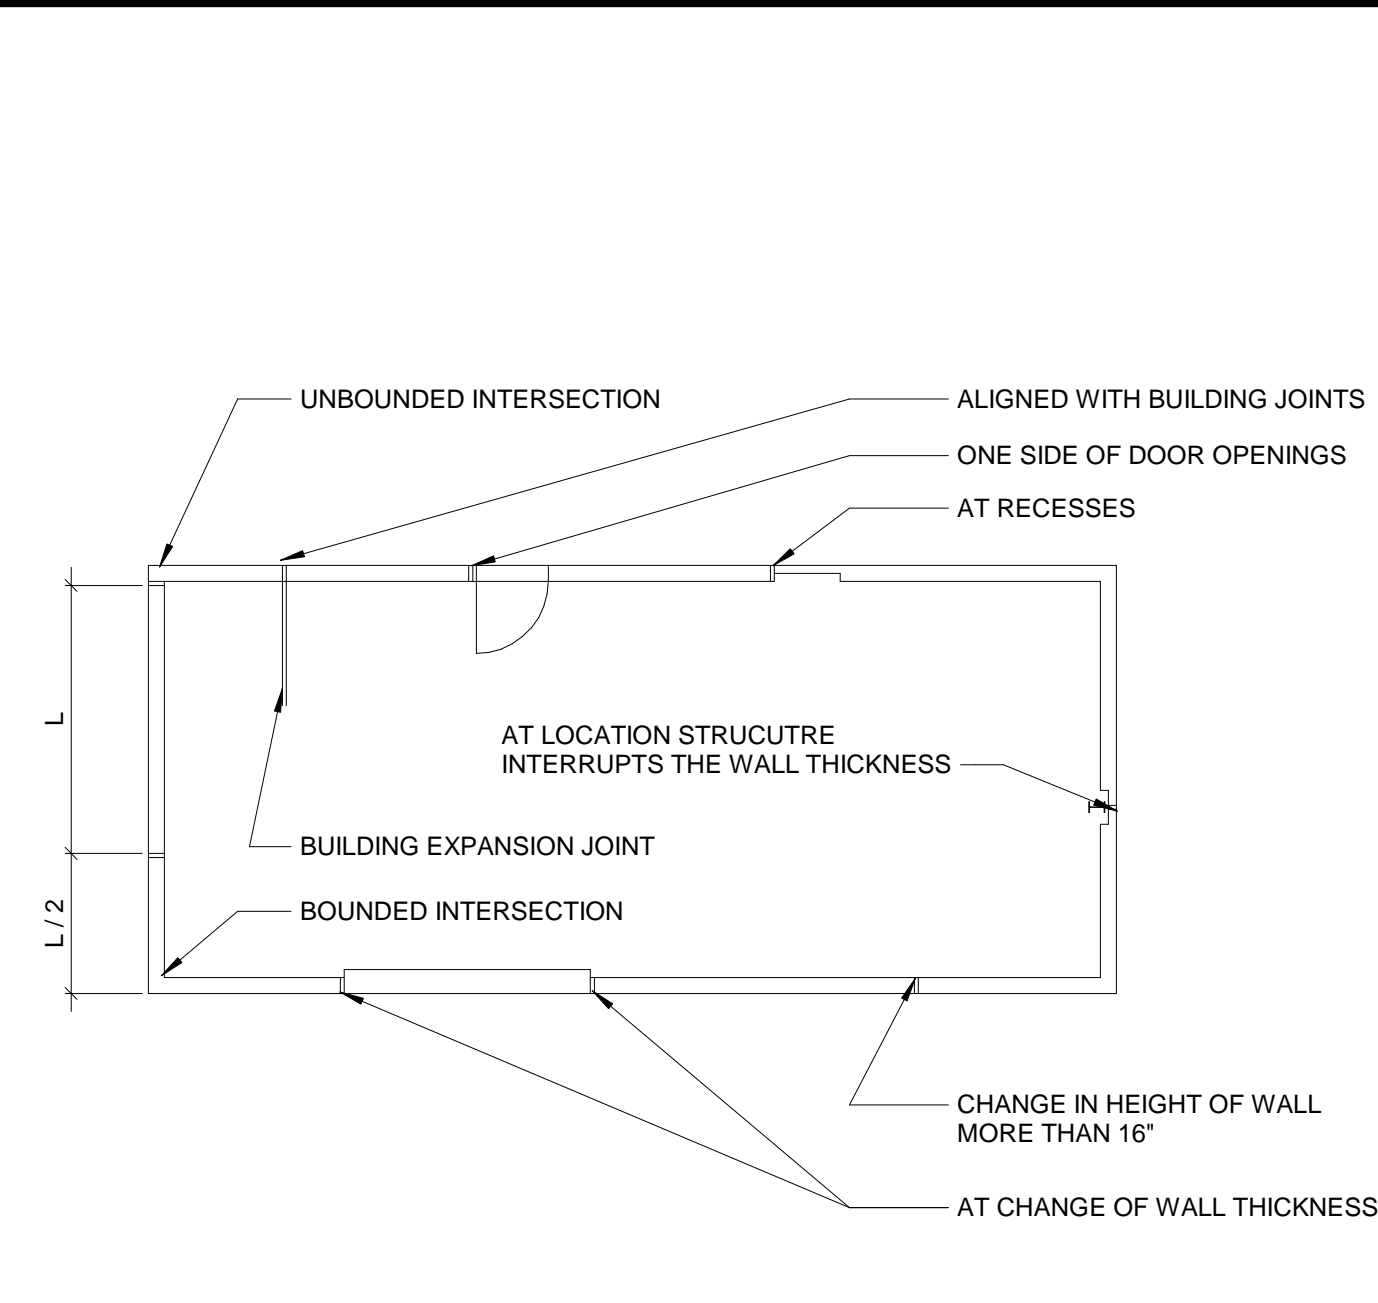


PROVIDE CONTROL JOINTS IN CMU PARTITION AS NOTED ABOVE AND AT MAXIMUM SPACING OF L = 24" MAX OR 3 TIMES THE HEIGHT OF THE PARTITION


**GWB HEAD CONDITIONS**

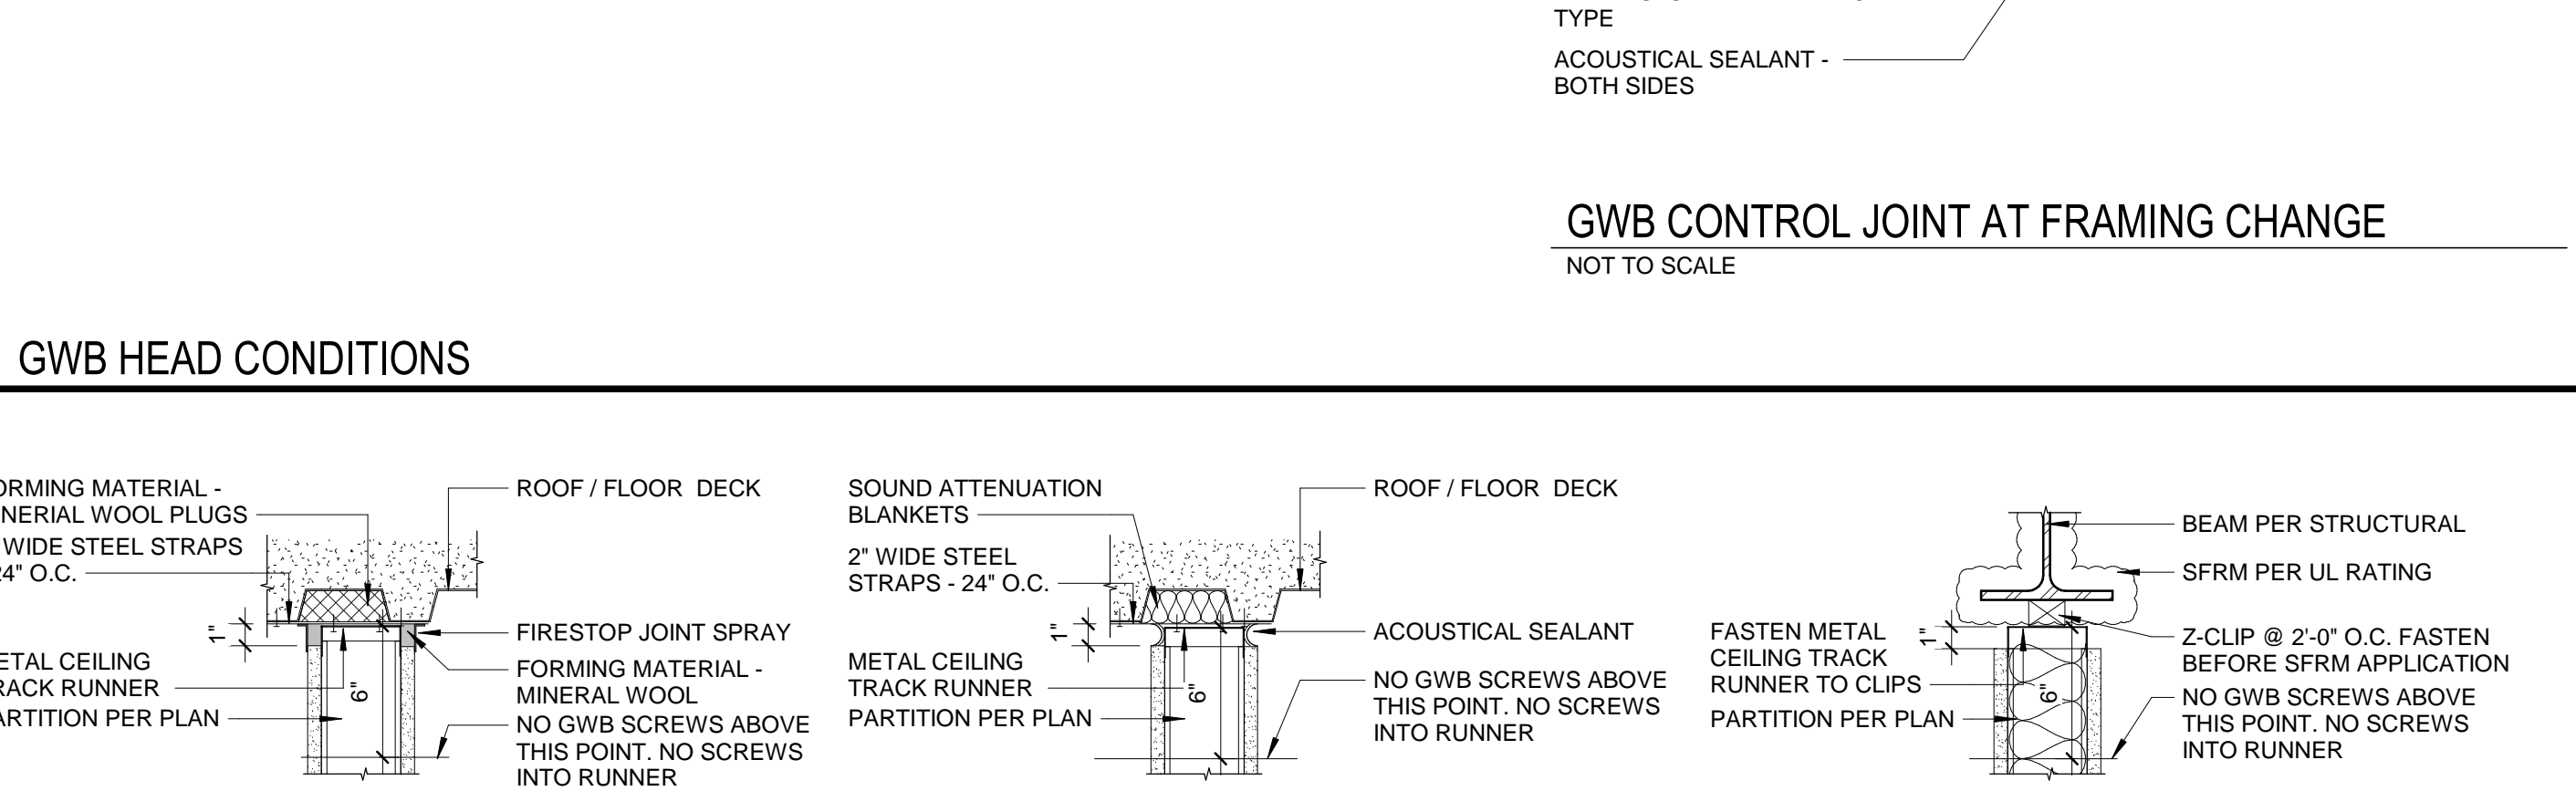


**HEAD - GWB - PARALLEL TO DECKING**

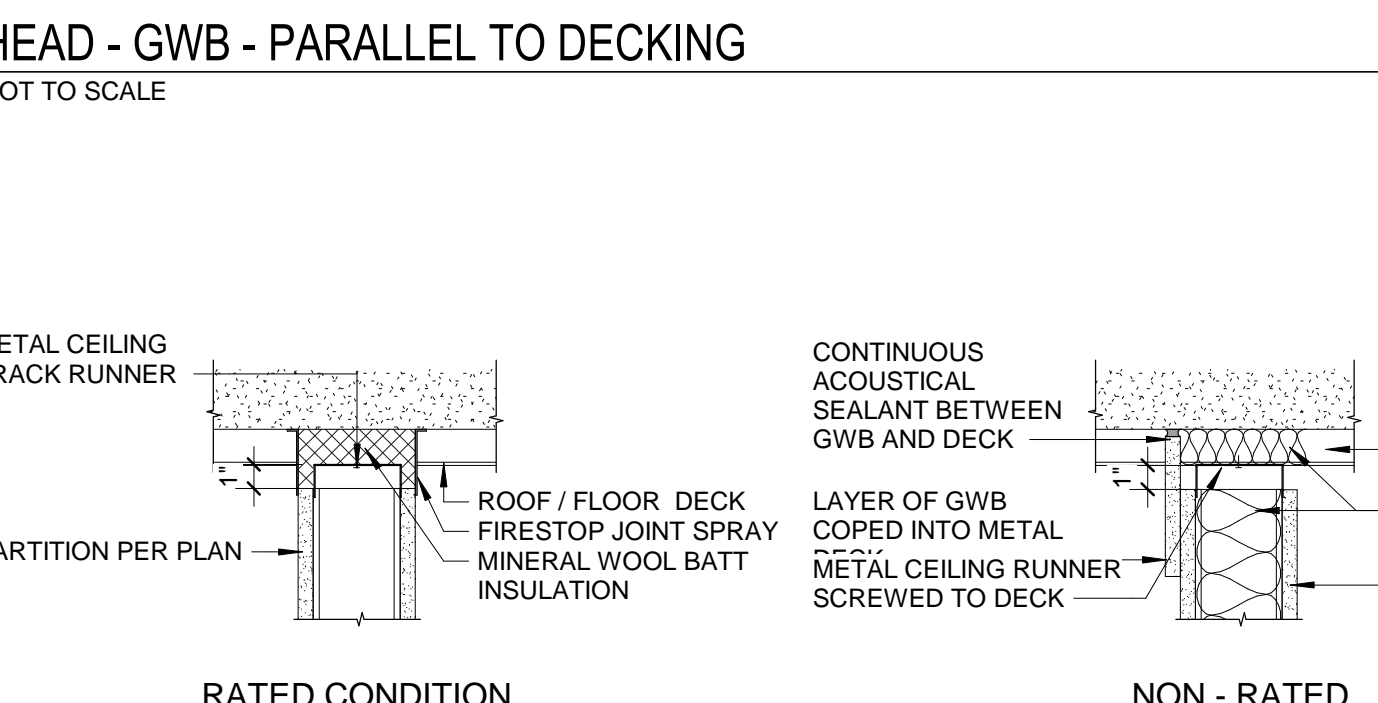

**HEAD - GWB - PERPENDICULAR TO DECK - COND. A**

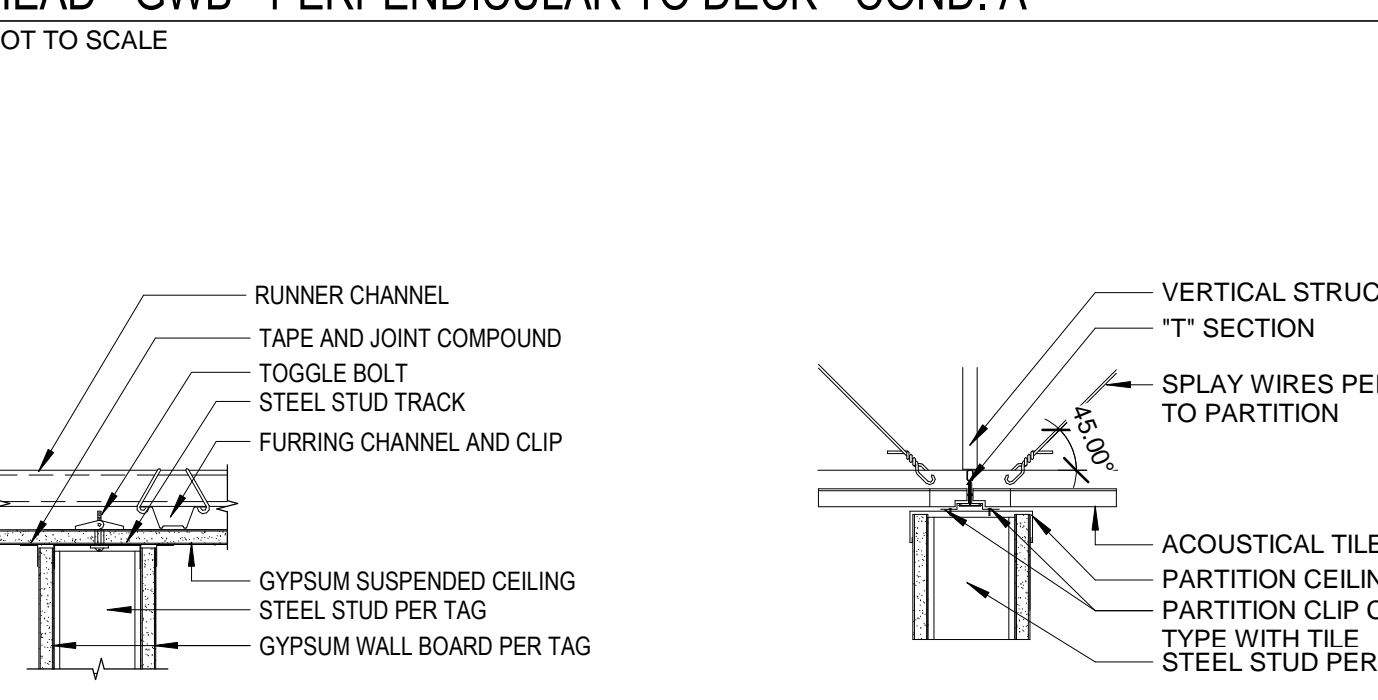


**HEAD - GWB - COND. B(2)**

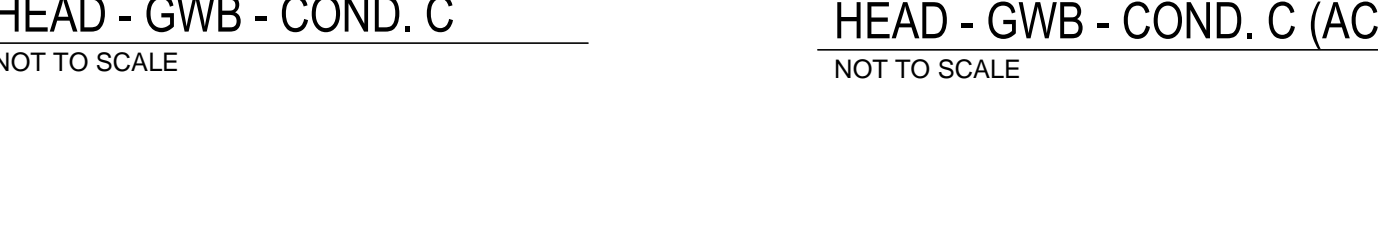


**HEAD - GWB - COND. B(1)**




**FIRE EXTINGUISHER CABINET**

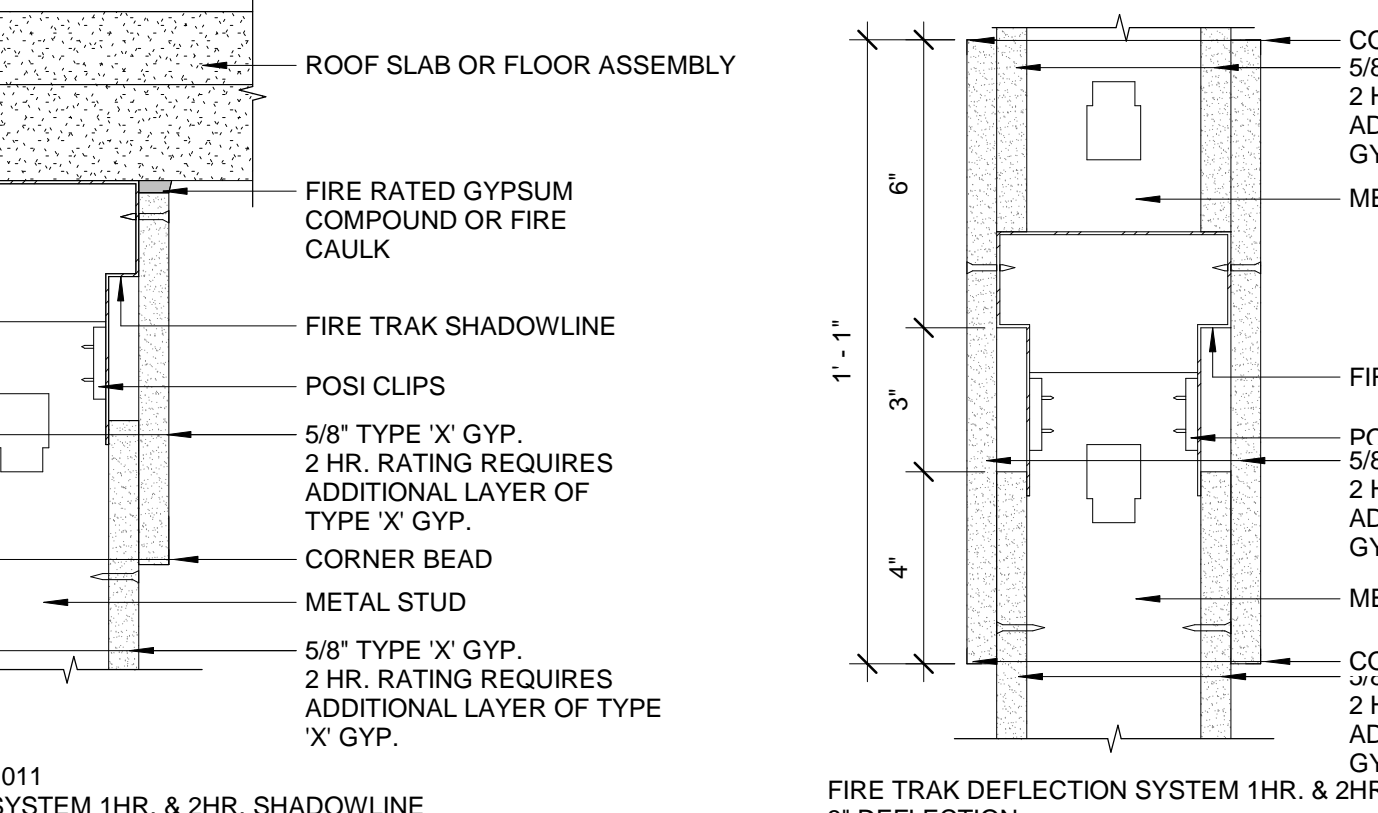

**HEAD DETAIL - DEFLECTION TRACK**

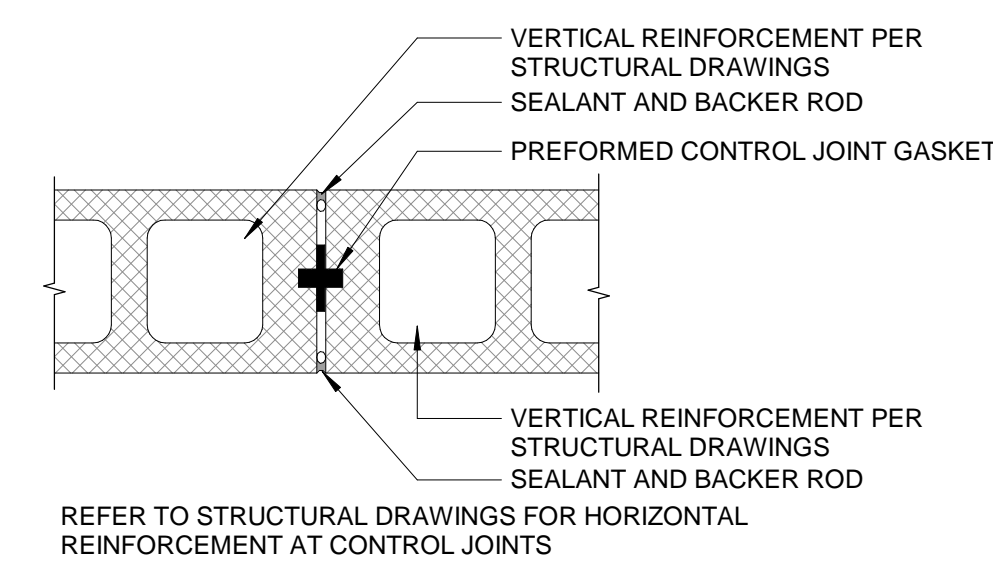


**CONTROL JOINT - CMU**

















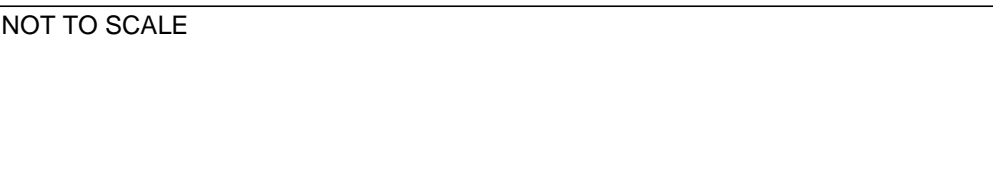


**GWB CONTROL JOINT AT FRAMING CHANGE**

**PARTITION TYPES**

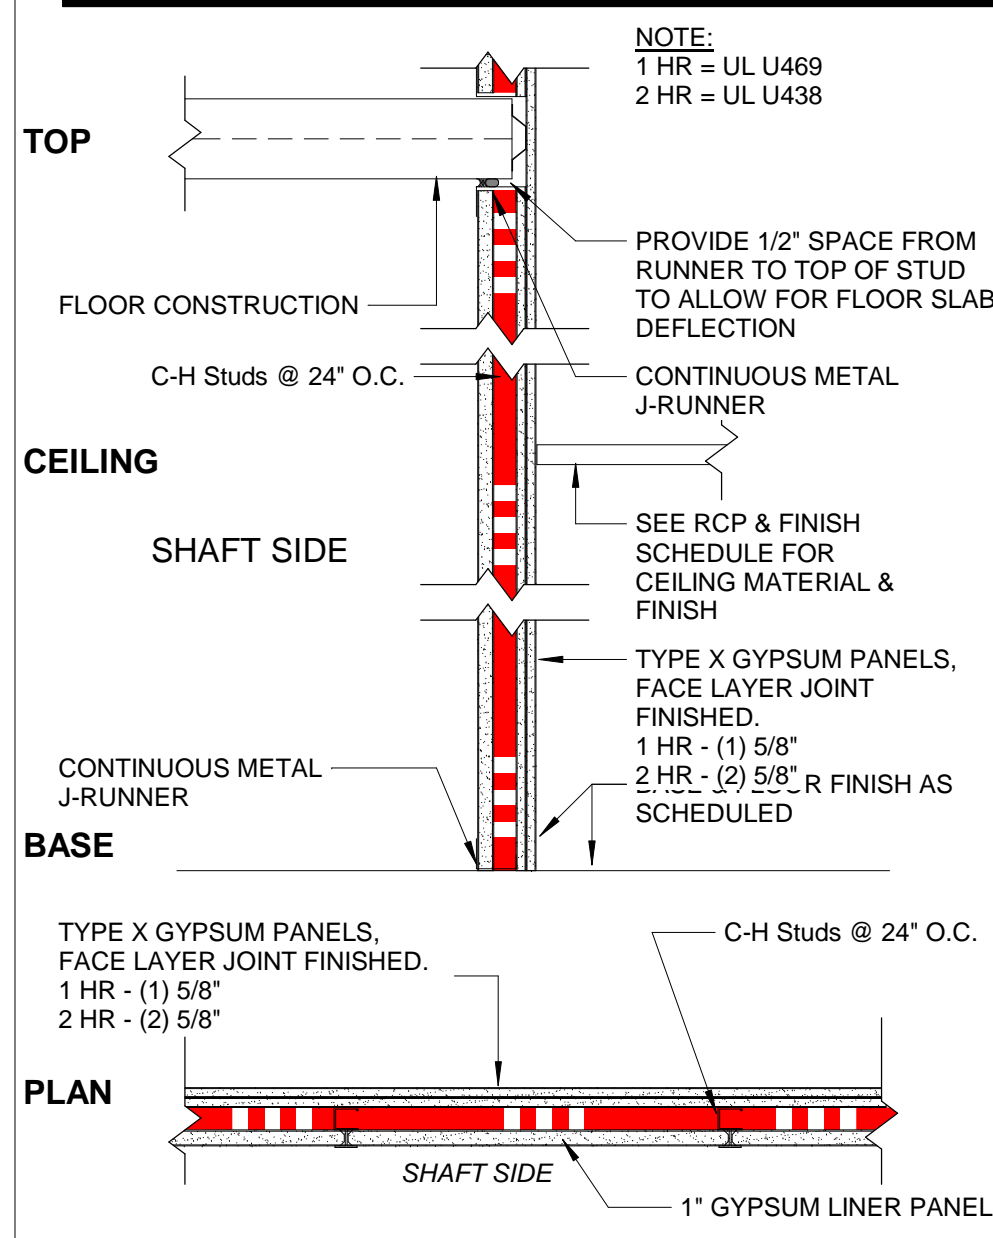

**<X33A> SHAFT - SLAB TO DECK**

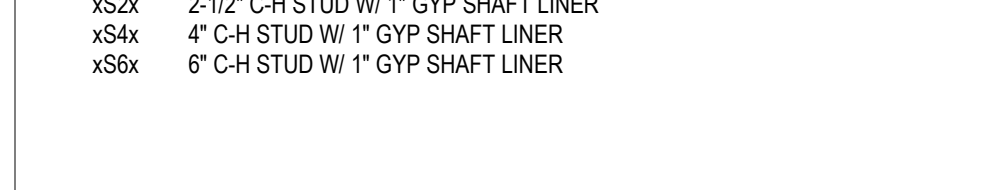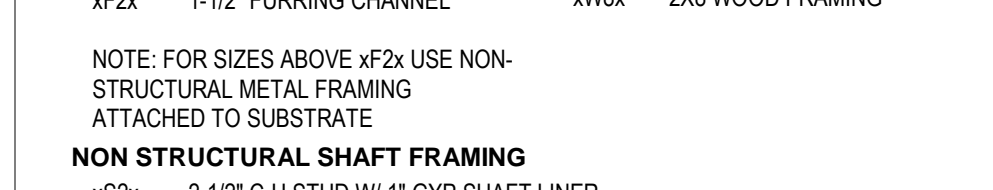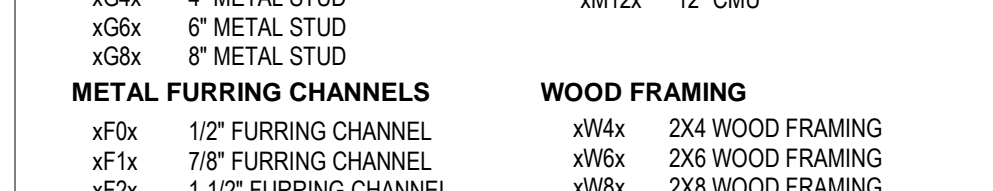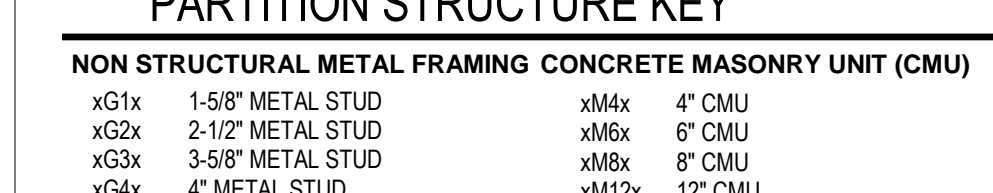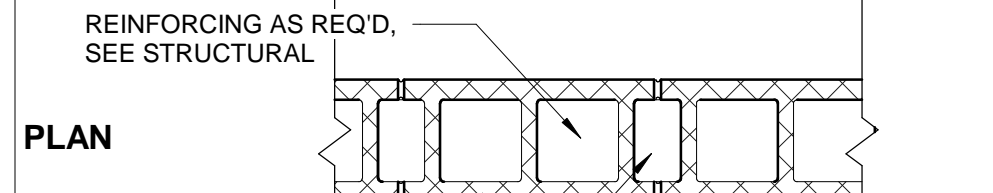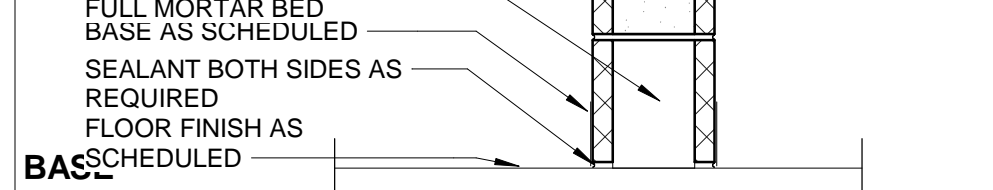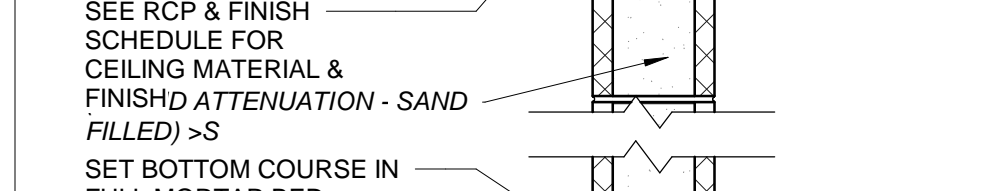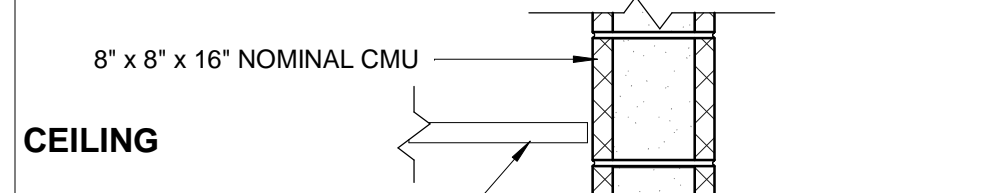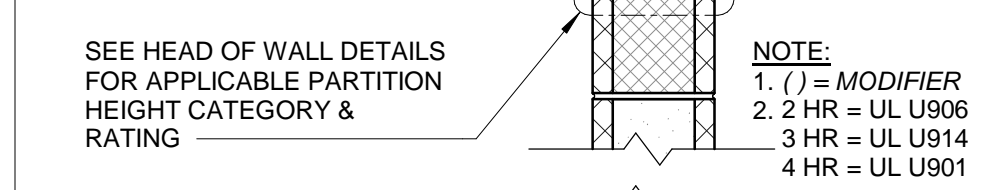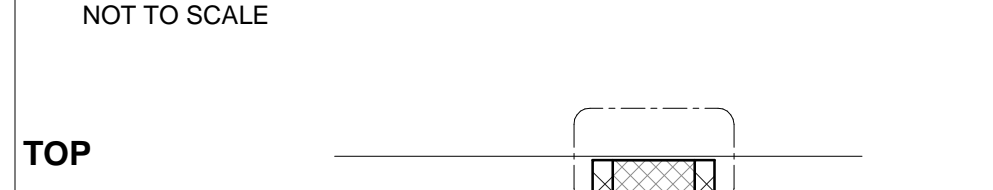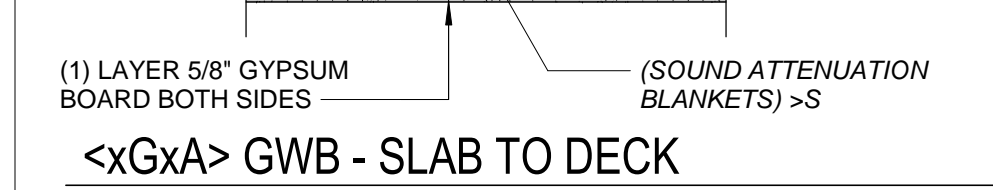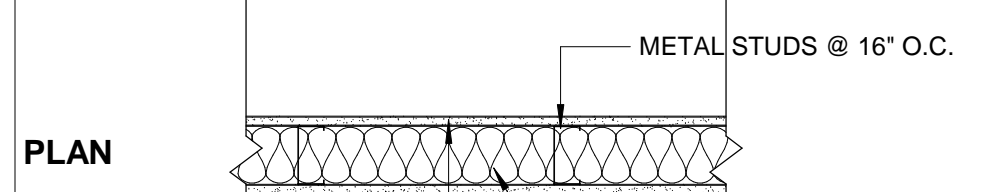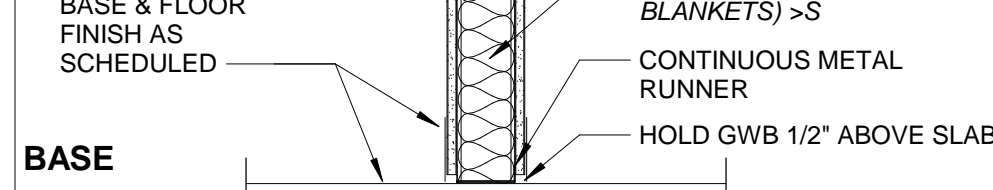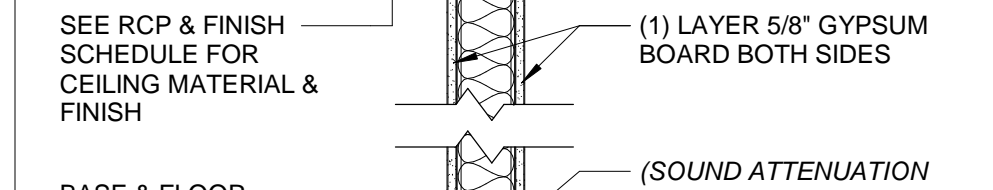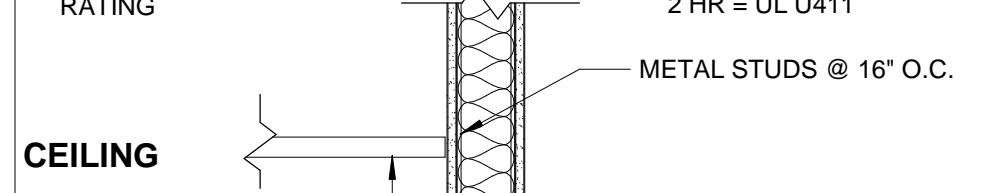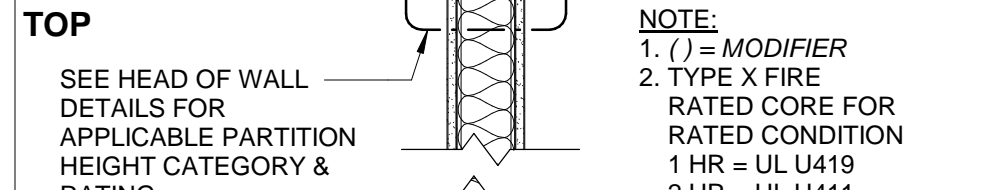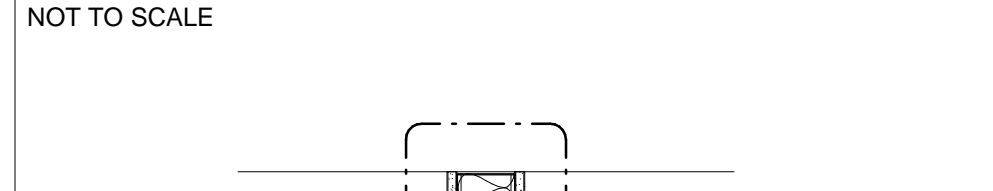


**GENERAL NOTES - PARTITIONS**

- 1. FIRE- AND SMOKE-RATED PARTITION ASSEMBLIES CONTINUE TO STRUCTURE ABOVE (HEAD CONDITION 'A') UNLESS NOTED OTHERWISE OR UNLESS OTHERWISE INDICATED BY THE CORRESPONDING FIRE RATED ASSEMBLY DIAGRAM.
- 2. PROVIDE ACOUSTICAL CAULKING AROUND ALL PERIMETERS EDGES AND PENETRATIONS AT SOUND INSULATED WALLS, OFFSET ELECT. AND TELEPHONE OUTLETS 16" MIN (SEPARATE STUD CAVITIES). AT SOUND INSULATED WALLS PROVIDE ACOUSTICAL CAULKING AROUND ALL PERIMETERS EDGES AND PENETRATIONS, OFFSET ELECT. AND TELEPHONE OUTLETS 16" MIN (SEPARATE STUD CAVITIES). WALLS ARE DIMENSIONED TO FINISH FACE OF WALL, UNLESS INDICATED OTHERWISE.
- 3. WHERE ADJACENT PARTITION TYPES ARE OF DIFFERENT OVERALL THICKNESS, ALIGN FINISHES ON VISIBLE SIDE, AND FURR OPPOSITE SIDE AS REQUIRED FOR A FLUSH INSTALLATION.
- 4. PARTITION TYPES AROUND ROOMS AND SPACES SHALL BE CONTINUOUS AROUND THE ENTIRE SPACE. WHERE MORE THAN ONE PARTITION TYPE IS INDICATED, THE WALL TYPE WITH THE HIGHEST FIRE AND/OR ACUSTICAL PERFORMANCE SHALL BE USED.
- 5. FIRE SAFE ALL PENETRATIONS THROUGH FIRE RATED WALLS TO THE LEVEL OF PROTECTION REQUIRED BY THE WALL. FIRE SAFE AT PERIMETERS OF RATED WALLS WHERE VOIDS OCCUR, SUCH AS DECK FLUTES.
- 6. REFER TO THE FINISH SCHEDULE AND/OR FLOOR PLANS FOR LOCATION OF FINISH MATERIALS FOR WALL TYPES INDICATING DIFFERENT FINISHES ON EACH SIDE OF WALL.
- 7. WET WALLS IN TOILET ROOMS TO RECEIVE CERAMIC TILE SHALL USE MOISTURE RESISTANT FIBERGLASS-MAT GYPSUM BOARD IN PLACE OF GWB.
- 8. BRACE ALL CHASE WALLS FROM STUD TO STUD AT 4' OC MIN. VERTICAL AND PER MANUFACTURER'S RECOMMENDATION UNLESS NOTED OTHERWISE.
- 9. PROVIDE STEEL STUD GAUGES AND/OR DIAGONAL BRACING AT TOPS OF WALLS PER MANUFACTURER'S RECOMMENDATIONS FOR WALL TYPE, HEIGHT, AND USE BASED ON L240 LIMITING HEIGHTS."
- 10. ALL CORNERS AND EDGES EXPOSED TO VIEW SHALL RECEIVE METAL EDGE BEADS TREATED WITH DRYWALL COMPOUND TO A HEIGHT OF 6" ABOVE FINISHED CEILING MIN."
- 11. ALL UL-RATED WALL ASSEMBLIES SHALL BE IDENTIFIED BY STENCILING ABOVE THE FINISHED CEILING ON BOTH FACES. ON ALL WALLS AS "FIRE AND SMOKE BARRIER - PROTECT ALL OPENINGS" WITH HOUR RATING INCLUDED.
- 12. ALL MATERIALS USED IN RATED ASSEMBLIES SHALL CONFORM TO REFERENCED STANDARDS."
- 13. USE MOISTURE- AND MOLD-RESISTANT GWB ON INTERIOR SIDE OF MECHANICAL ROOM WALLS.
- 14. PROVIDE CONTINUOUS HORIZONTAL BRIDGING FOR WALLS EXTENDING 10'-0" OR GREATER IN HEIGHT FROM FINISH FLOOR.


**PARTITION HEIRARCHY**

**PARTITION TO MULLION**

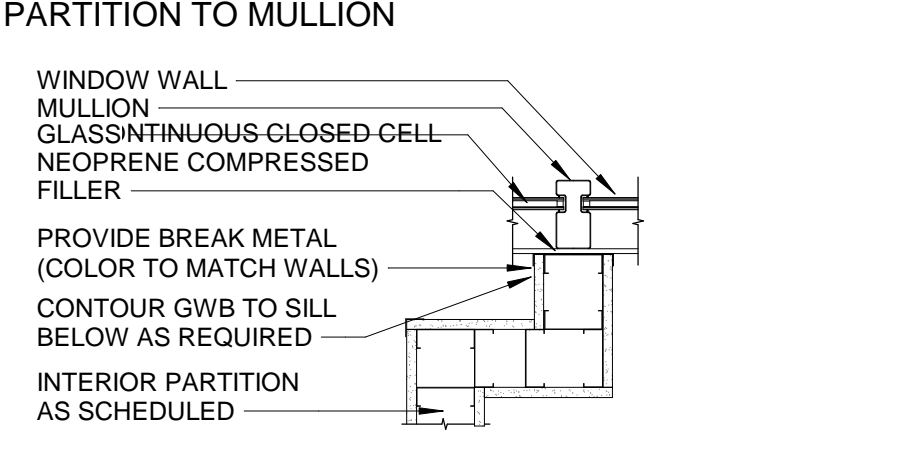

NOTE: NO PHYSICAL OR MECHANICAL ATTACHMENT TO MULLION SHALL BE ALLOWED.

**RATING HIERARCHY**

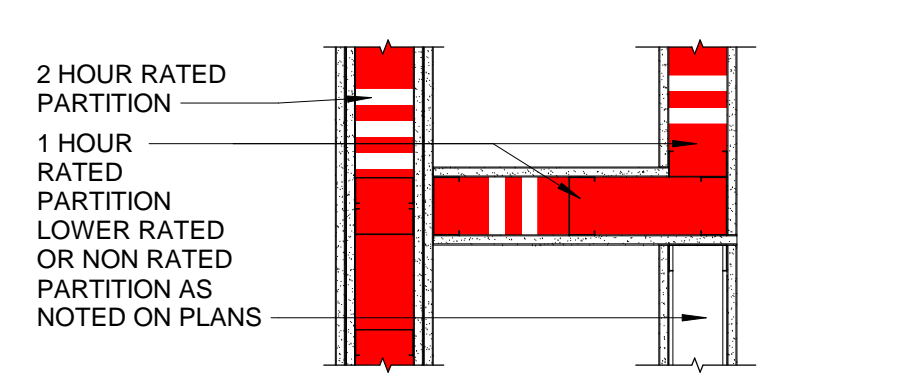


**LIMITING HEIGHTS - STEEL STUD**

WALL HEIGHT	DEFLECTION LIMIT OF L240		DEFLECTION LIMIT OF L360	
	WITHOUT SHELVING	WITH SHELVING	WITHOUT SHELVING	WITH SHELVING
<10'	362S125-18 16" O.C.	362S125-18 16" O.C.	362S125-18 16" O.C.	362S125-18 16" O.C.
<12'	362S125-18 16" O.C.	362S125-33 16" O.C.	362S125-18 16" O.C.	362S125-33 16" O.C.
<14'	362S125-18 16" O.C.	362S125-33 16" O.C.	362S125-33 16" O.C.	362S125-54 16" O.C.
<16'	362S125-33 16" O.C.	362S125-43 16" O.C.	362S125-33 16" O.C.	600S125-33 16" O.C.
<18'	362S125-43 16" O.C.	362S125-43 16" O.C.	362S125-54 16" O.C.	600S125-33 16" O.C.
<20'	362S125-43 16" O.C.	362S125-54 16" O.C.	600S125-33 16" O.C.	600S125-33 16" O.C.

NOTES:  
1. DESIGN LATERAL LOAD OF 5 PSF. AND NO VERTICAL LOAD (NON-LOAD-BEARING).  
2. FINISHES, SUCH AS TILE, TERRAZZO, AND PLASTER, DEFLECTION LIMIT OF L240 MAY BE USED FOR ALL OTHER CONDITIONS.  
3. "WITH SHELVING" DESIGN FOR 16" SHELVING UNIT, LOAD OF 73 POUNDS PER LINEAR FOOT INCLUDING CONTENTS, CENTERED 8" FROM FACE OF WALL. FOR ONE ROW OF SHELVING ROUGHLY 4" A.F.F.  
MEMBER WEB DEPTH: (6" = 600 x 1/100") 600 (S) 162 - (54) (1-5/8" = 162 x 1/100")  
STYLE:  
S = STUD OR JOIST SECTION  
T = TRACK SECTIONS  
U = CHANNEL SECTIONS  
F = FURRING CHANNEL SECTIONS  
MIL THICKNESS:  
(354" = 54 MILS.; 1 MIL = 1/1000")  
18 MIL = 25 GA  
27 MIL = 22 GA  
30 MIL = 20 GA (DRYWALL)  
33 MIL = 20 GA (STRUCTURAL)  
43 MIL = 18 GA  
54 MIL = 16 GA  
68 MIL = 14 GA


**PARTITION TAG KEY**

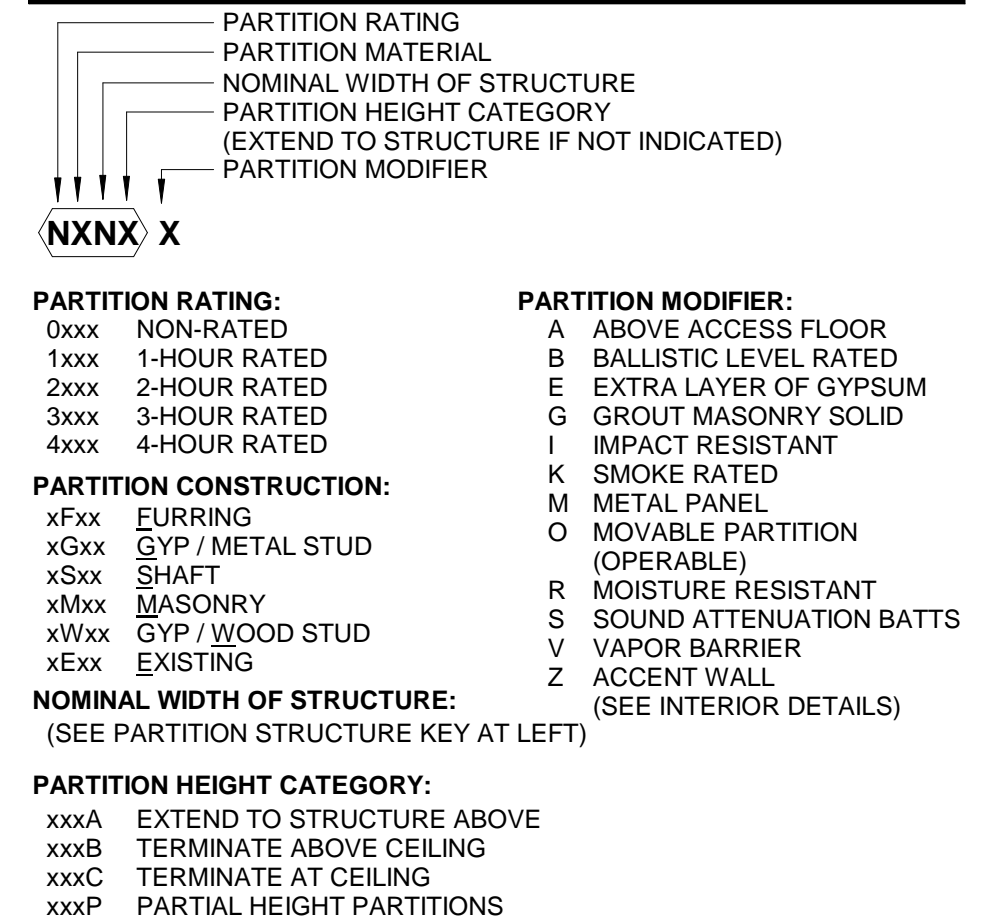


- FIELD VERIFY ALL DIMENSIONS AND EXISTING CONDITIONS.
- ALL EXISTING WALL SURFACES AND PARTITIONS TO REMAIN SHALL BE PATCHED, SPACKLED AND SANDED SMOOTH SO AS NOT TO LEAVE ANY EVIDENCE OF DEMOLITION OR REPAIR WORK. PREPARE SURFACES FOR NEW FINISHES AS REQUIRED.
- ALL WORK SHALL CONFORM TO CONTRACT DOCUMENTS WHICH INCLUDE THE OWNER'S CONTRACTOR AGREEMENT, THE PROJECT DRAWINGS AND SPECIFICATIONS, AND ALL ADDENDA AND MODIFICATIONS ISSUED BY THE ARCHITECT.
- THE CONTRACTOR SHALL REVIEW ALL DOCUMENTS AND VERIFY ALL DIMENSIONS AND FIELD CONDITIONS AND SHALL CONFIRM THAT WORK IS BUILDABLE AS SHOWN. ANY CONFLICTS OR OMISSIONS SHALL BE IMMEDIATELY REPORTED TO THE ARCHITECT FOR CLARIFICATION PRIOR TO THE PERFORMANCE OF ANY WORK IN QUESTION.
- CONTRACTOR SHALL COORDINATE WITH TENANT THE SCHEDULE FOR ALL TELEPHONE COMPANY AND DATA INSTALLATIONS.
- "ALIGN" SHALL MEAN TO ACCURATELY LOCATE FINISH FACES IN THE SAME PLANE.
- ALL WORK NOTED 'BY OTHERS' OR 'NIC' SHALL BE PROVIDED BY OWNER OR UNDER SEPARATE CONTRACT.
- DO NOT SCALE DRAWINGS. WRITTEN DIMENSIONS GOVERN.
- EXTEND WALLS TO STRUCTURE ABOVE STOREFRONT SYSTEMS AND GLASS WALL PARTITIONS.

- |    |   |    |  |
|----|---|----|--|
| 1  | INSTALL SALVAGED WINDOW IN NEW WINDOW OPENING.  | 16 | CHASE DEPTH IN CLOSETS TO BE A MINIMUM OF 1'-0" TO MATCH SHELVING DEPTH, TYPICAL.  |
| 2  | WHERE DOOR AND FRAME WERE REMOVED, FILL OPENING WITH CONCRETE, SEE STRUCTURAL.  | 17 | IT HELP DESK TO BE HARDWIRED (WORKSPACE FOR TWO TECHNICIANS).  |
| 4  | PROVIDE CARD READER.  | 21 | PATCH BRICK/CMU WALL TO MATCH EXISTING AT NEW STOREFRONT, INCLUDING WHERE EXISTING CAST STONE SURROUND WAS REMOVED AT WINDOW JAMBS AND HEADER. |
| 5  | PROVIDE DOOR HOLD OPEN.   | 22 | FILTERED WATER DISPENSER TO BE PROVIDED BY OWNER. CONTRACTOR TO CONFIRM SIZE, ELECTRICAL AND WATER REQUIREMENTS WITH OWNER.                    |
| 6  | PROVIDE PREFABRICATED METAL STAIR, LANDING AND RAILINGS.  |    |  |
| 9  | PROVIDE DOOR OPERATOR.  |    |  |
| 11 | ADHERE 5/8" GYP. BD. TO ALL EXISTING BRICK AND CMU WALLS AND NEW CMU WALLS IN PUBLIC AREAS, TYPICAL THROUGHOUT THE BUILDING.                        |    |  |
| 12 | WHERE EXISTING DOORS, WINDOWS, ETC. WERE REMOVED, FILL OPENING WITH METAL STUD FRAMING AND 5/8" GYP. BD. FINISH, TYPICAL THROUGHOUT THE BUILDING.   |    |  |
| 13 | AT NEW OPENINGS, PROVIDE 5/8" GYP. BD. FINISH OVER 3 5/8" METAL STUD FRAMING, ALIGN GYP. BD. WITH ADJACENT ADHERED GYP. BD. FINISH.                 |    |  |
| 14 | WHERE EXISTING WINDOWS WERE REMOVED IN EXTERIOR WALL, FILL OPENING WITH BRICK AND CMU TO MATCH EXISTING. SEE STRUCTURAL FOR ADDITIONAL INFORMATION. |    |  |
| 15 | PROVIDE 12" HEAVY DUTY, ADJUSTABLE SHELVING IN ALL CLOSETS - FIVE SHELVES PER CLOSET.   |    |  |

VERIFY ALL DIMENSIONS AND EXISTING CONDITIONS, TYPICAL

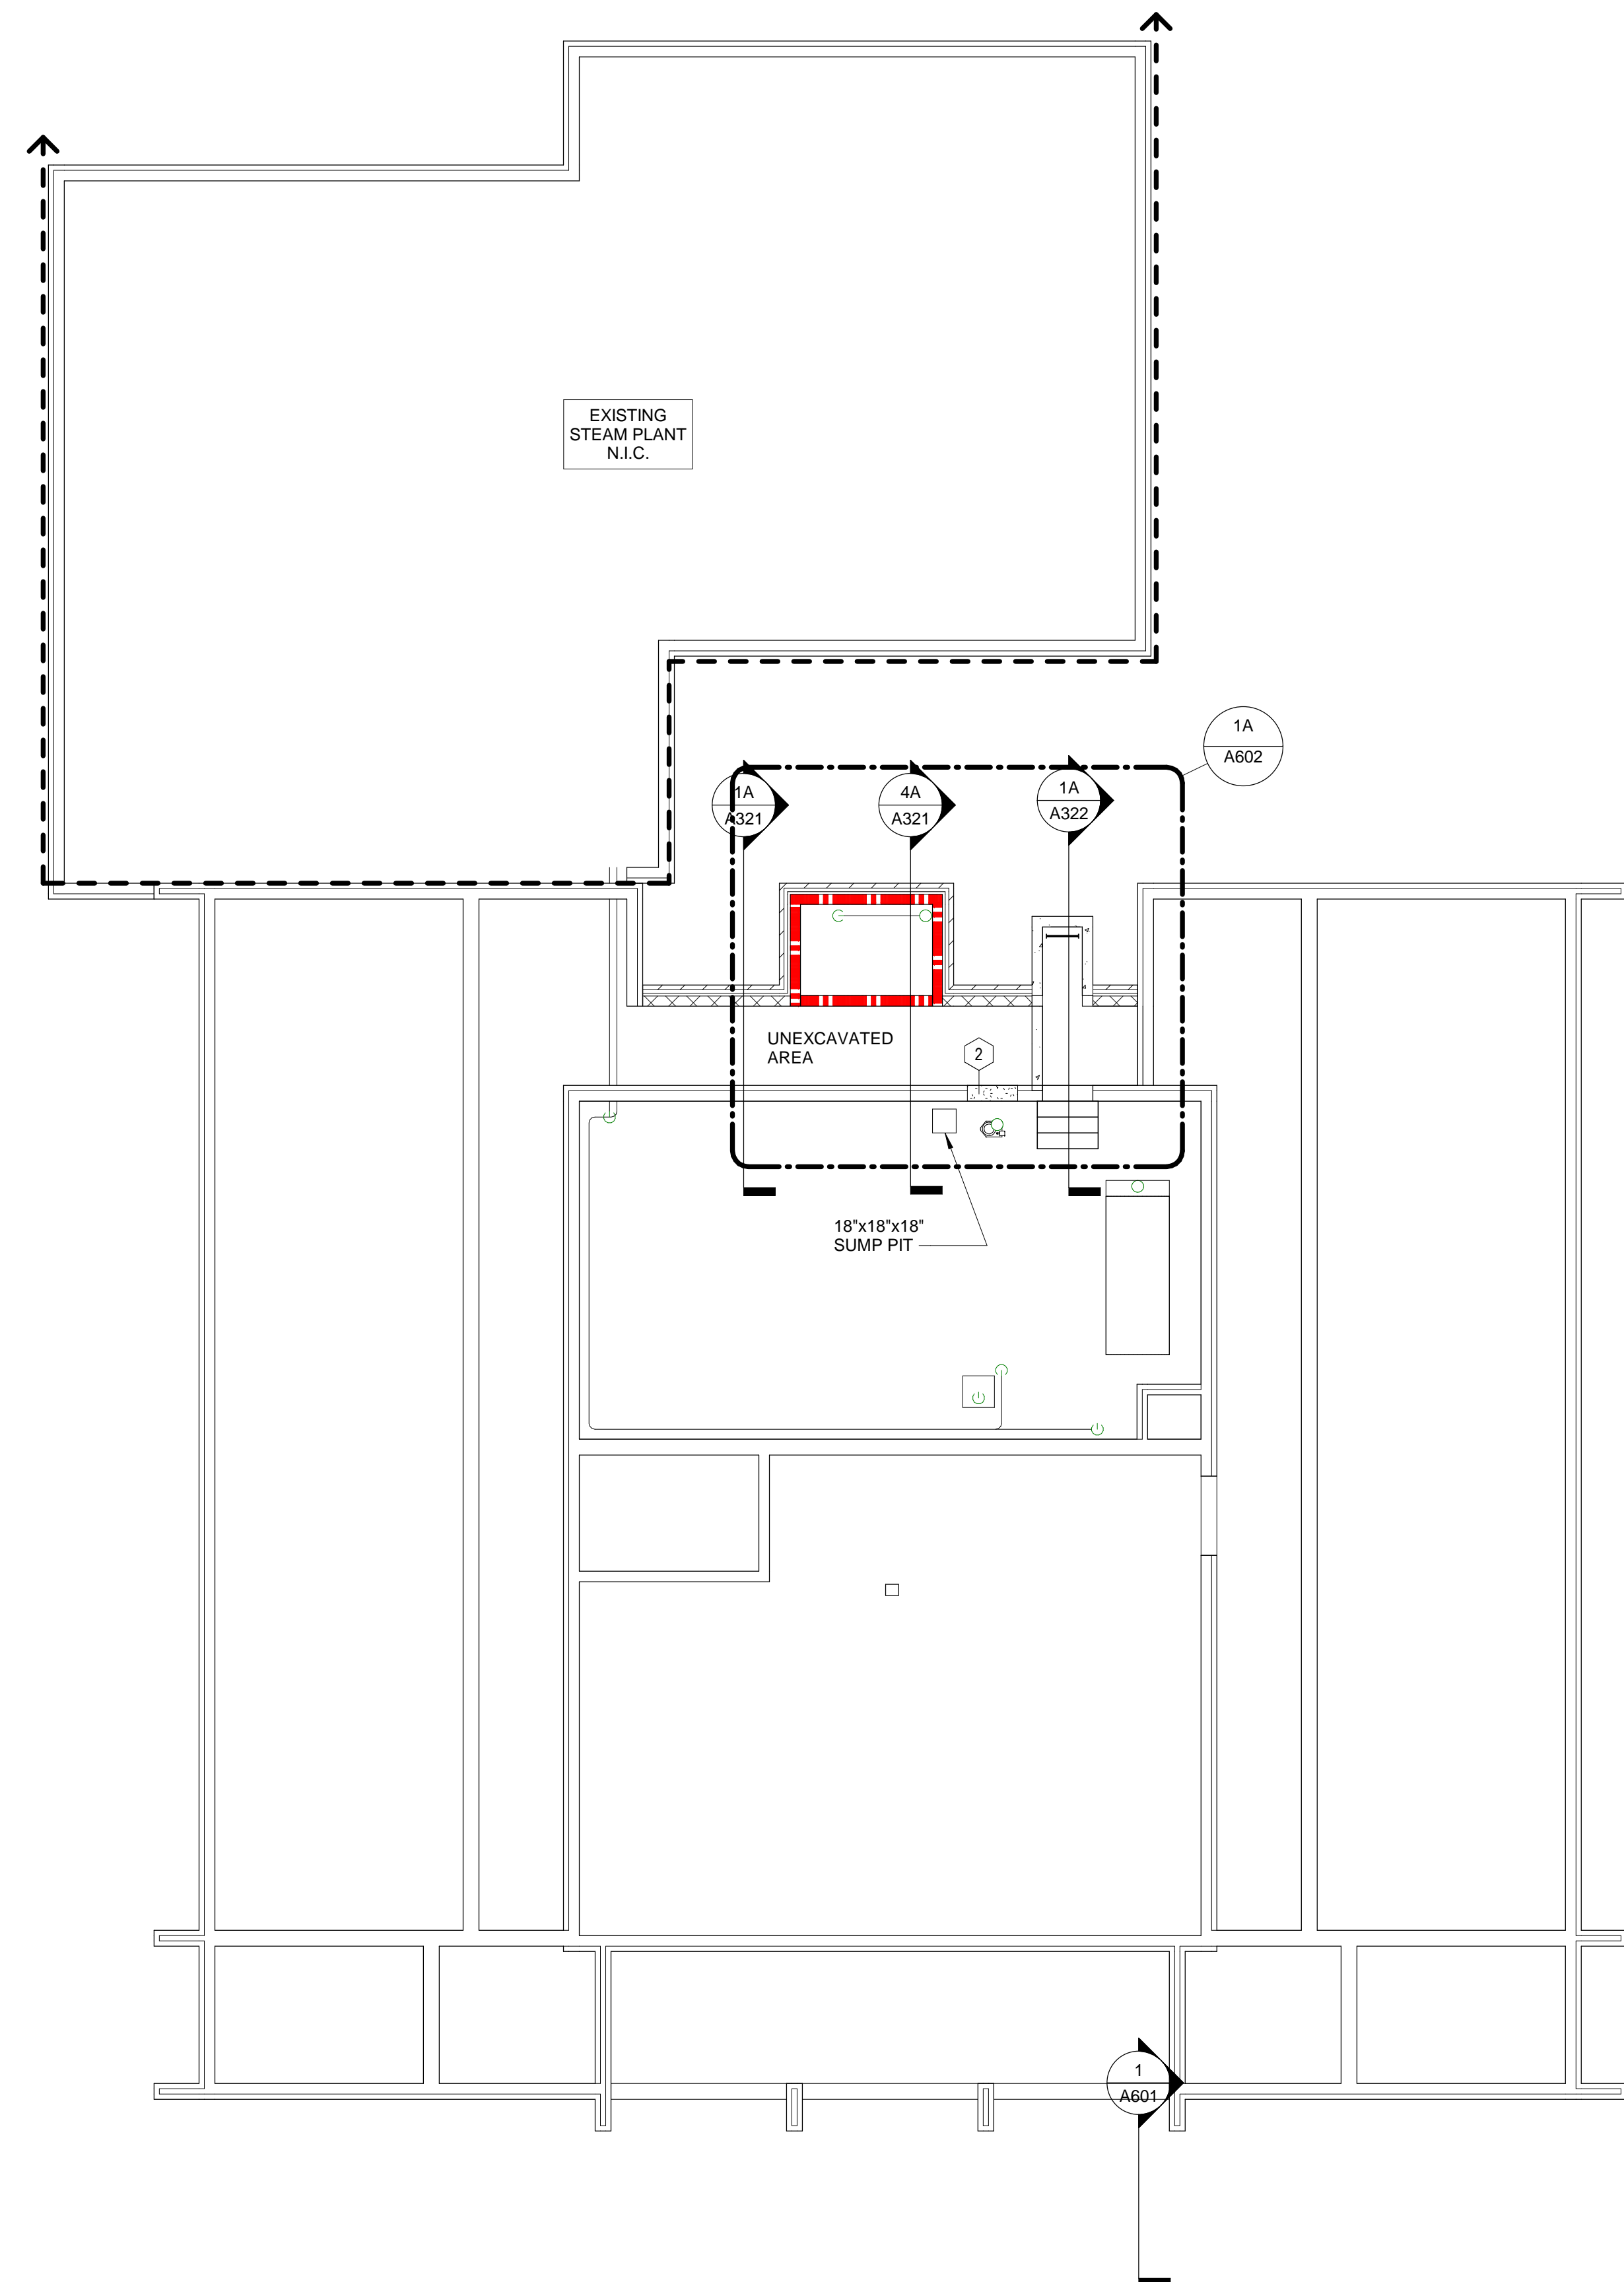

1A Level 0 - Base Bid  
A111 1/8" = 1'-0"

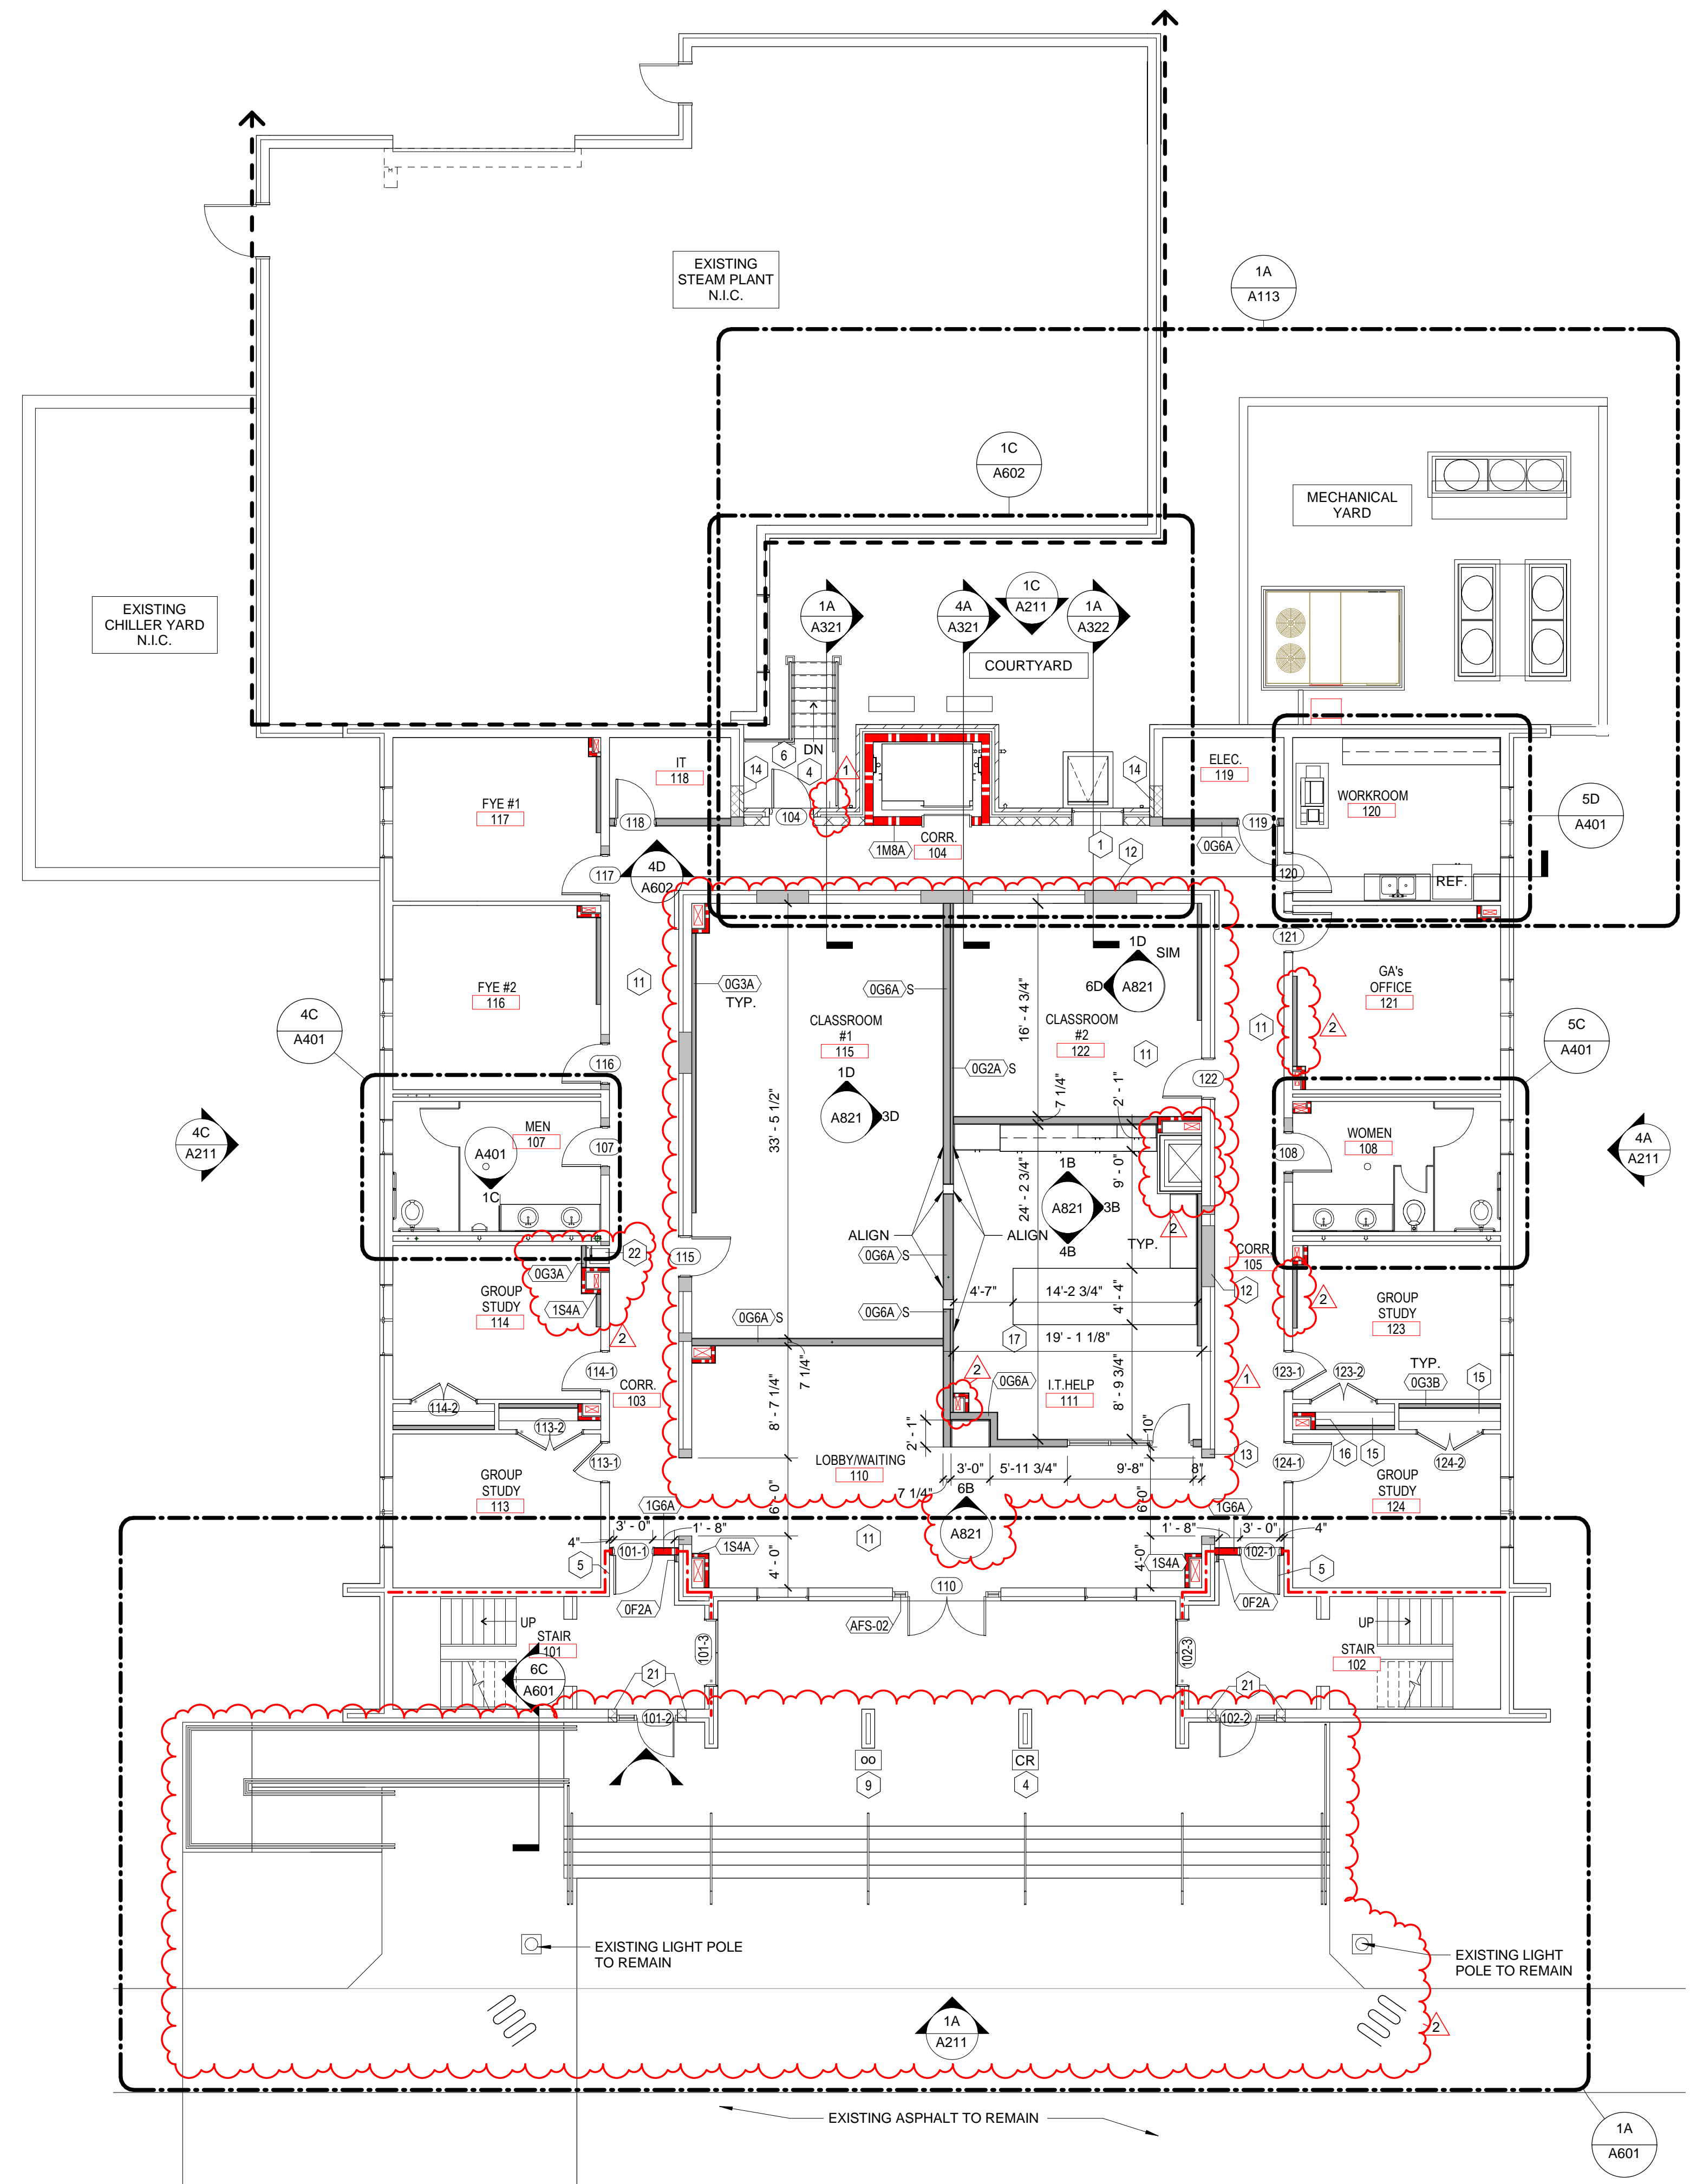

4A Level 1 - Base Bid  
A111 1/8" = 1'-0"

**LITTLE**  
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ISSUE FOR PERMIT SET

ISSUE DATE: 09.11.2018

REVISIONS NO.	REASON	DATE
1	AV Revisions by Owner and Quality Control	08.20.18
2	Revisions by Owner	09.11.18

PROJECT TEAM  
PRINCIPAL IN CHARGE: ROB KLINEDINST, AIA  
PROJECT MANAGER: SHANE WEBSTER, AIA  
DESIGN TEAM: LITTLE  
PROJECT NAME: CAMPBELL UNIVERSITY DAY HALL RENOVATIONS

PROJECT NO. 513.9660.00

SHEET TITLE: FLOOR PLANS - BASE BID - LEVELS 0 AND 1


SHEET NUMBER: A111

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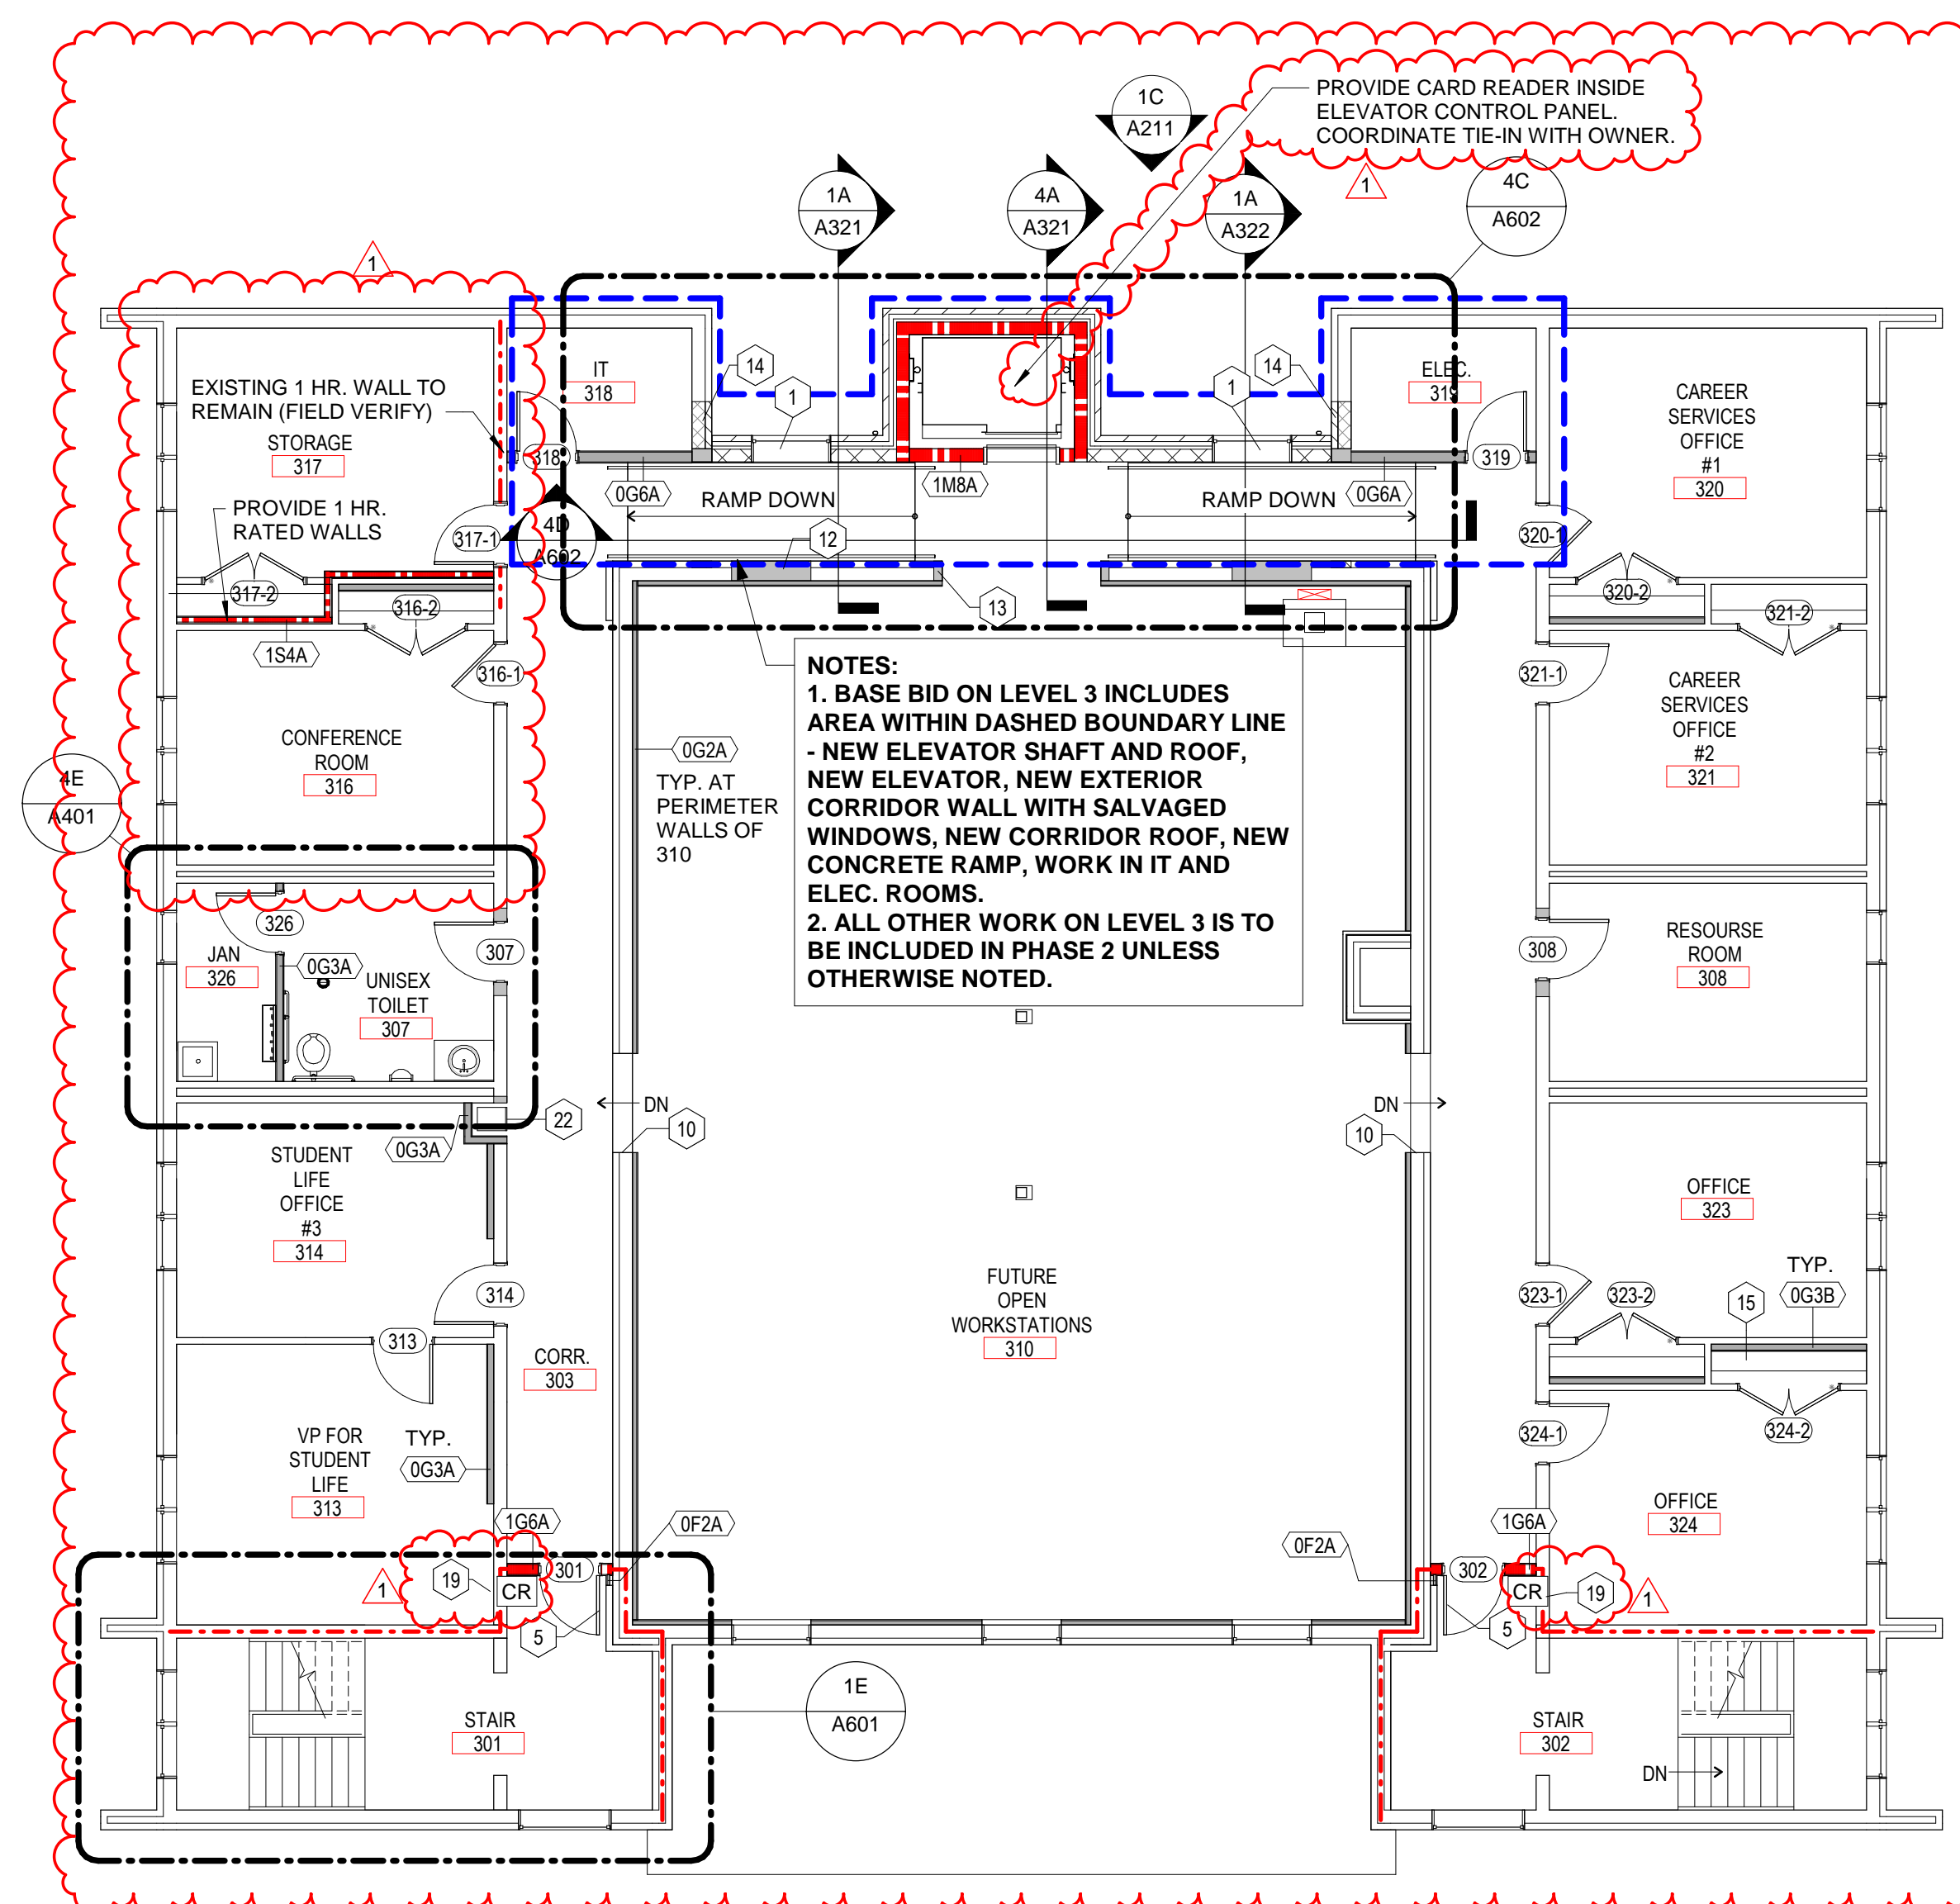
- FIELD VERIFY ALL DIMENSIONS AND EXISTING CONDITIONS.
- ALL EXISTING WALL SURFACES AND PARTITIONS TO REMAIN SHALL BE PATCHED, SPACKLED AND SANDED SMOOTH SO AS NOT TO LEAVE ANY EVIDENCE OF DEMOLITION OR REPAIR WORK. PREPARE SURFACES FOR NEW FINISHES AS REQUIRED.
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- THE CONTRACTOR SHALL REVIEW ALL DOCUMENTS AND VERIFY ALL DIMENSIONS AND FIELD CONDITIONS AND SHALL CONFIRM THAT WORK IS BUILDABLE AS SHOWN. ANY CONFLICTS OR OMISSIONS SHALL BE IMMEDIATELY REPORTED TO THE ARCHITECT FOR CLARIFICATION PRIOR TO THE PERFORMANCE OF ANY WORK IN QUESTION.
- CONTRACTOR SHALL COORDINATE WITH TENANT THE SCHEDULE FOR ALL TELEPHONE COMPANY AND DATA INSTALLATIONS.
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- DO NOT SCALE DRAWINGS. WRITTEN DIMENSIONS GOVERN.
- EXTEND WALLS TO STRUCTURE ABOVE STOREFRONT SYSTEMS AND GLASS WALL PARTITIONS.

1	INSTALL SALVAGED WINDOW IN NEW WINDOW OPENING.	20	DOUBLE HEIGHT LOCKERS OR CUBICLES (PER OWNER'S PREFERENCE). NINETEEN DOUBLE HEIGHT SHOWN TO PROVIDE FOR 38 STATIONS SHOWN IN TESTING 210 AND COMPUTER 211.
5	PROVIDE DOOR HOLD OPEN.		
10	EXISTING OPENING TO REMAIN. WRAP GYP. BD. AROUND END OF WALL.		
11	ADHERE 5/8" GYP. BD. TO ALL EXISTING BRICK AND CMU WALLS AND NEW CMU WALLS IN PUBLIC AREAS, TYPICAL THROUGHOUT THE BUILDING.		
12	WHERE EXISTING DOORS, WINDOWS, ETC. WERE REMOVED, FILL OPENING WITH METAL STUD FRAMING AND 5/8" GYP. BD. FINISH. TYPICAL THROUGHOUT THE BUILDING.		
13	AT NEW OPENINGS, PROVIDE 5/8" GYP. BD. FINISH OVER 3 5/8" METAL STUD FRAMING. ALIGN GYP. BD. WITH ADJACENT ADHERED GYP. BD. FINISH.		
14	WHERE EXISTING WINDOWS WERE REMOVED IN EXTERIOR WALL, FILL OPENING WITH BRICK AND CMU TO MATCH EXISTING. SEE STRUCTURAL FOR ADDITIONAL INFORMATION.		
15	PROVIDE 12" HEAVY DUTY, ADJUSTABLE SHELVING IN ALL CLOSETS - FIVE SHELVES PER CLOSET.		
16	CHASE DEPTH IN CLOSETS TO BE A MINIMUM OF 1'-0" TO MATCH SHELVING DEPTH, TYPICAL.		
19	STAIR DOORS TO HAVE CARD READER FOR AFTER HOURS ACCESS TO LEVELS 2 AND 3.		

VERIFY ALL DIMENSIONS AND EXISTING CONDITIONS, TYPICAL

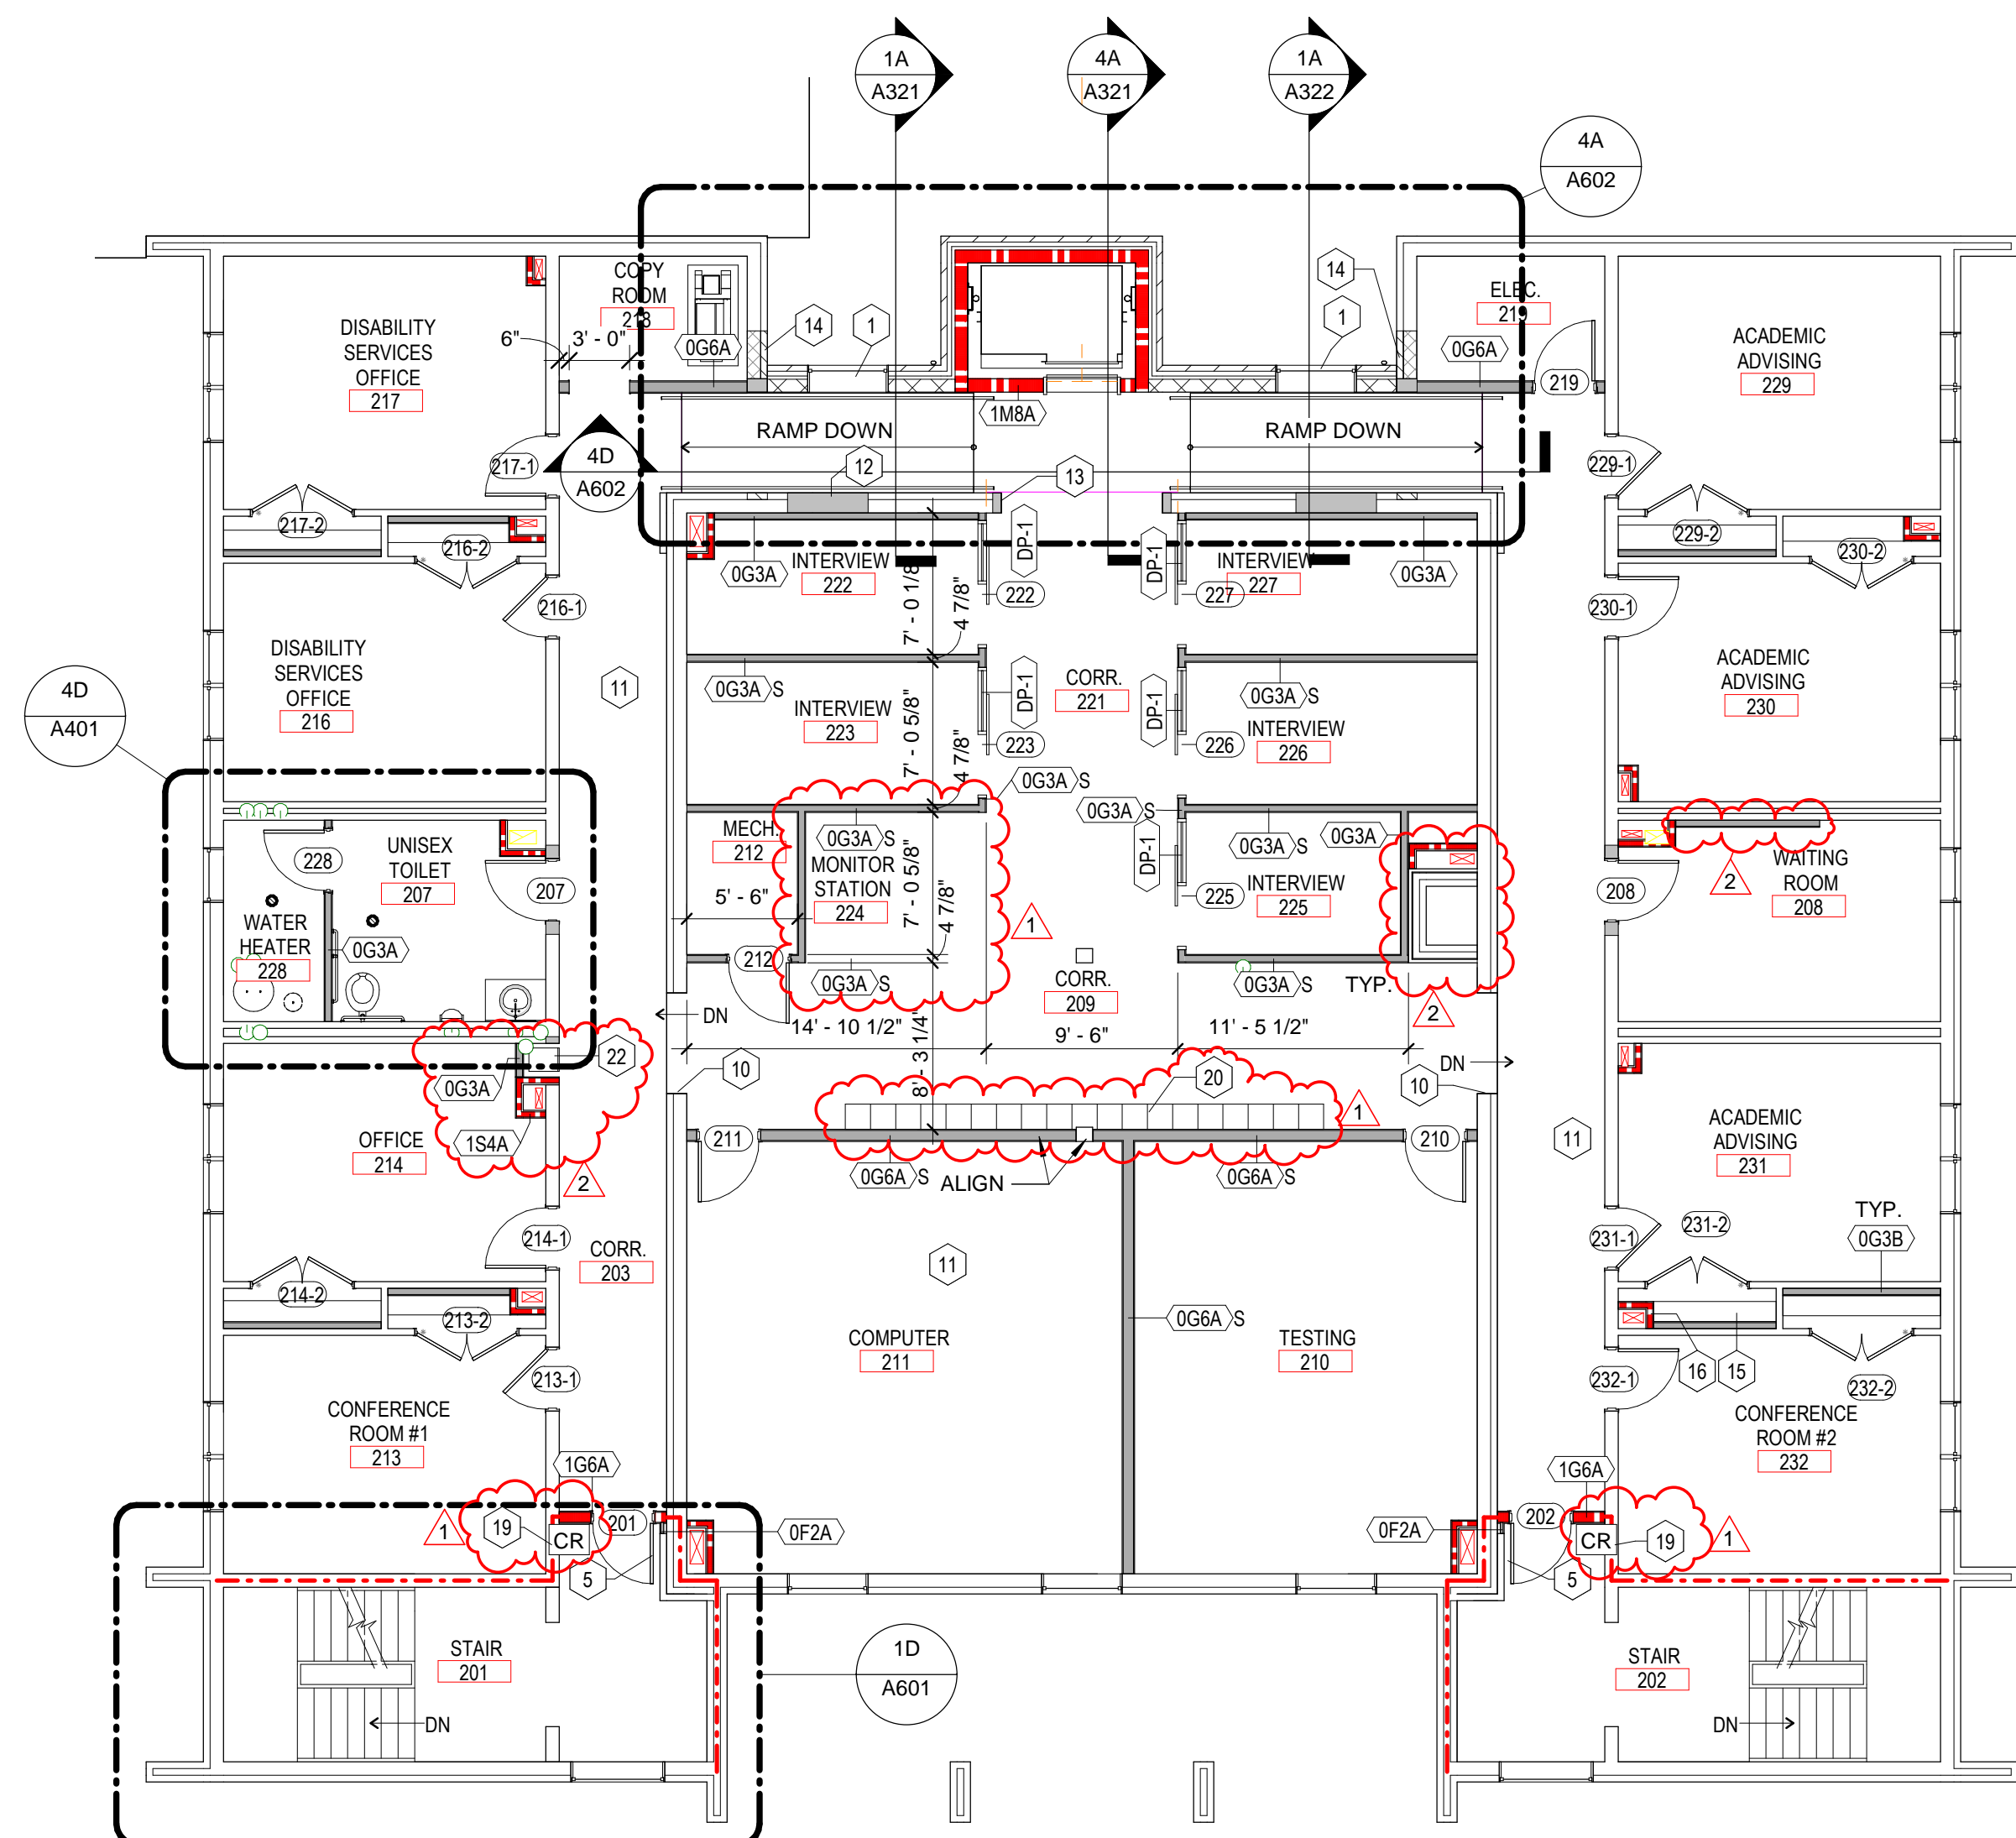

1A Level 2 - Base Bid  
A112 1/8" = 1'-0"



4A Level 3 - Base Bid  
A112 1/8" = 1'-0"

NOTES:  
1. BASE BID ON LEVEL 3 INCLUDES AREA WITHIN DASHED BOUNDARY LINE - NEW ELEVATOR SHAFT AND ROOF, NEW ELEVATOR, NEW EXTERIOR CORRIDOR WALL WITH SALVAGED WINDOWS, NEW CORRIDOR ROOF, NEW CONCRETE RAMP, WORK IN IT AND ELEC. ROOMS.  
2. ALL OTHER WORK ON LEVEL 3 IS TO BE INCLUDED IN PHASE 2 UNLESS OTHERWISE NOTED.



09/11/2018

ISSUE FOR PERMIT SET

ISSUE DATE  
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REVISIONS NO.	REASON	DATE
1	AV Revisions by Owner and Quality Control	08.20.18
2	Revisions by Owner	09.11.18

PROJECT TEAM  
PRINCIPAL IN CHARGE  
ROB KLINE/DINST, AIA  
PROJECT MANAGER  
SHANE WEBSTER, AIA

DESIGN TEAM  
LITTLE

PROJECT NAME  
CAMPBELL UNIVERSITY  
DAY HALL RENOVATIONS

PROJECT NO.  
513.9660.00

SHEET TITLE  
FLOOR PLANS - BASE  
BID - LEVELS 2 AND 3

SHEET NUMBER  
A112



VERIFY ALL DIMENSIONS AND EXISTING CONDITIONS, TYPICAL

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1A ENLARGED PLAN - LEVEL 1 - COURTYARD / MECHANICAL YARD PLAN  
A113 1/4\"/>

6A DETAIL - CONCRETE CURB  
A113 1\"/>



09/11/2018
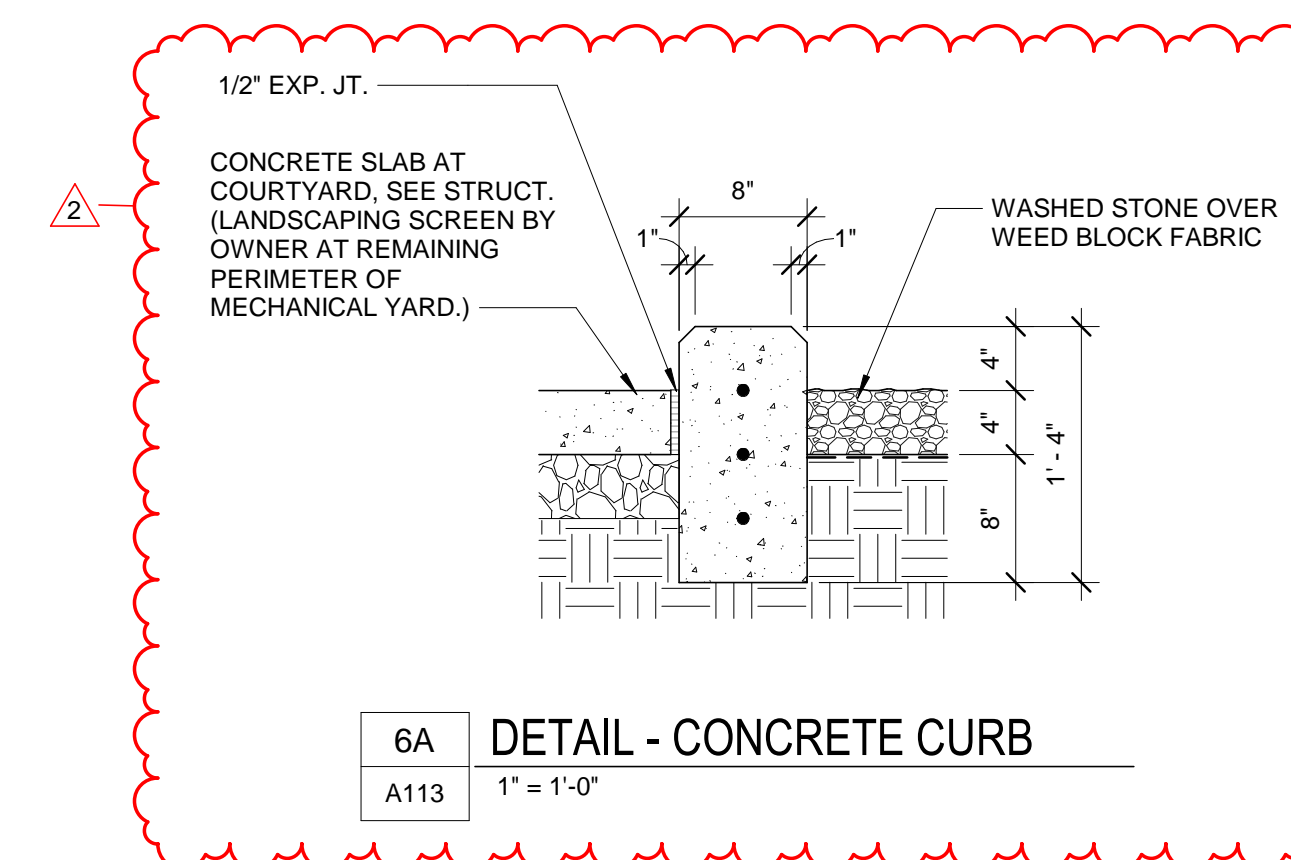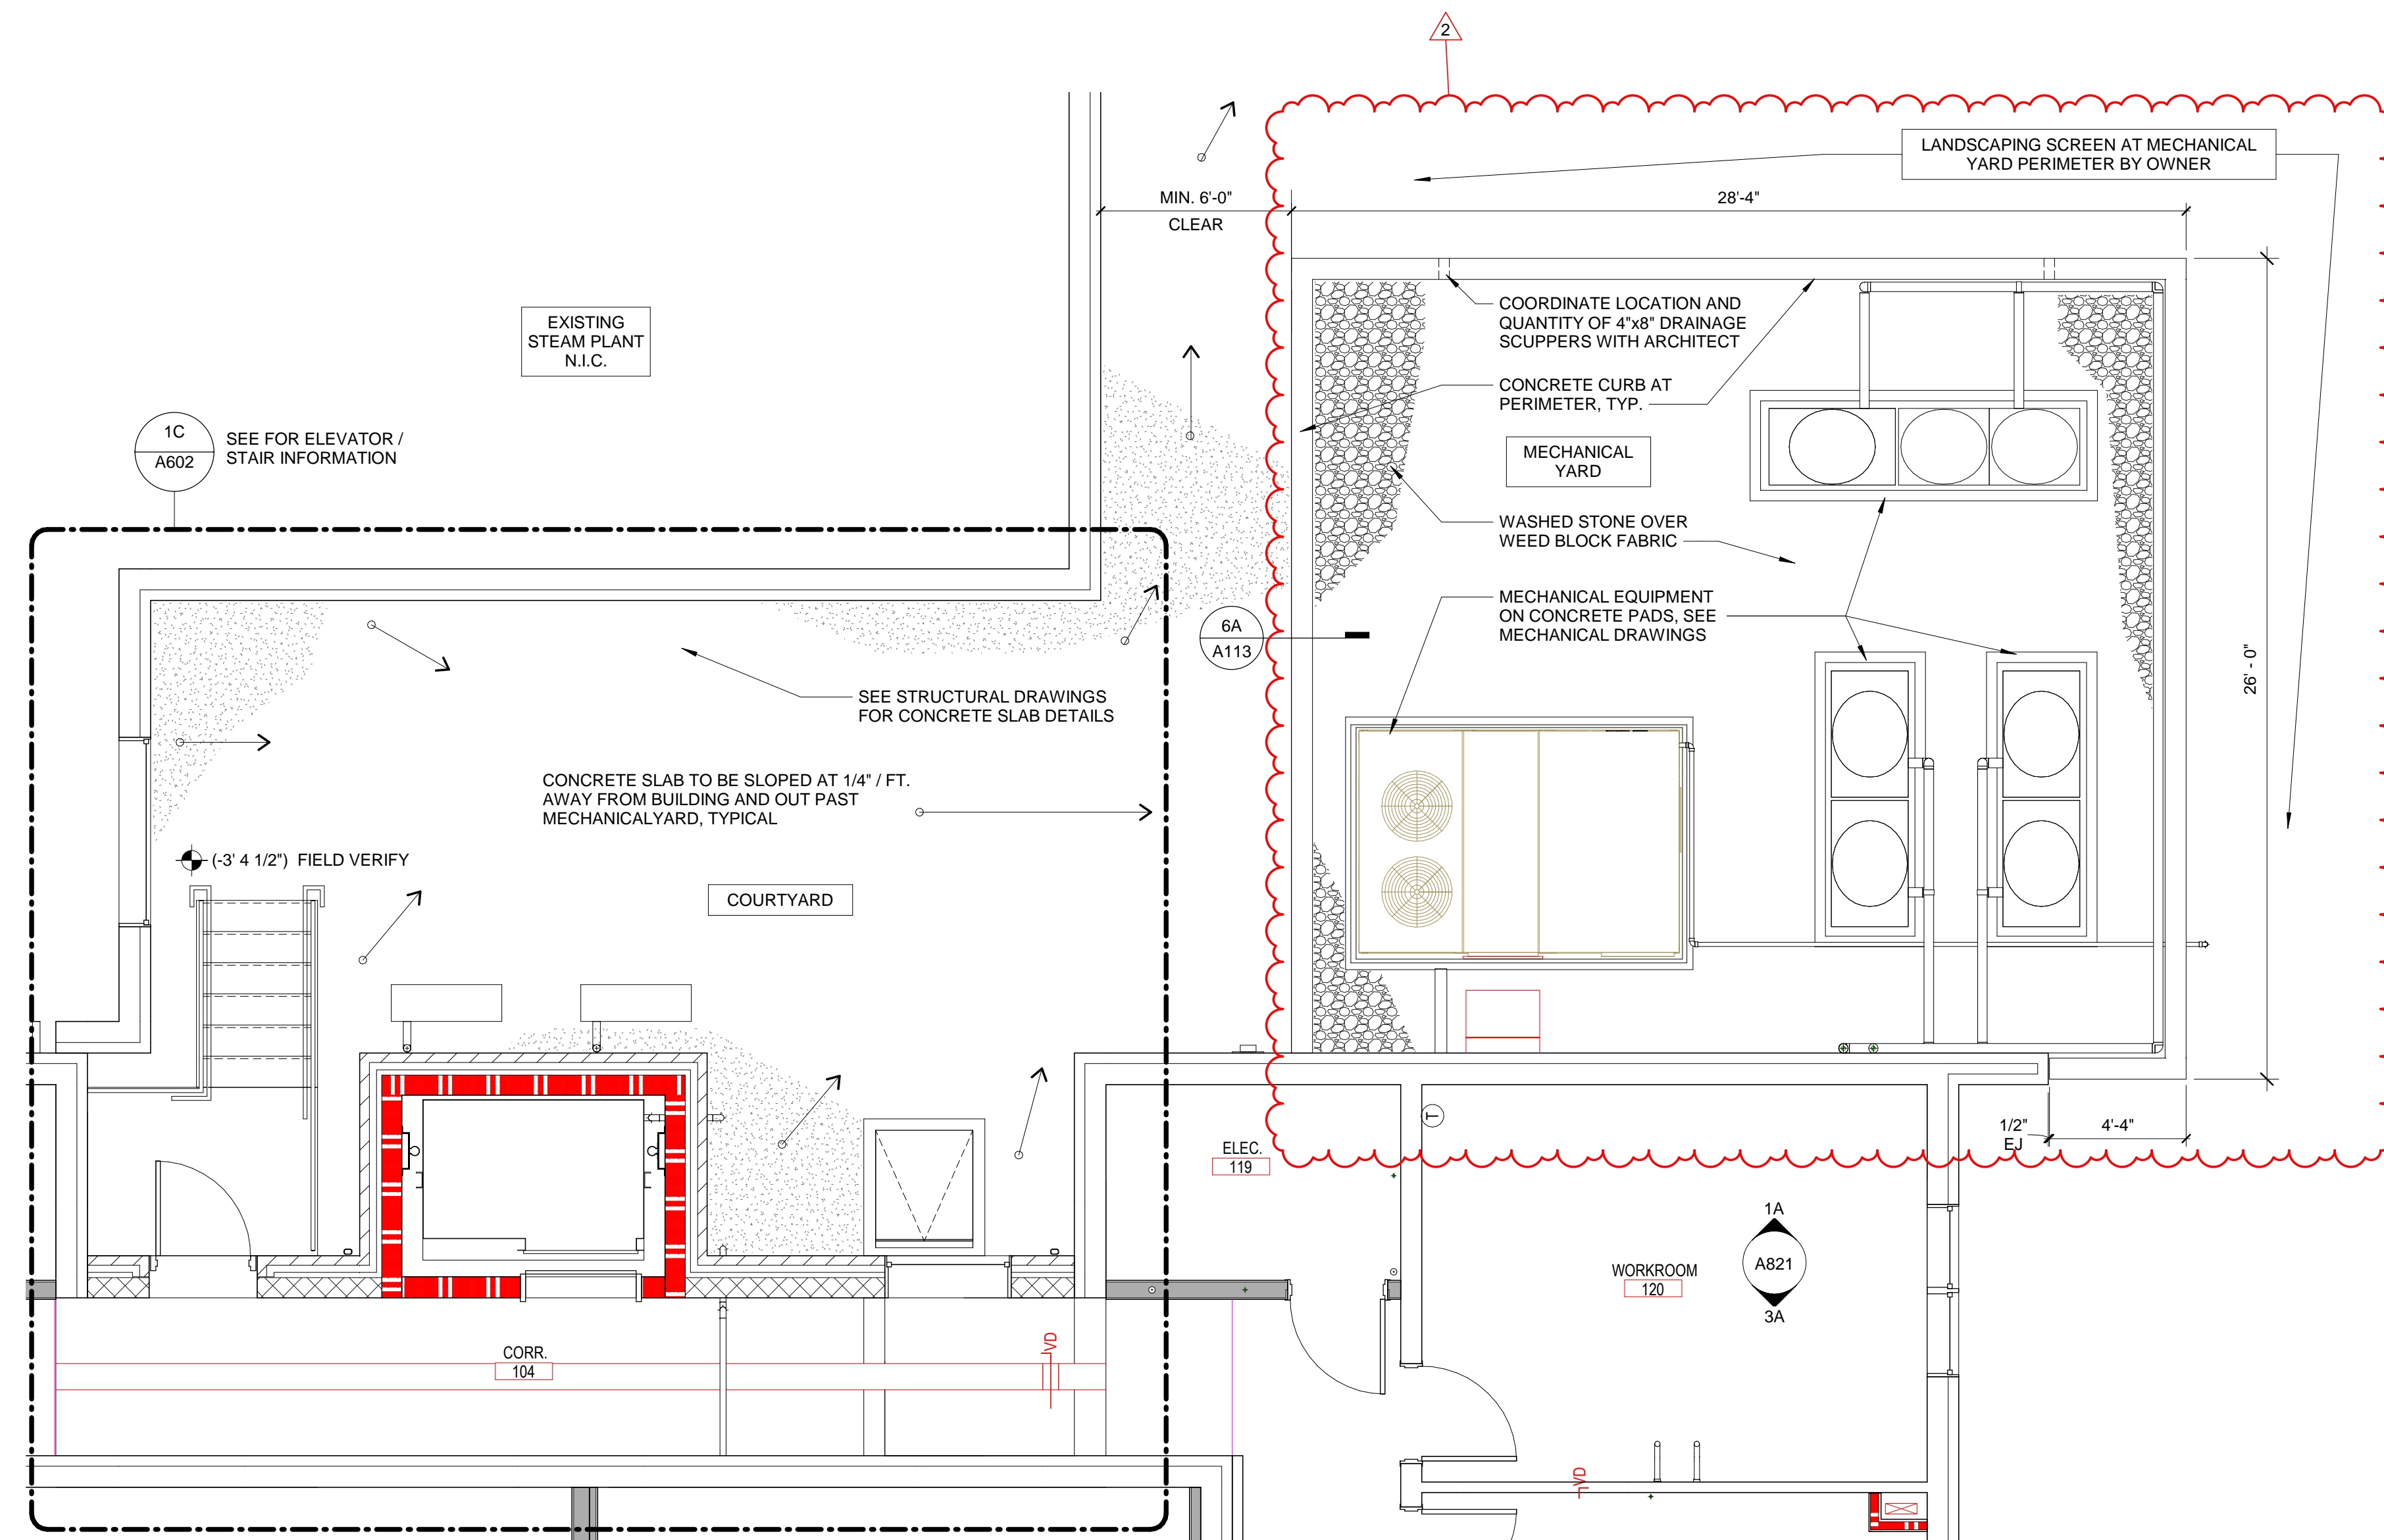
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PROJECT TEAM  
PRINCIPAL IN CHARGE: ROB KLINEINST, AIA  
PROJECT MANAGER: SHANE WEBSTER, AIA  
DESIGN TEAM: LITTLE

PROJECT NAME  
CAMPBELL UNIVERSITY DAY HALL RENOVATIONS


PROJECT NO.  
513.9660.00

SHEET TITLE  
ENLARGED COURTYARD / MECHANICAL YARD PLAN AND DETAILS


SHEET NUMBER  
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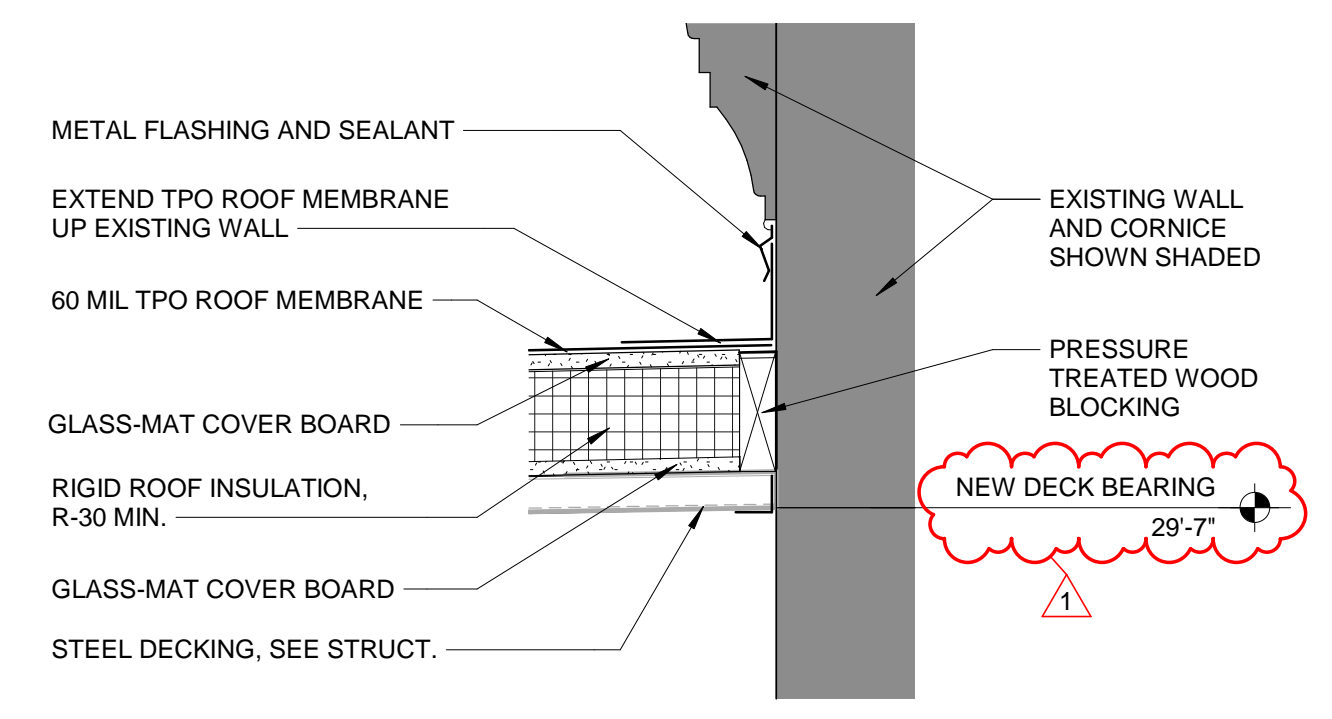
**VERIFY ALL DIMENSIONS AND EXISTING CONDITIONS, TYPICAL**




**5E SECTION DETAIL - PARAPET AT ELEVATOR**  
A114 1 1/2" = 1'-0"

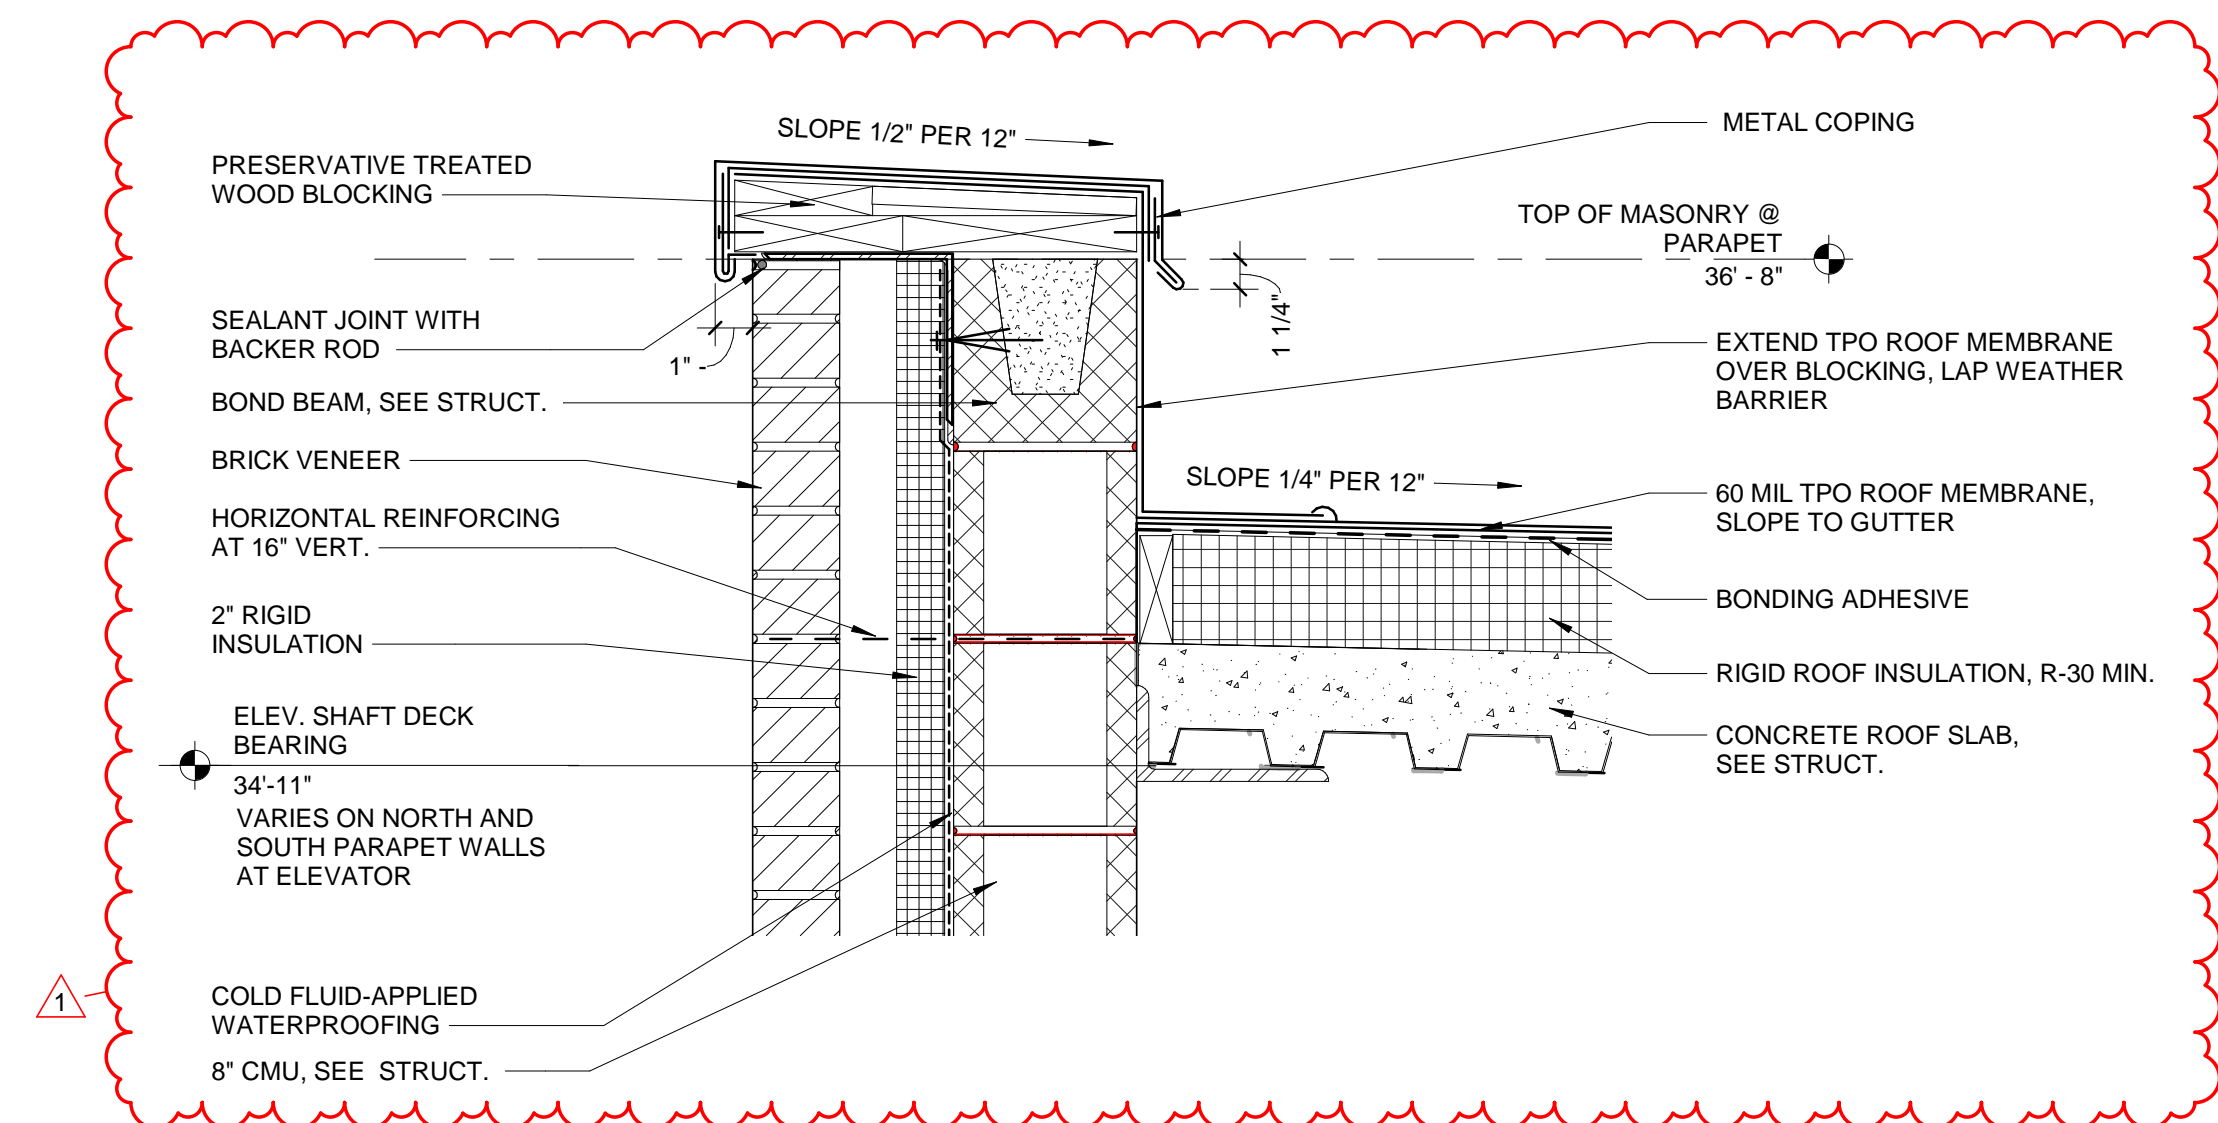


**5C SECTION DETAIL - GUTTER AT ROOF EDGE**  
A114 1 1/2" = 1'-0"

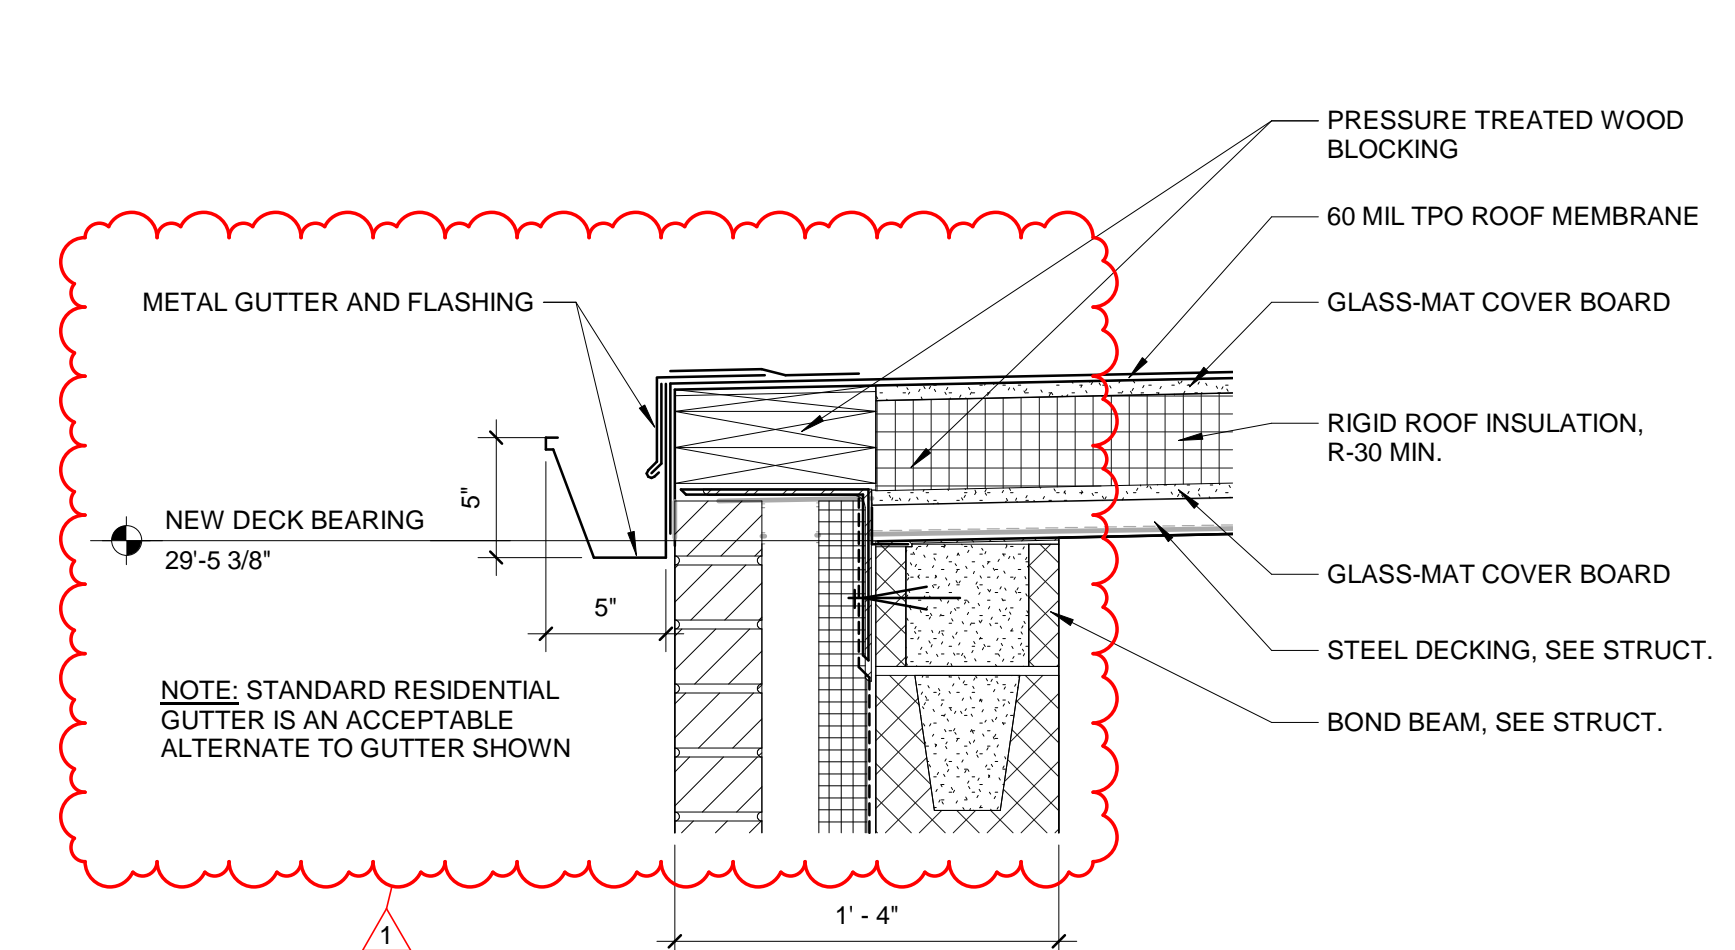

**6C SECTION DETAIL - NEW ROOF AT EXISTING WALL**  
A114 1 1/2" = 1'-0"

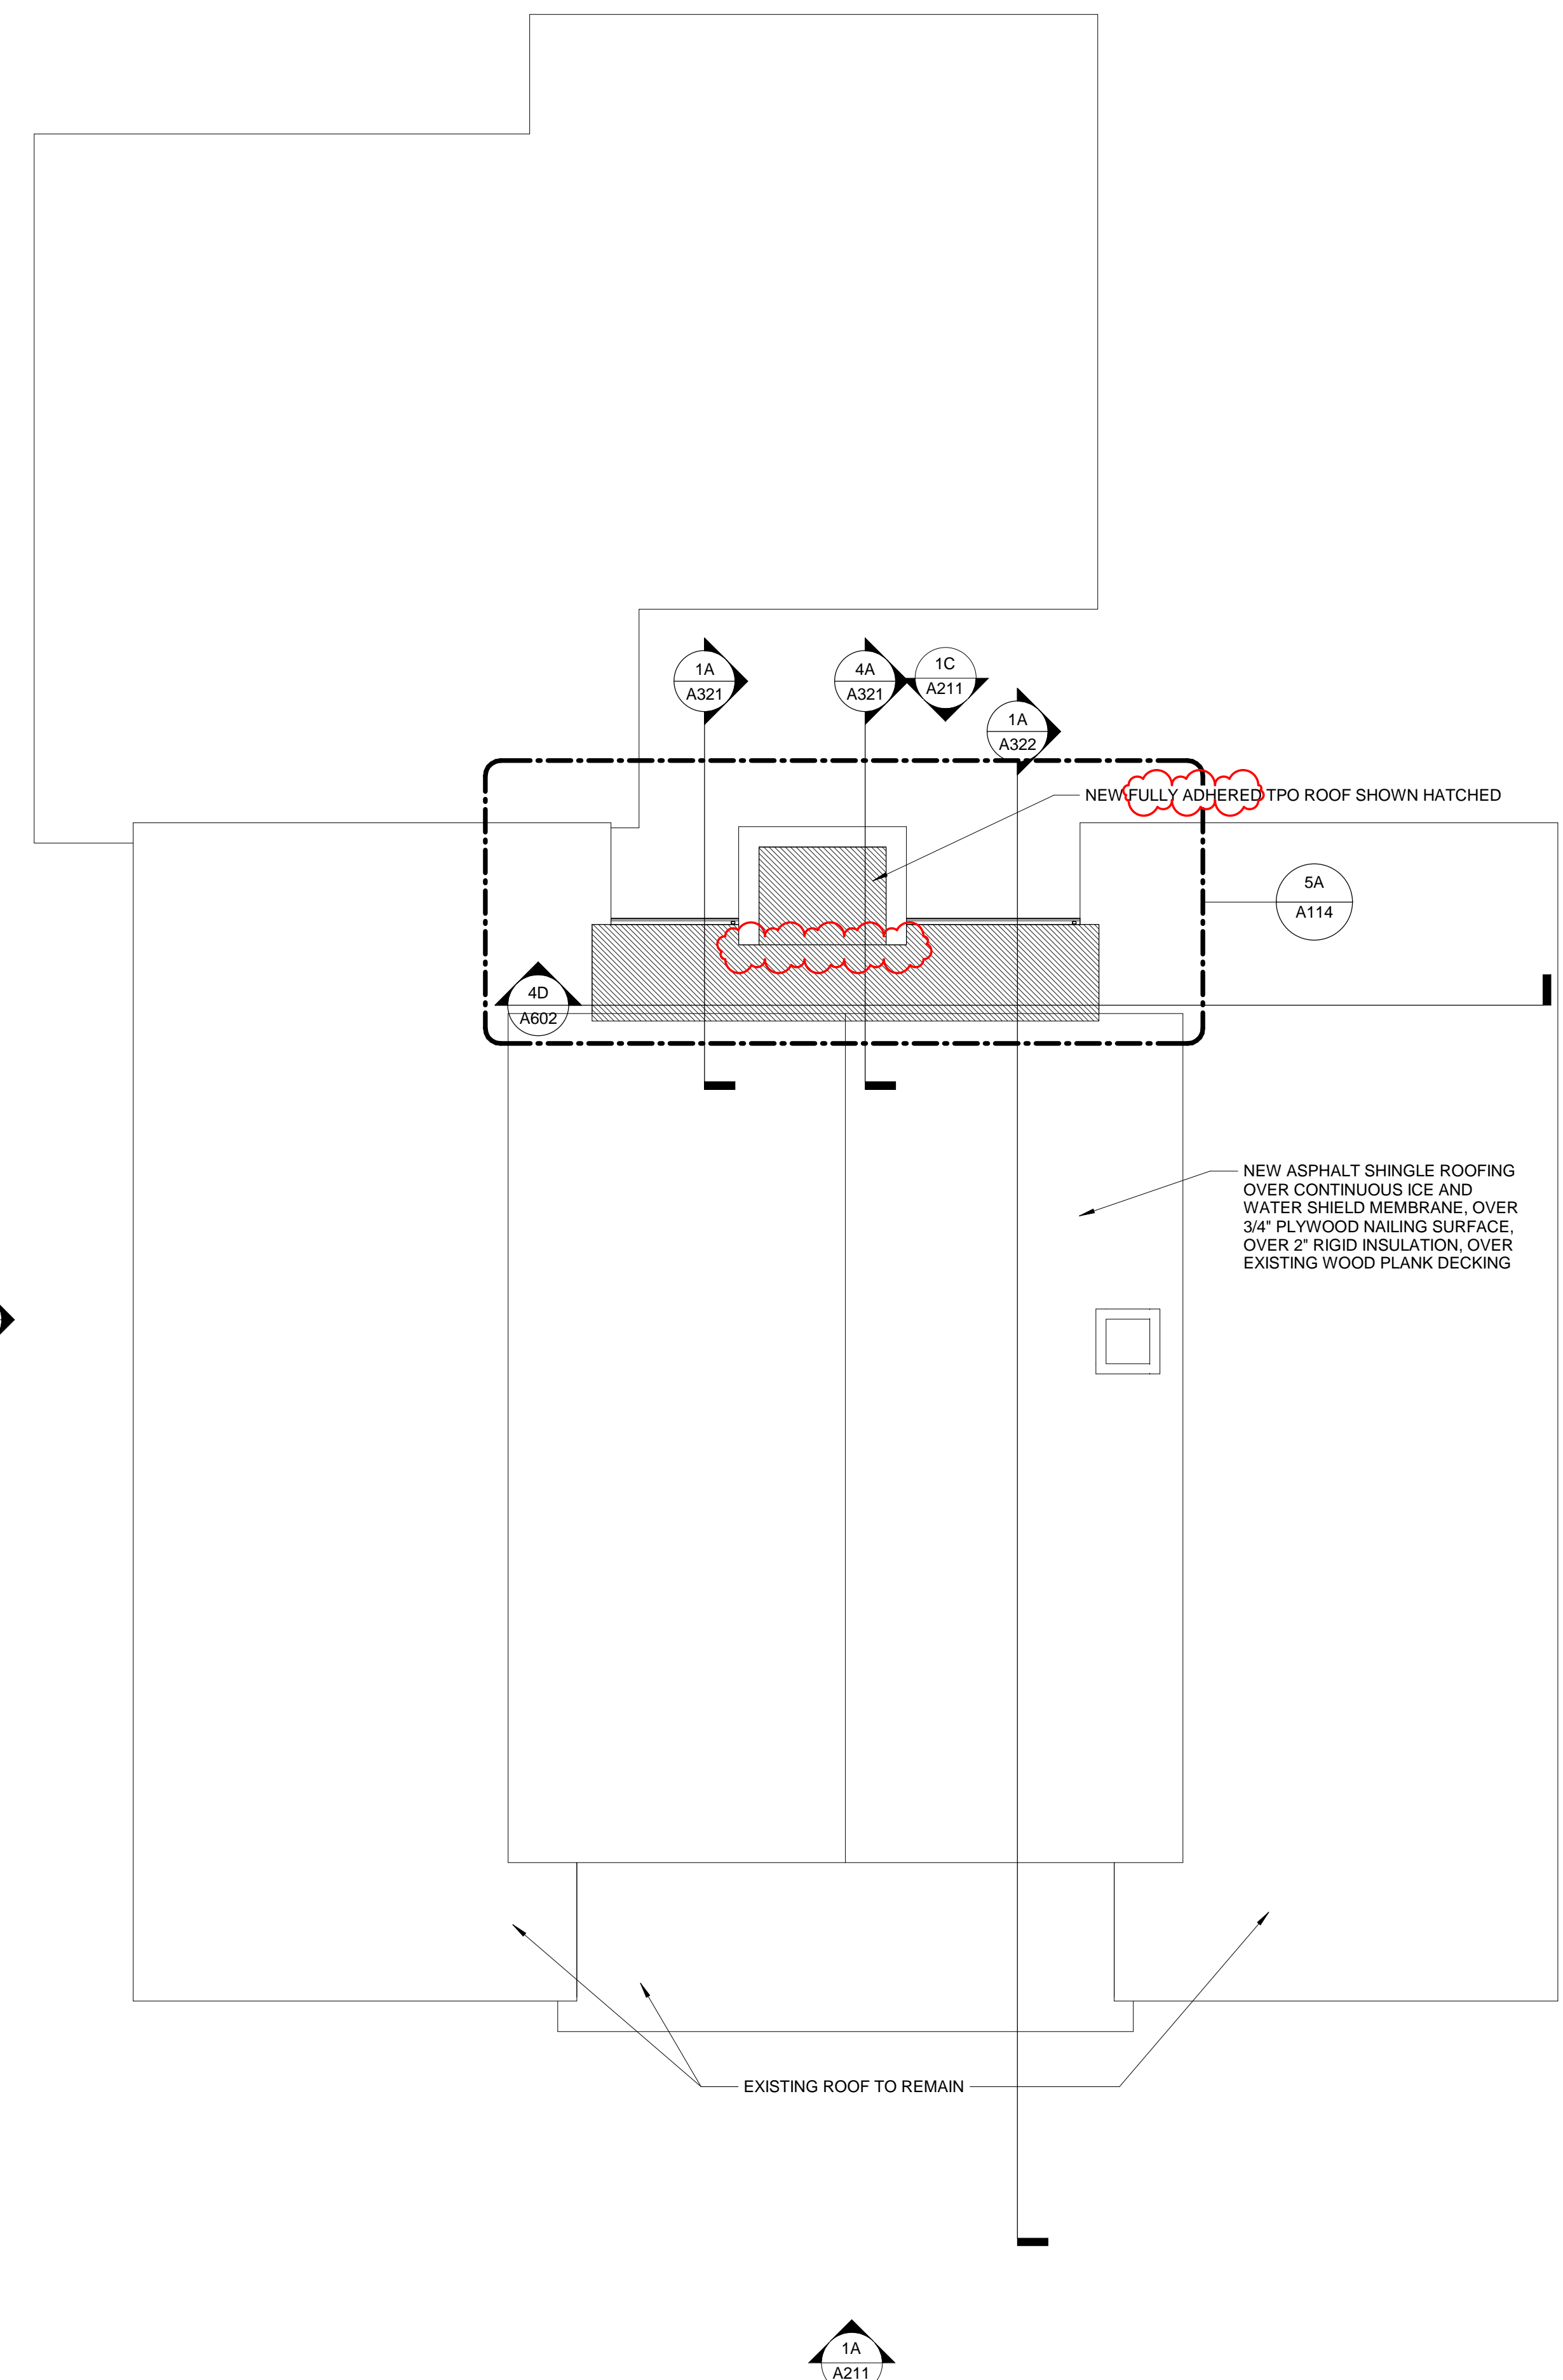

**1A Roof Plan - Base Bid**  
A114 1/8" = 1'-0"

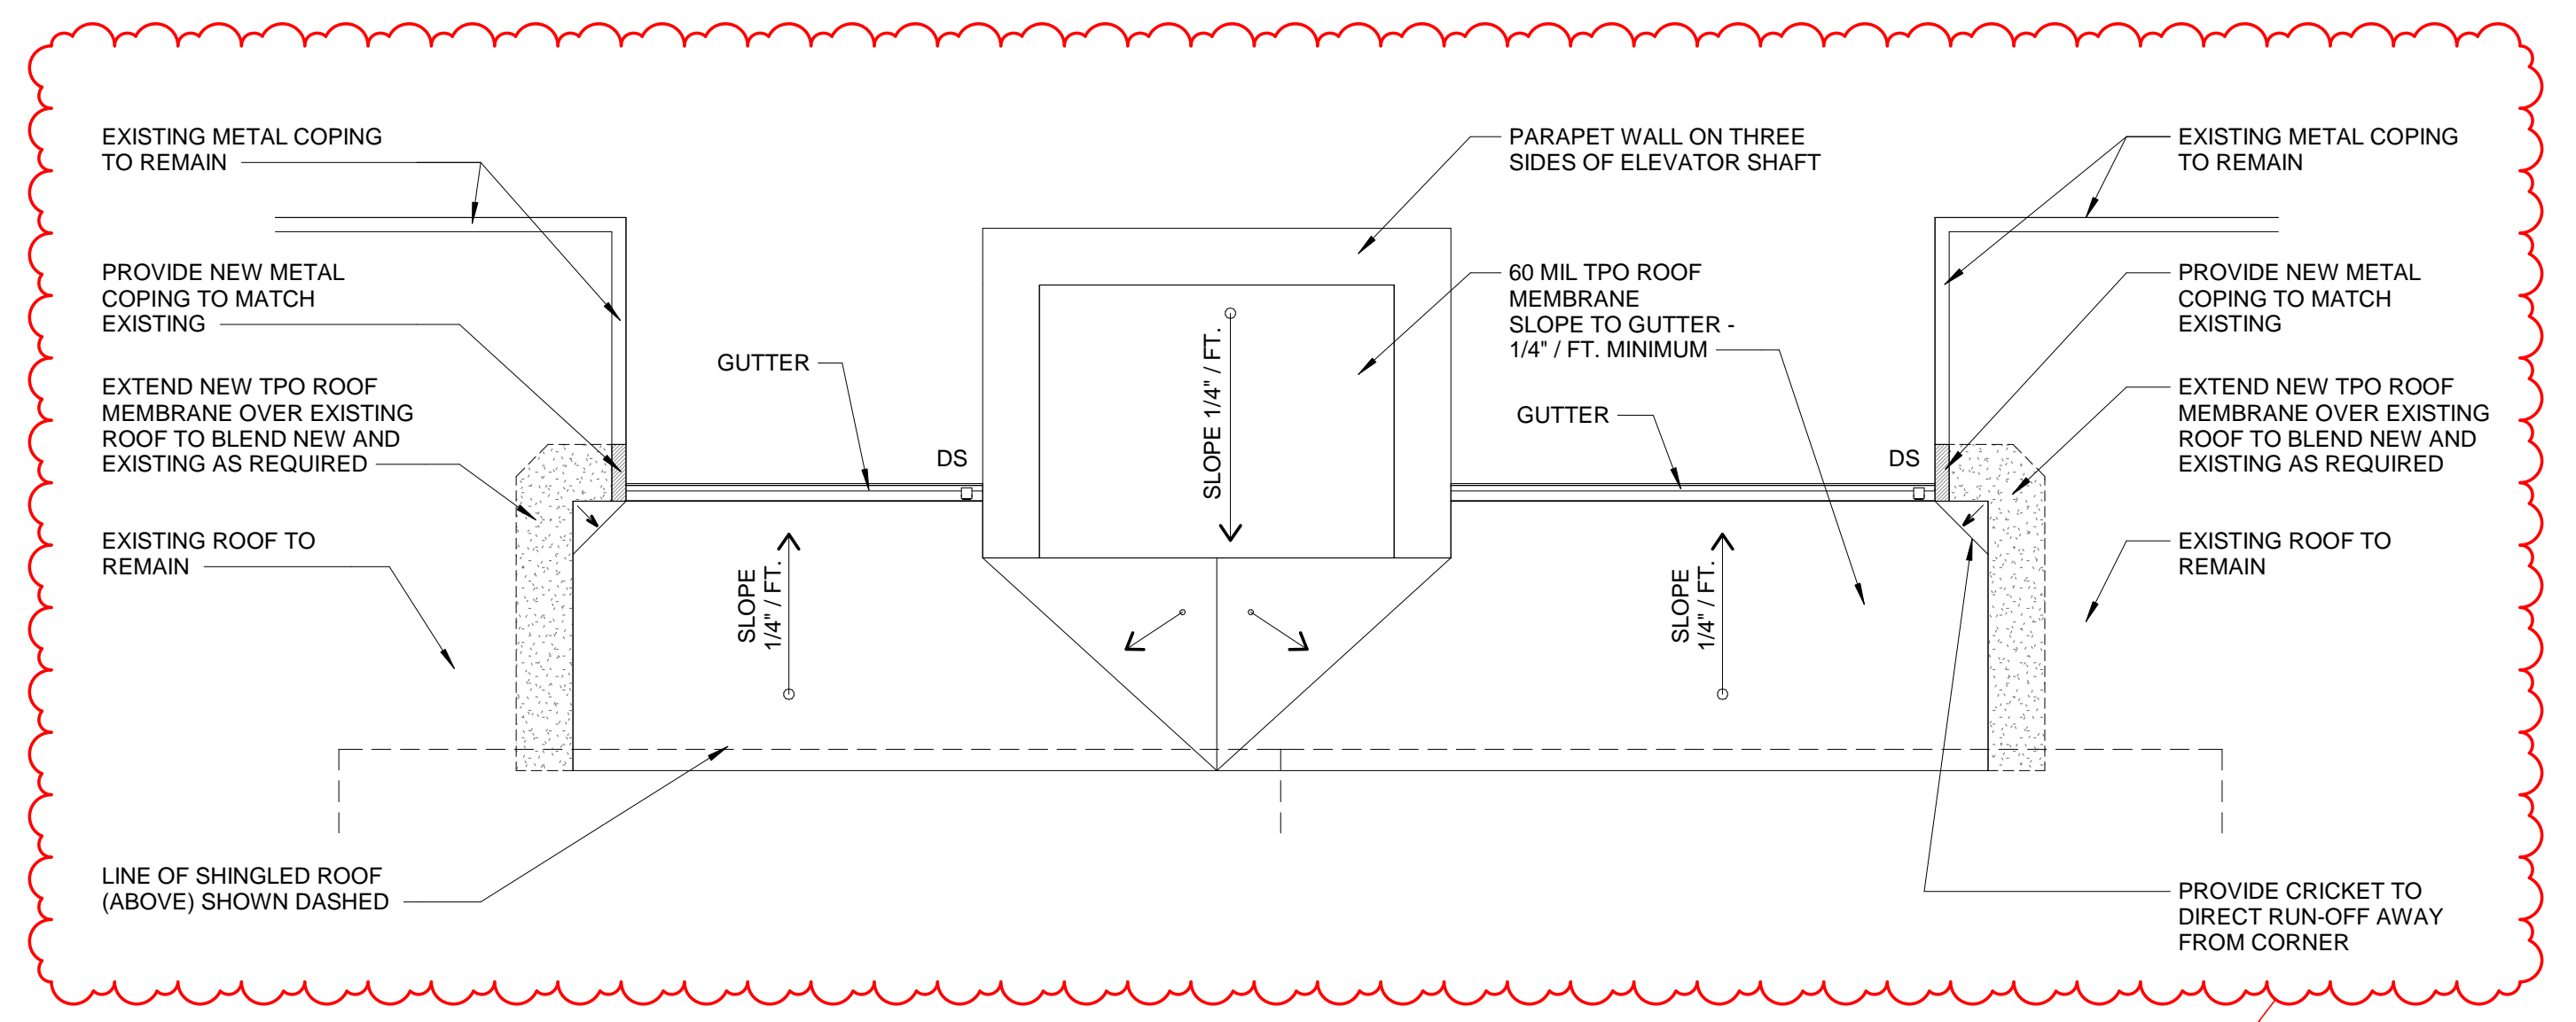

**5A ENLARGED PLAN - NEW ROOF**  
A114 1/4" = 1'-0"



09/11/2018

ISSUE FOR PERMIT SET

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REVISIONS

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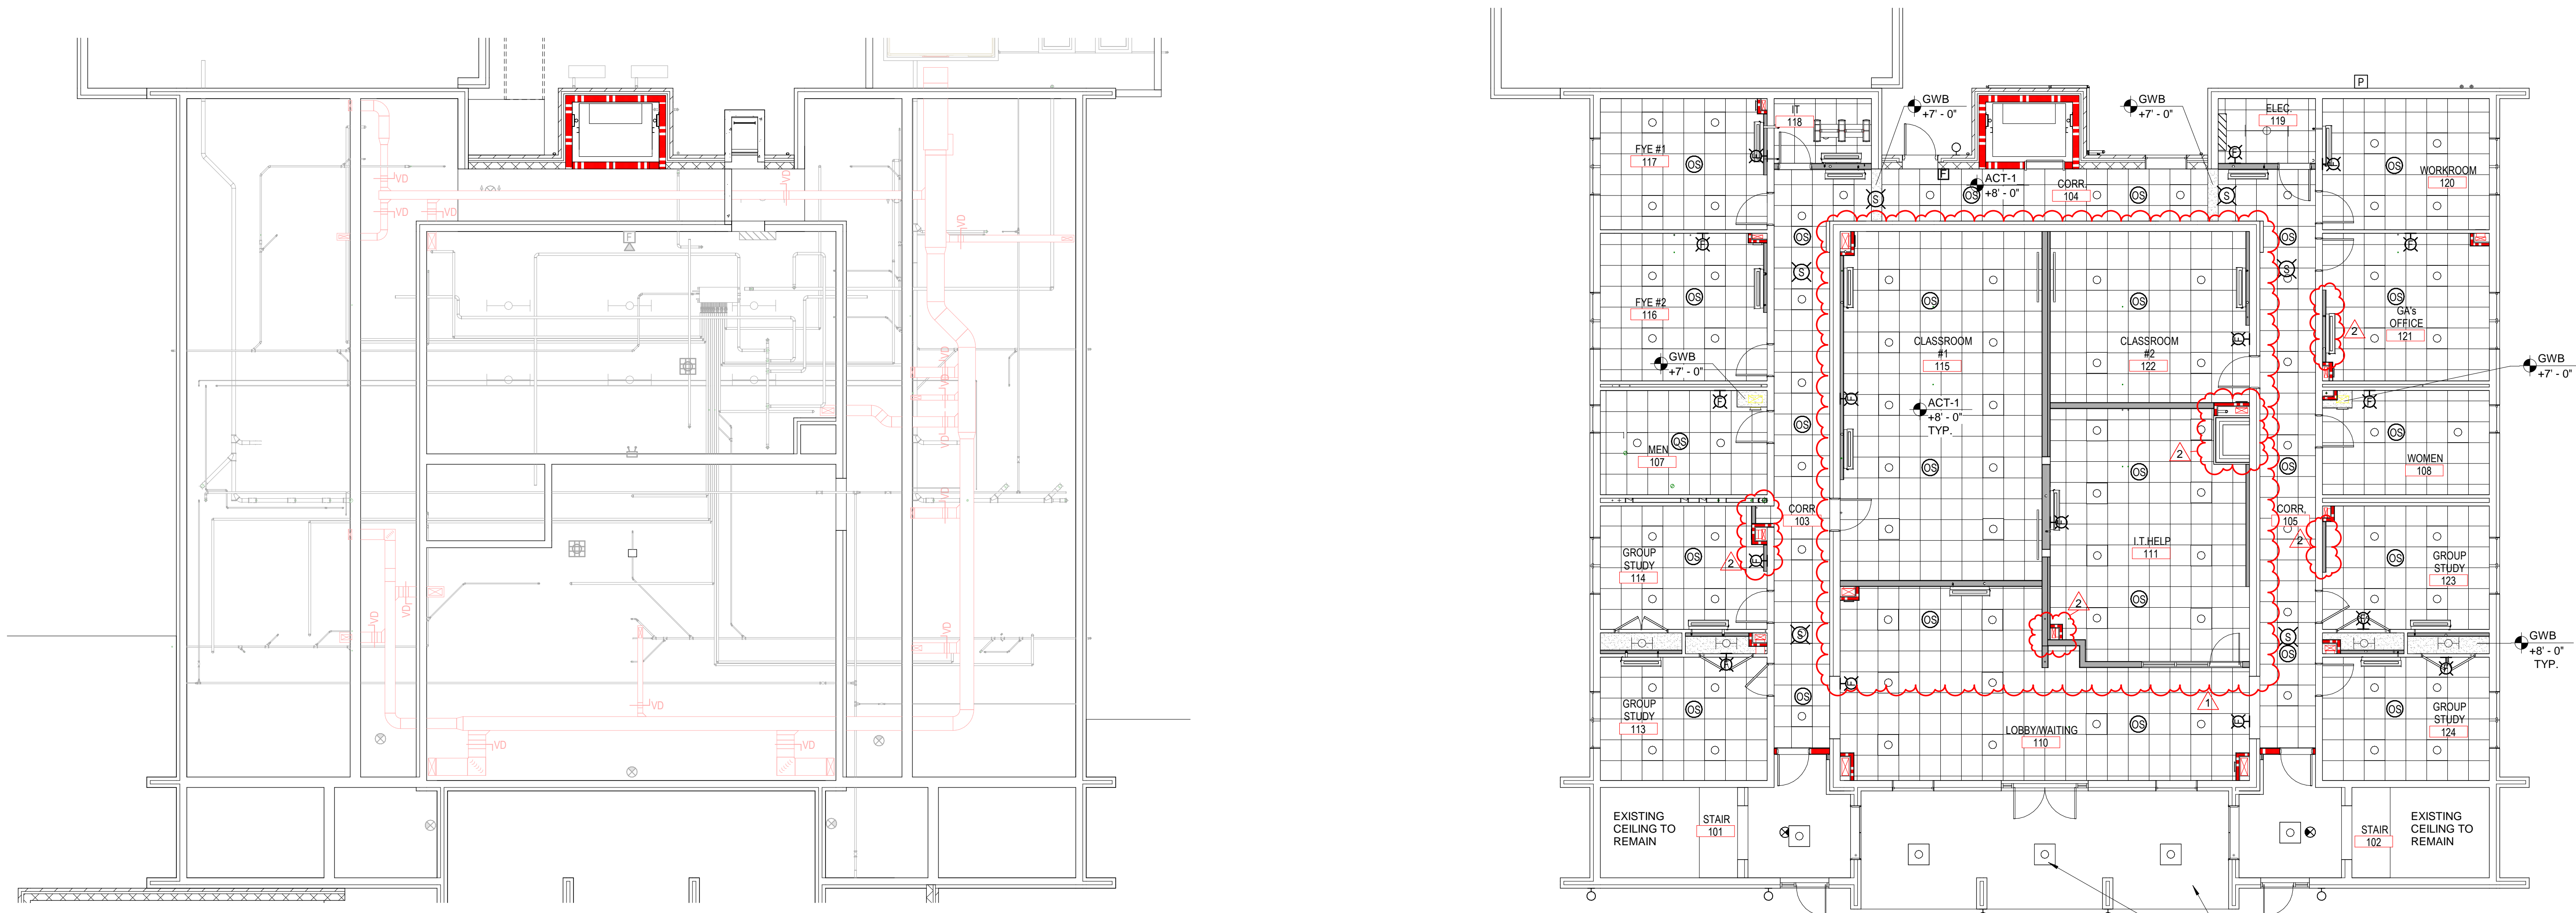
PROJECT TEAM  
 PRINCIPAL IN CHARGE: ROB KLINEINST, AIA  
 PROJECT MANAGER: SHANE WEBSTER, AIA  
 DESIGN TEAM: LITTLE  
 PROJECT NAME: CAMPBELL UNIVERSITY DAY HALL RENOVATIONS

PROJECT NO. 513.9660.00  
 SHEET TITLE: ROOF PLAN - BASE BID

SHEET NUMBER: A114

- A. FIELD VERIFY ALL DIMENSIONS AND EXISTING CONDITIONS.
- B. ARCHITECTURAL CEILING PLAN SHALL GOVERN FOR LOCATIONS OF ALL DEVICES AS SHOWN. ENGINEERING DOCUMENTS SHALL PREVAIL ONLY IN CASE OF SCOPE OF WORK AND ELEMENTS OCCURRING ABOVE CEILING. DISCREPANCIES (IF ANY) BETWEEN ARCHITECTURAL AND ENGINEERING DOCUMENTS MUST BE BROUGHT TO THE ARCHITECTS ATTENTION. AT TIME OF BID ANY COSTS ASSOCIATED W/ SPECIFICATION DISCREPANCIES NOT BROUGHT TO THE ARCHITECTS ATTENTION SHALL BE THE SOLE RESPONSIBILITY OF THE SUBCONTRACTOR.
- C. TILES SHALL BE INSTALLED SO GRAIN LINES OF TILE ARE RUNNING IN SAME DIRECTION ON ALL CEILINGS.
- D. ACOUSTICAL CONTRACTOR SHALL MIX TILE IN A UNIFORM MANNER TO ELIMINATE BANDING OR BATCHING.
- E. FOLLOWING COMPLETION OF ACOUSTICAL CEILING INSTALLATION, ALL JOINTS SHALL BE STRAIGHT AND TRUE TO LINE, WITH EXPOSED SURFACES FLUSH AND LEVEL.
- F. ALL LIGHTS SHALL BE BLDG. STD. FIXTURES, U.O.N.
- G. PROVIDE BUILDING STANDARD SPRINKLERS AS REQUIRED BY CODE PER NEW PARTITION LAYOUT.
- H. ALL NEW/RELOCATED SPRINKLER HEADS SHALL BE CENTERED IN MODULE OF THE TILE INDICATED.
- I. ALL NEW/RELOCATED SPRINKLER HEADS SHALL BE CENTERED IN MODULE OF THE TILE INDICATED.
- J. CONTRACTOR SHALL TEST AND BALANCE HVAC PER NEW PARTITION LAYOUT.
- K. FULL HEIGHT PARTITION WALLS CAN NOT HAVE ANY PORTION OF A V.A.V. BOX OR FAN POWERED BOX ABOVE THEM. RELOCATE AFFECTED V.A.V. AND F.P. BOXES AS REQUIRED.
- L. IF CEILING DIFFUSER, LIGHT FIXTURES OR OTHER ELEMENTS ON OR ABOVE THE CEILING CAN NOT BE LOCATED AS SHOWN ON THE DRAWINGS, SUCH INTERFERENCE SHALL BE REPORTED IMMEDIATELY TO LITTLE FOR RELOCATION.
- M. PROVIDE EMERGENCY BATTERY PACKS OR EMERGENCY CIRCUITS AS REQUIRED BY CODE. SEE ELECTRICAL DRAWINGS FOR CIRCUITRY OF EMERGENCY LIGHT FIXTURES.
- N. GENERAL CONTRACTOR SHALL BE RESPONSIBLE FOR FINAL QUANTITY AND LOCATION OF ALL EMERGENCY DEVICES INCLUDING BUT NOT LIMITED TO: BATTERY PACKS, EXIT SIGNS, FIRE ALARMS, ETC.) WITH MUNICIPAL AGENCY HAVING JURISDICTION.
- O. DIMMERS AND SWITCHES SHALL BE GANGED TOGETHER IN LARGEST MULTI-GANG BOXES WITH COMMON FACE PLATES POSSIBLE. STACKING OF LARGE BOXES (5 SWITCHES ABOVE 5 SWITCHES) IS ACCEPTABLE.
- P. ALL MATERIALS PLACED IN CEILING SHALL BE REQUIRED TO HAVE A PLENUM RATING.
- Q. STENCIL ALL RATED WALLS ABOVE CEILING AS REQUIRED.

VERIFY ALL DIMENSIONS AND EXISTING CONDITIONS, TYPICAL



1A Level 0  
A121 1/8" = 1'-0"

4A Level 1  
A121 1/8" = 1'-0"



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PROJECT TEAM  
PRINCIPAL IN CHARGE: ROB KLINEDINST, AIA  
PROJECT MANAGER: SHANE WEBSTER, AIA  
DESIGN TEAM: LITTLE  
PROGRAM NAME: CAMPBELL UNIVERSITY DAY HALL RENOVATIONS

PROJECT NO. 513.9660.00



SHEET TITLE REFLECTED CEILING PLANS - BASE BID - LEVELS 0 AND 1

SHEET NUMBER A121



- A. FIELD VERIFY ALL DIMENSIONS AND EXISTING CONDITIONS.
- B. ARCHITECTURAL CEILING PLAN SHALL GOVERN FOR LOCATIONS OF ALL DEVICES AS SHOWN. ENGINEERING DOCUMENTS SHALL PREVAIL ONLY IN CASE OF SCOPE OF WORK AND ELEMENTS OCCURRING ABOVE CEILING. DISCREPANCIES (IF ANY) BETWEEN ARCHITECTURAL AND ENGINEERING DOCUMENTS MUST BE BROUGHT TO THE ARCHITECTS ATTENTION. AT TIME OF BID ANY COSTS ASSOCIATED W/ SPECIFICATION DISCREPANCIES NOT BROUGHT TO THE ARCHITECTS ATTENTION SHALL BE THE SOLE RESPONSIBILITY OF THE SUBCONTRACTOR.
- C. TILES SHALL BE INSTALLED SO GRAIN LINES OF TILE ARE RUNNING IN SAME DIRECTION ON ALL CEILINGS.
- D. ACOUSTICAL CONTRACTOR SHALL MIX TILE IN A UNIFORM MANNER TO ELIMINATE BANDING OR BATCHING.
- E. FOLLOWING COMPLETION OF ACOUSTICAL CEILING INSTALLATION, ALL JOINTS SHALL BE STRAIGHT AND TRUE TO LINE, WITH EXPOSED SURFACES FLUSH AND LEVEL.
- F. ALL LIGHTS SHALL BE BLDG. STD. FIXTURES, U.O.N.
- G. PROVIDE BUILDING STANDARD SPRINKLERS AS REQUIRED BY CODE PER NEW PARTITION LAYOUT.
- H. ALL NEW/RELOCATED SPRINKLER HEADS SHALL BE CENTERED IN MODULE OF THE TILE INDICATED.
- I. ALL NEW/RELOCATED SPRINKLER HEADS SHALL BE CENTERED IN MODULE OF THE TILE INDICATED.
- J. CONTRACTOR SHALL TEST AND BALANCE HVAC PER NEW PARTITION LAYOUT.
- K. FULL HEIGHT PARTITION WALLS CAN NOT HAVE ANY PORTION OF A V.A.V. BOX OR FAN POWERED BOX ABOVE THEM. RELOCATE AFFECTED V.A.V. AND F.P. BOXES AS REQUIRED.
- L. IF CEILING DIFFUSER, LIGHT FIXTURES OR OTHER ELEMENTS ON OR ABOVE THE CEILING CAN NOT BE LOCATED AS SHOWN ON THE DRAWINGS, SUCH INTERFERENCE SHALL BE REPORTED IMMEDIATELY TO LITTLE FOR RELOCATION.
- M. PROVIDE EMERGENCY BATTERY PACKS OR EMERGENCY CIRCUITS AS REQUIRED BY CODE. SEE ELECTRICAL DRAWINGS FOR CIRCUITRY OF EMERGENCY LIGHT FIXTURES.
- N. GENERAL CONTRACTOR SHALL BE RESPONSIBLE FOR FINAL QUANTITY AND LOCATION OF ALL EMERGENCY DEVICES (INCLUDING BUT NOT LIMITED TO: BATTERY PACKS, EXIT SIGNS, FIRE ALARMS, ETC.) WITH MUNICIPAL AGENCY HAVING JURISDICTION.
- O. DIMMERS AND SWITCHES SHALL BE GANGED TOGETHER IN LARGEST MULTISWITCH BOXES WITH COMMON FACE PLATES POSSIBLE. STACKING OF LARGE BOXES (5 SWITCHES ABOVE 5 SWITCHES) IS ACCEPTABLE.
- P. ALL MATERIALS PLACED IN CEILING SHALL BE REQUIRED TO HAVE A PLENUM RATING.
- Q. STENCIL ALL RATED WALLS ABOVE CEILING AS REQUIRED.

VERIFY ALL DIMENSIONS AND EXISTING CONDITIONS, TYPICAL

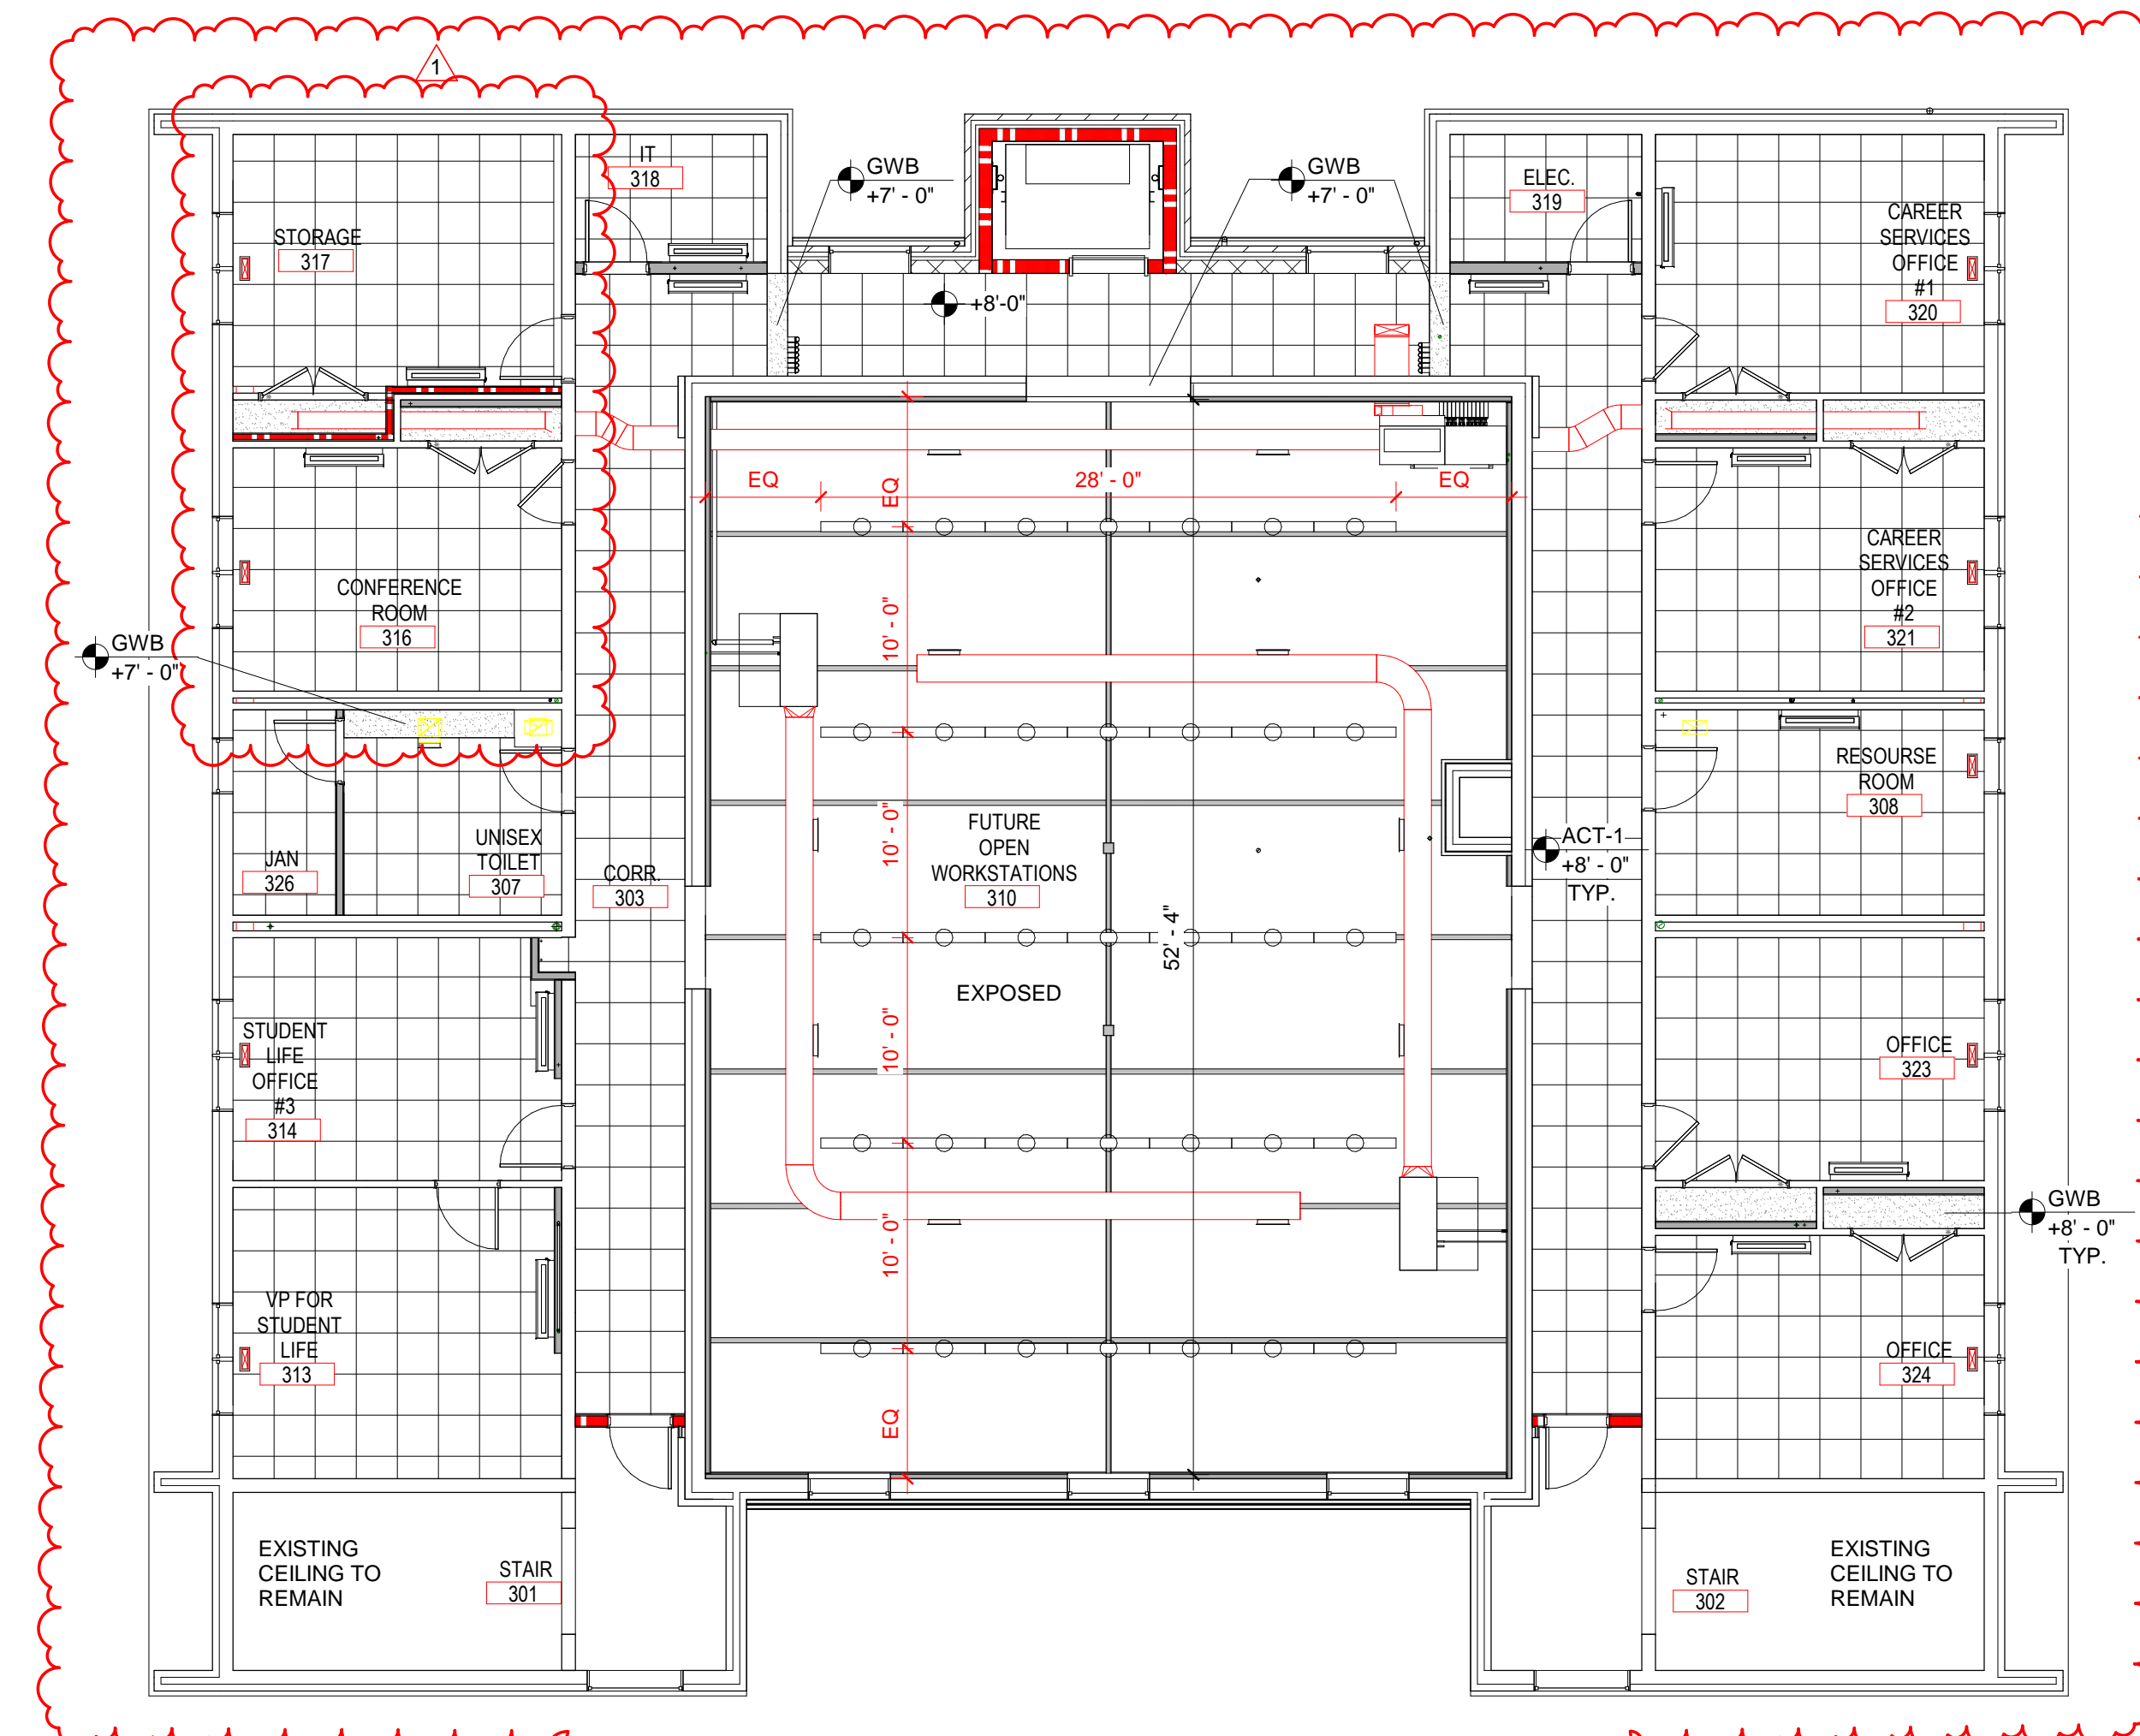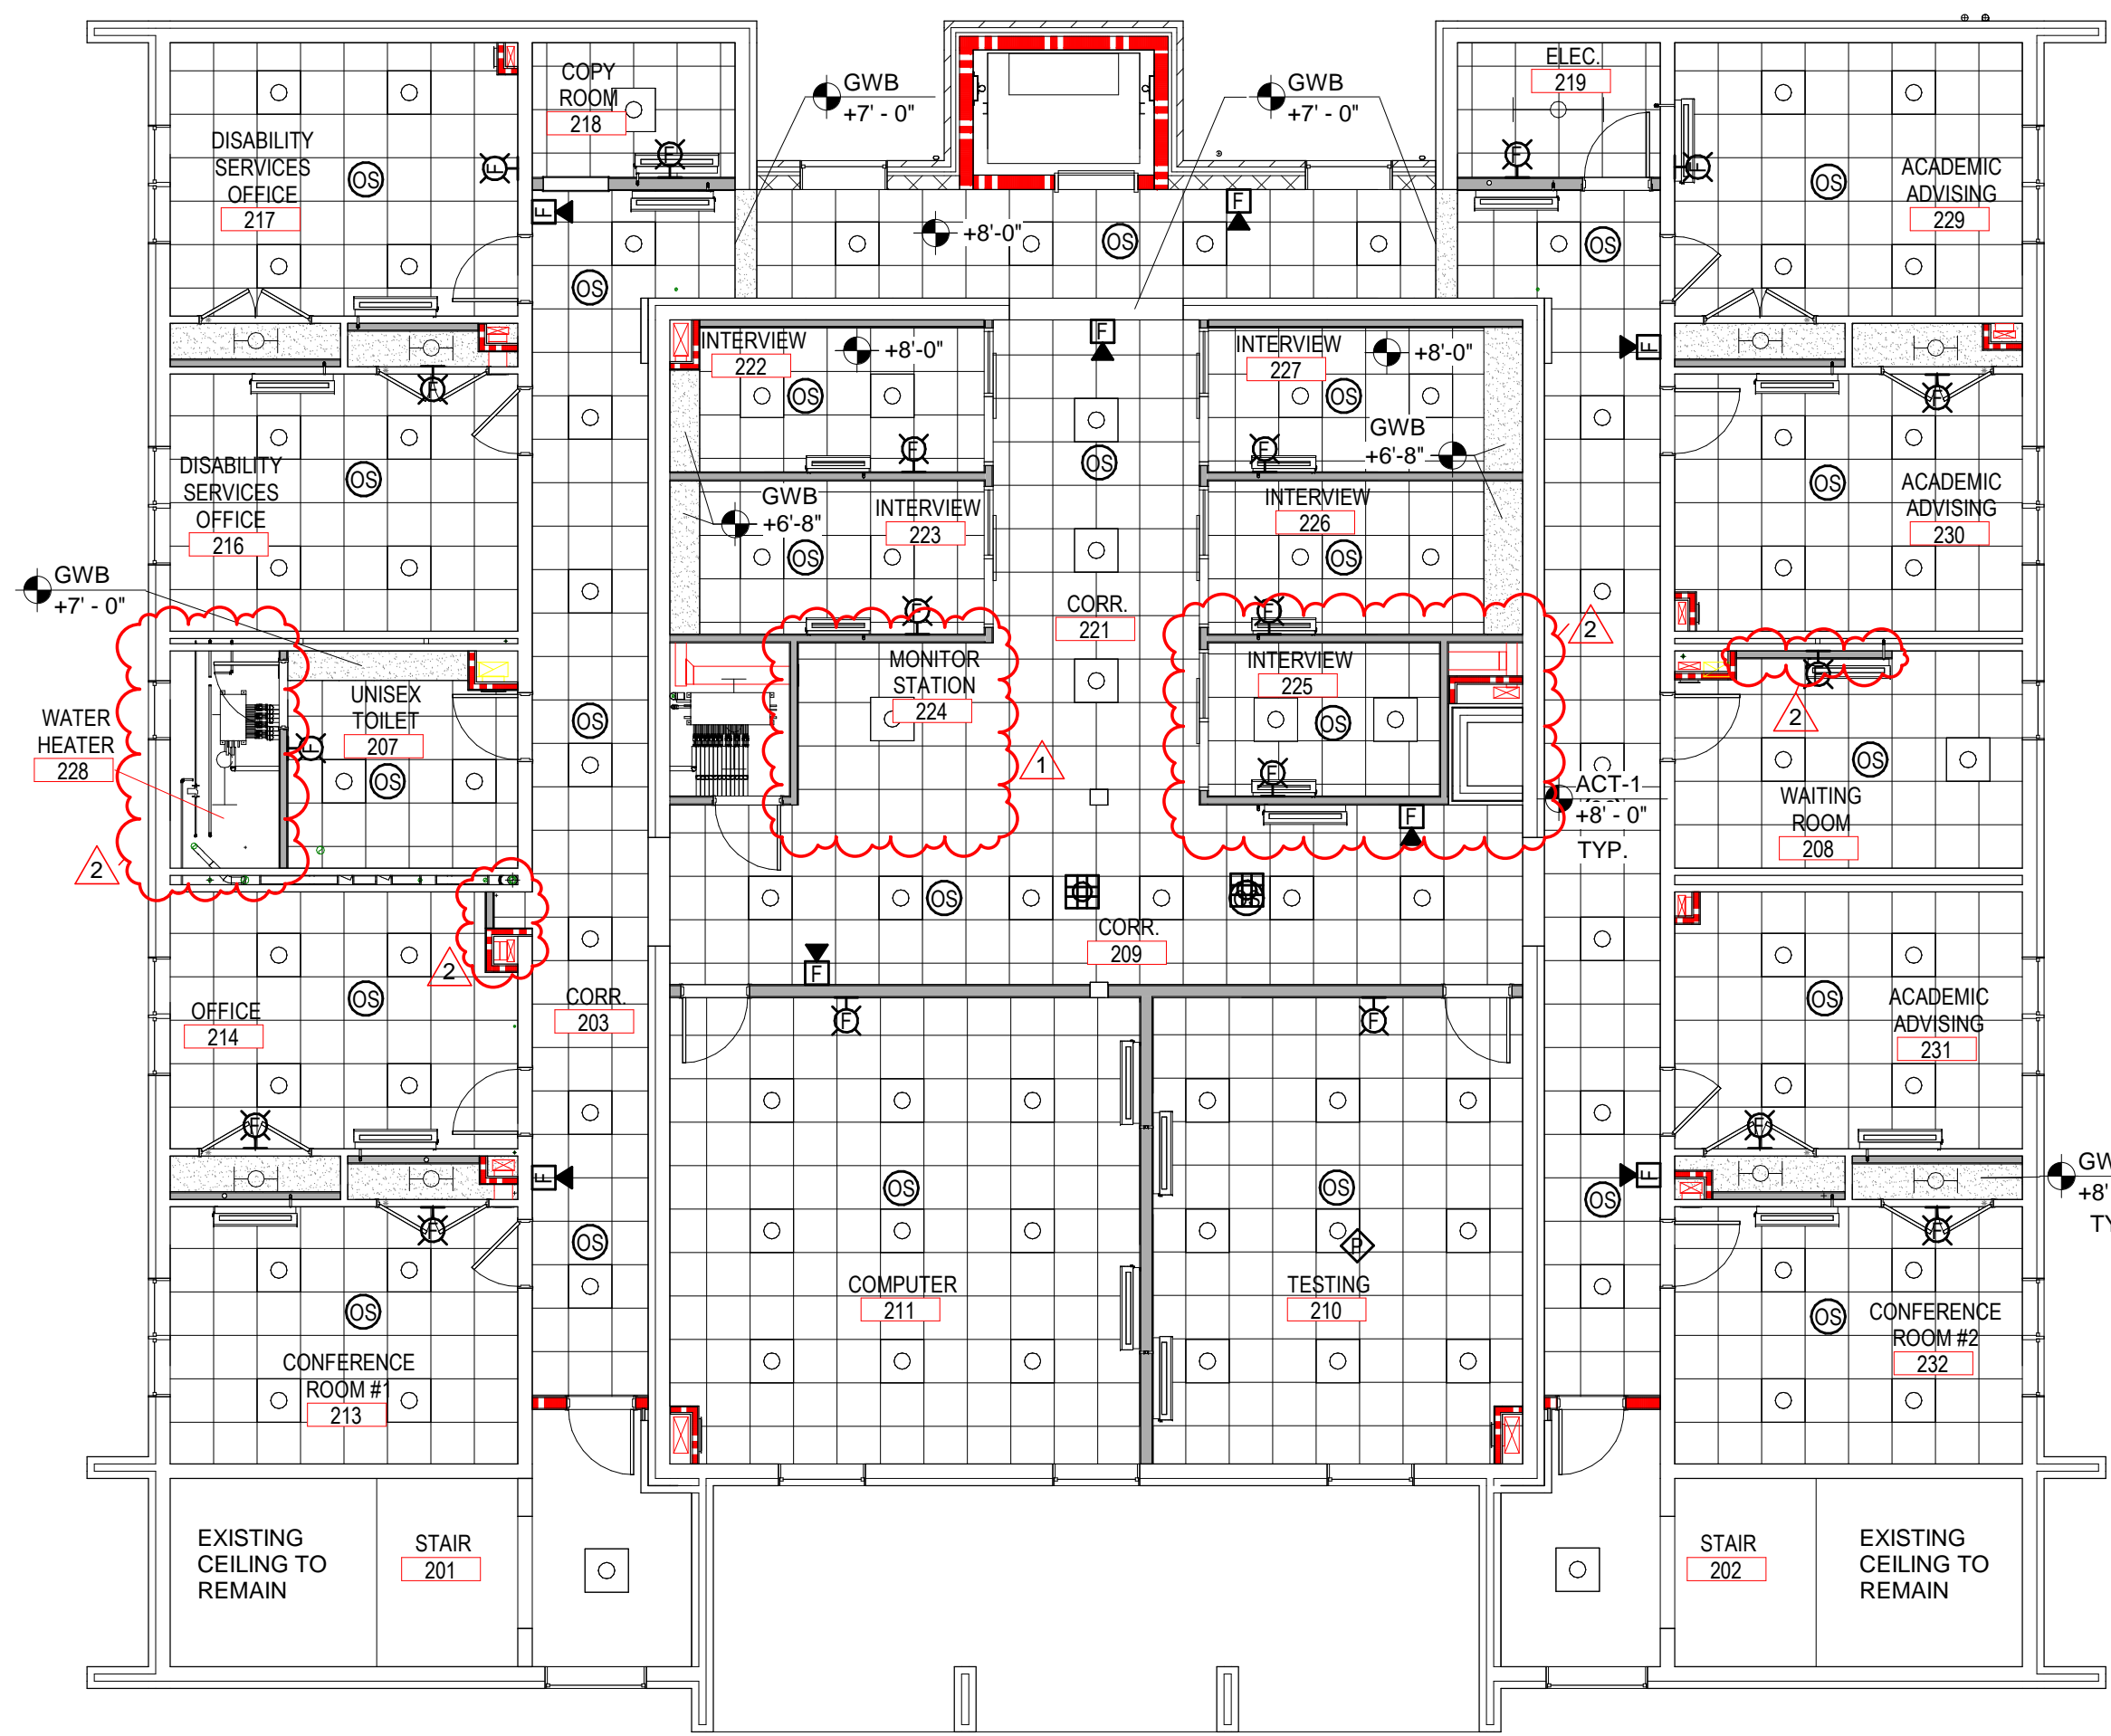

NOTES:  
 1. BASE BID ON LEVEL 3 INCLUDES: NEW ELEVATOR SHAFT AND ROOF, NEW ELEVATOR, NEW EXTERIOR CORRIDOR WALL WITH SALVAGED WINDOWS, NEW CORRIDOR ROOF, NEW CONCRETE RAMP, WORK IN IT AND ELEC. ROOMS  
 2. ALL OTHER WORK ON LEVEL 3 IS TO BE INCLUDED IN FUTURE PHASE 2 UNLESS OTHERWISE NOTED.

1A Level 2  
 A122 1/8" = 1'-0"

4A Level 3  
 A122 1/8" = 1'-0"

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ISSUE FOR:  
**PERMIT SET**

ISSUE DATE:  
 09.11.2018

REVISIONS NO.	REASON	DATE
1	AV Revisions by Owner and Quality Control	08.20.18
2	Revisions by Owner	09.11.18

PROJECT TEAM  
 PRINCIPAL IN CHARGE: **ROB KLINEINST, AIA**  
 PROJECT MANAGER: **SHANE WEBSTER, AIA**  
 DESIGN TEAM: **LITTLE**  
 PROJECT NAME: **CAMPBELL UNIVERSITY DAY HALL RENOVATIONS**

PROJECT NO.:  
**513.9660.00**

SHEET TITLE:  
**REFLECTED CEILING PLANS - BASE BID - LEVELS 2 AND 3**


SHEET NUMBER:  
**A122**

VERIFY ALL DIMENSIONS AND EXISTING CONDITIONS, TYPICAL


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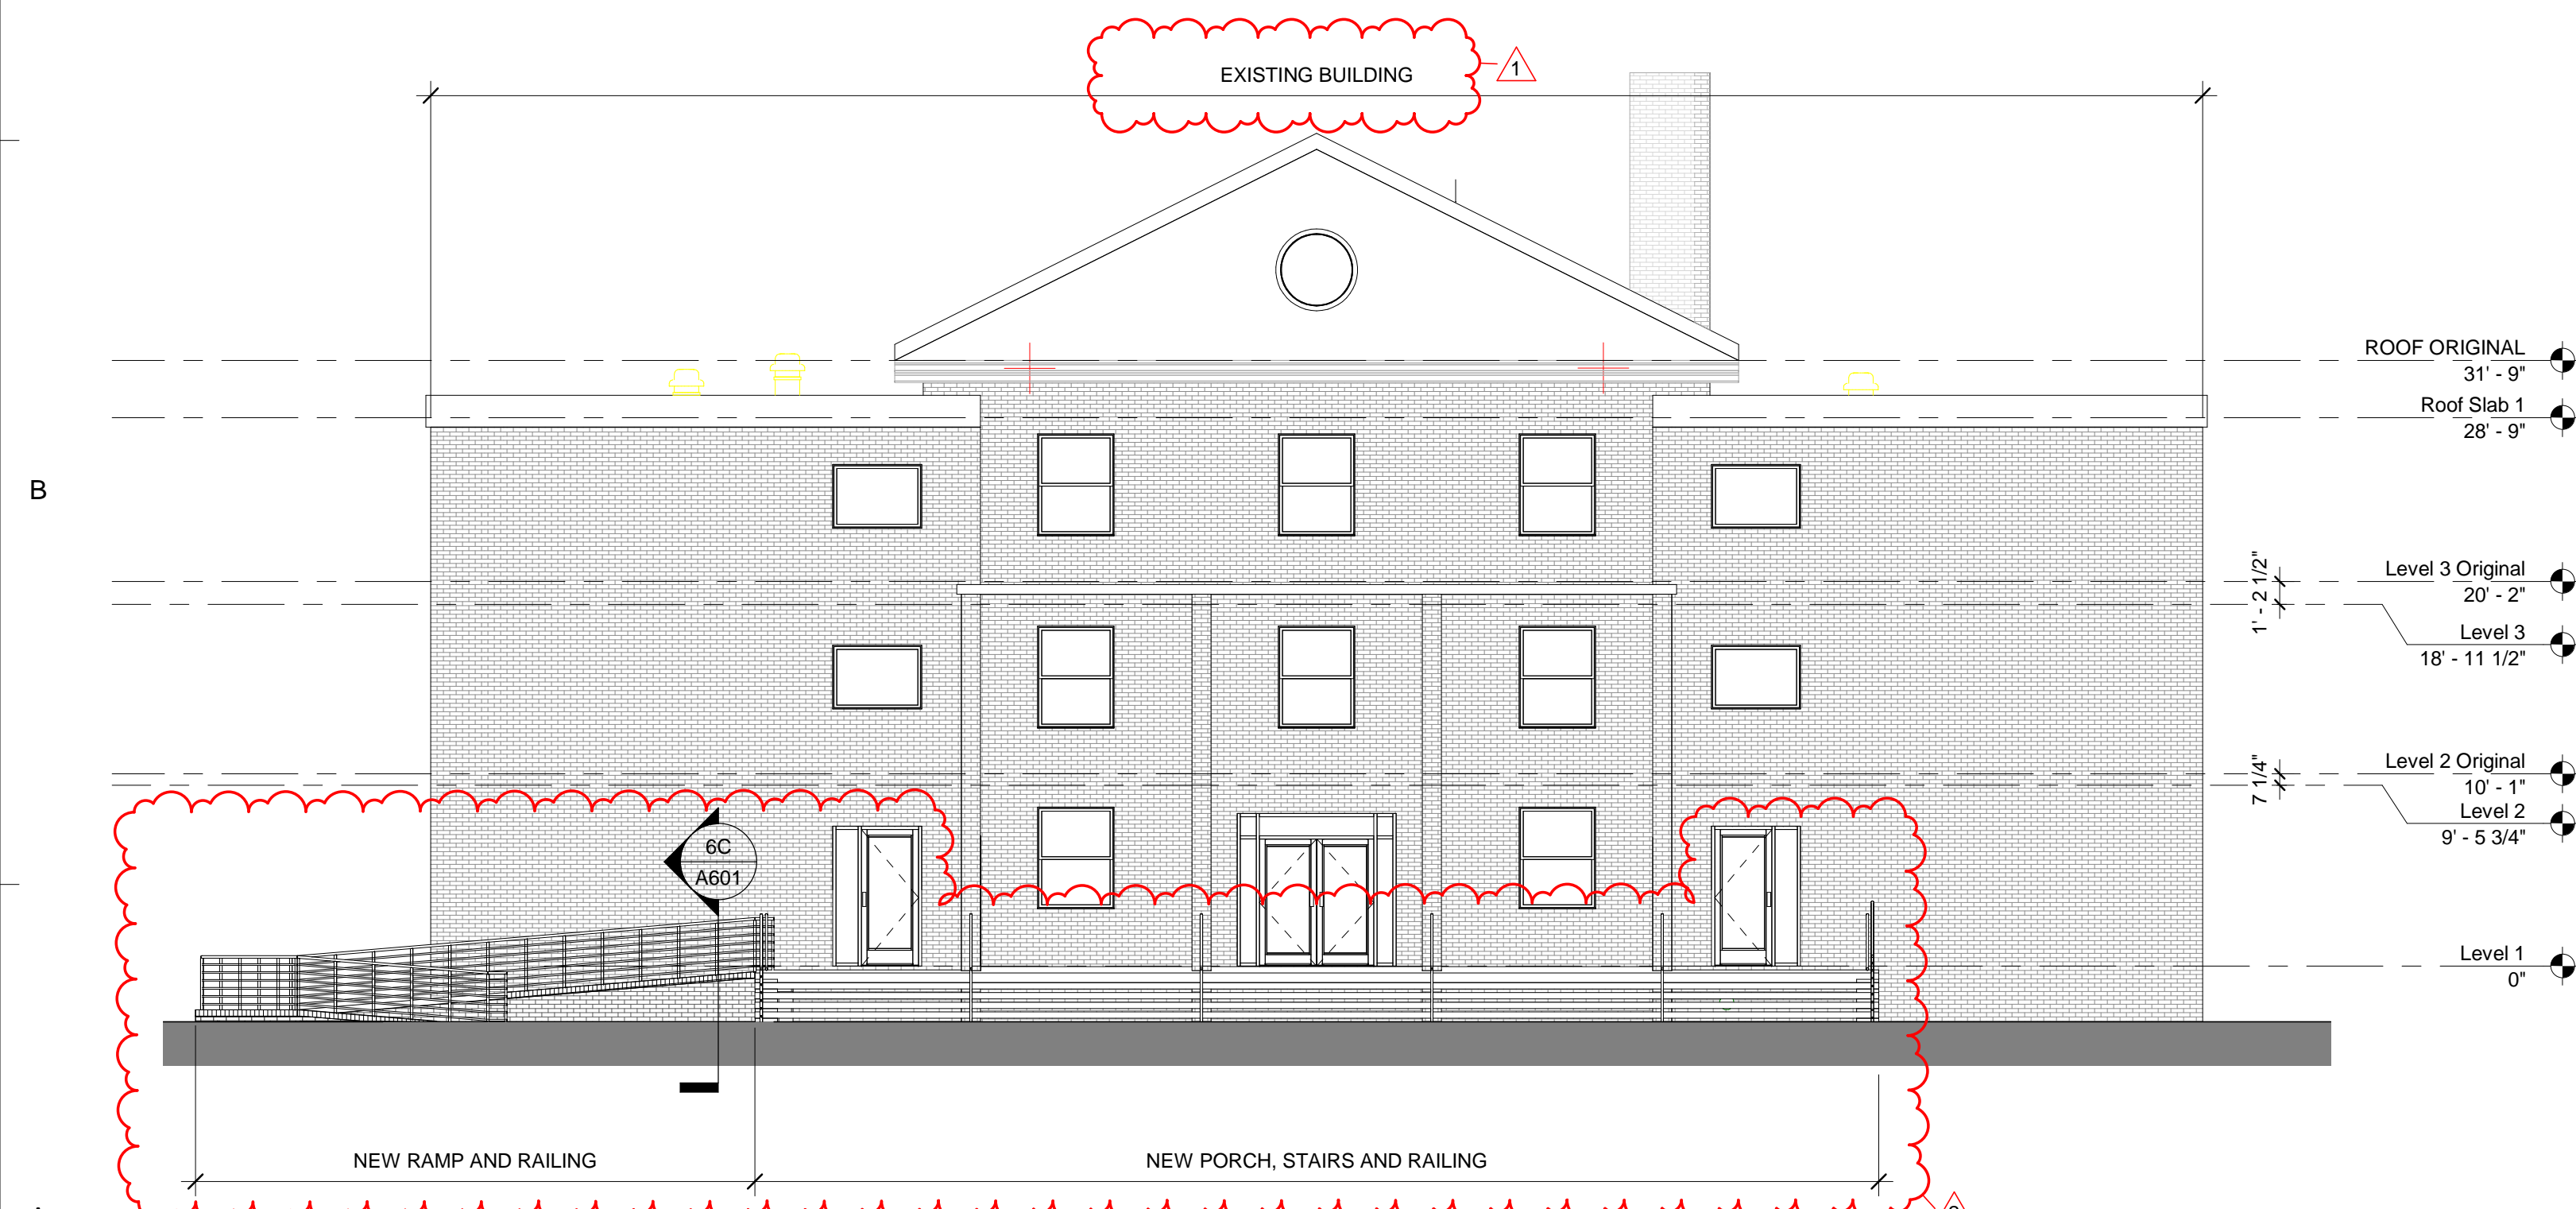
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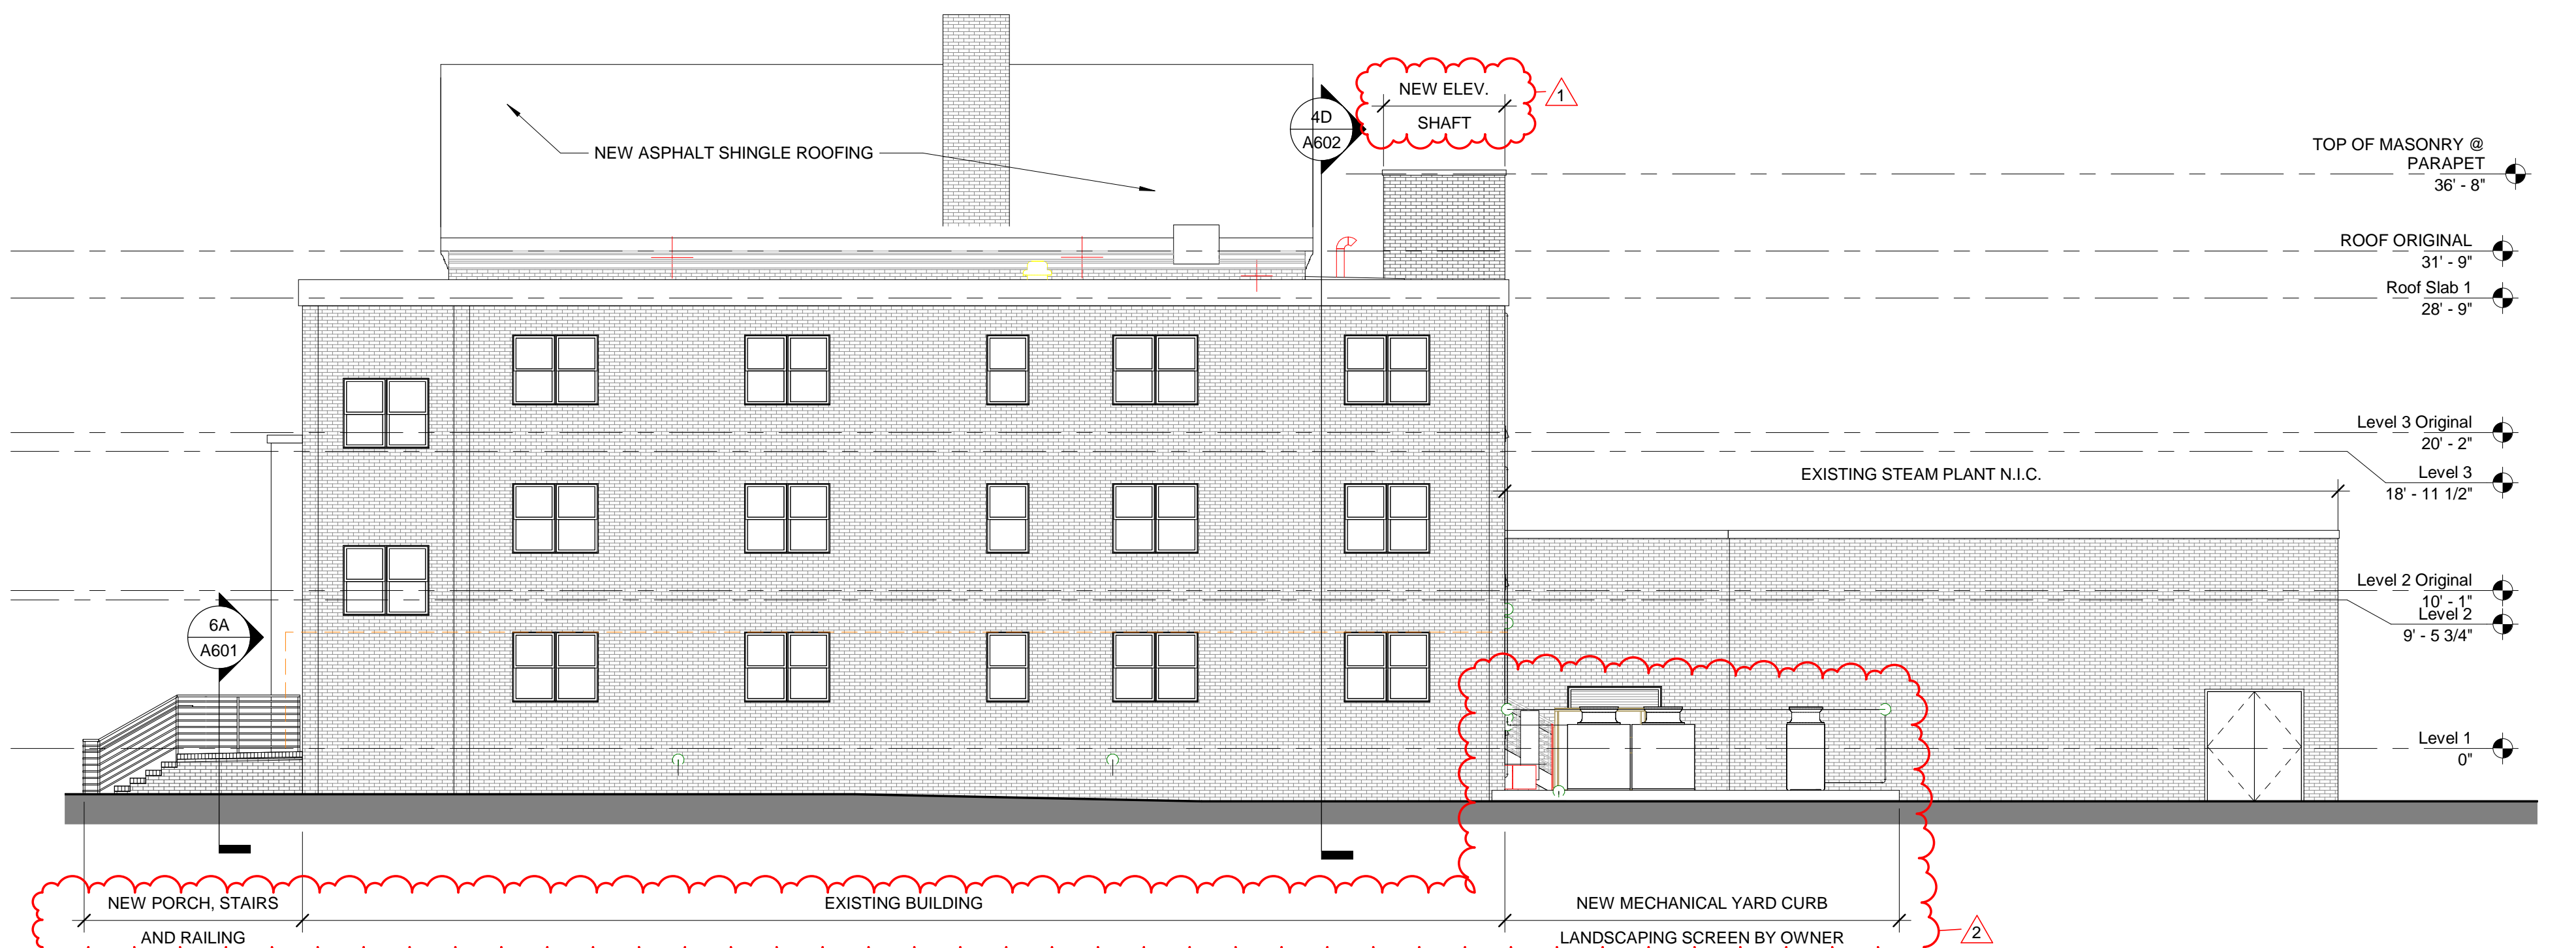
1C NORTH ELEVATION - BASE BID  
A211 1/8" = 1'-0"



4C WEST ELEVATION - BASE BID  
A211 1/8" = 1'-0"

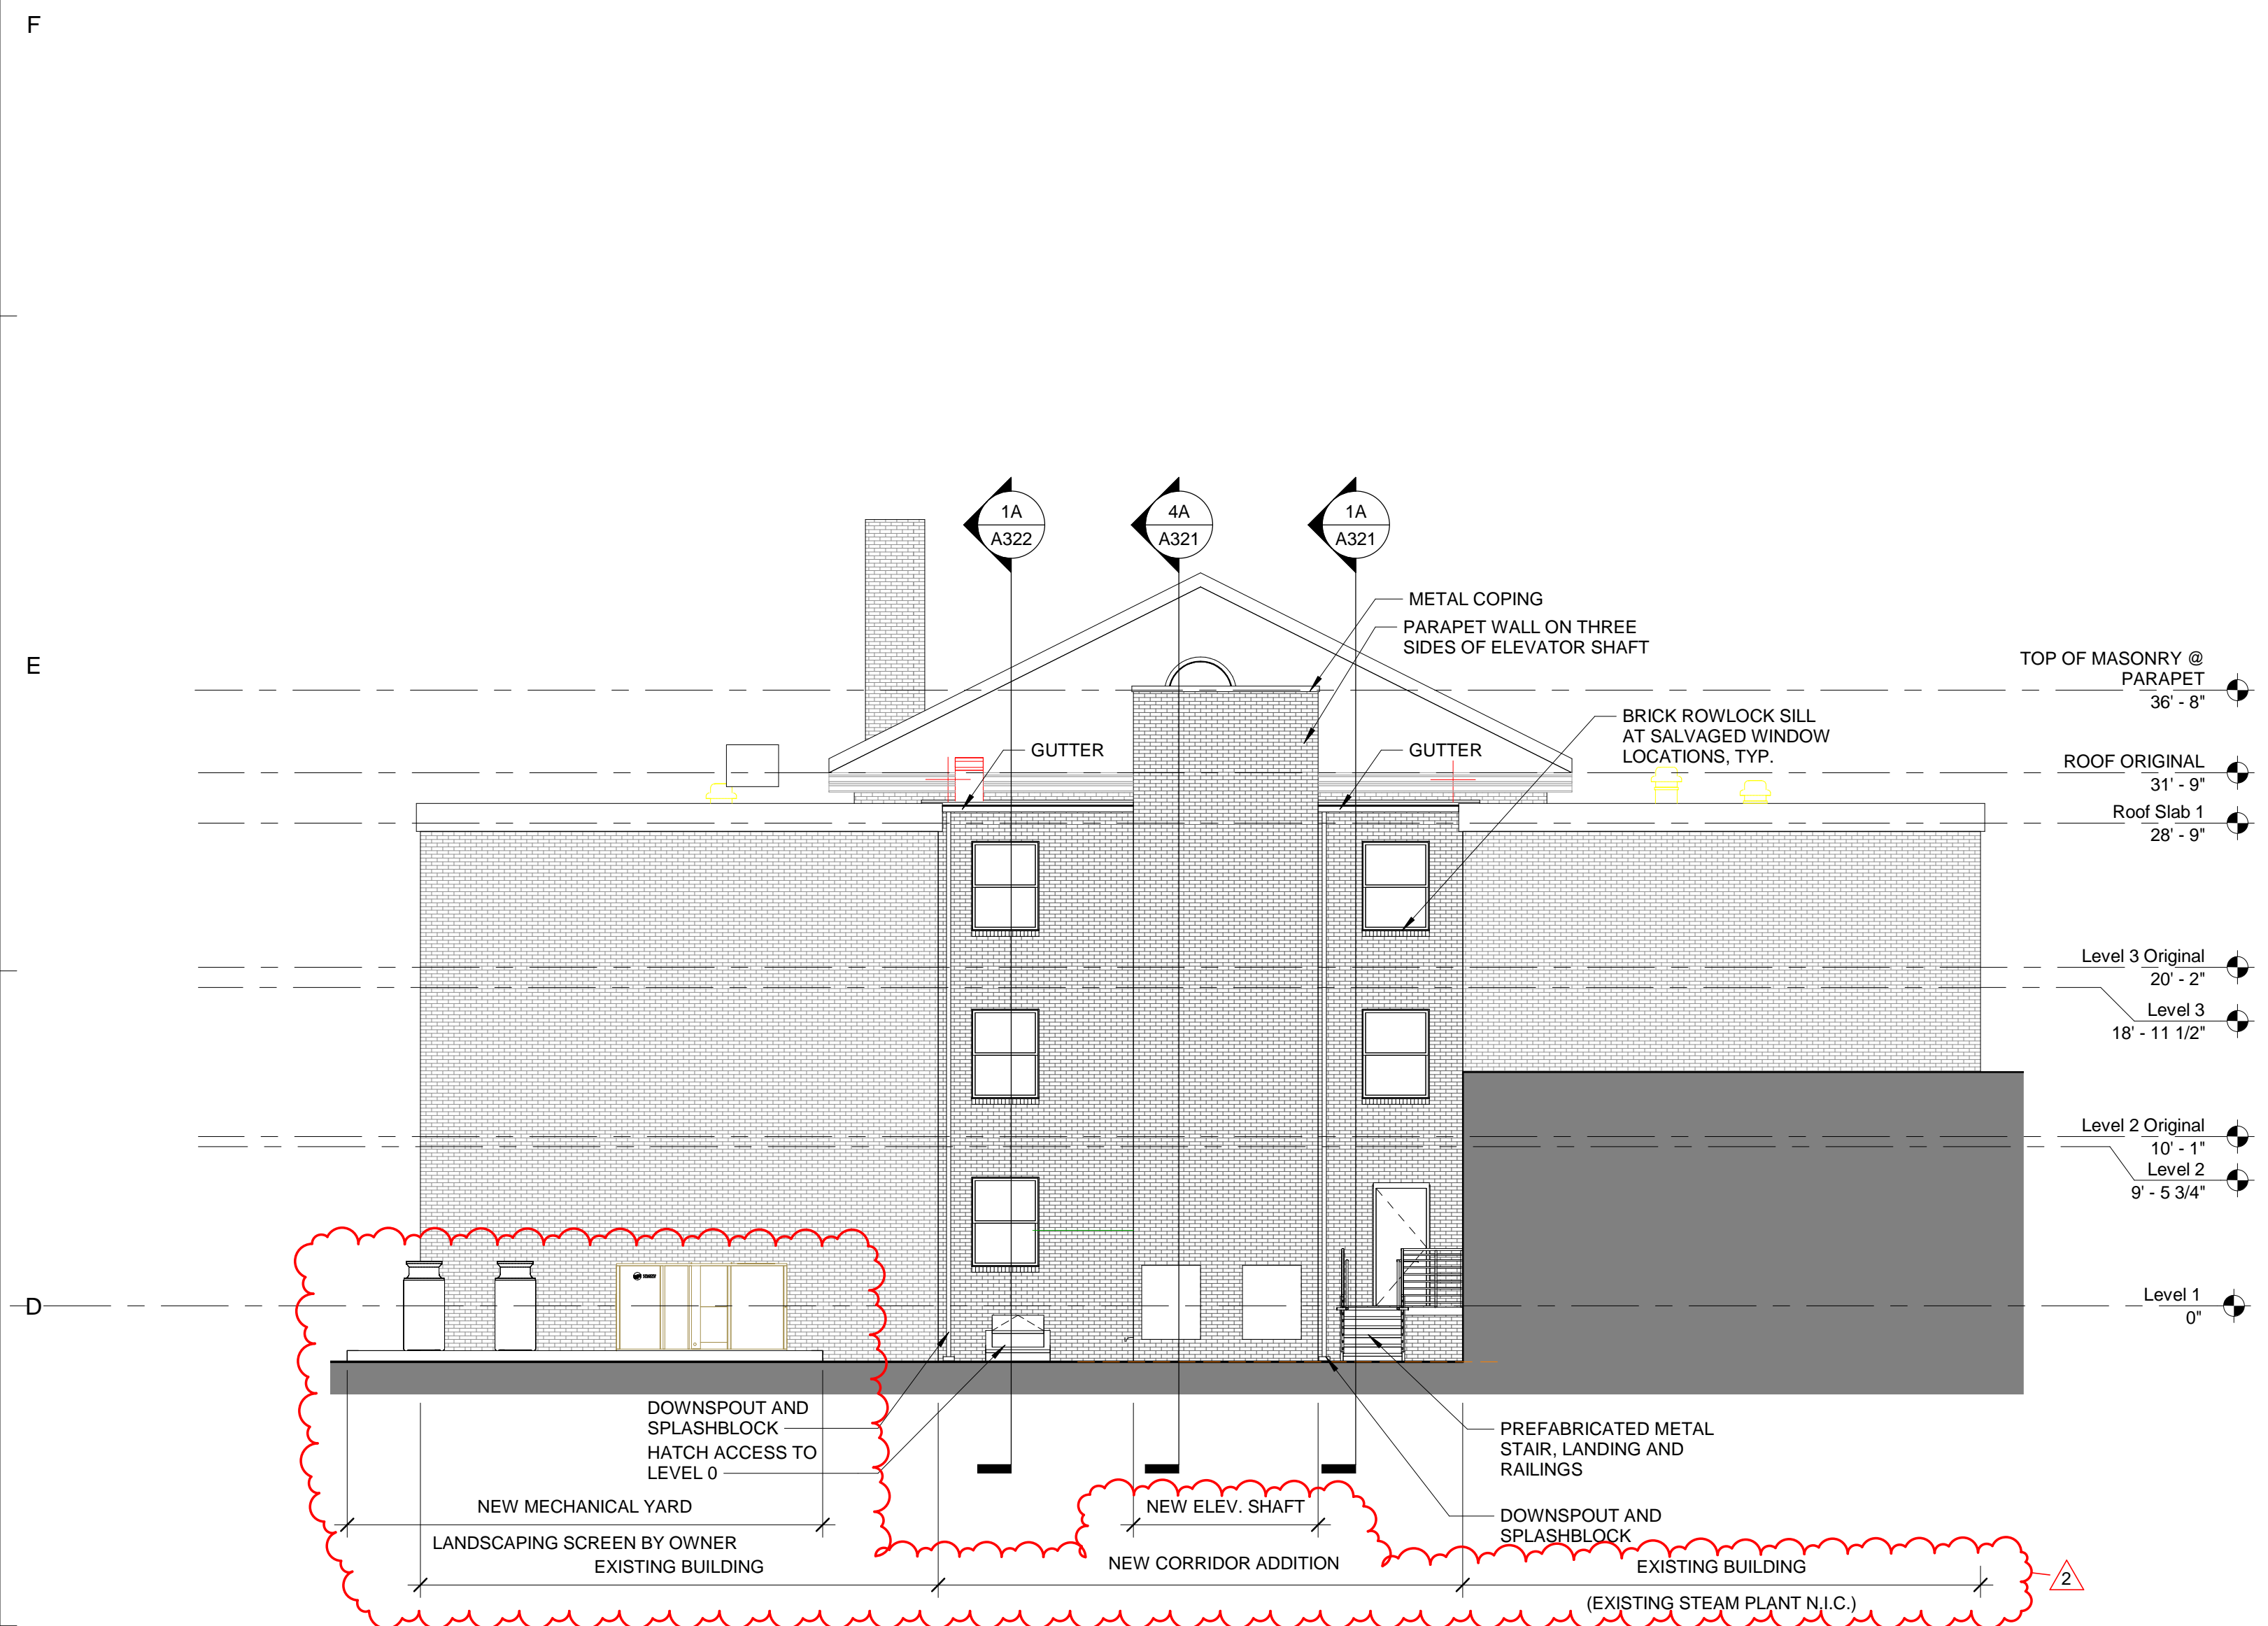

1A SOUTH ELEVATION - BASE BID  
A211 1/8" = 1'-0"

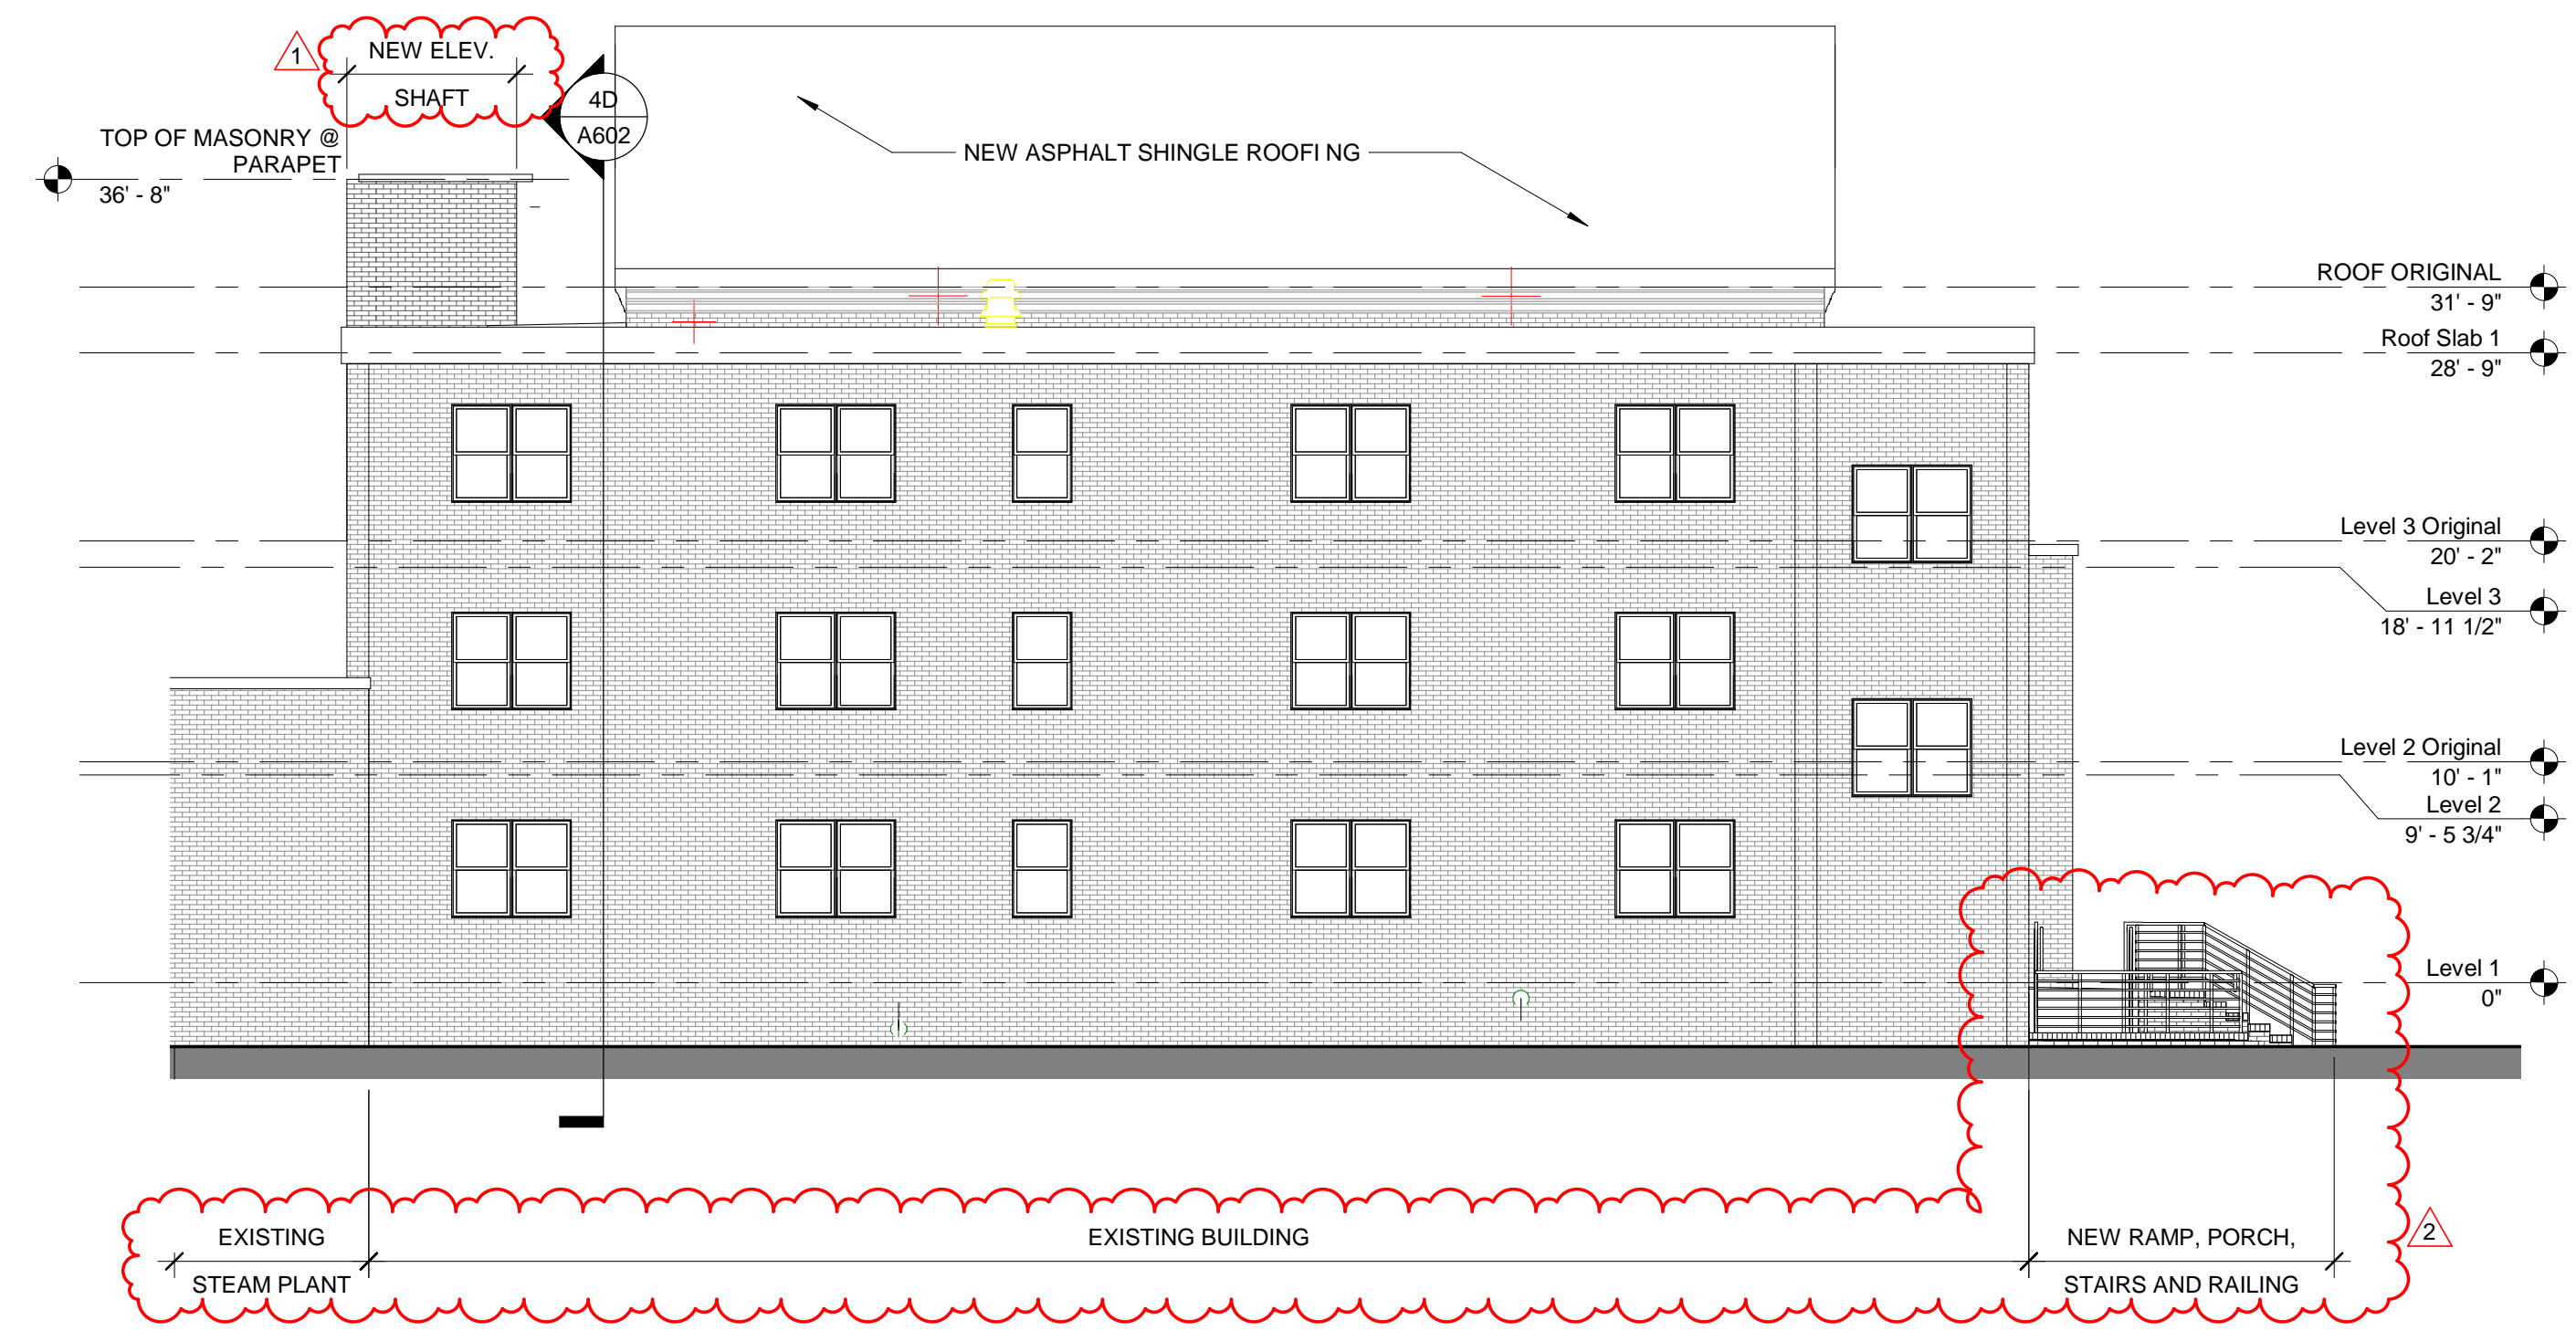

4A EAST ELEVATION - BASE BID  
A211 1/8" = 1'-0"



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PROJECT TEAM

PRINCIPAL IN CHARGE: ROB KLINEDINST, AIA

PROJECT MANAGER: SHANE WEBSTER, AIA

DESIGN TEAM: LITTLE


PROGRAM NAME: CAMPBELL UNIVERSITY DAY HALL RENOVATIONS

PROJECT NO. 513.9660.00


SHEET TITLE: EXTERIOR ELEVATIONS - BASE BID

SHEET NUMBER: A211

VERIFY ALL DIMENSIONS AND EXISTING CONDITIONS, TYPICAL

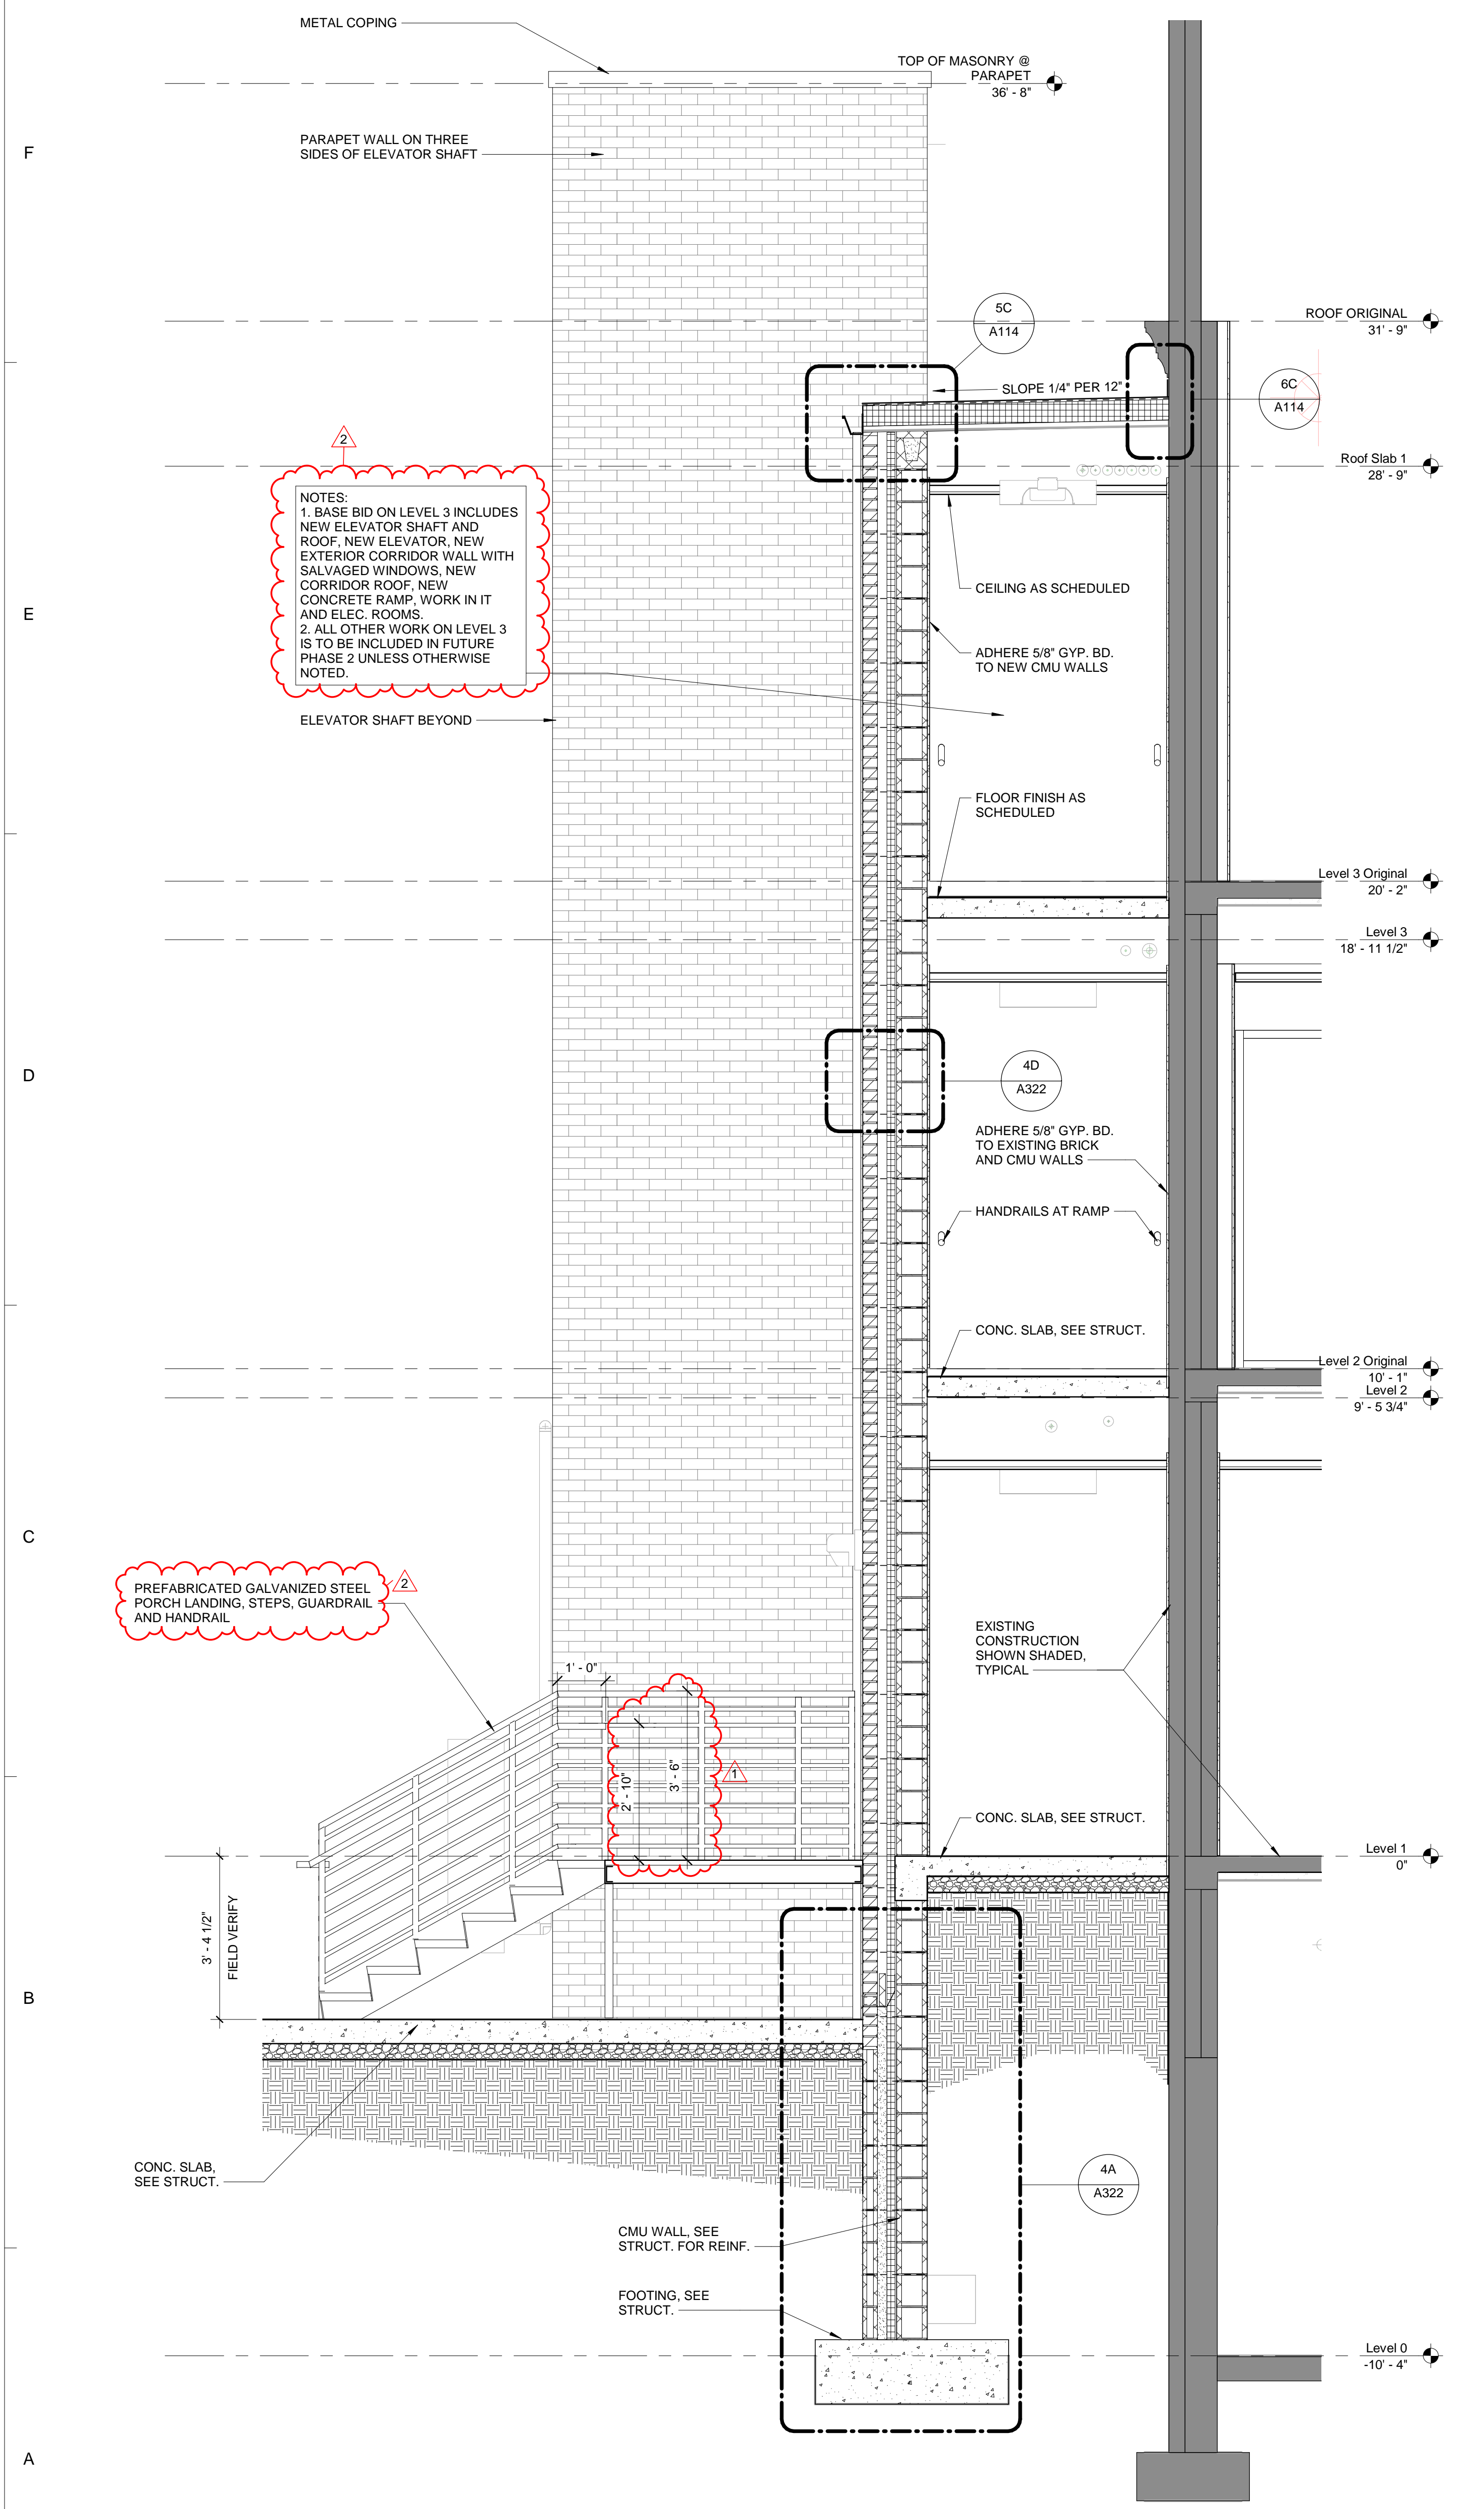

1A SECTION - CORRIDOR ADDITION WEST OF ELEV  
A321 1/2" = 1'-0"

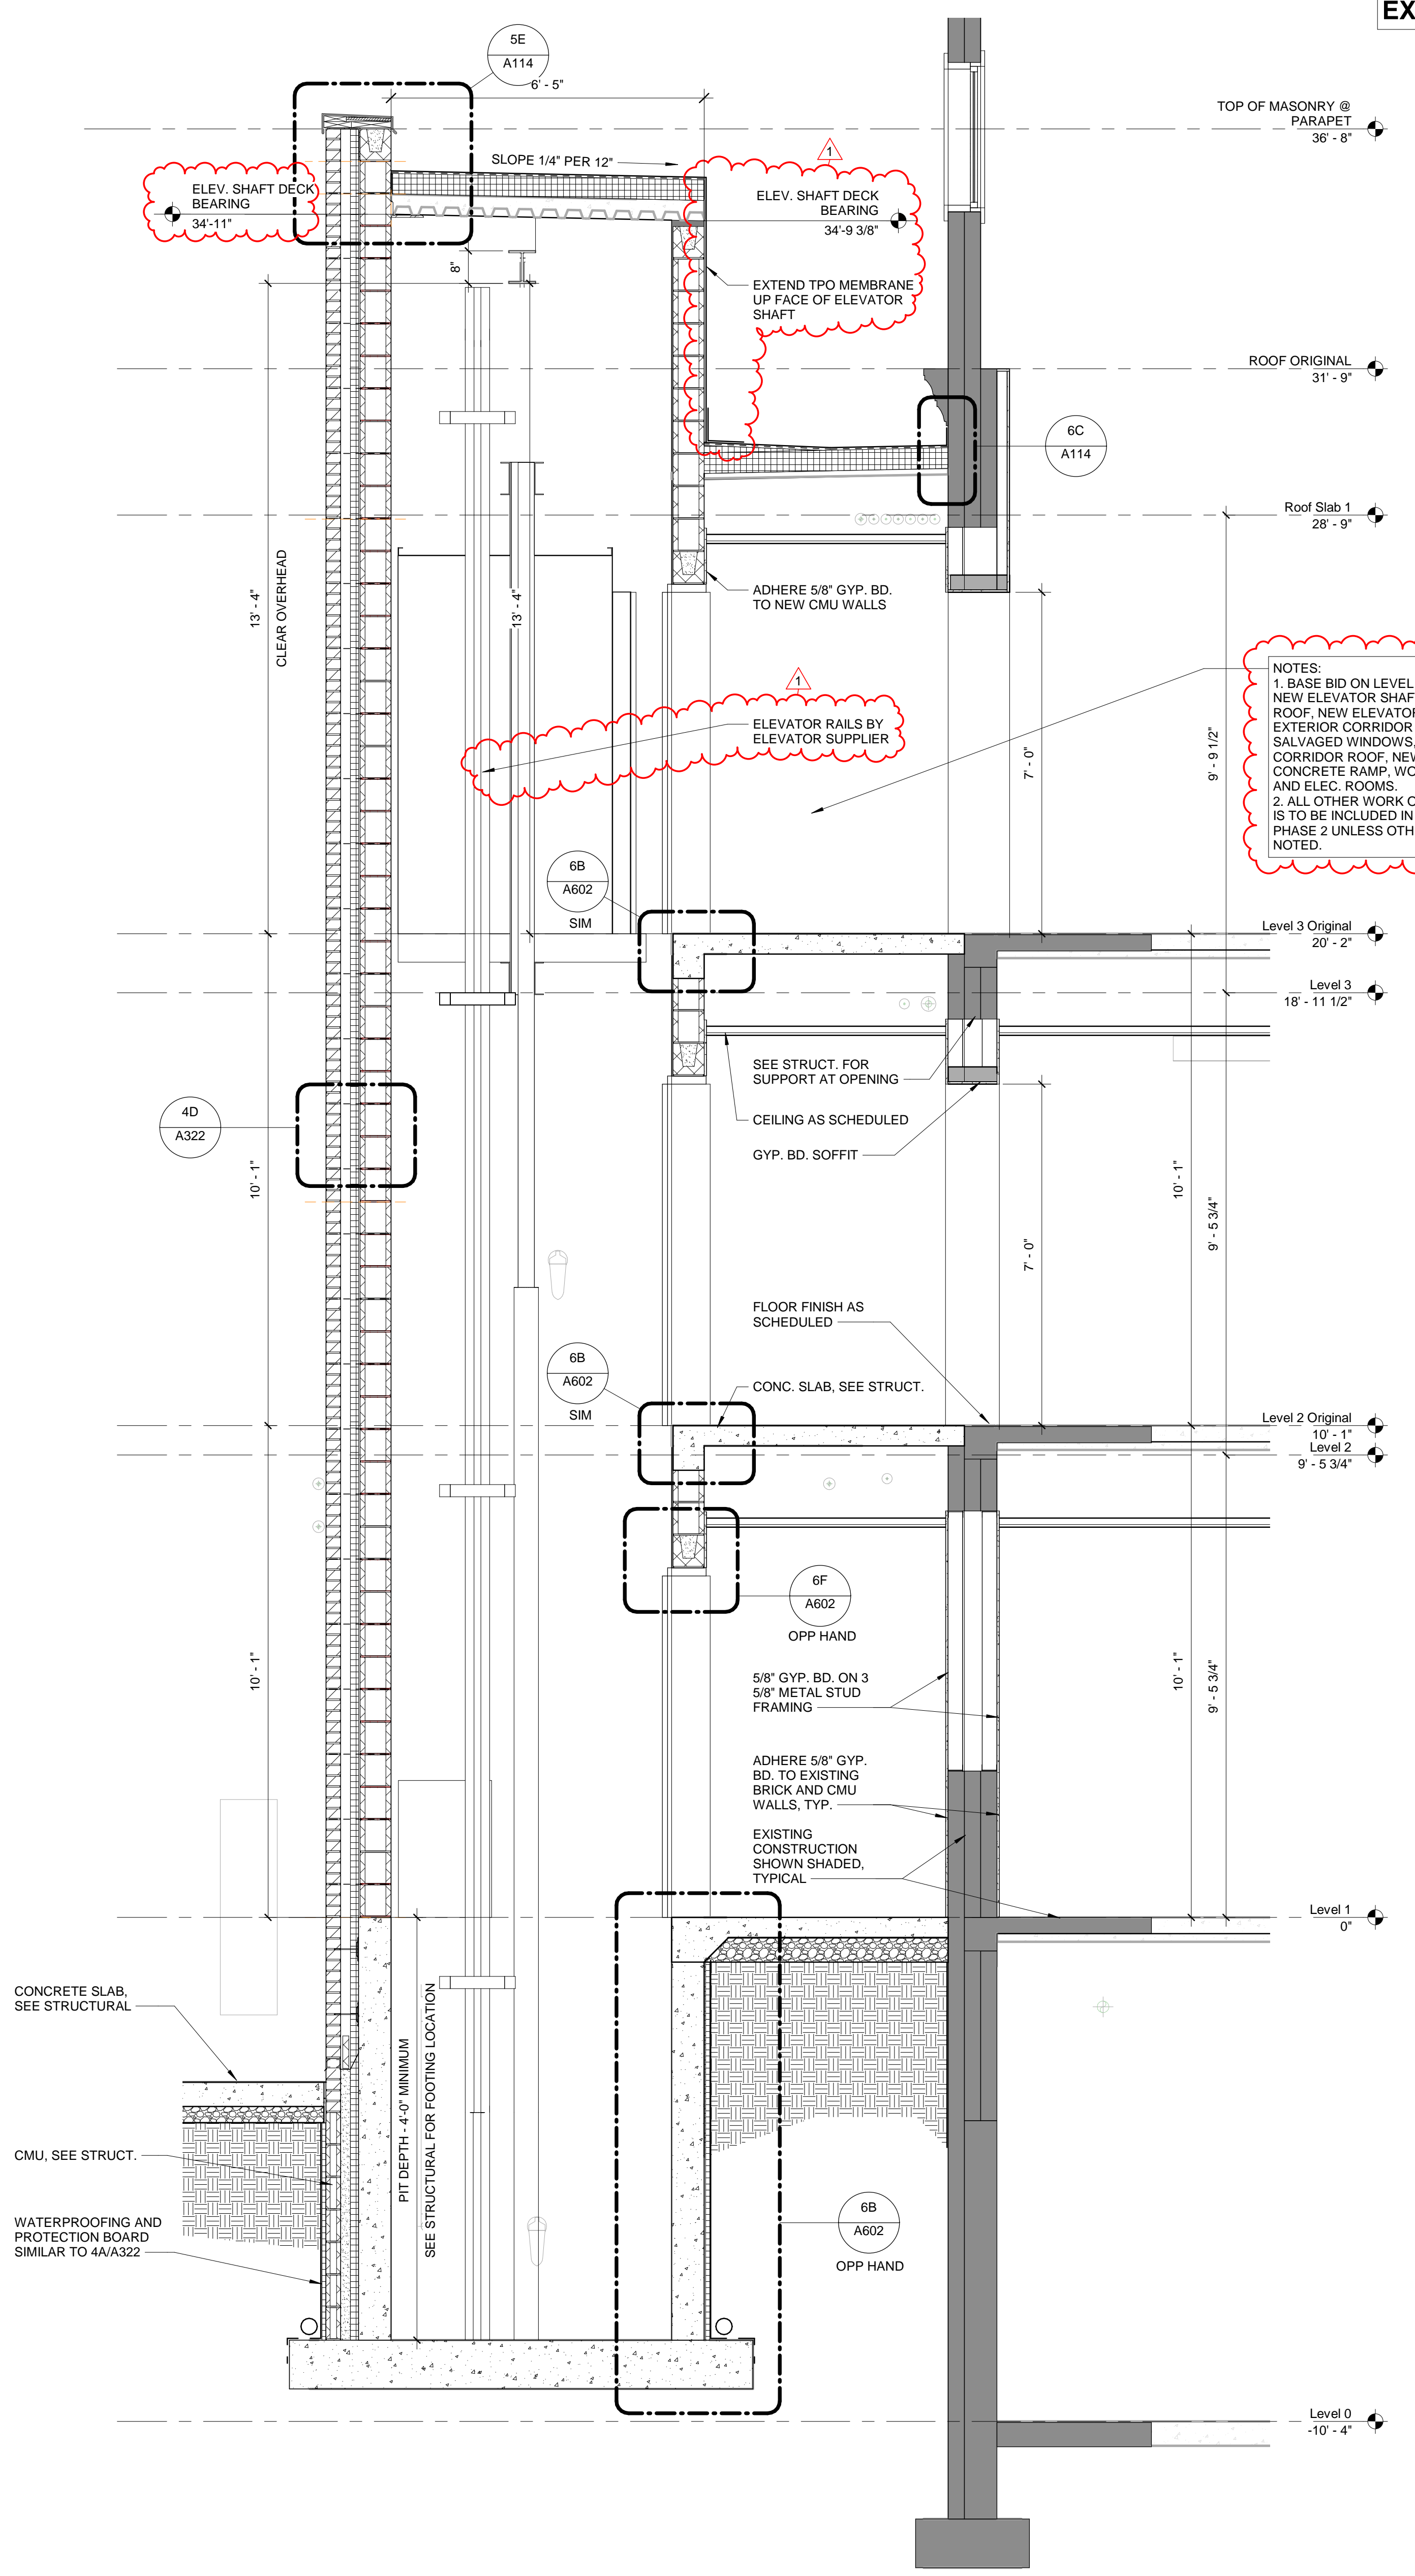

4A SECTION - CORRIDOR / ELEVATOR ADDITION  
A321 1/2" = 1'-0"

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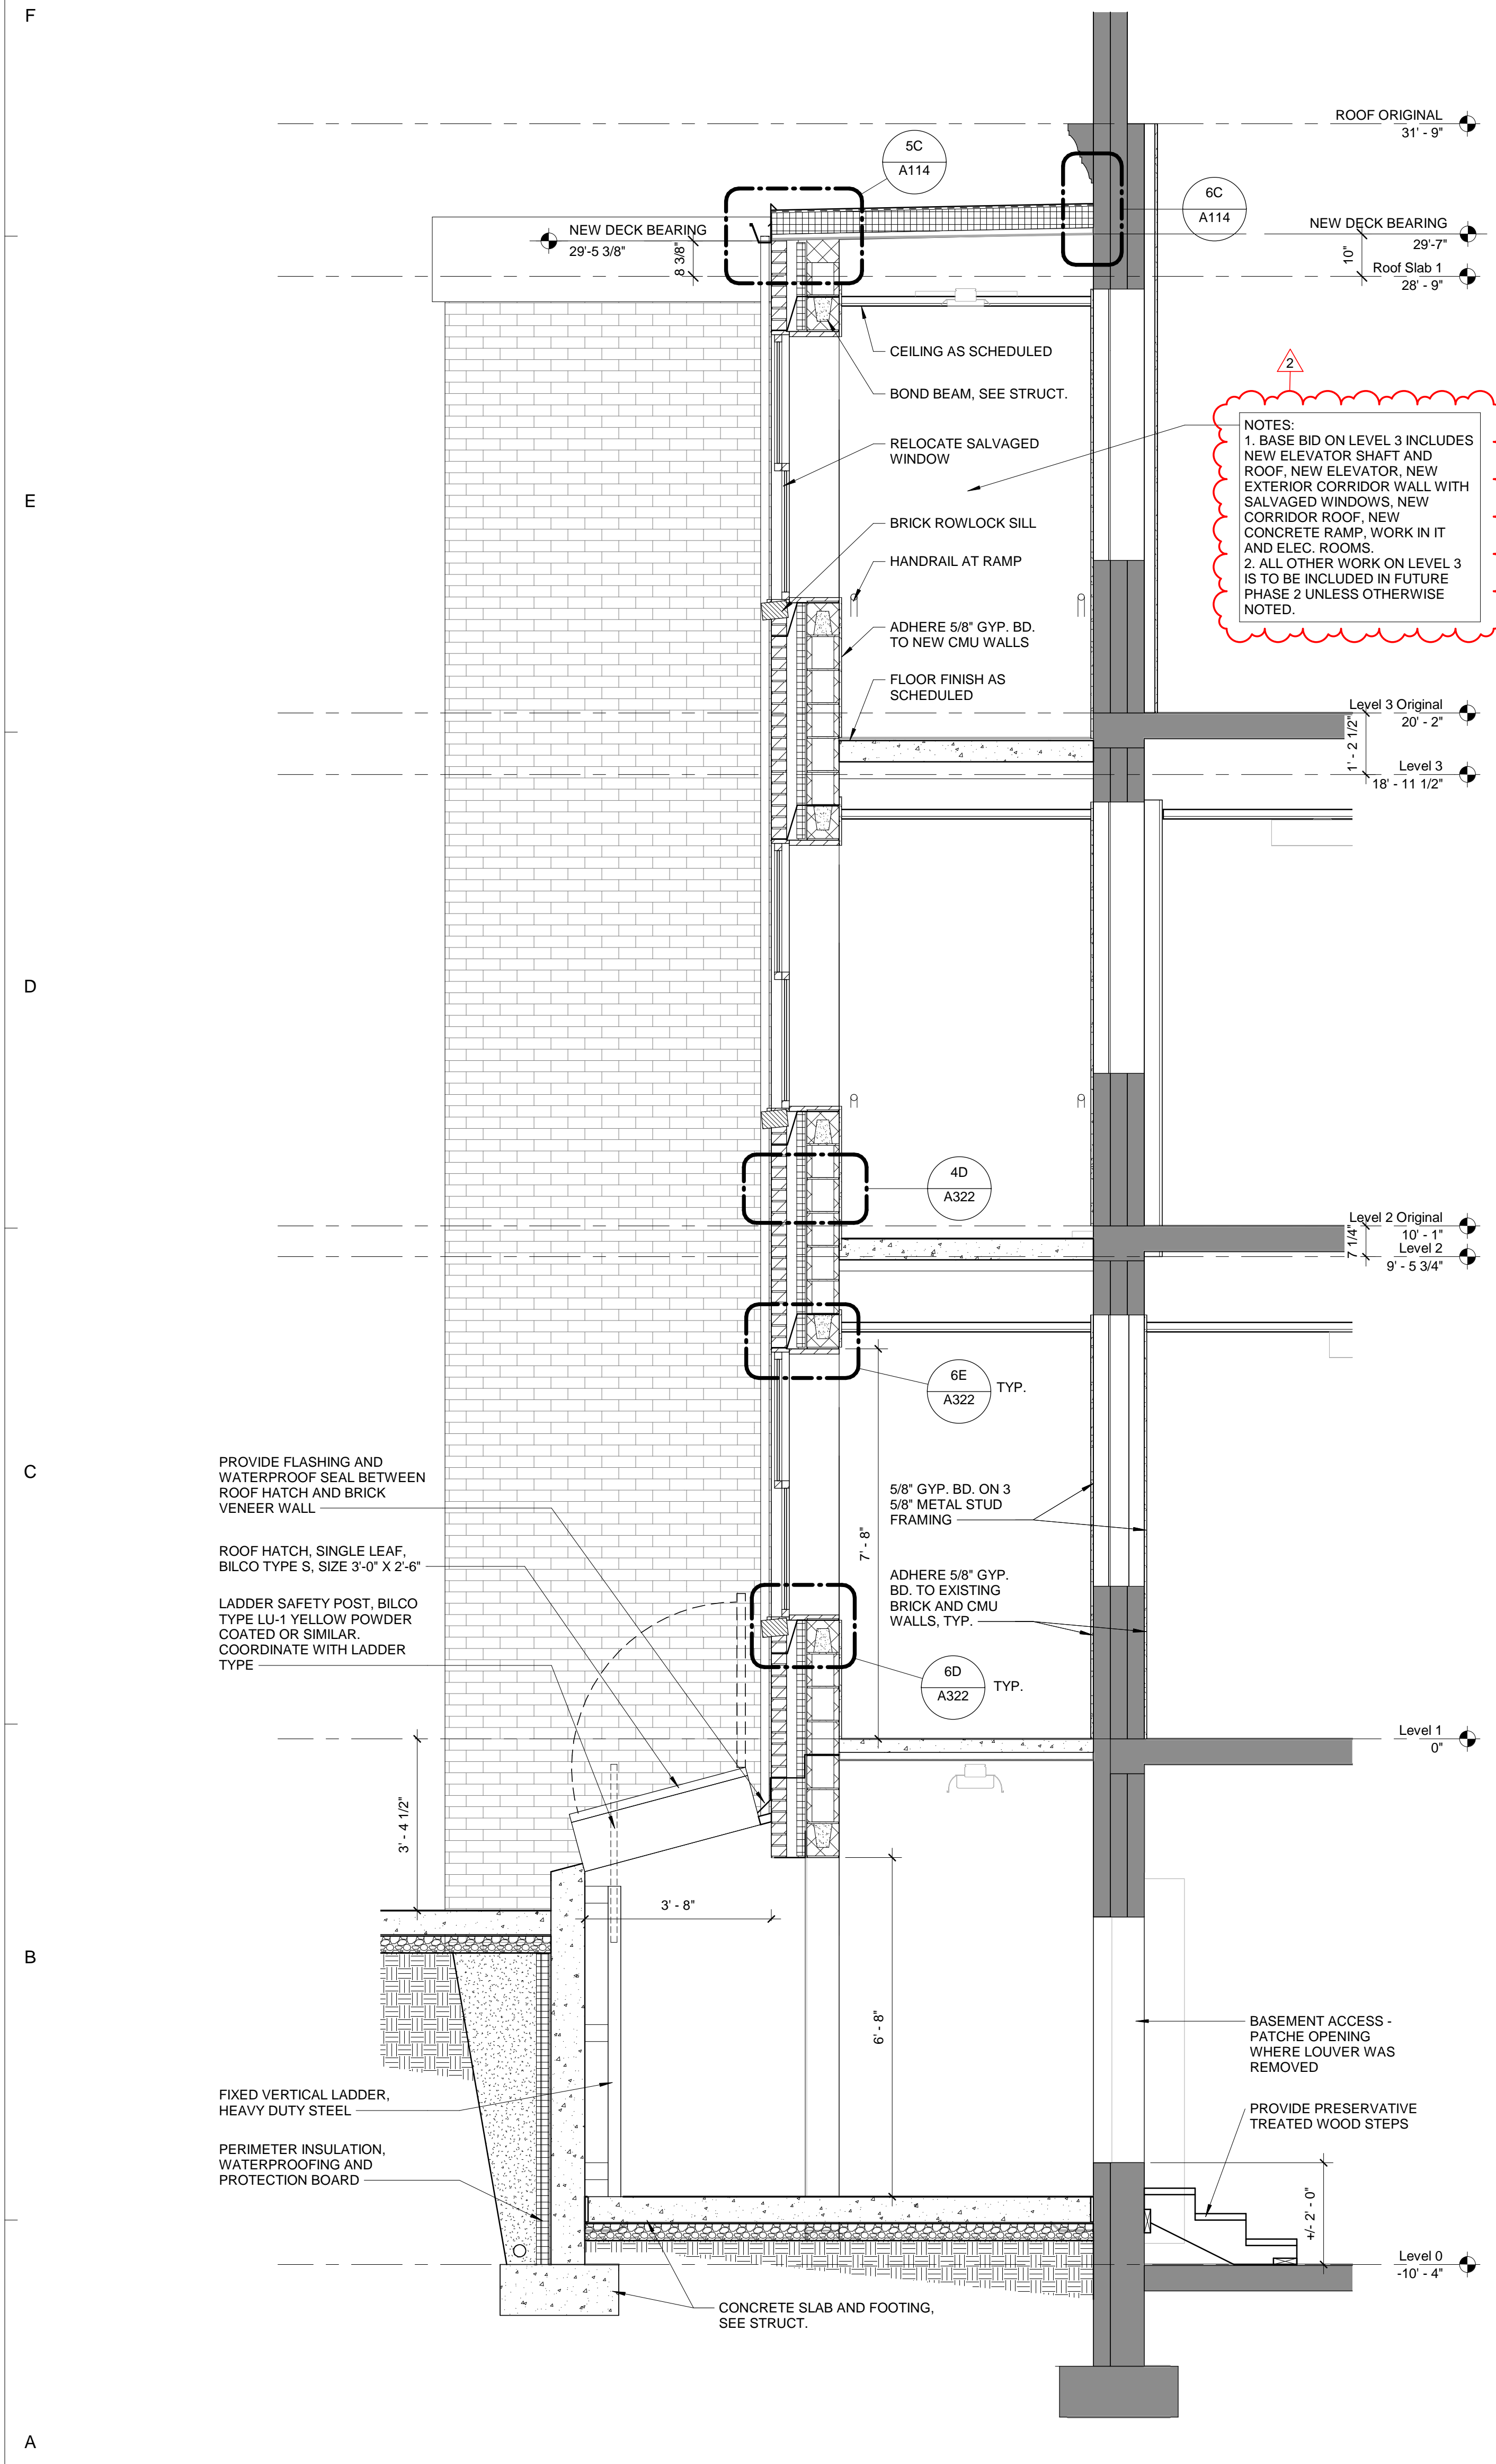
ISSUE DATE: 09.11.2018

REVISIONS NO.	REASON	DATE
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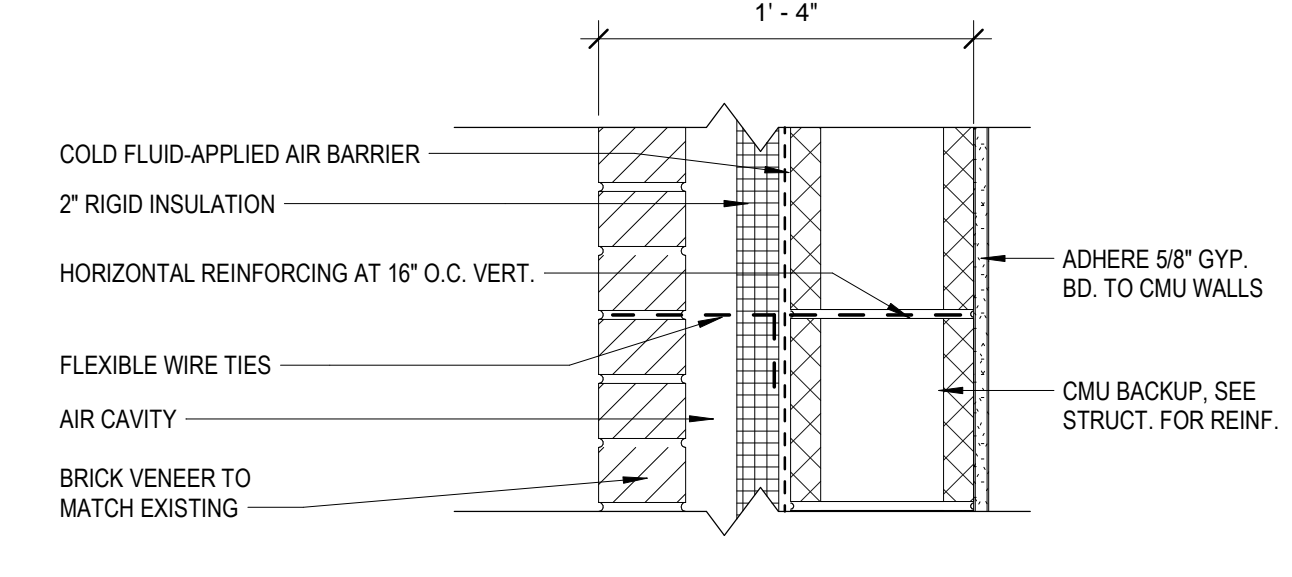
PROJECT TEAM  
PRINCIPAL IN CHARGE: ROB KLINEINST, AIA  
PROJECT MANAGER: SHANE WEBSTER, AIA  
DESIGN TEAM: LITTLE  
PROJECT NAME: CAMPBELL UNIVERSITY DAY HALL RENOVATIONS

PROJECT NO.: 513.9660.00  
SHEET TITLE: WALL SECTIONS


SHEET NUMBER: A321




**NOTES:**  
1. BASE BID ON LEVEL 3 INCLUDES NEW ELEVATOR SHAFT AND ROOF, NEW ELEVATOR, NEW EXTERIOR CORRIDOR WALL WITH SALVAGED WINDOWS, NEW CORRIDOR ROOF, NEW CONCRETE RAMP, WORK IN IT AND ELEC. ROOMS.  
2. ALL OTHER WORK ON LEVEL 3 IS TO BE INCLUDED IN FUTURE PHASE 2 UNLESS OTHERWISE NOTED.




**4D EXTERIOR WALL - BRICK VENEER ON CMU**  
A322 1 1/2" = 1'-0"

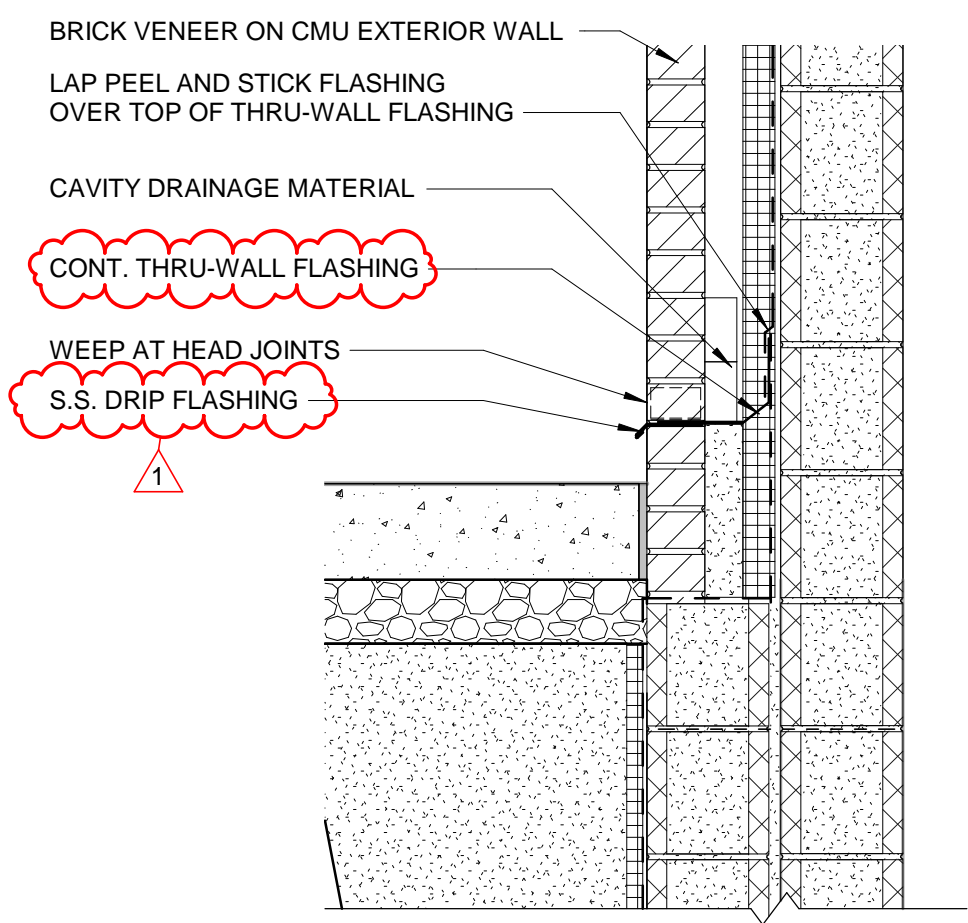

**6E Detail - Window Head**  
A322 1 1/2" = 1'-0"

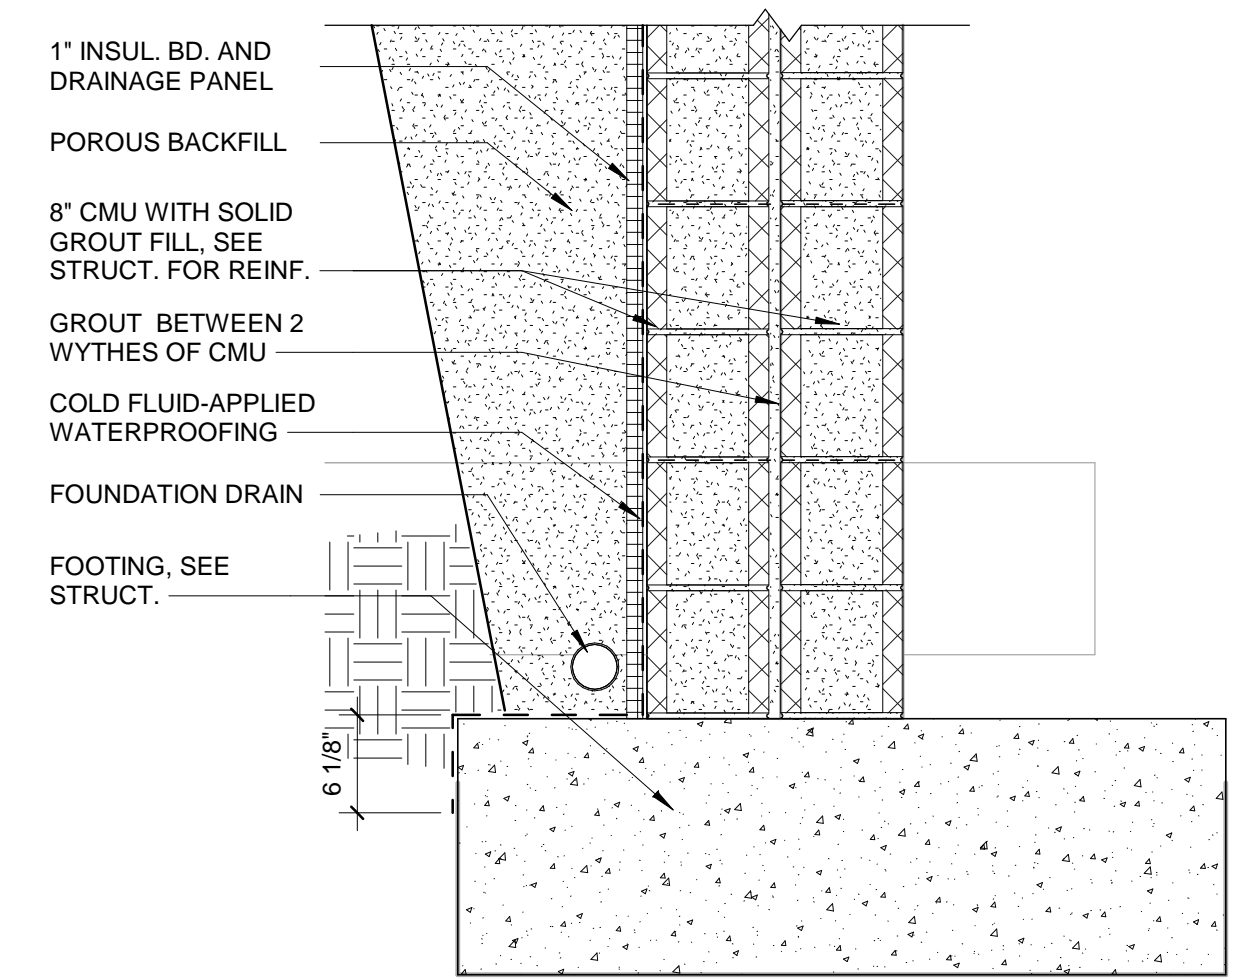

**4A SECTION DETAIL - FOUNDATION AT EXTERIOR WALL**  
A322 1" = 1'-0"

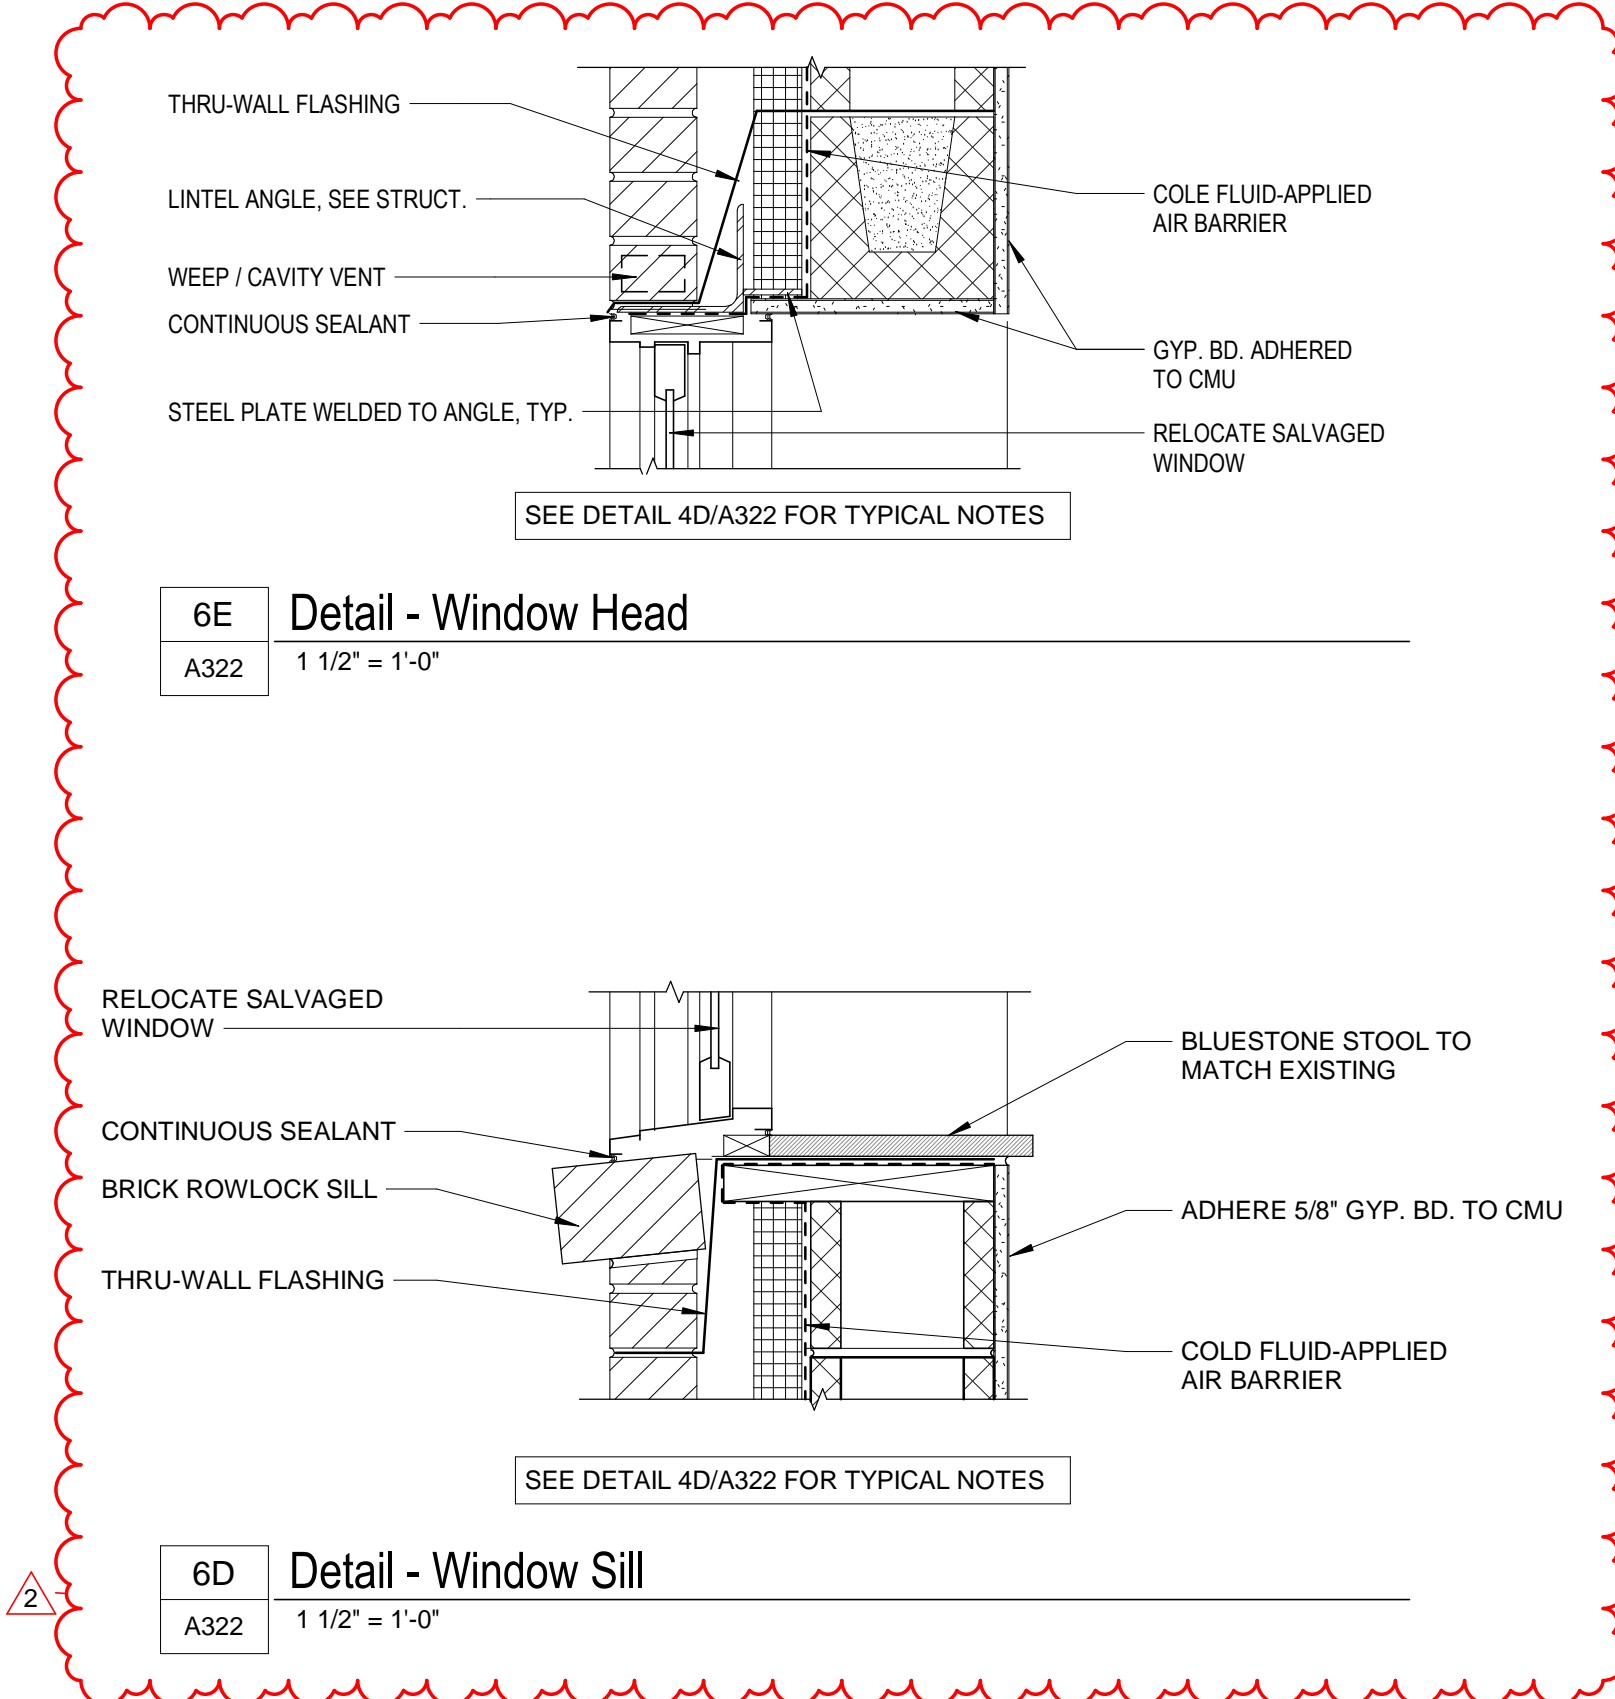

**6D Detail - Window Sill**  
A322 1 1/2" = 1'-0"

**1A SECTION - CORRIDOR ADDITION EAST OF ELEV**  
A322 1/2" = 1'-0"

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**PROJECT TEAM**  
PRINCIPAL IN CHARGE: ROB KLINEINST, AIA  
PROJECT MANAGER: SHANE WEBSTER, AIA  
DESIGN TEAM: Designer  
PROJECT NAME: CAMPBELL UNIVERSITY DAY HALL RENOVATIONS

PROJECT NO. 513.9660.00


SHEET TITLE: WALL SECTIONS AND DETAILS

SHEET NUMBER: A322


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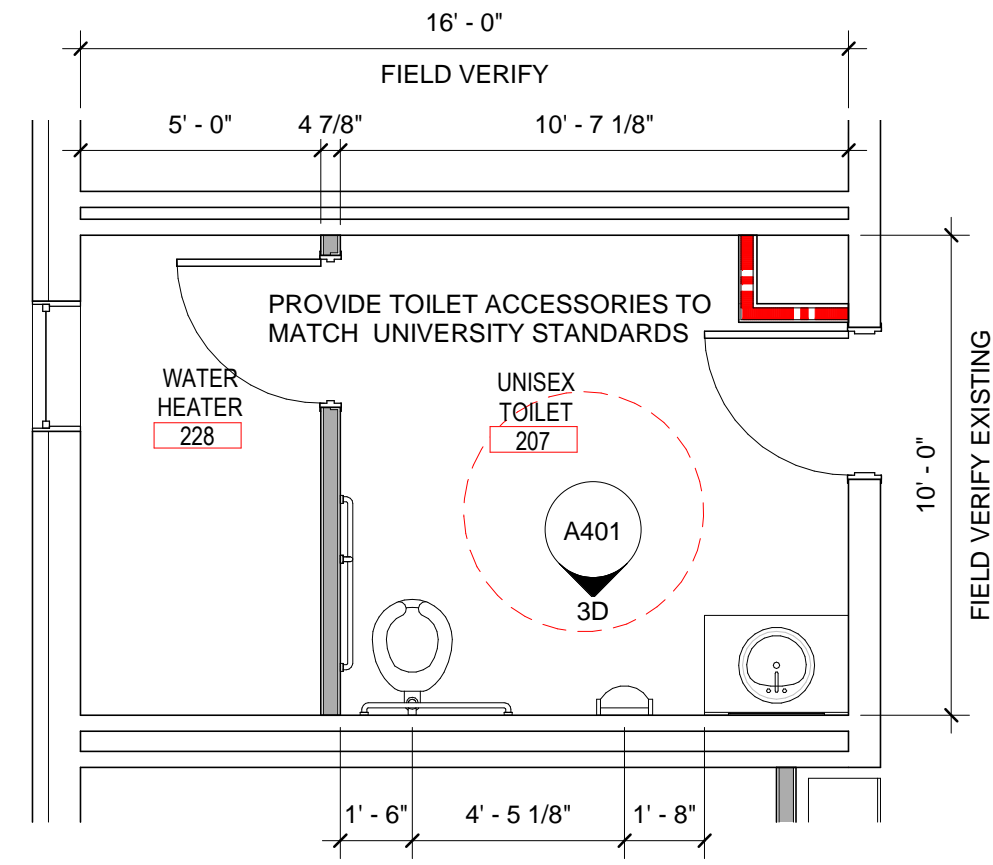
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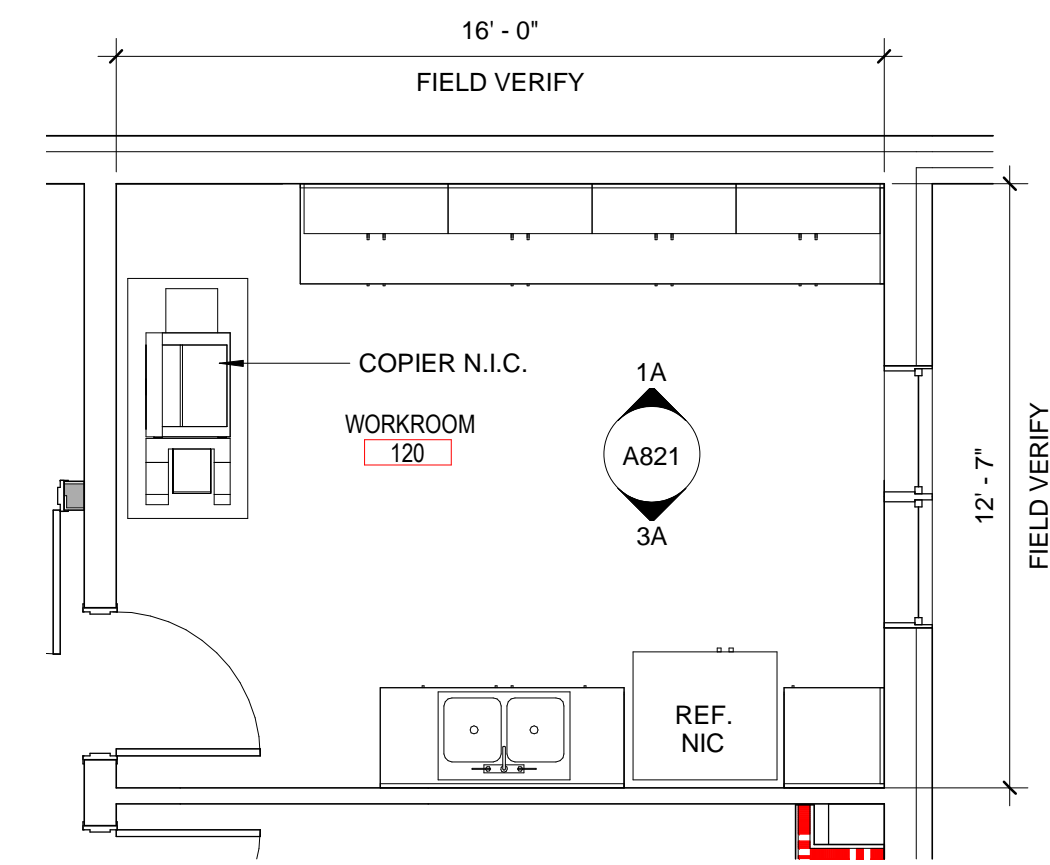
4E ENLARGED PLAN - UNISEX TOILET 307  
A401 1/4" = 1'-0"




3D ELEVATION - UNISEX 207  
A401 3/8" = 1'-0"

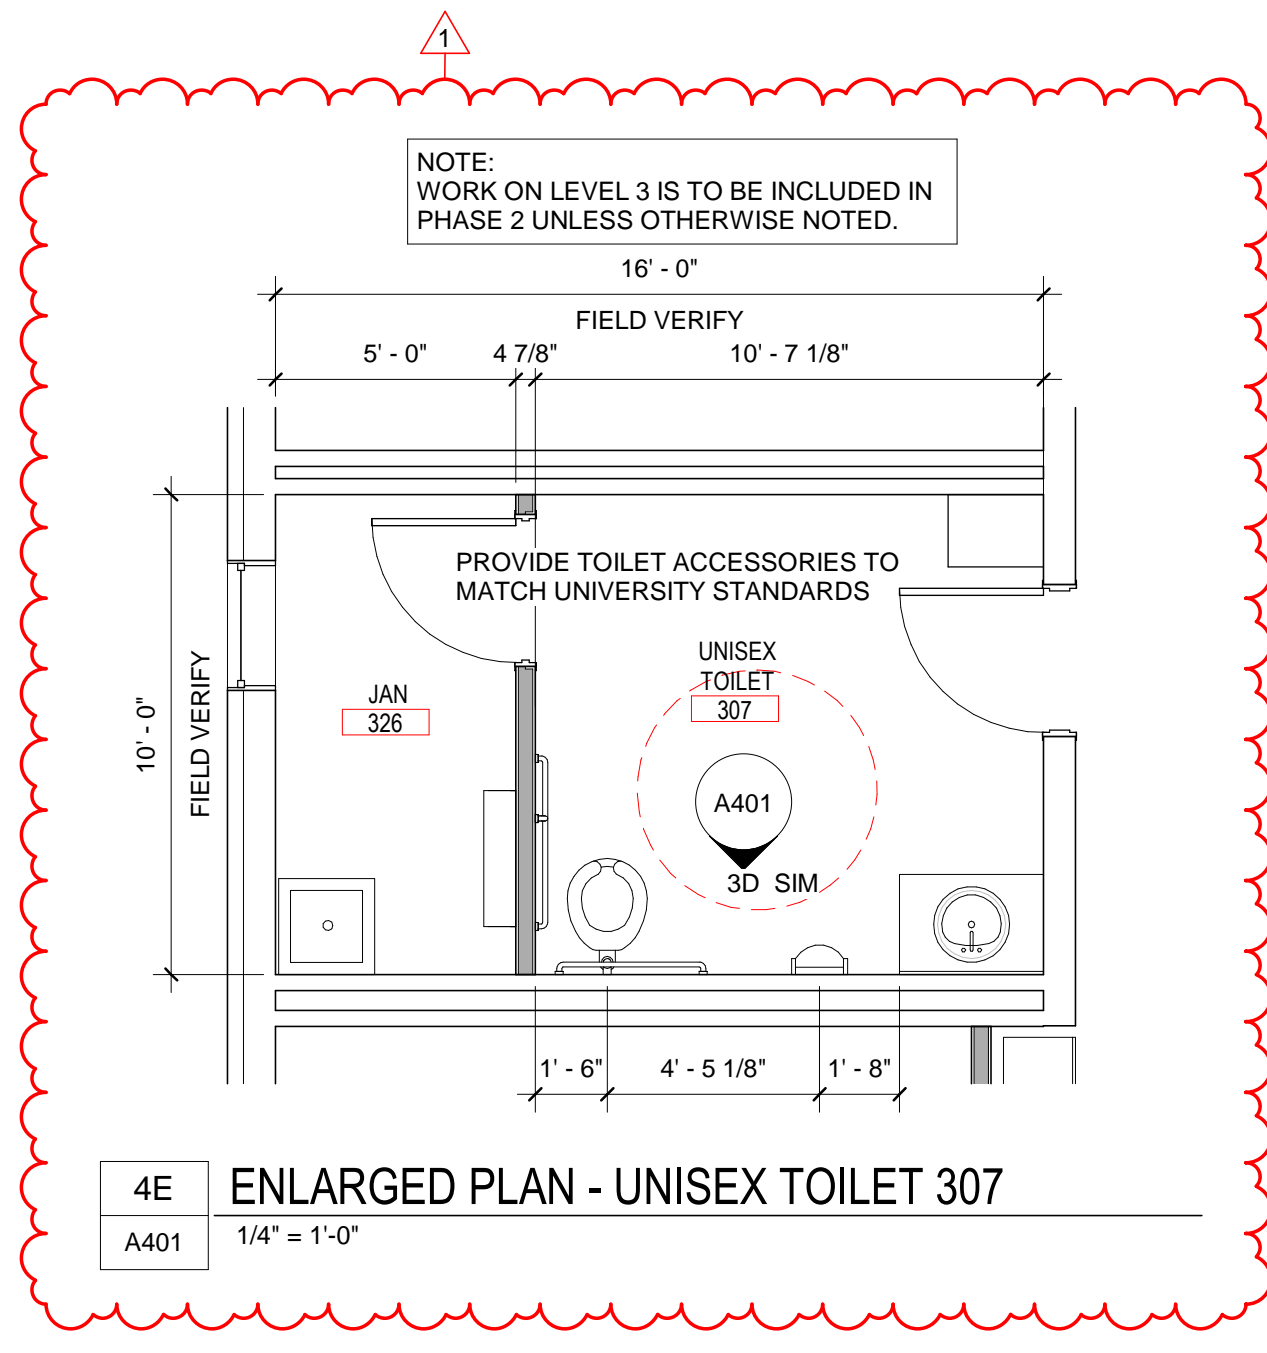


4D ENLARGED PLAN - UNISEX TOILET 207  
A401 1/4" = 1'-0"

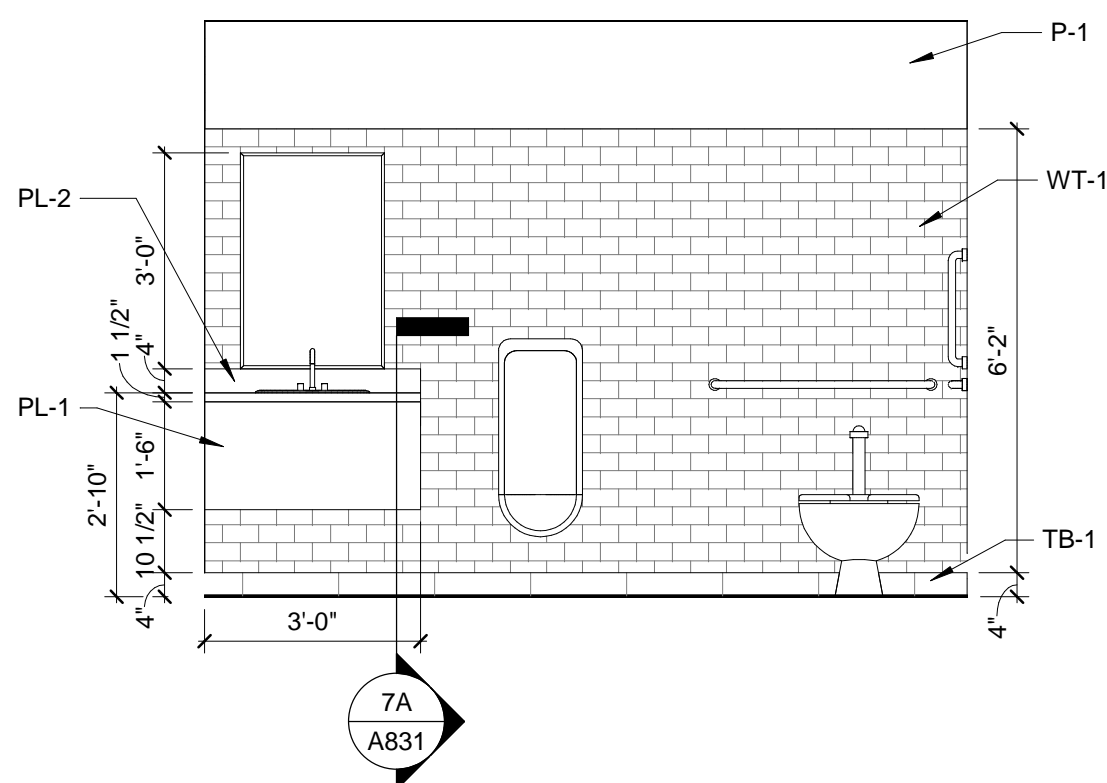


5D ENLARGED FLOOR PLAN - WORKROOM  
A401 1/4" = 1'-0"

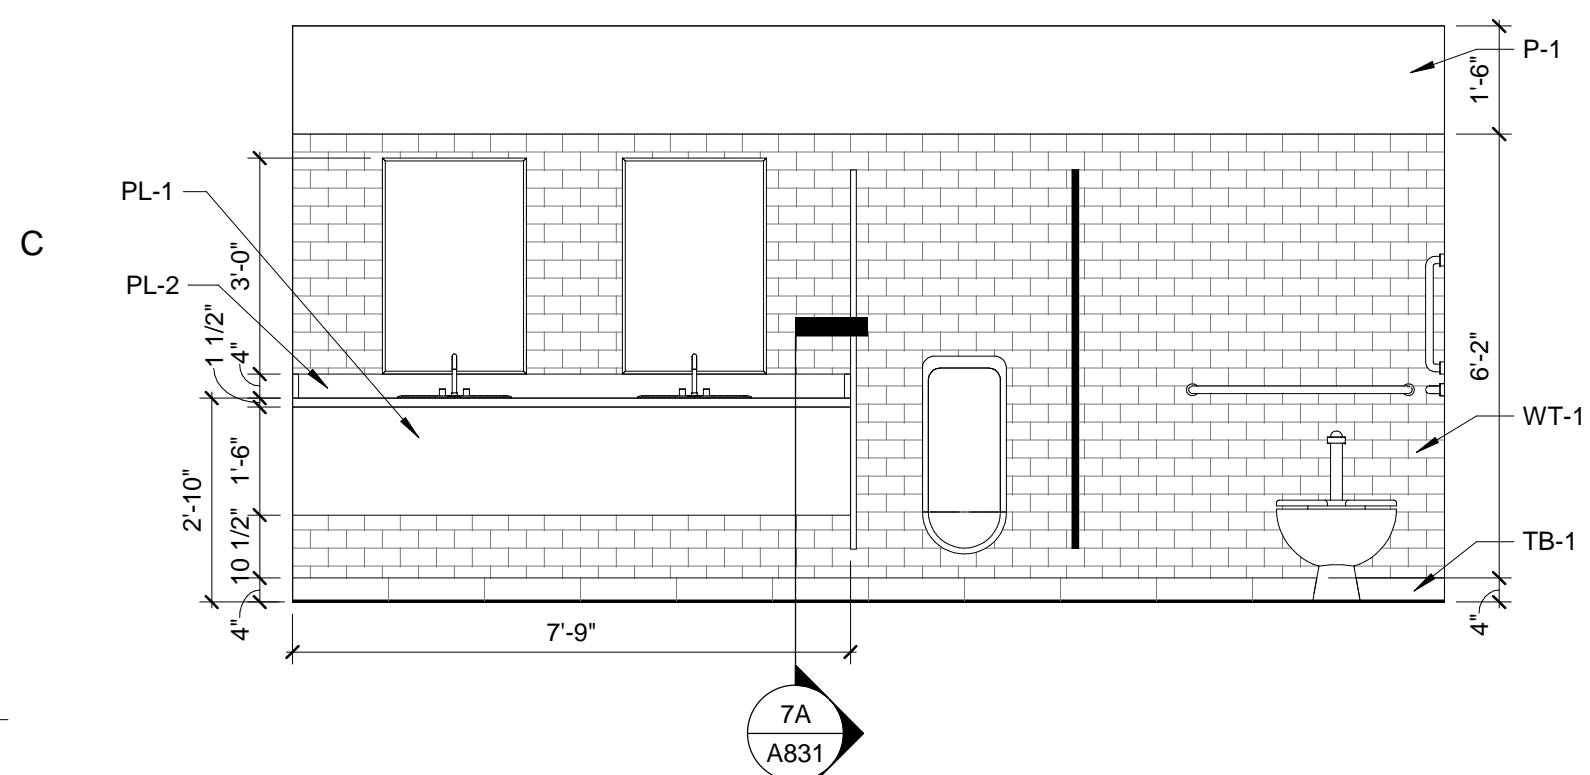


1C ELEVATION - MEN 107  
A401 3/8" = 1'-0"

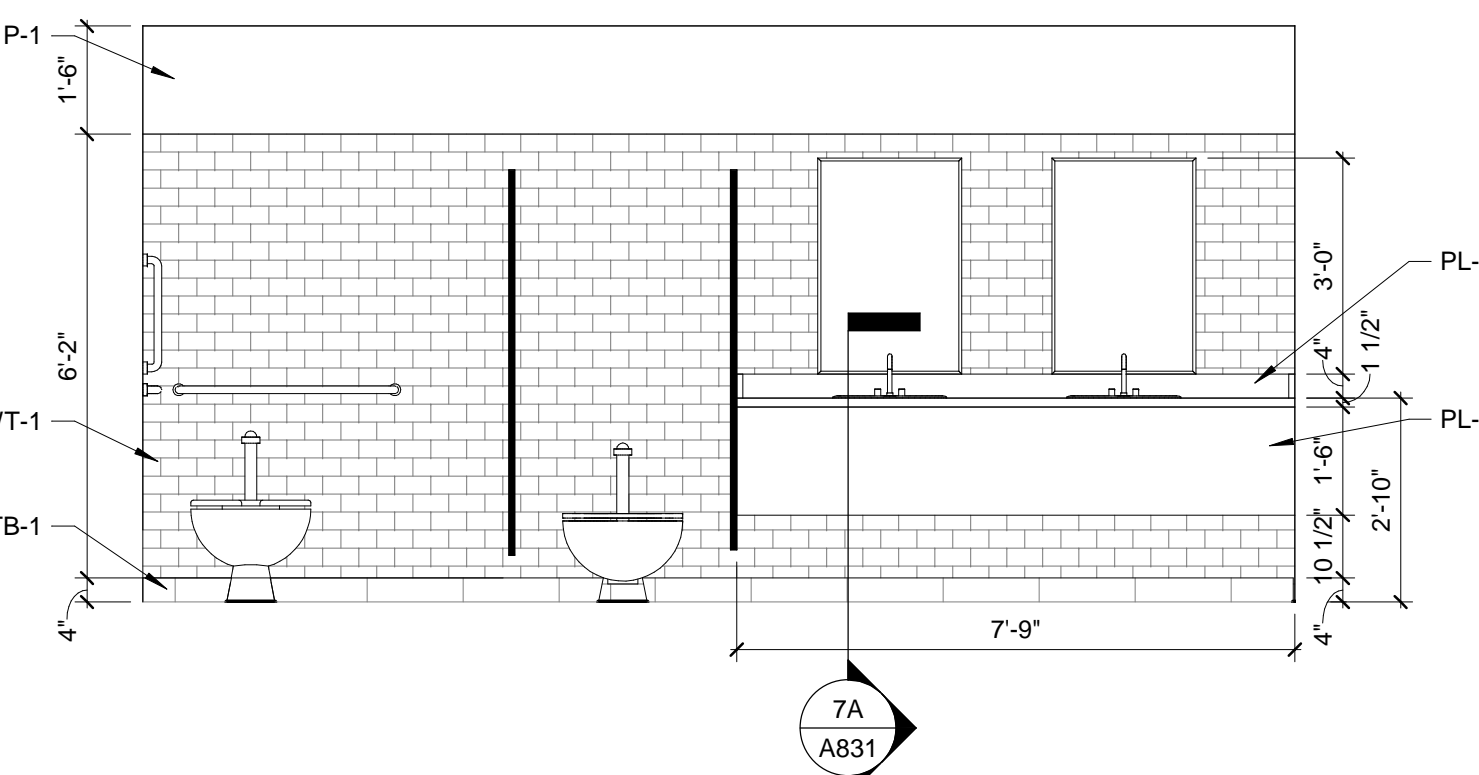


3C ELEVATION - WOMEN 108  
A401 3/8" = 1'-0"

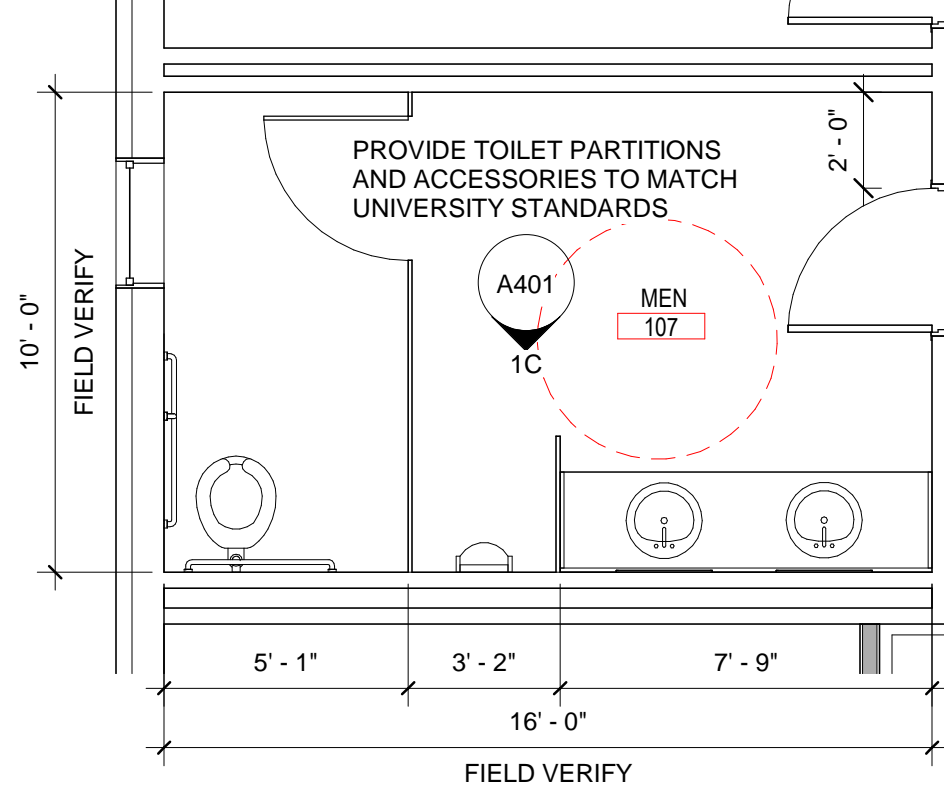

4C ENLARGED PLAN - MEN 107  
A401 1/4" = 1'-0"

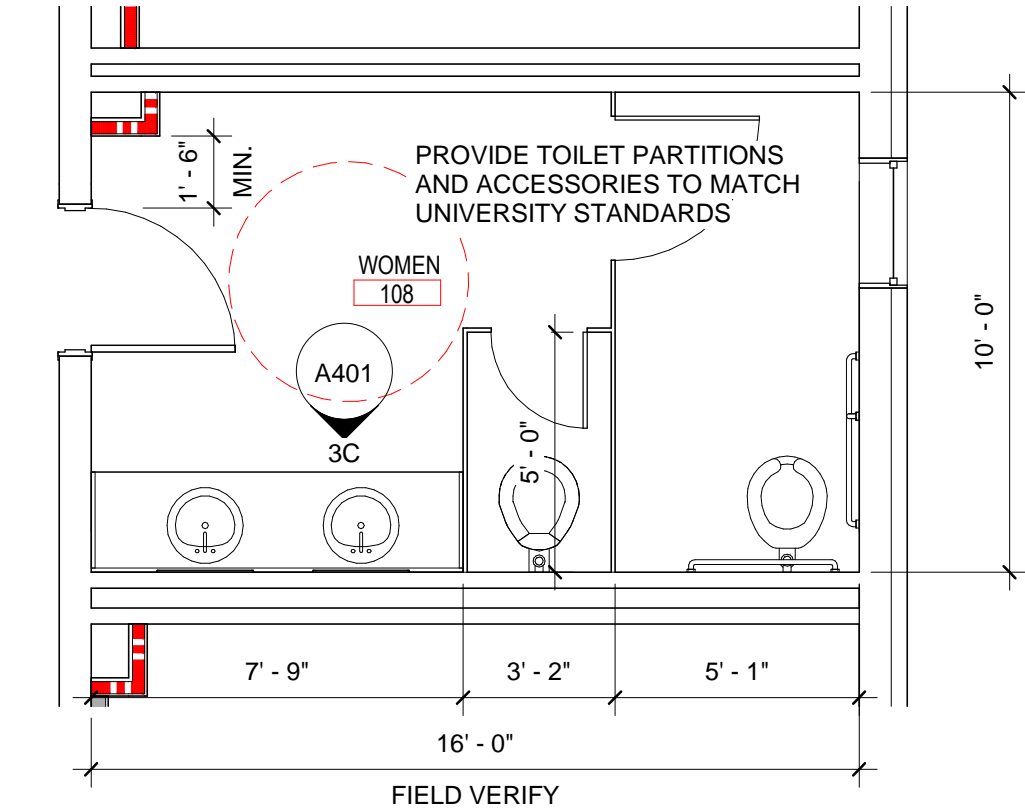

5C ENLARGED PLAN - WOMEN 108  
A401 1/4" = 1'-0"

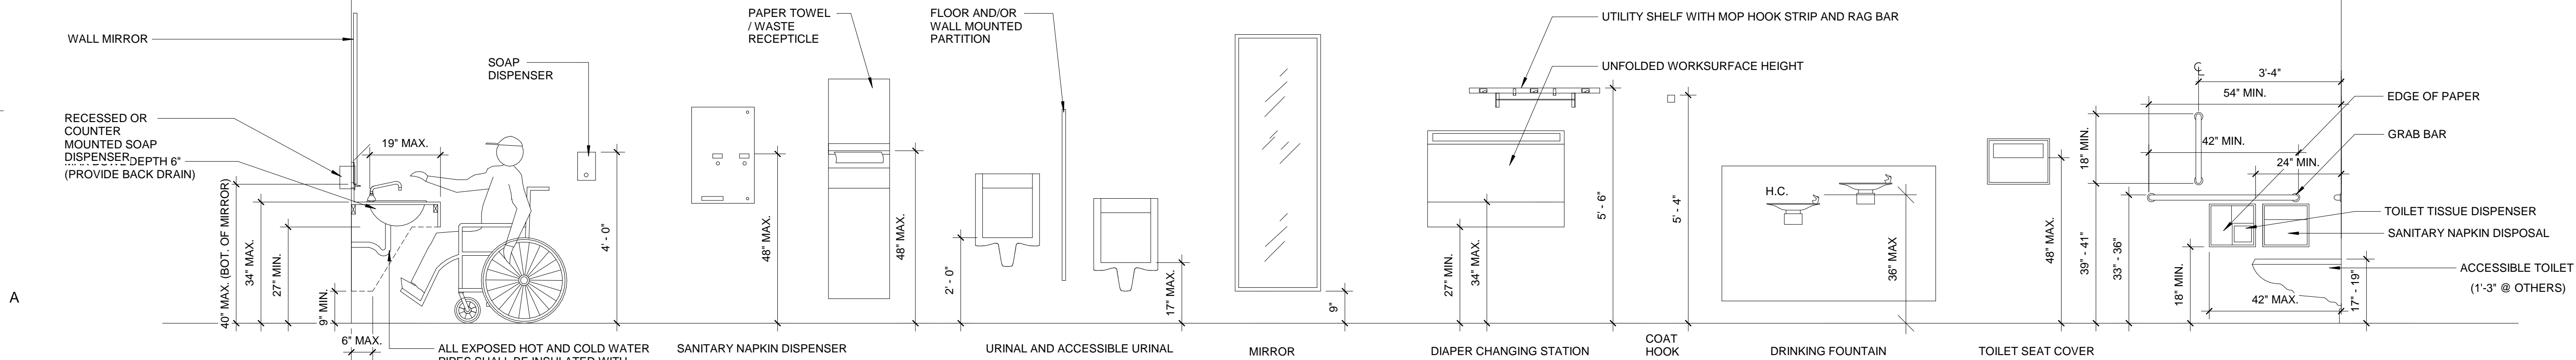

1A HEIGHTS  
A401 NOT TO SCALE



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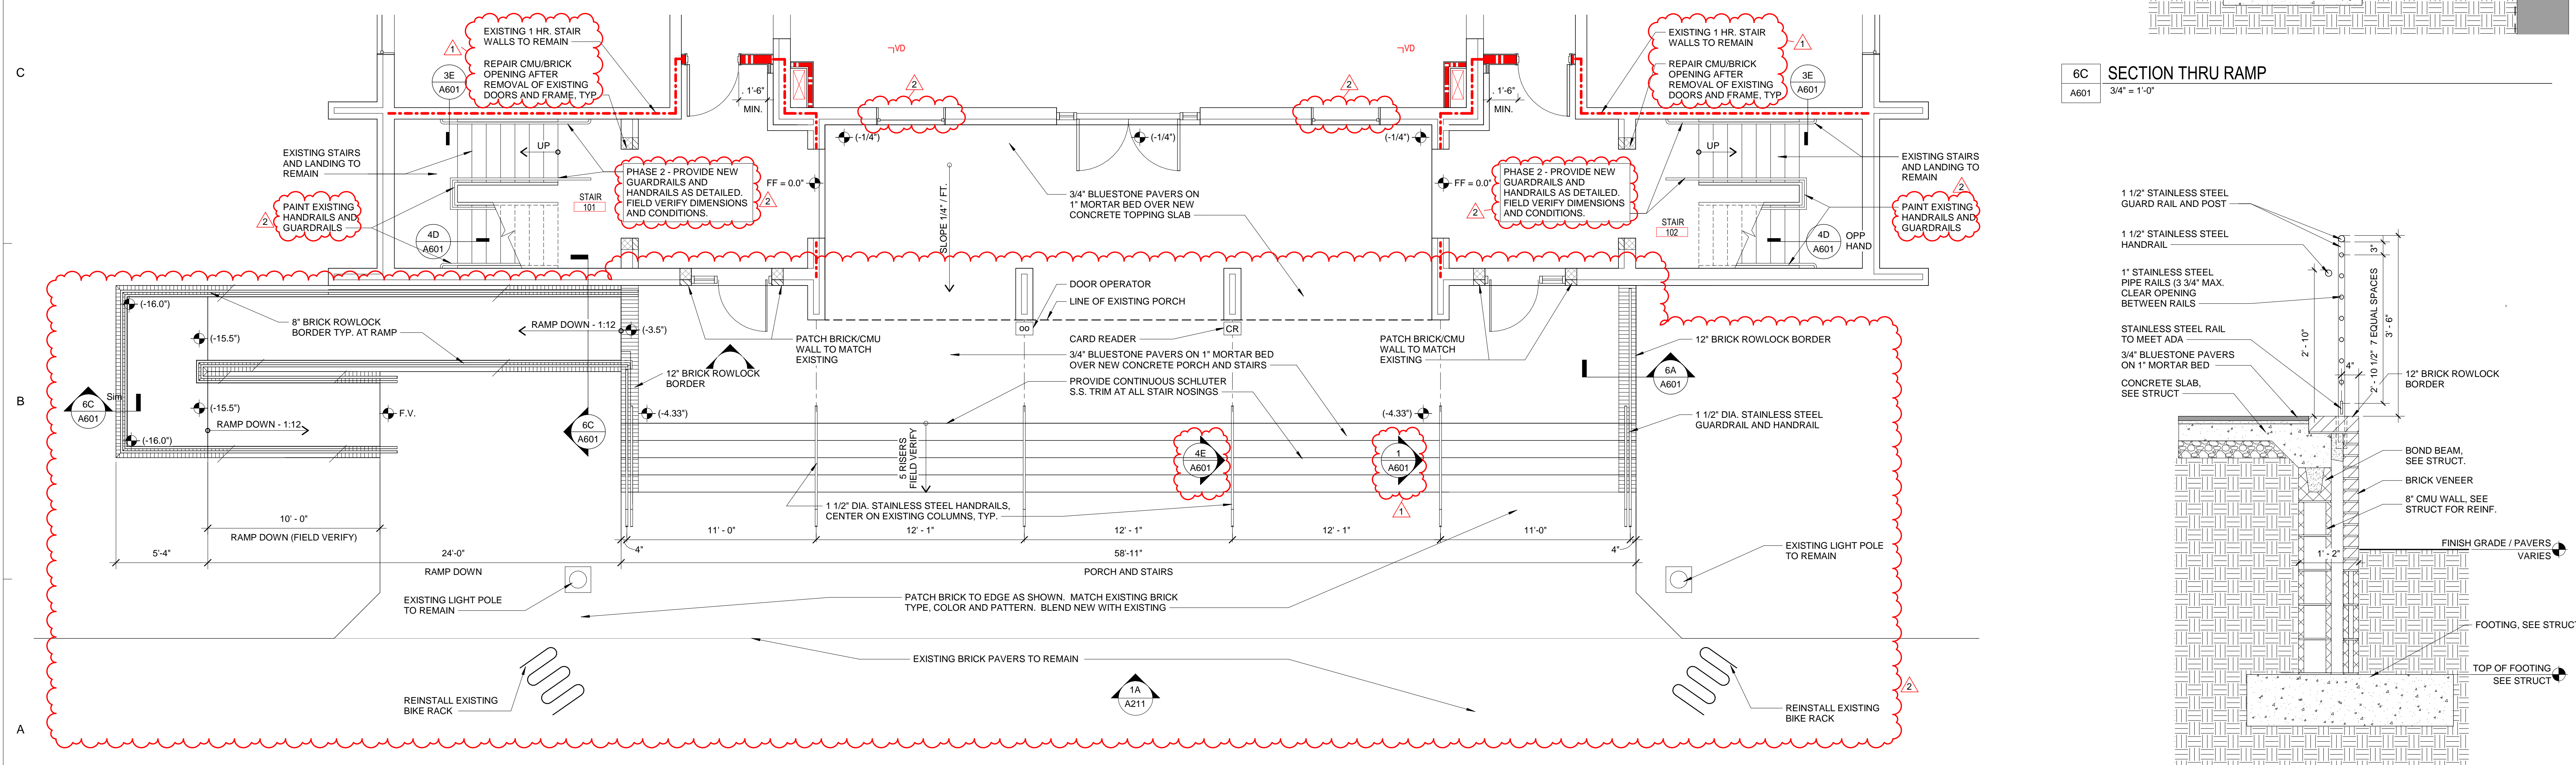
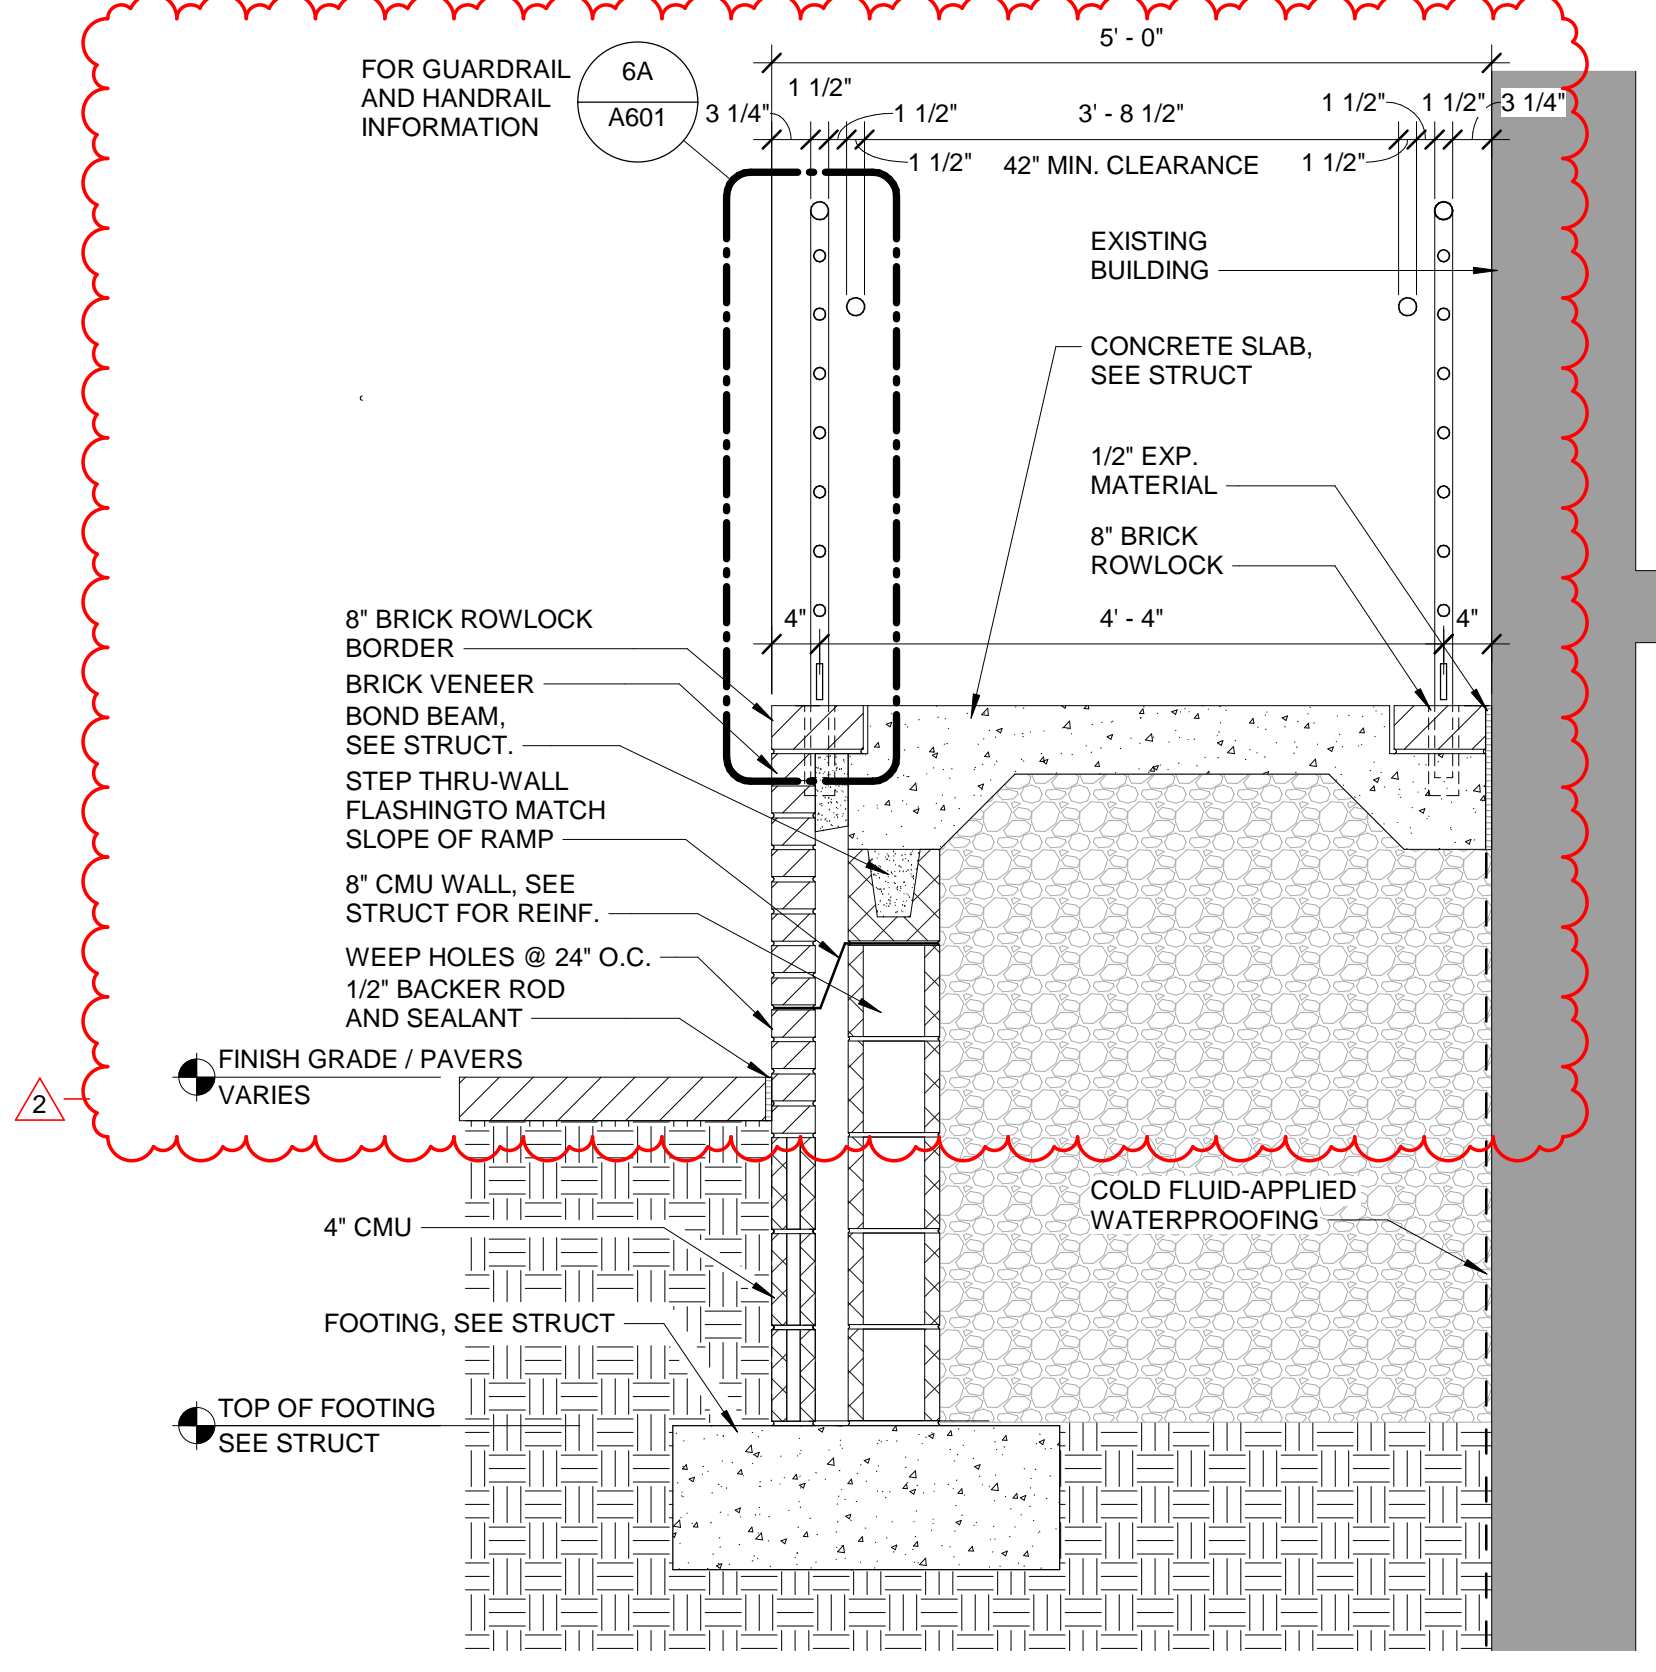
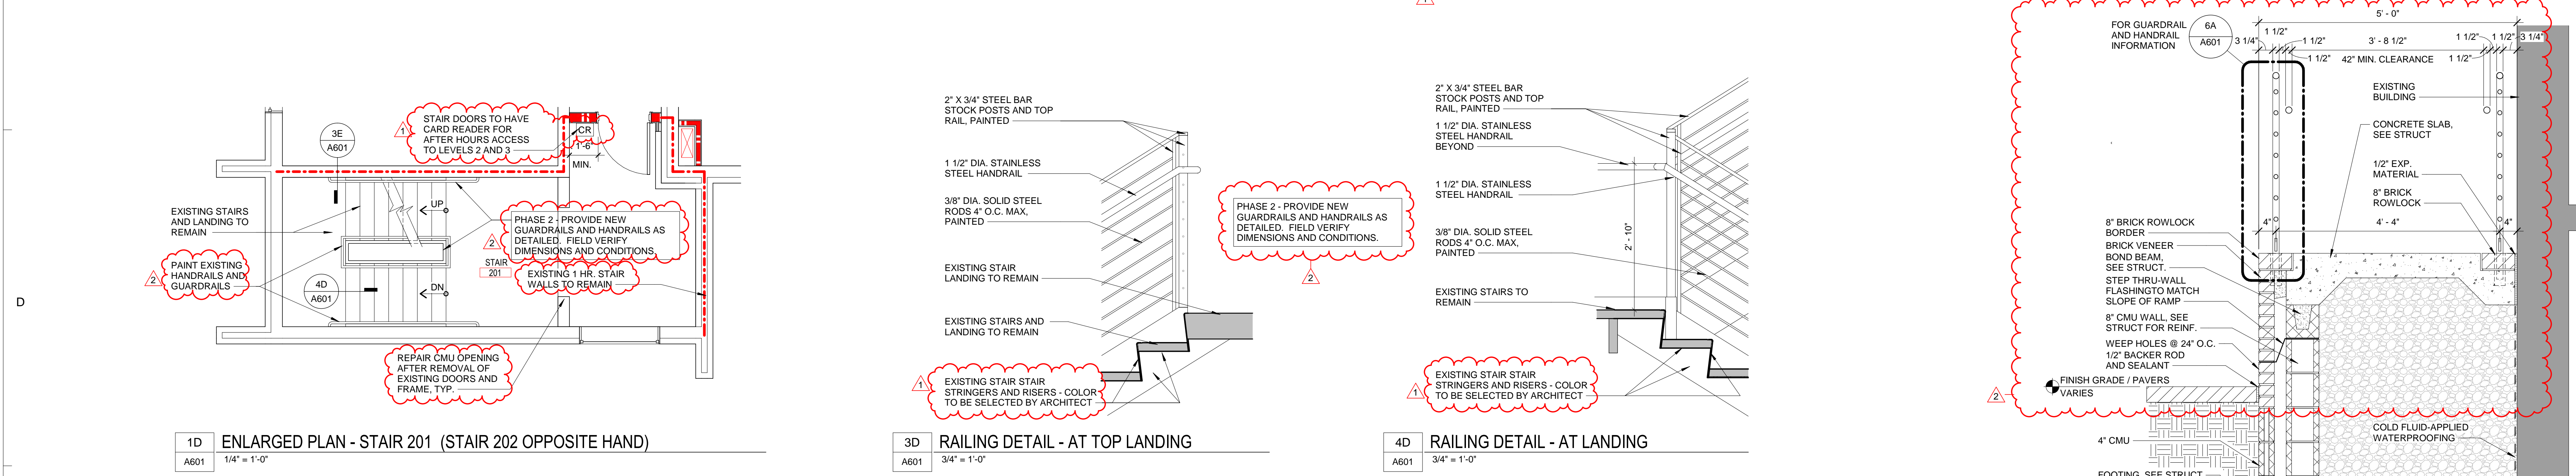
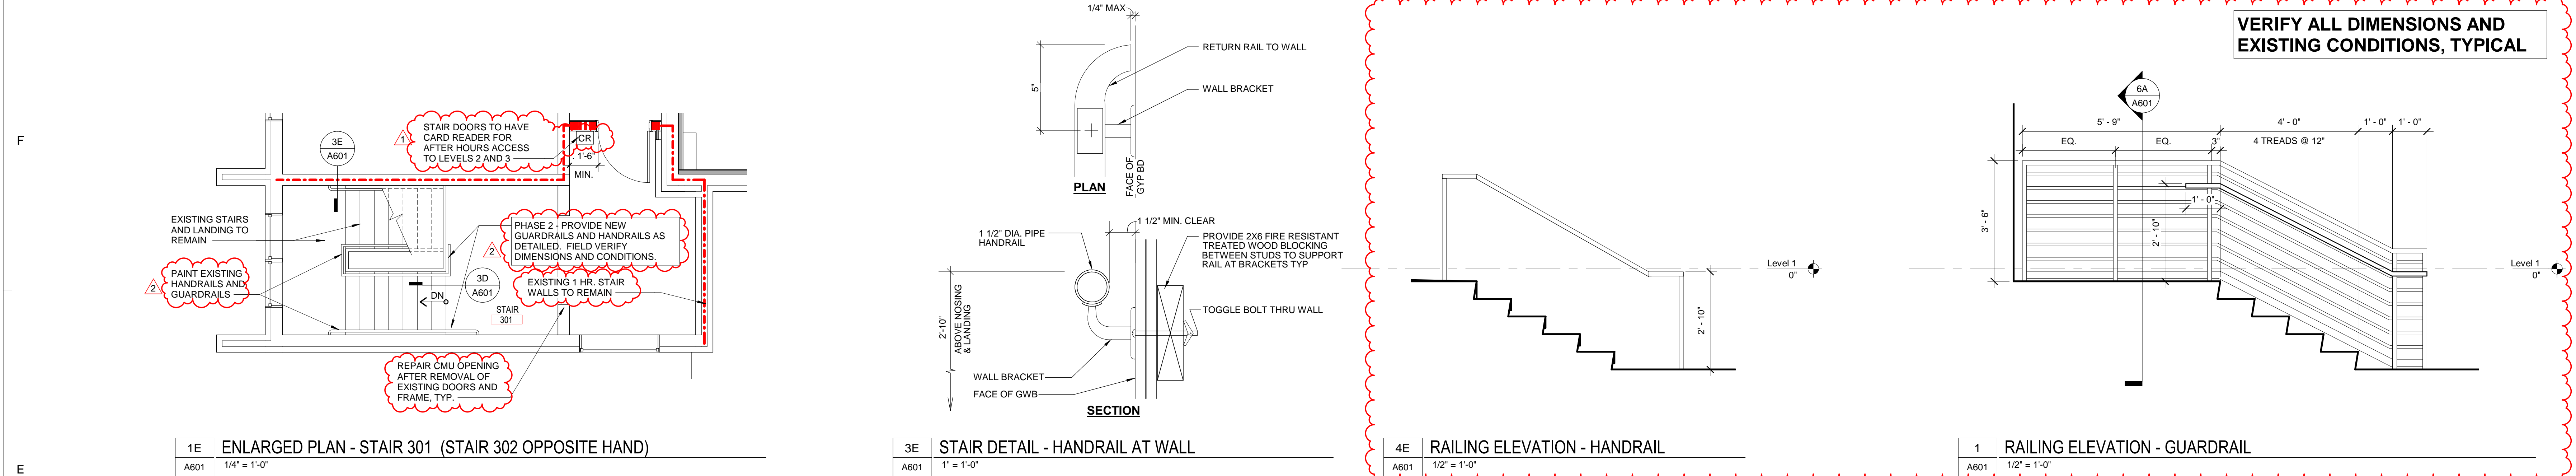
PROJECT TEAM  
PRINCIPAL IN CHARGE: ROB KLINEINST, AIA  
PROJECT MANAGER: SHANE WEBSTER, AIA  
DESIGN TEAM: LITTLE  
COLLEGE NAME: CAMPBELL UNIVERSITY DAY HALL RENOVATIONS

PROJECT NO. 513.9660.00

SHEET TITLE ENLARGED TOILET PLANS AND ELEVATIONS, ENLARGED WORKROOM PLAN

SHEET NUMBER A401

**VERIFY ALL DIMENSIONS AND EXISTING CONDITIONS, TYPICAL**



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SHEET TITLE VERTICAL CIRCULATION

PROJECT TEAM

PRINCIPAL IN CHARGE ROB KLINEDINST, AIA

PROJECT MANAGER SHANE WEBSTER, AIA

DESIGN TEAM LITTLE

PROGRAM NAME CAMPBELL UNIVERSITY DAY HALL RENOVATIONS

PROJECT NO. 513.9660.00

SHEET TITLE VERTICAL CIRCULATION

PROJECT TEAM LITTLE

PRINCIPAL IN CHARGE ROB KLINEDINST, AIA

PROJECT MANAGER SHANE WEBSTER, AIA

DESIGN TEAM LITTLE

PROGRAM NAME CAMPBELL UNIVERSITY DAY HALL RENOVATIONS

PROJECT NO. 513.9660.00

SHEET TITLE VERTICAL CIRCULATION

PROJECT TEAM LITTLE

PRINCIPAL IN CHARGE ROB KLINEDINST, AIA

PROJECT MANAGER SHANE WEBSTER, AIA

DESIGN TEAM LITTLE

PROGRAM NAME CAMPBELL UNIVERSITY DAY HALL RENOVATIONS

PROJECT NO. 513.9660.00

SHEET TITLE VERTICAL CIRCULATION

PROJECT TEAM LITTLE

PRINCIPAL IN CHARGE ROB KLINEDINST, AIA

PROJECT MANAGER SHANE WEBSTER, AIA

DESIGN TEAM LITTLE


PROGRAM NAME CAMPBELL UNIVERSITY DAY HALL RENOVATIONS

PROJECT NO. 513.9660.00

SHEET TITLE VERTICAL CIRCULATION


SHEET NUMBER A601

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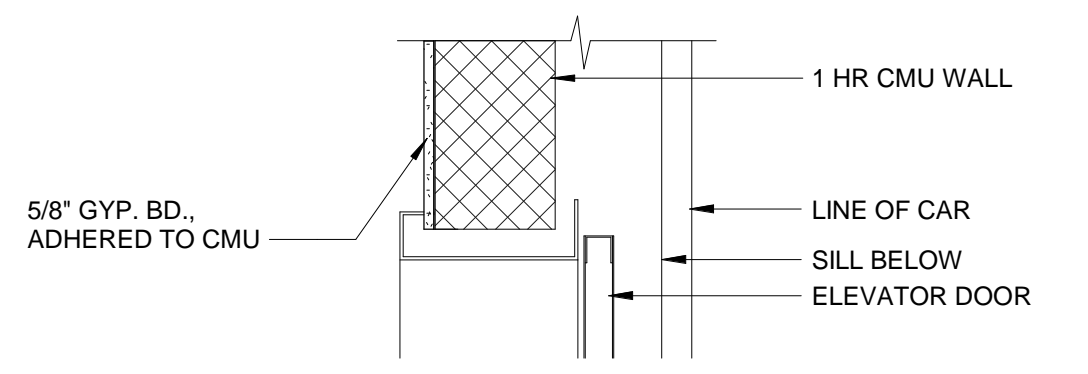


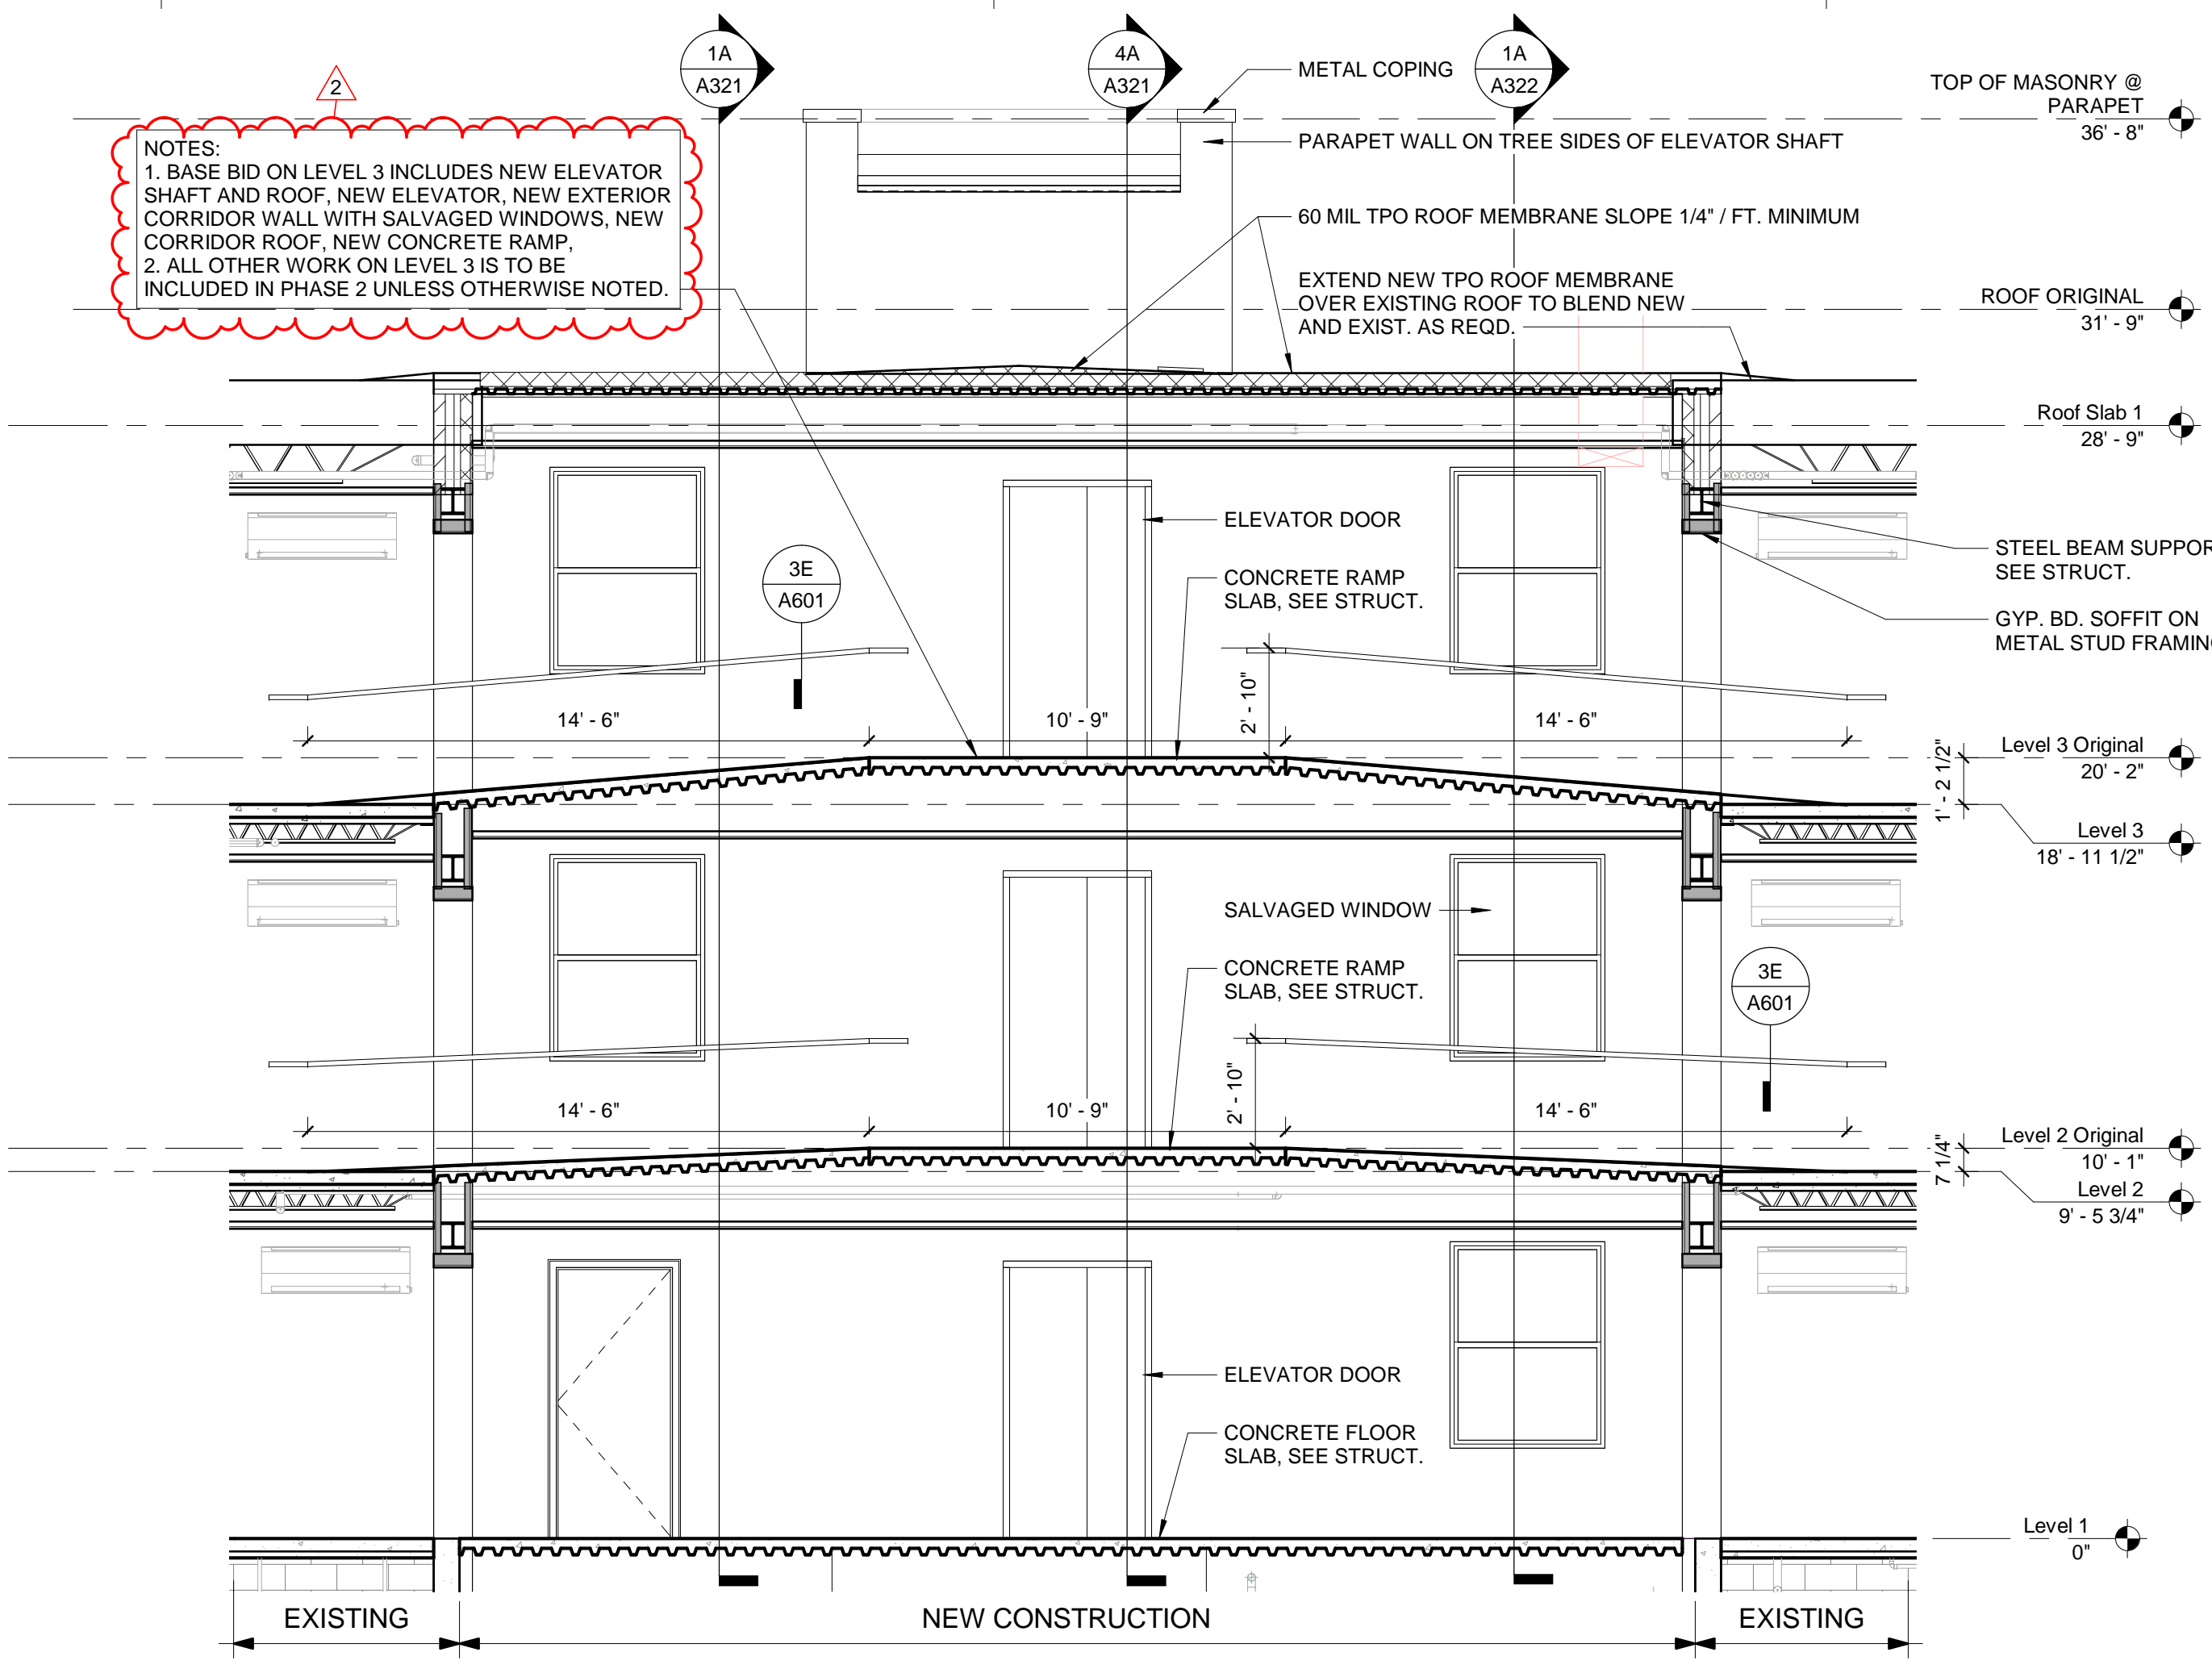**4D PARTIAL BUILDING SECTION - CORRIDOR ADDITION**  
A602 1/4" = 1'-0"


**VERIFY ALL DIMENSIONS AND EXISTING CONDITIONS, TYPICAL**

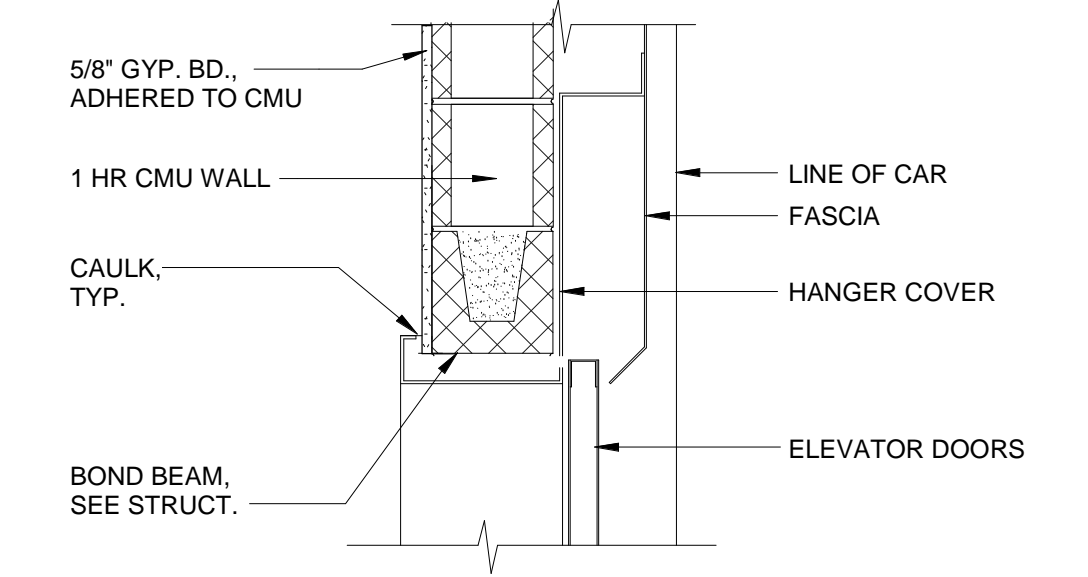


**6F Elevator Detail - Head**  
A602 1" = 1'-0"




**6D Elevator Detail - Jamb**  
A602 1" = 1'-0"

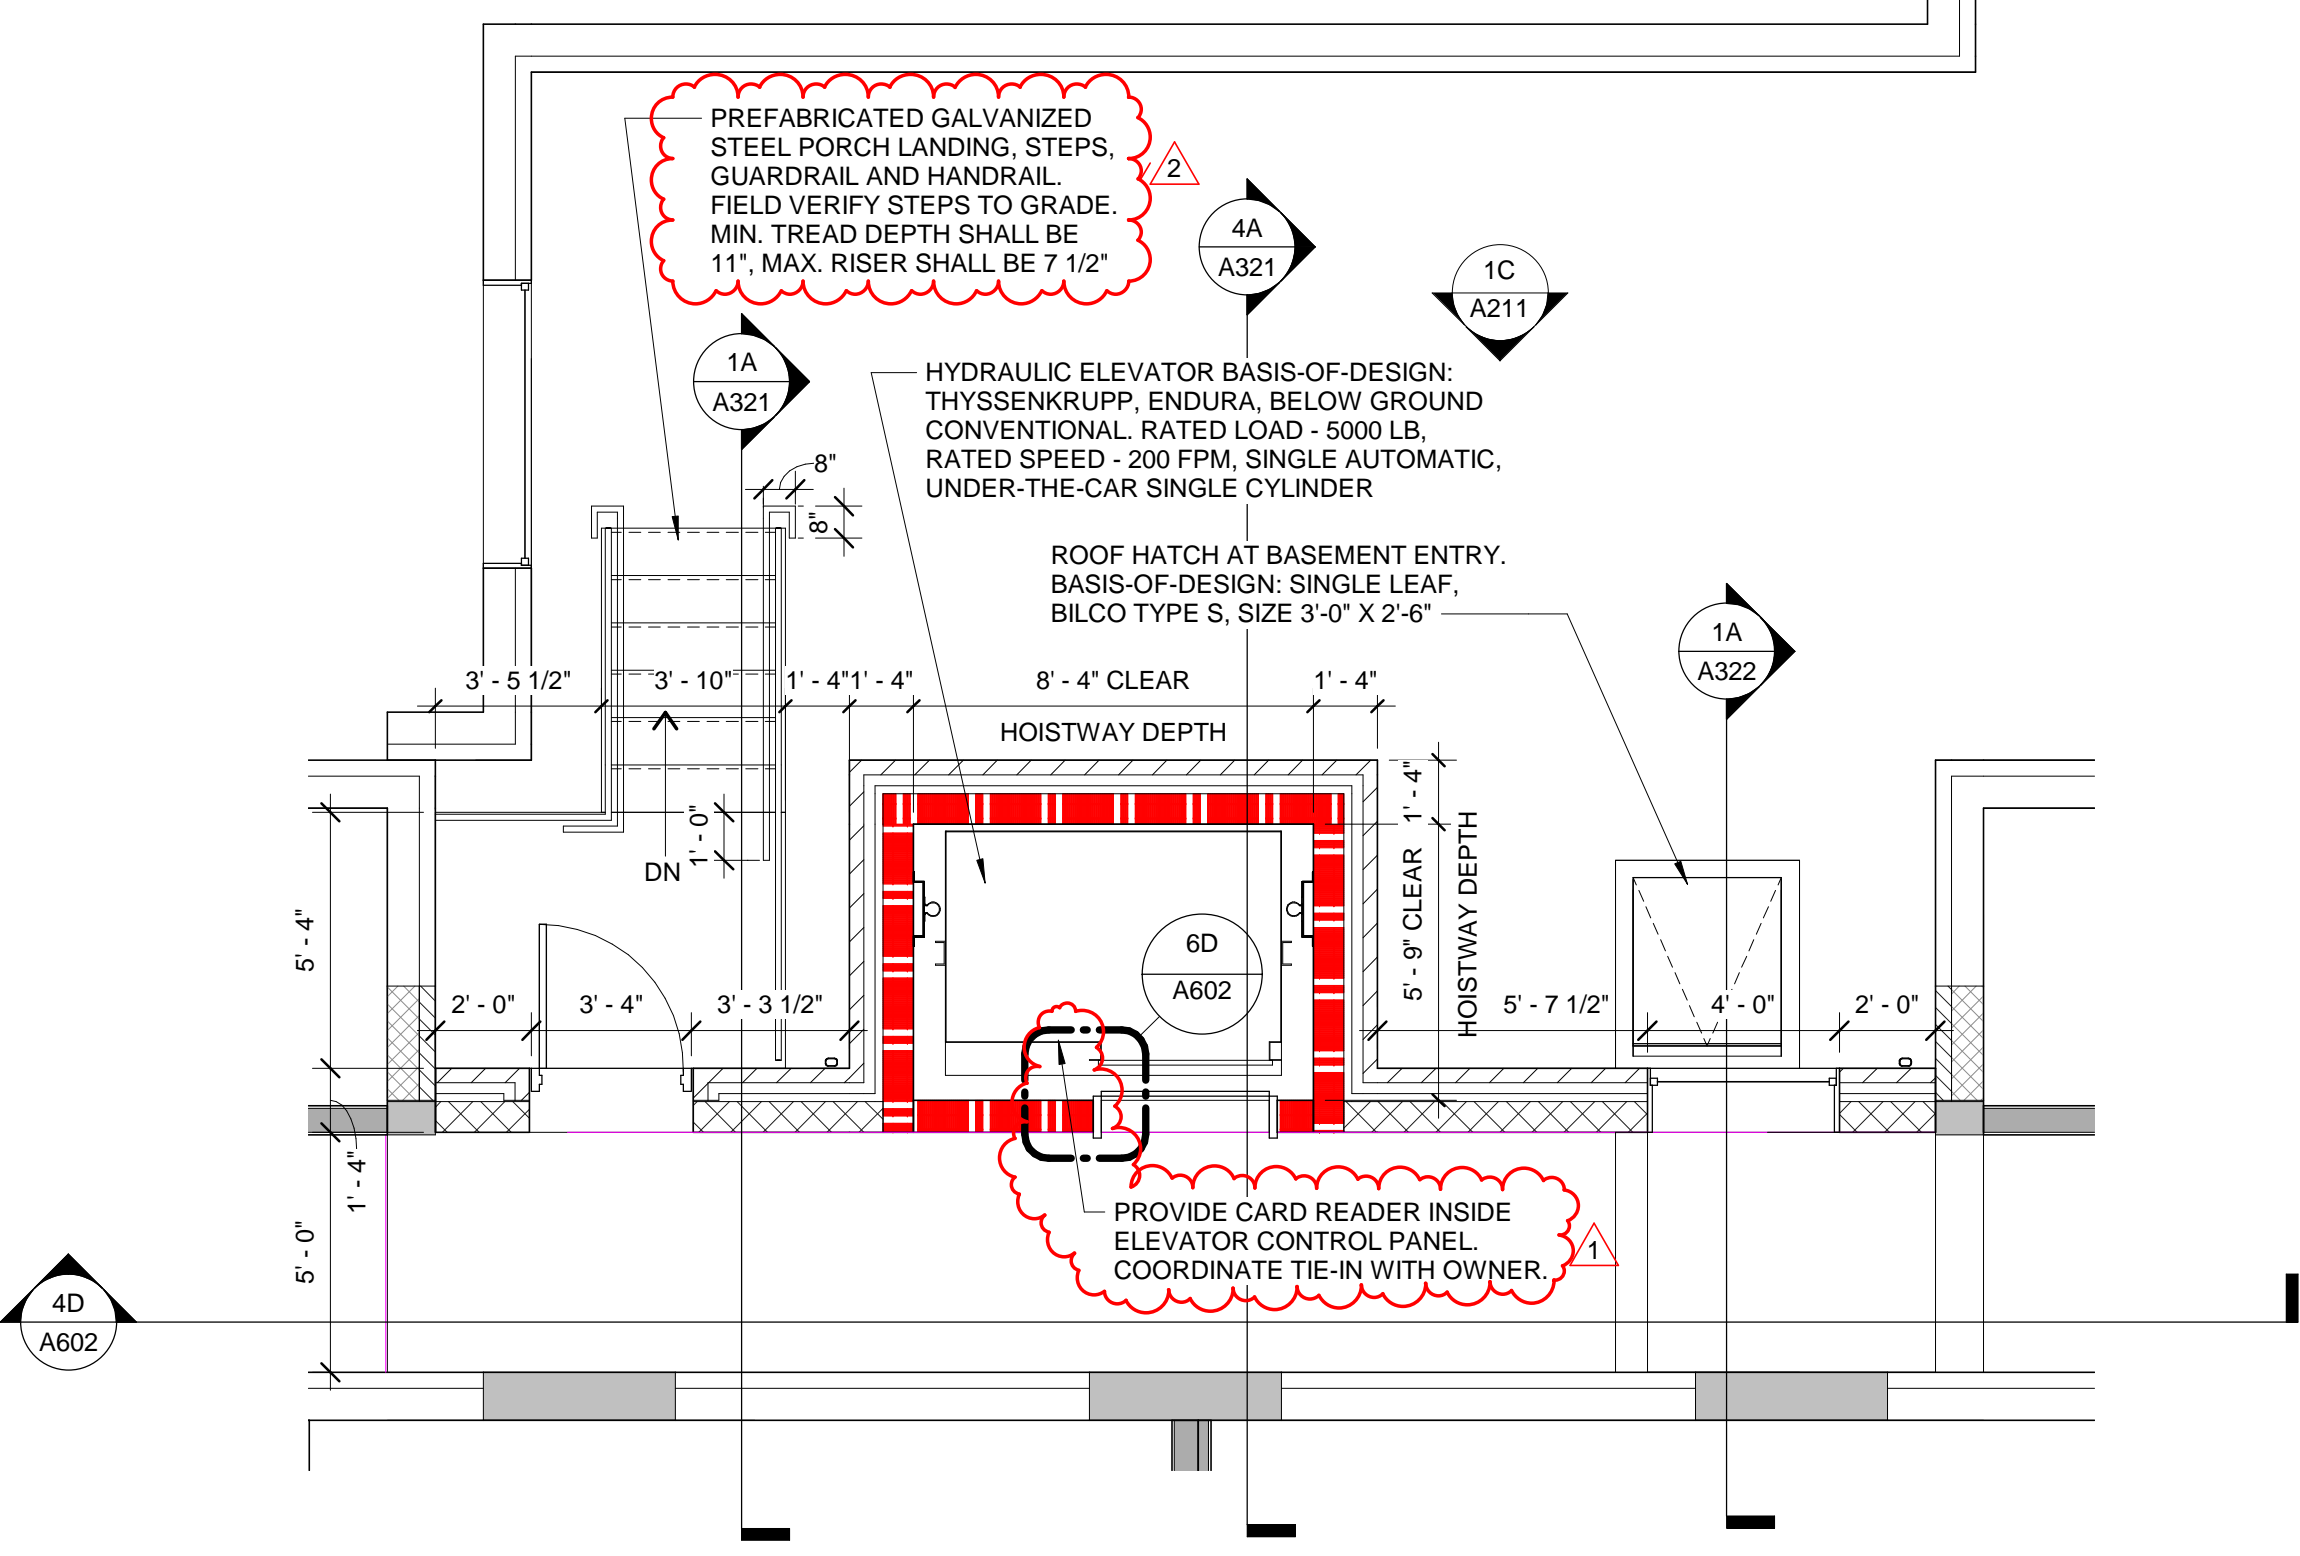


**1C ENLARGED PLAN - LEVEL 1 - ELEVATOR / STAIRS**  
A602 1/4" = 1'-0"

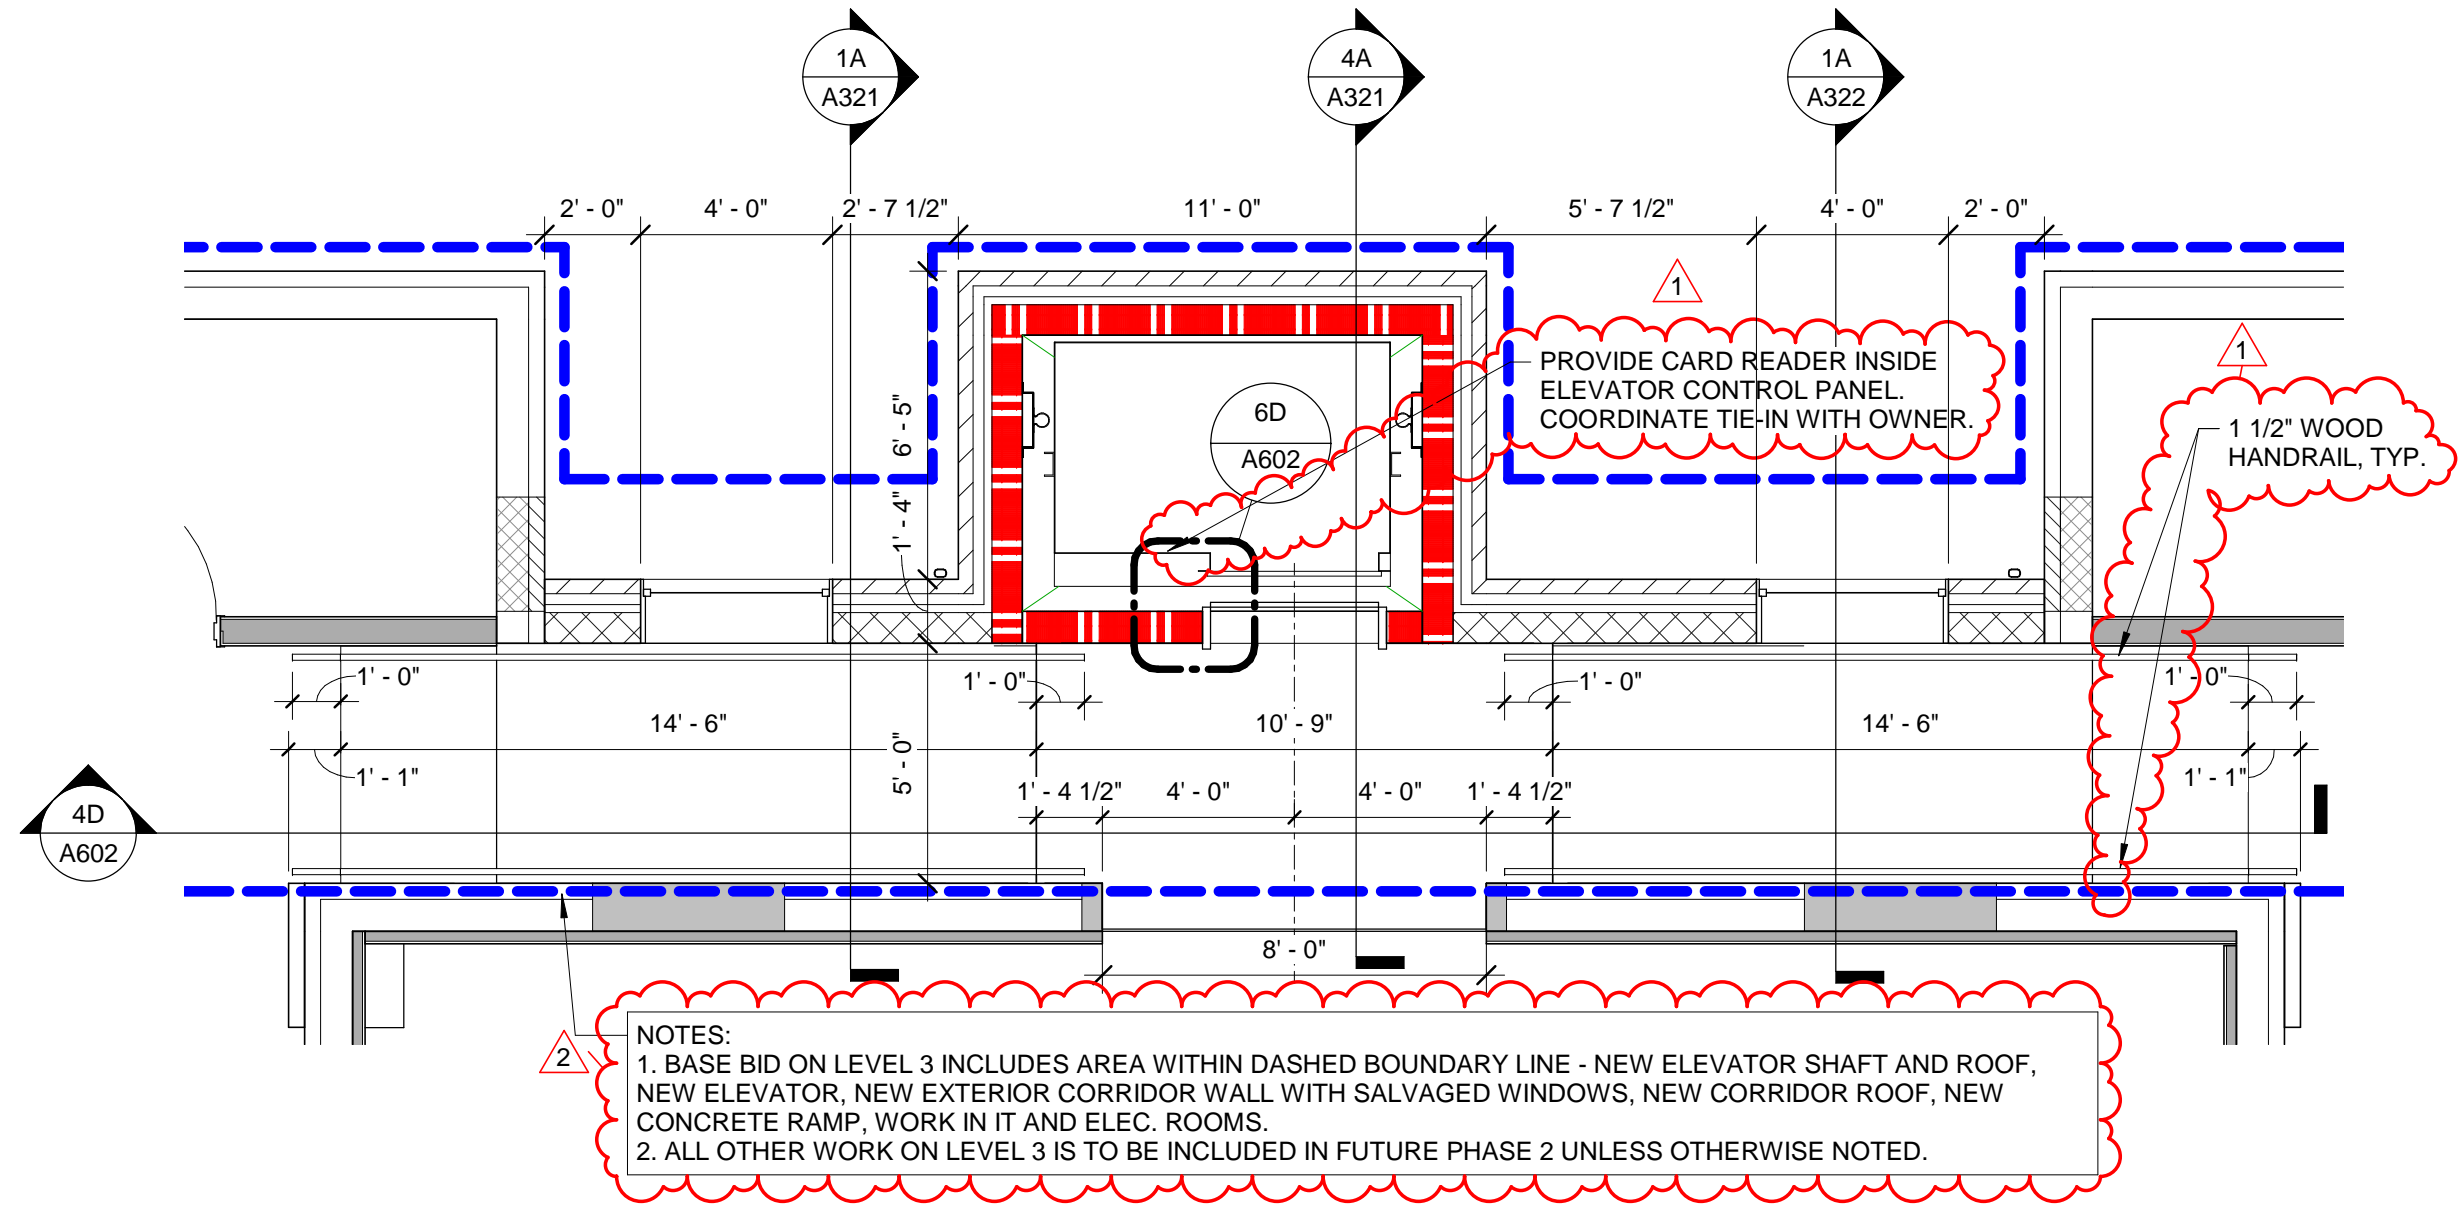


**4C ENLARGED PLAN - LEVEL 3 - ELEVATOR / RAMPS**  
A602 1/4" = 1'-0"

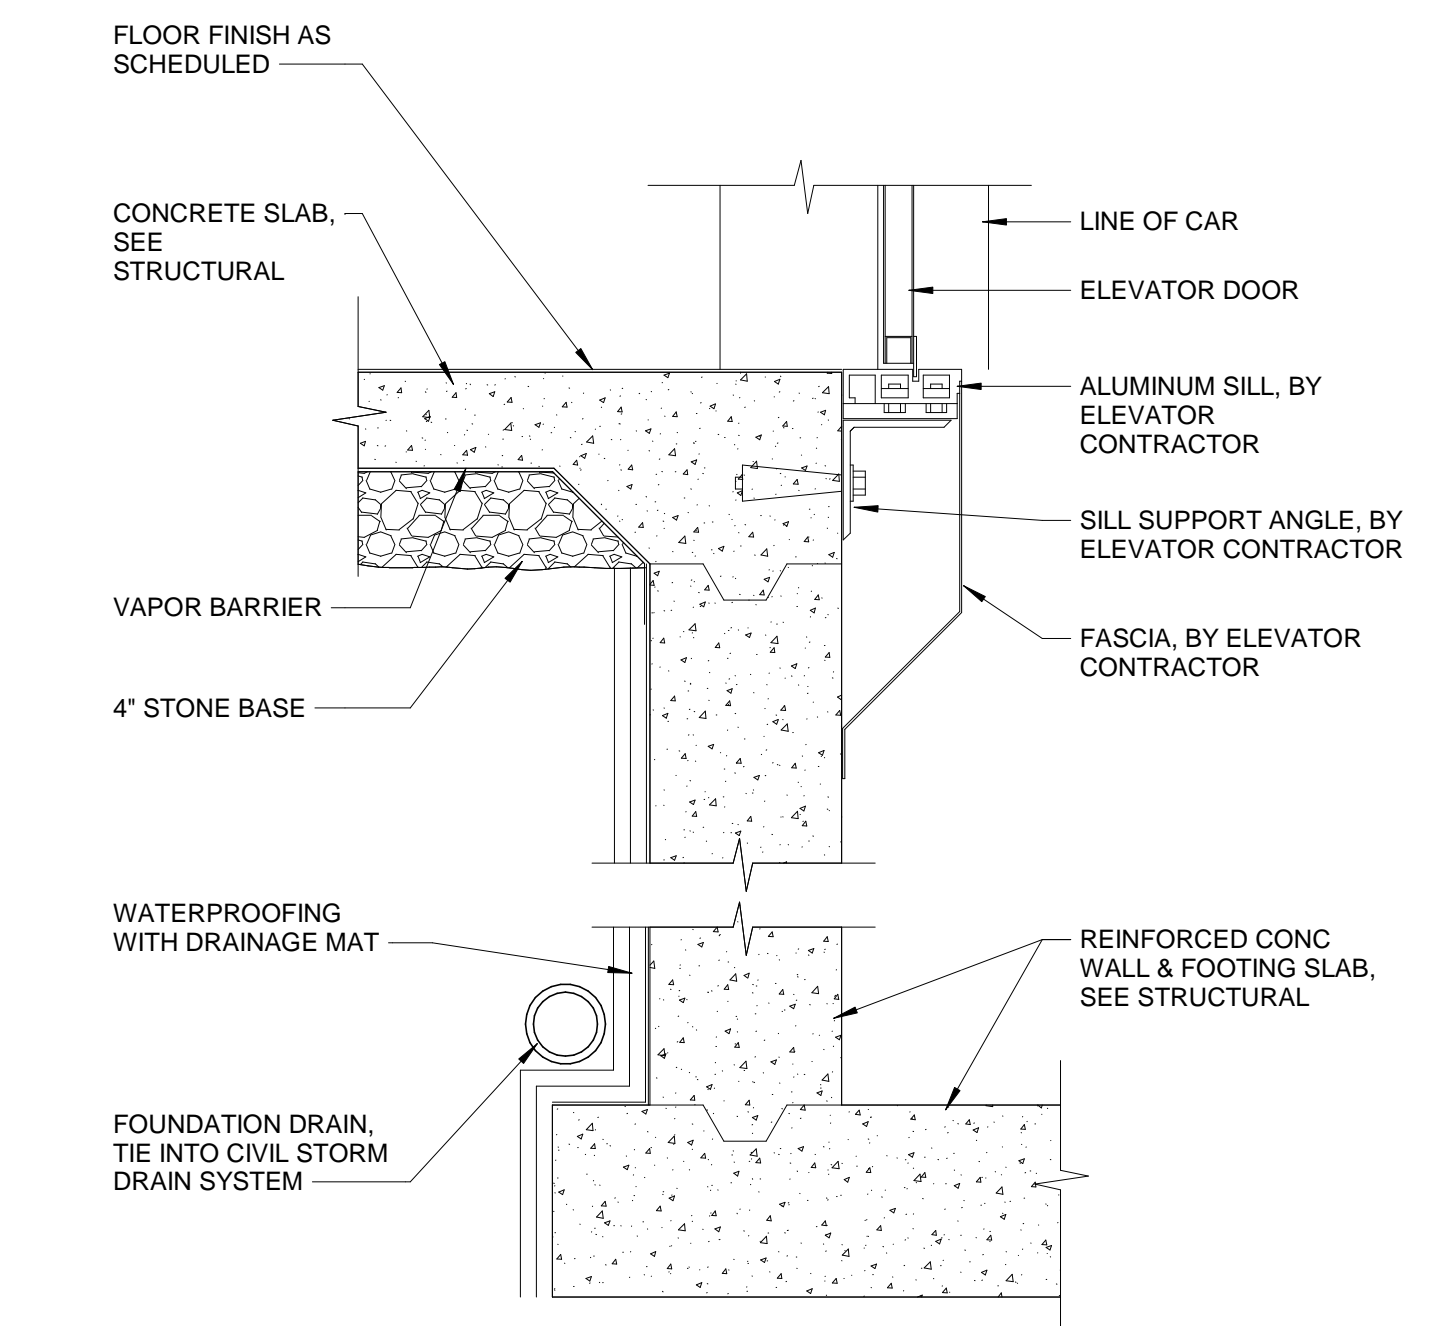


**6B Elevator Detail - Pit / Sill**  
A602 1" = 1'-0"

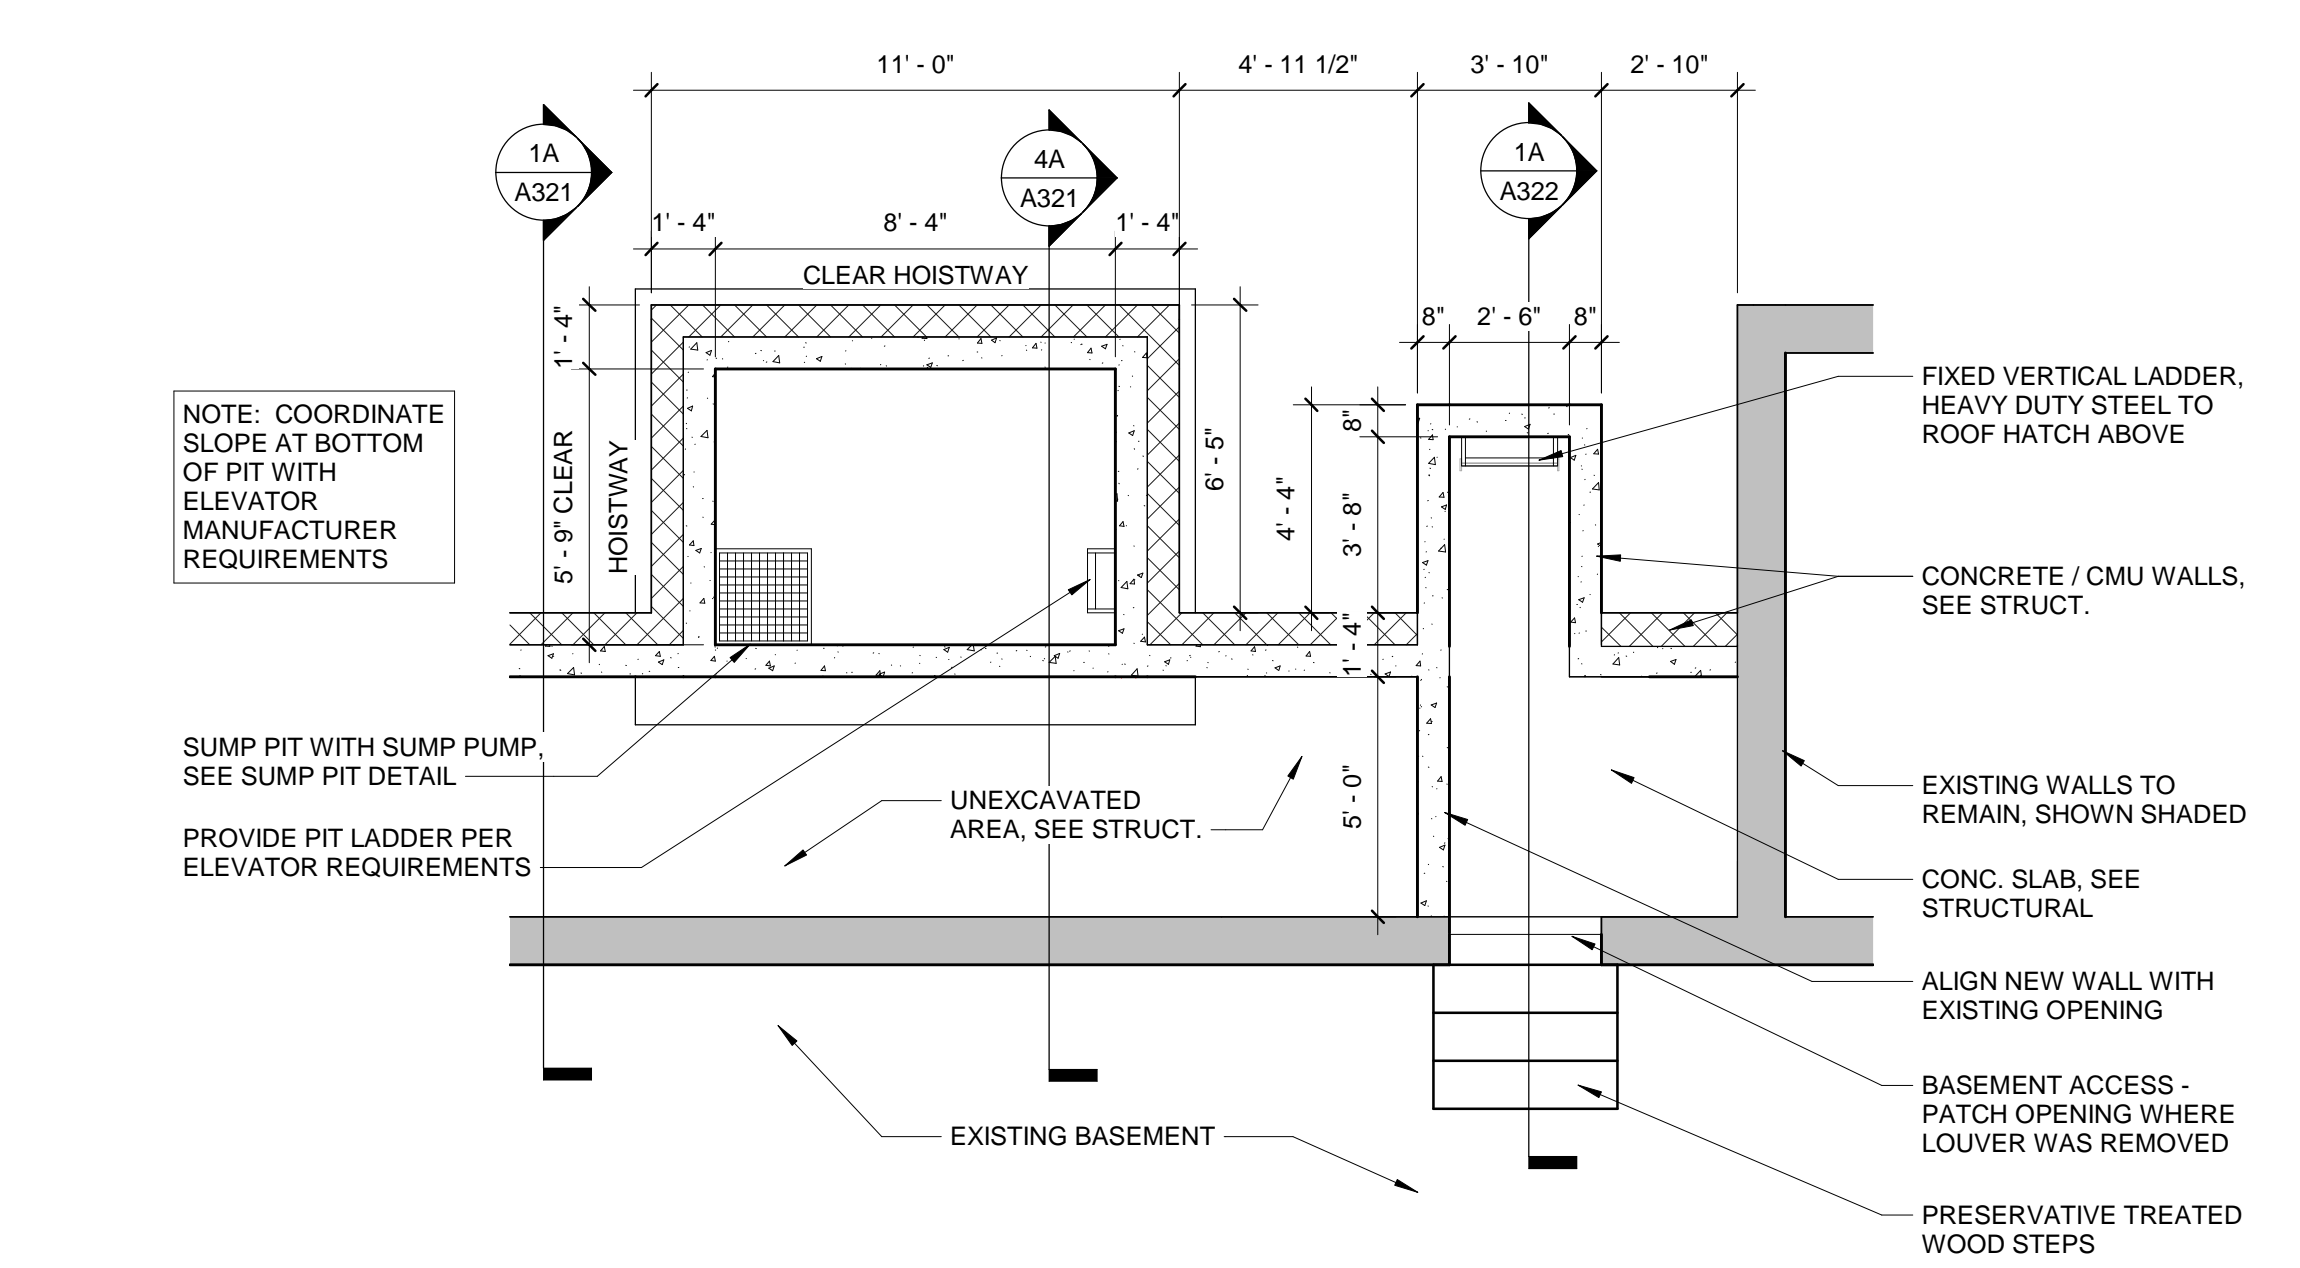

**1A ENLARGED PLAN - LEVEL 0 - ELEVATOR PIT/ BASEMENT ACCESS**  
A602 1/4" = 1'-0"

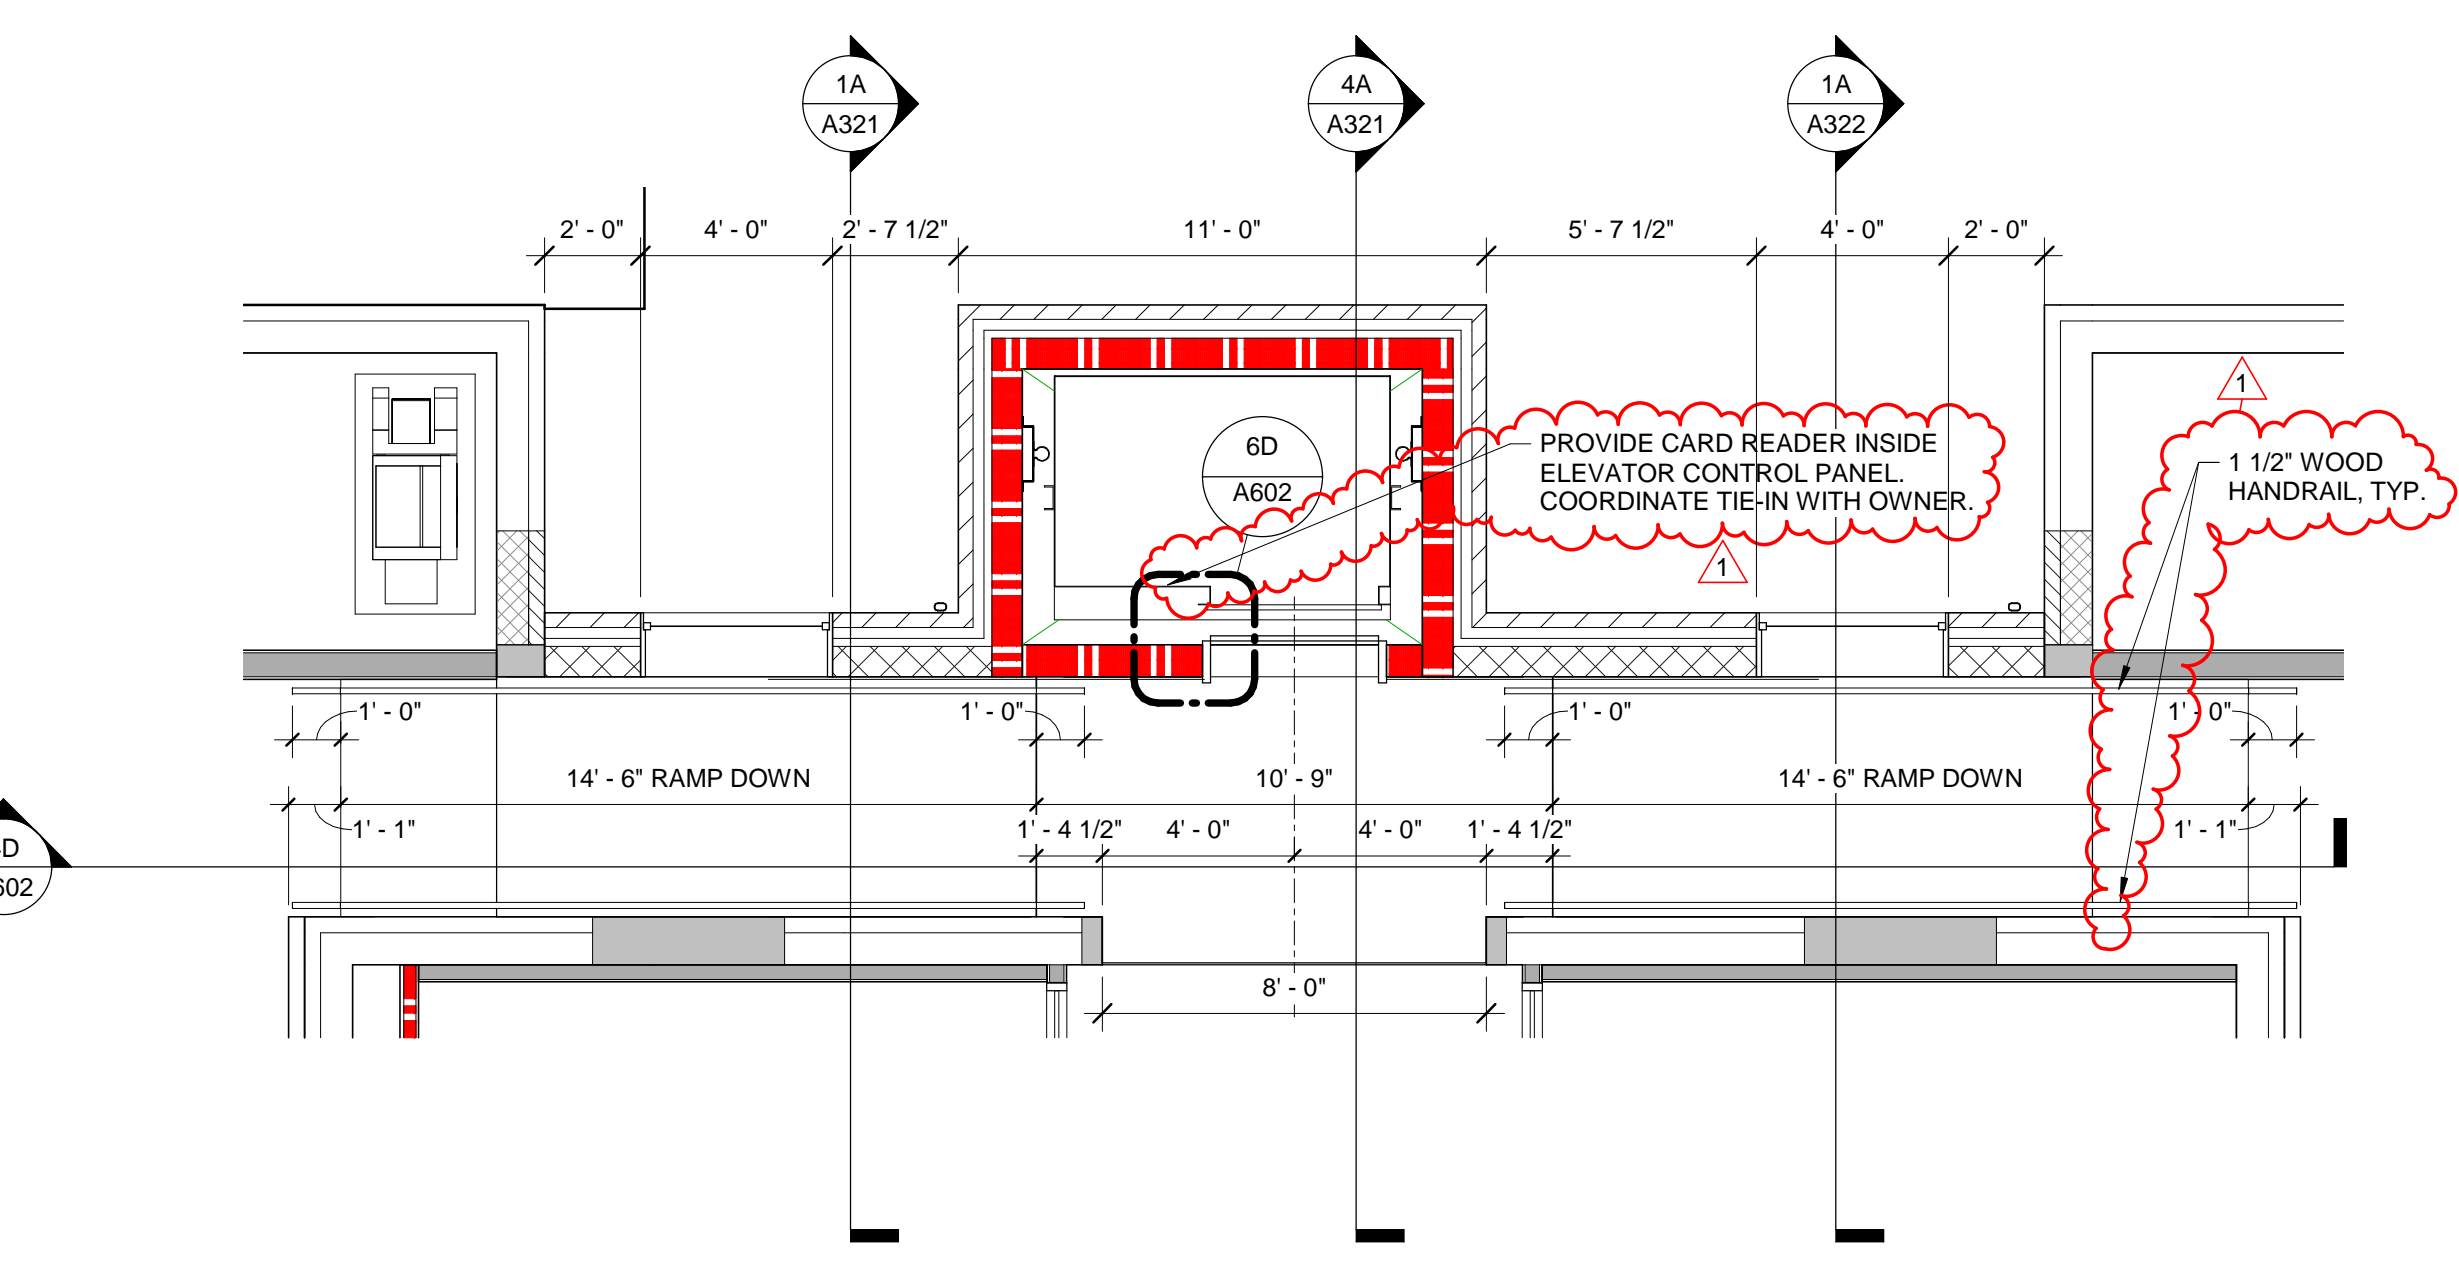

**4A ENLARGED PLAN - LEVEL 2 - ELEVATOR / RAMPS**  
A602 1/4" = 1'-0"

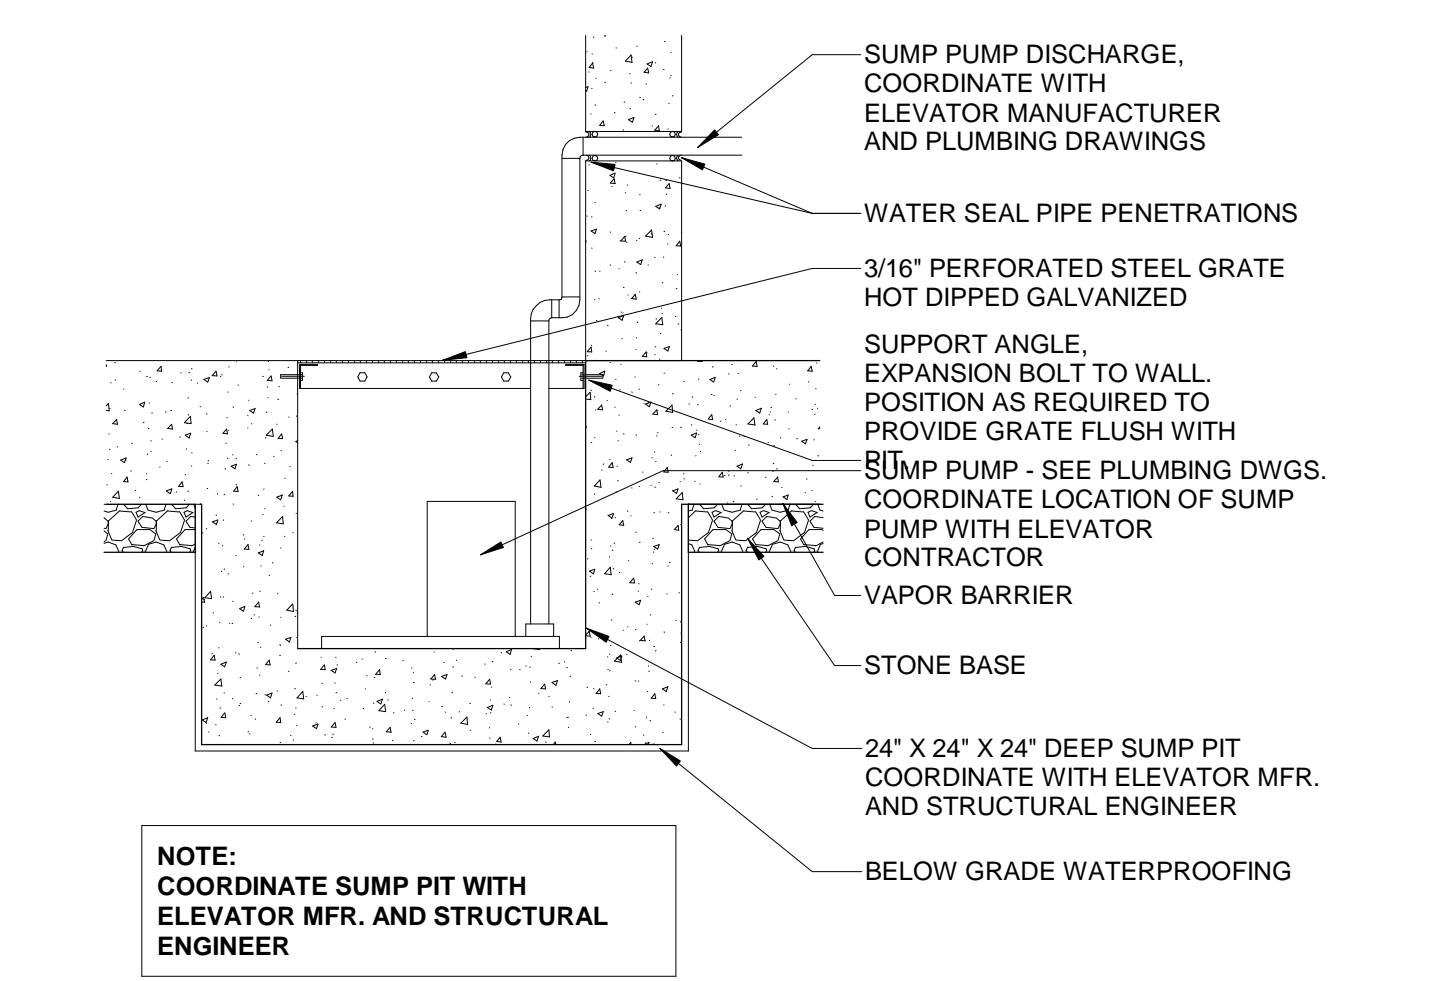

**6A DETAIL @ ELEVATOR SUMP PIT**  
A602 3/4" = 1'-0"



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PROJECT MANAGER: SHANE WEBSTER, AIA  
DESIGN TEAM: LITTLE  
PROJECT NAME: CAMPBELL UNIVERSITY DAY HALL RENOVATIONS

PROJECT NO.: 513.9660.00

SHEET TITLE: VERTICAL CIRCULATION



SHEET NUMBER: A602

VERIFY ALL DIMENSIONS AND EXISTING CONDITIONS, TYPICAL

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FINISH MATERIAL SCHEDULE										
Order	Location	Tag	Description	Manufacturer	Style	Size	Finish Description	Color	Install Notes	Comments
							Product Number			
1	WALL	P-1	PAINT	SHERWIN WILLIAMS	SEMI-GLOSS LOW SHEEN		SW6071	POPULAR GRAY		FIELD PAINT
1	WALL	P-2	PAINT	SHERWIN WILLIAMS	SEMI-GLOSS LOW SHEEN		SW7038	TONY TAUPE		OFFICE PAINT
1	WALL	P-3	PAINT	SHERWIN WILLIAMS	SEMI-GLOSS LOW SHEEN		SW6886	INVIGORATE		ACCENT PAINT
1	WALL	P-4	PAINT	SHERWIN WILLIAMS	SEMI-GLOSS LOW SHEEN		SW6883	RAUCOUS ORANGE		ACCENT PAINT
1	WALL	WT-1	CERAMIC WALL TILE	DALTILE	RITTENHOUSE SQ	3X6		ARCTIC WHITE	ASHLAR	
2	BASE	RB-1	RUBBER BASE	JOHNSONITE	COVE	4"H ROLL	460	COTTON		
2	BASE	RB-2	RUBBER BASE	JOHNSONITE	COVE	4"H ROLL	280	SHORELINE		
2	BASE	RB-3	RUBBER BASE	JOHNSONITE	COVE	4"H ROLL	121	CEMENT		
2	BASE	TB-1	TILE BASE	CROSSVILLE	BULLNOSE	4x24	AV243	FOG, UNPOLISHED		
3	FLOOR	CON-1	SEALED CONCRETE							
3	FLOOR	CPT-1	CARPET TILE	SHAW	VIBRANT TILE	24"x24"	5T001 01761	PIXEL	ASHLAR; GRAIN PLAN N/S	
3	FLOOR	CPT-2	CARPET TILE	SHAW	FIELD TILE	24"x24"	5T079 78675	LANDSCAPE	ASHLAR; GRAIN PLAN EW	
3	FLOOR	CPT-3	CARPET TILE	SHAW	ABSORBED TILE	24"x24"	5T003 01761	PIXEL	ASHLAR; GRAIN PLAN N/S	
3	FLOOR	CPT-4	CARPET TILE	SHAW	SCAPE TILE	24"x24"	5T080 78675	LANDSCAPE	ASHLAR; GRAIN PLAN EW	
3	FLOOR	FT-1	PORCELAIN FLOOR TILE	CROSSVILLE	SHADES	12"x24"	AV243	FOG, UNPOLISHED	1/3 OFFSET	
3	FLOOR	LVT-1	LUXURY VINYL TILE	SHAW	GRAIN	7"x48"	0364V 64103	COCOA	1/3 OFFSET	
3	FLOOR	LVT-2	LUXURY VINYL TILE	SHAW	PIGMENT	7"x48"	0365V 65675	ORANGE	1/3 OFFSET	
3	FLOOR	RS-1	RUBBER FLOOR TILE	JOHNSONITE	ROUNDEL	24"x24"	HTR-121	ASHLAR		STAIR LANDINGS
3	FLOOR	RS-1	RUBBER STAIR TREAD WITH INTEGRATED RISER	JOHNSONITE	STAIR TREAD WITH INTEGRATED RISER, NO VI INSERT		HTR-121	CEMENT, HAMMERED		STAIR
4	CASEWORK	PL-1	PLASTIC LAMINATE	WILSONART	PREMIUM LAMINATE		5012K-19	MAGNOLIA, LENO WEAWE FINISH		CABINETS
4	CASEWORK	PL-2	PLASTIC LAMINATE	WILSONART	STANDARD LAMINATE		4886-38	PEARL SOAPSTONE, FINE VELVET FINISH		COUNTERTOPS-
5	MISC.	GB-1	GLASSBOARD							
5	MISC.	P-4	PAINT	SHERWIN WILLIAMS	GLOSS		SW7020	BLACK FOX	EXPOSED STEEL AT STAIRS	
5	MISC.	WT-1	WINDOW TREATMENT-BLINDS	HUNTER DOUGLAS	1" ALUM. MINI BLINDS	1" X 1 1/2" HEADRAIL	CE80	BRUSHED ALUM. 065		ALL EXTERIOR WINDOWS



1A Level 1 - Base Bid Finish Plan  
A801 1/8" = 1'-0"

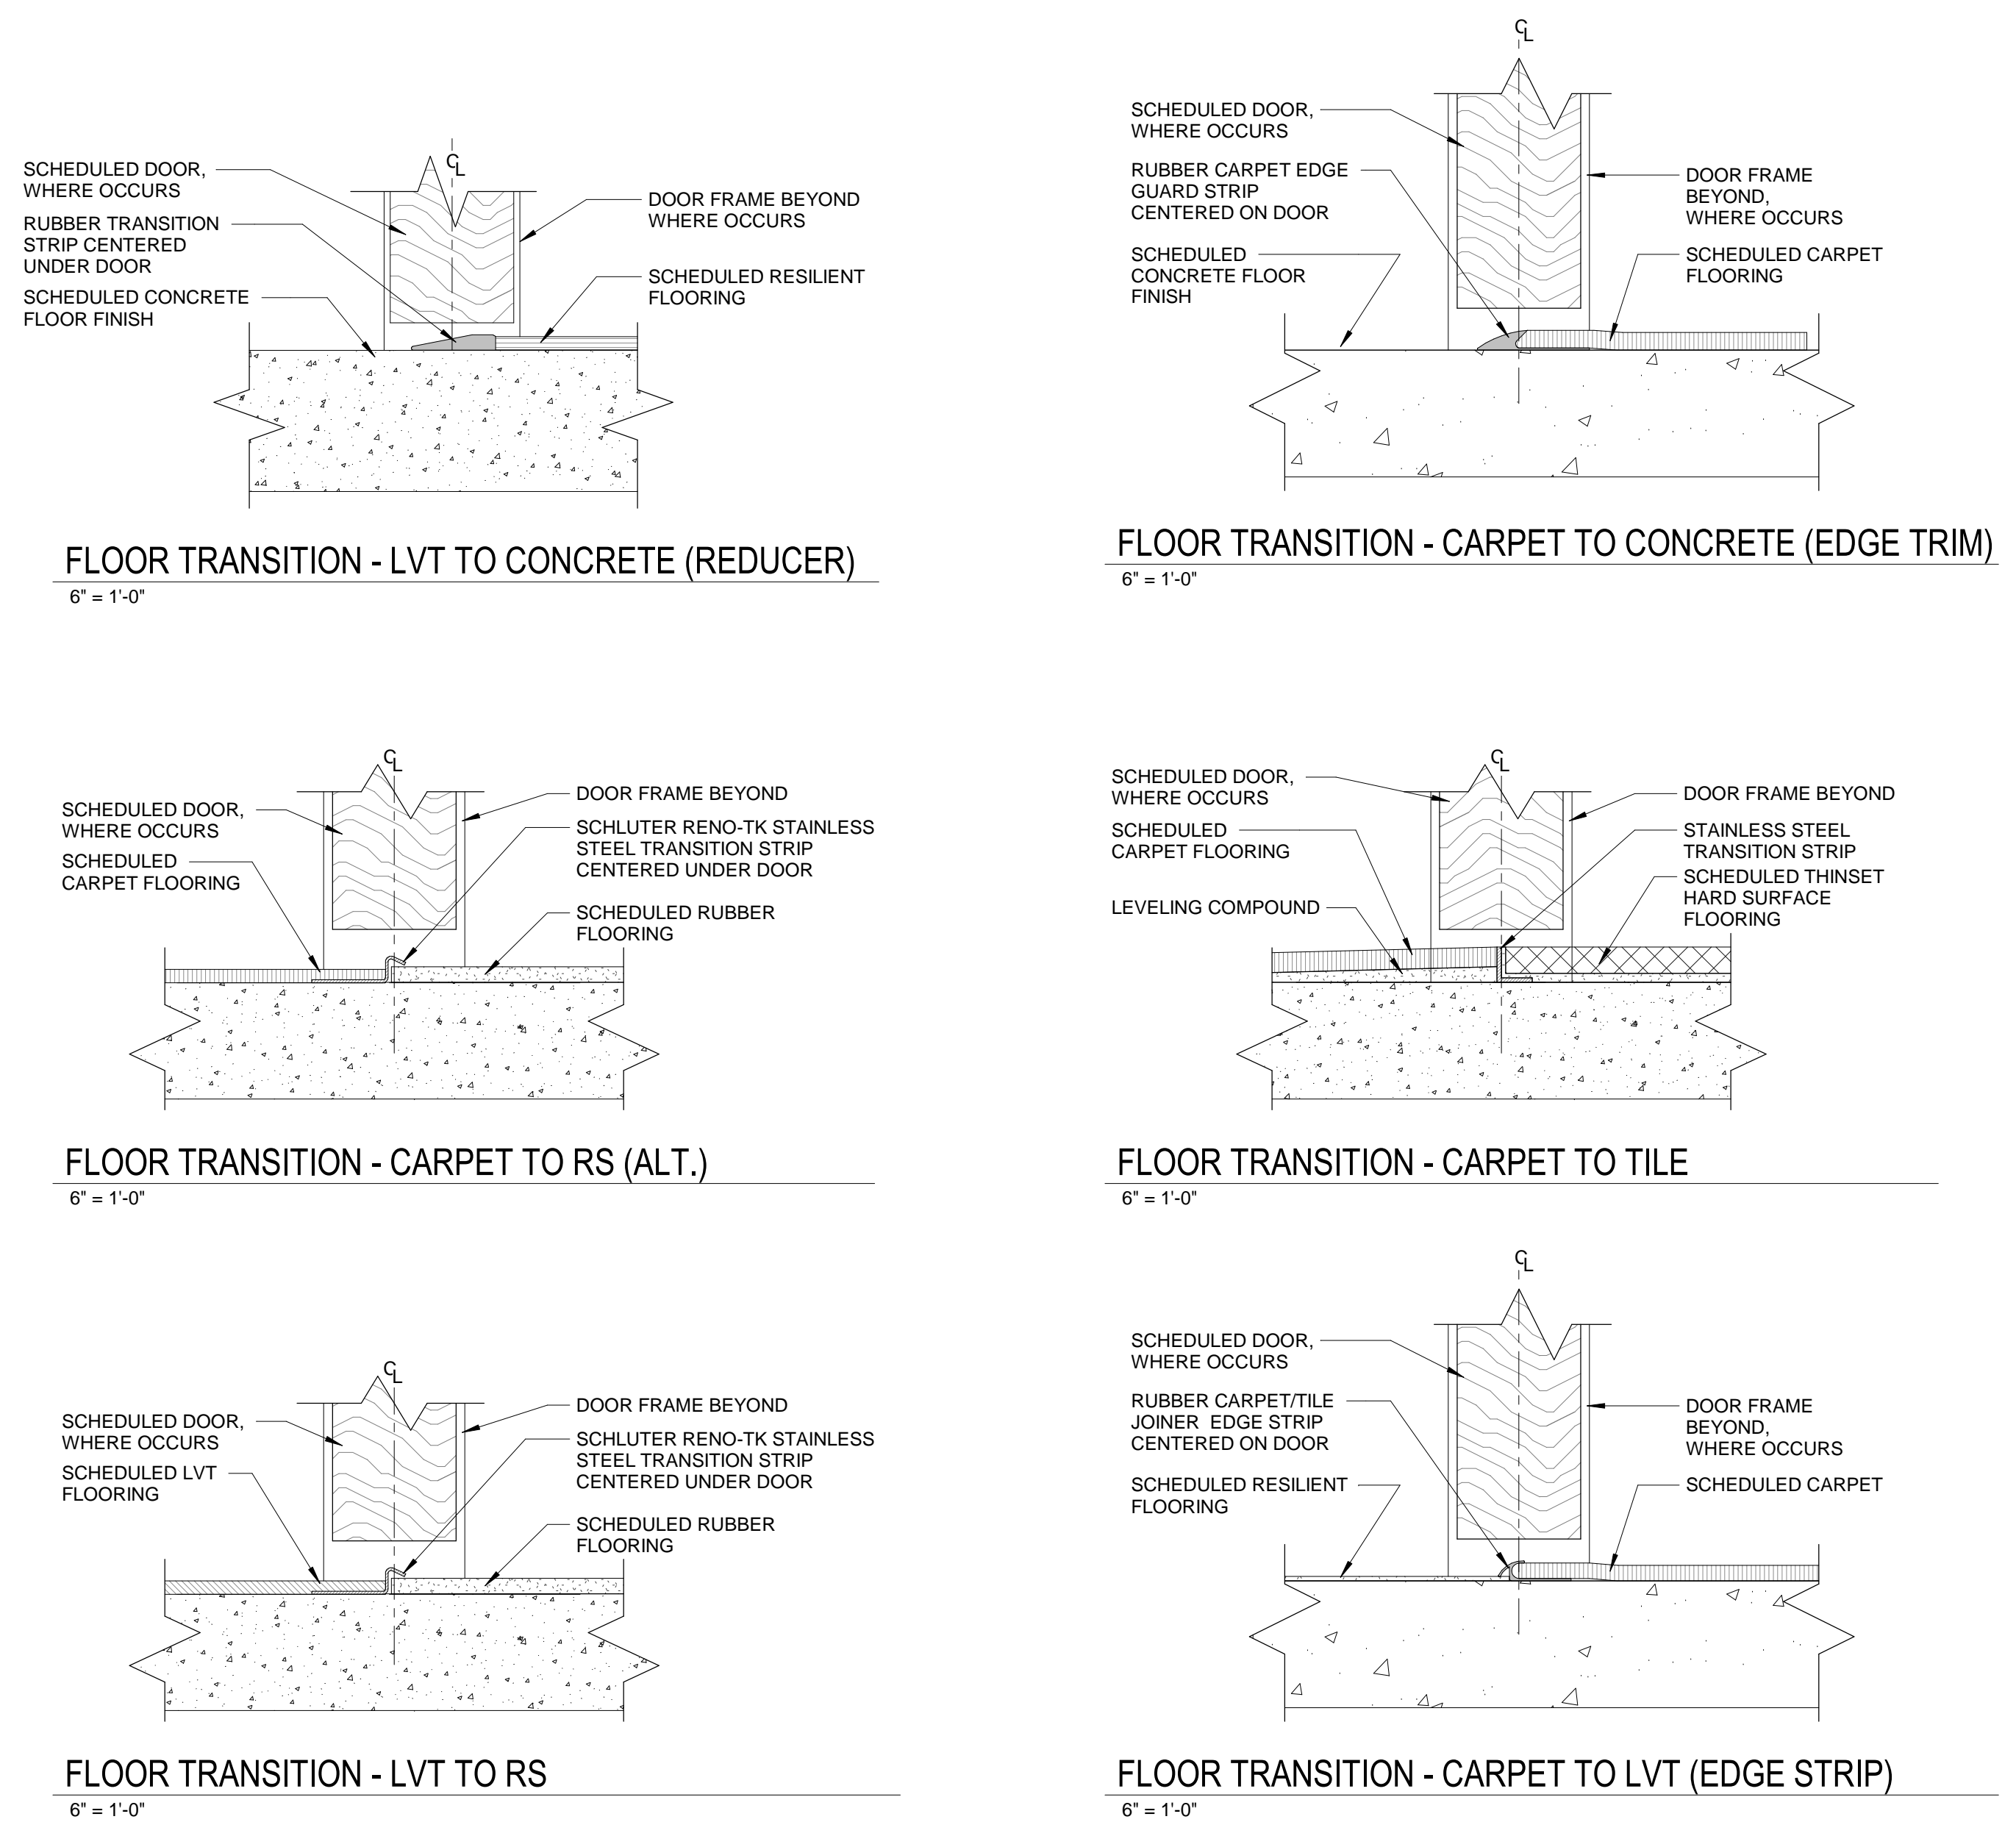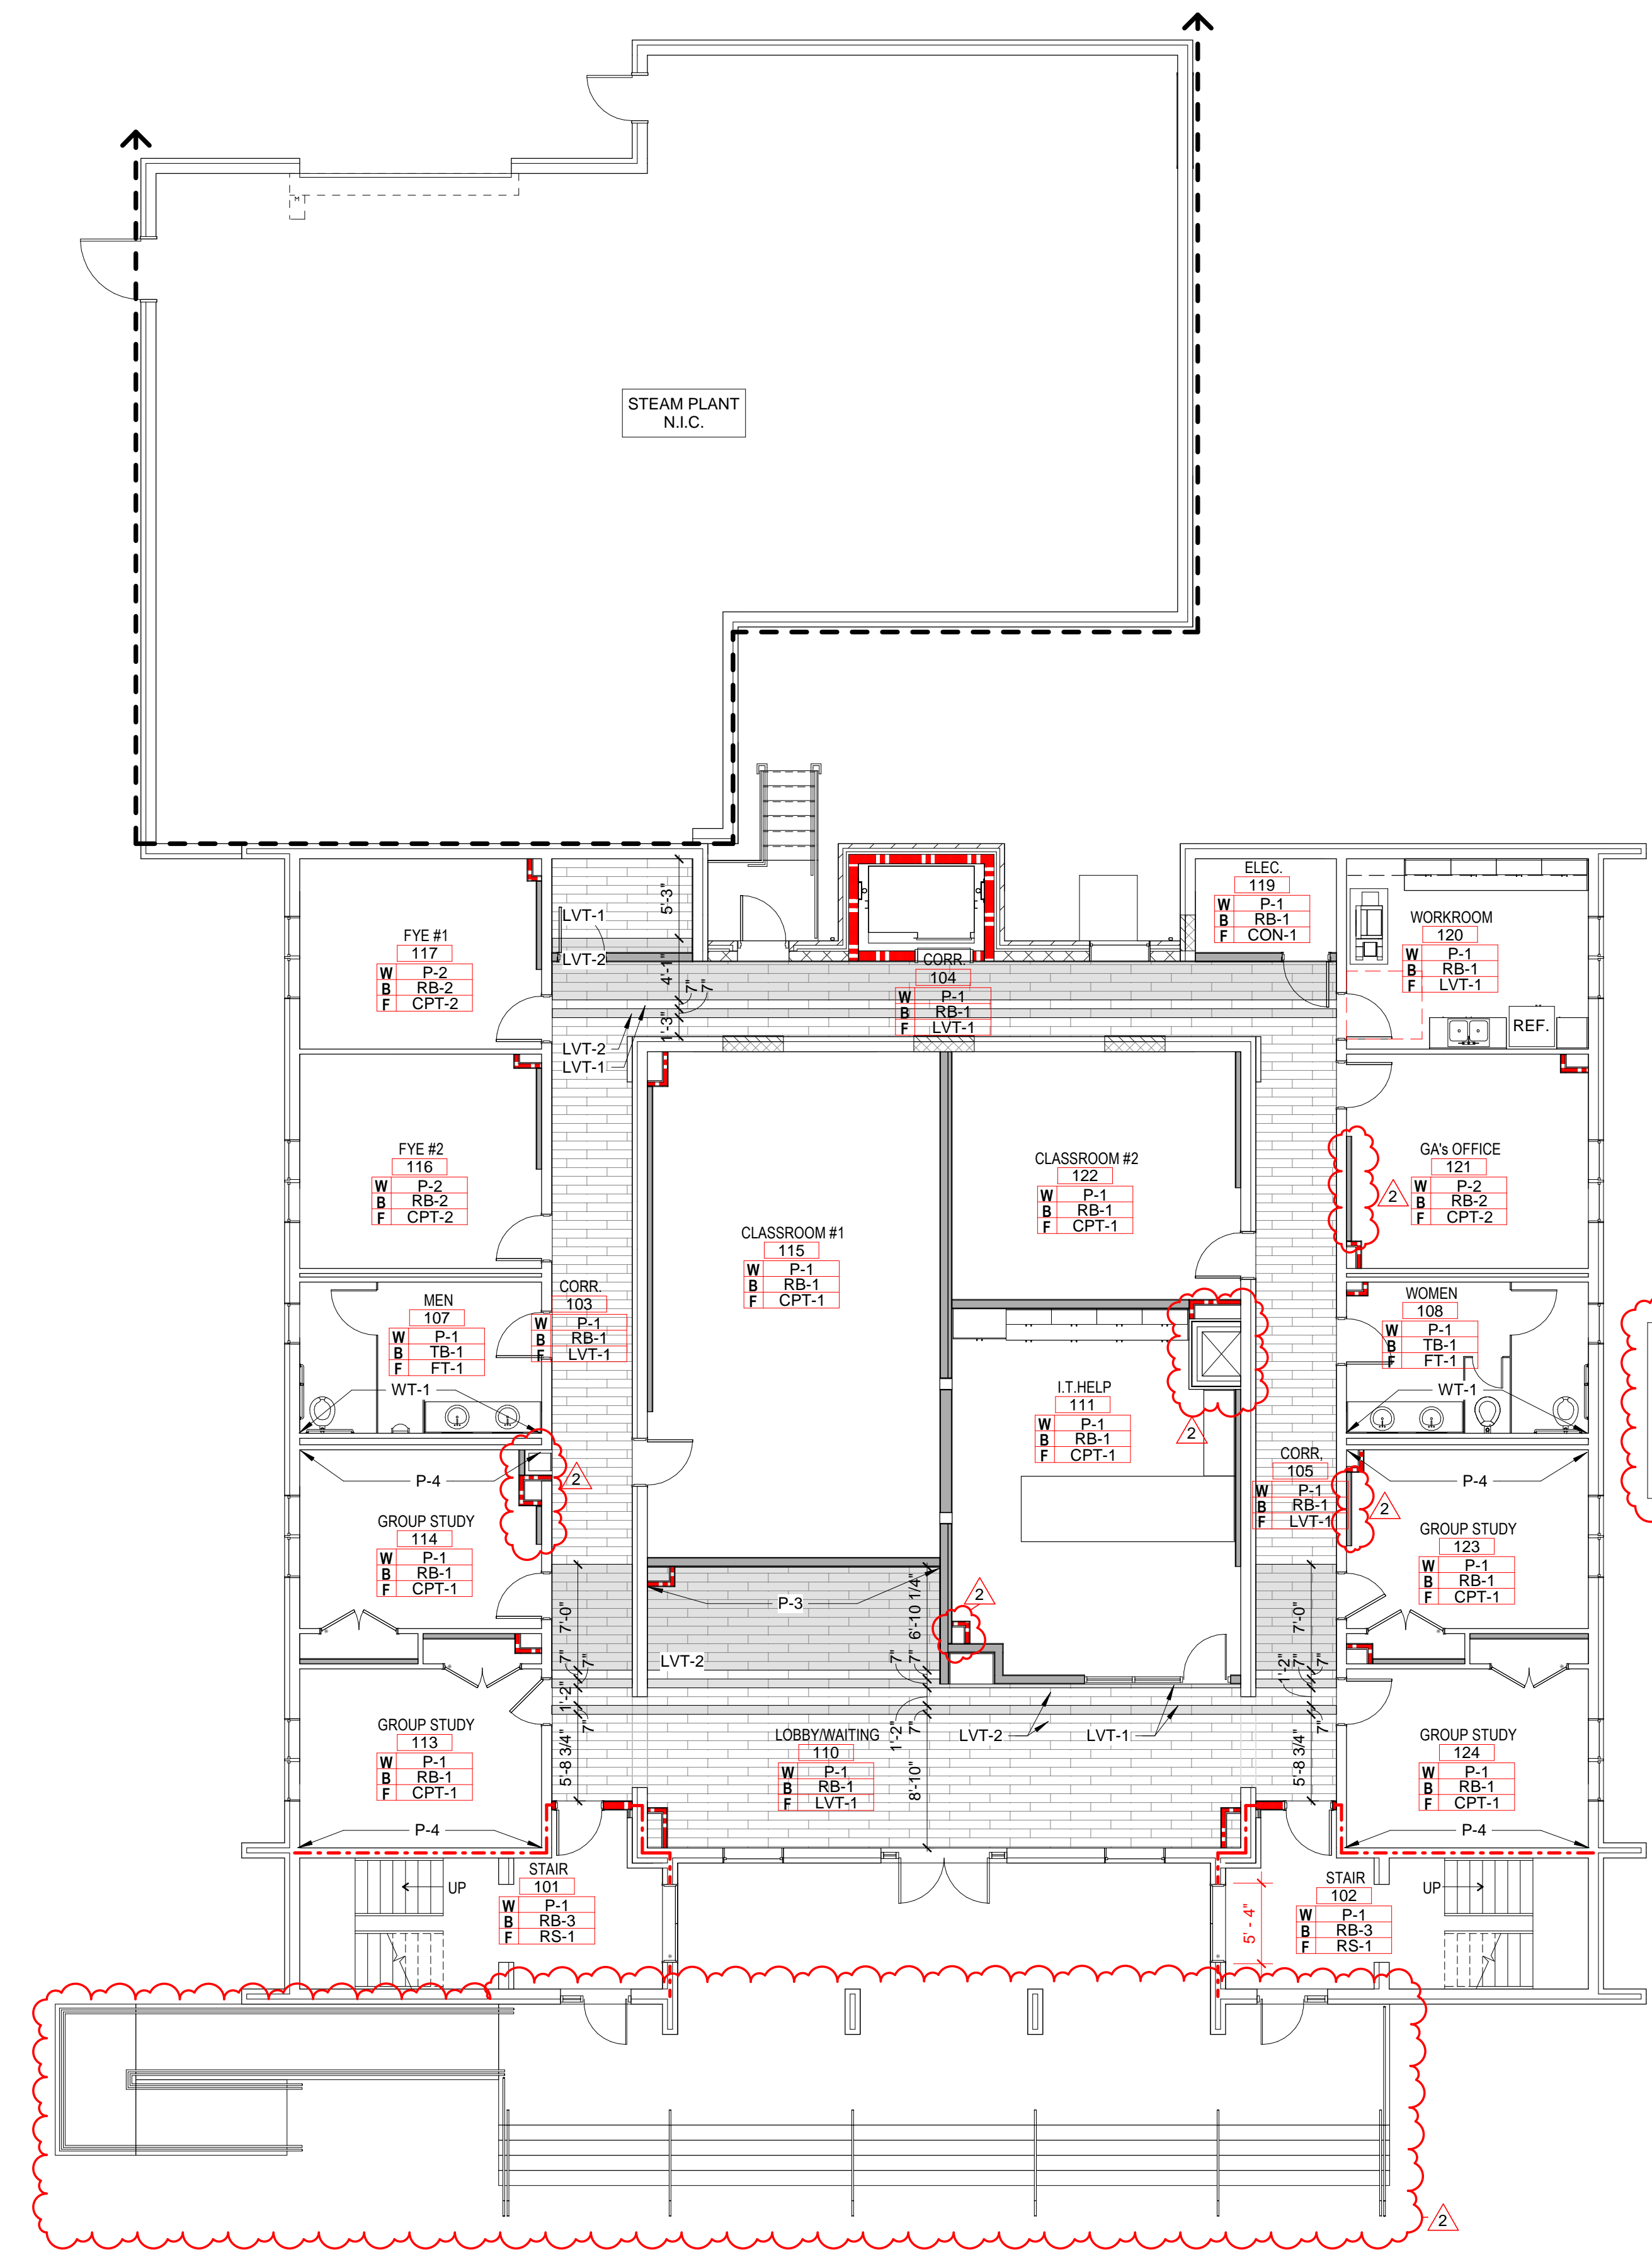

09/11/2018

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PROJECT TEAM  
PRINCIPAL IN CHARGE: ROB KLINEINST, AIA  
PROJECT MANAGER: SHANE WEBSTER, AIA  
DESIGN TEAM: LITTLE  
PROGRAM NAME: CAMPBELL UNIVERSITY DAY HALL RENOVATIONS

PROJECT NO. 513.9660.00

SHEET TITLE FINISH PLAN - LEVEL 1, FINISH SCHEDULE AND DETAILS

SHEET NUMBER A801

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Durham, NC 27701  
T: 919-472-2500


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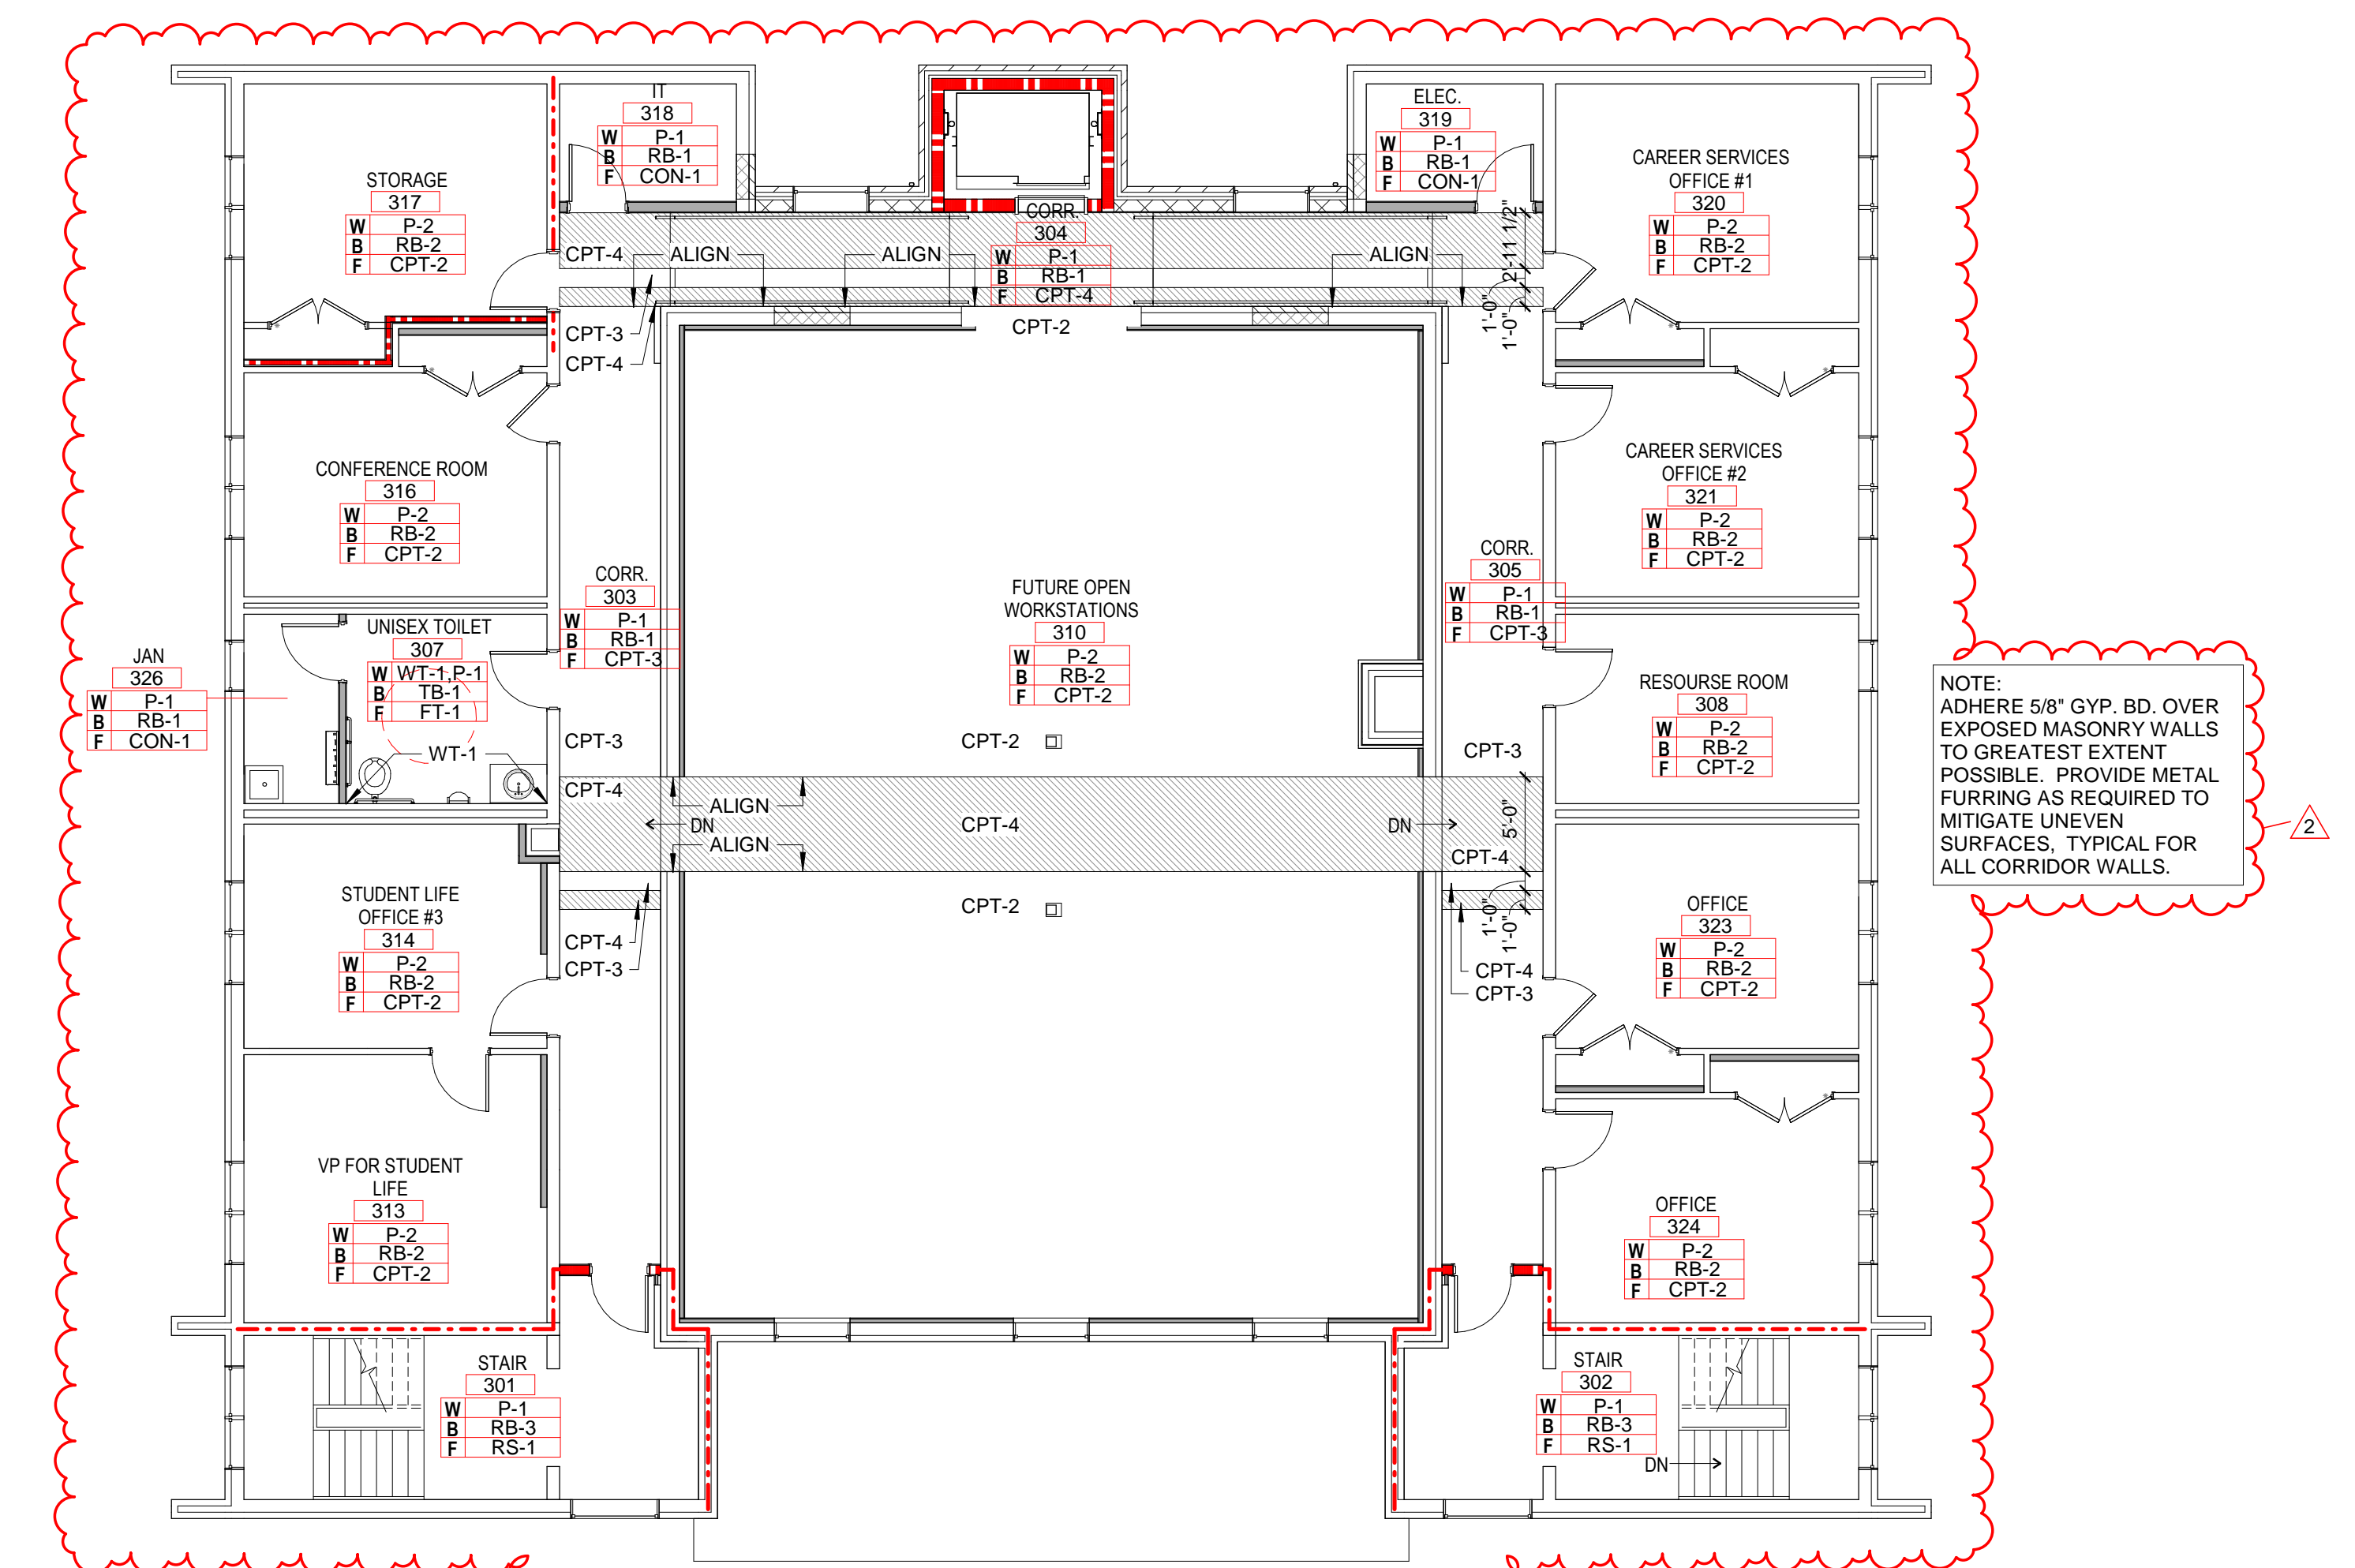
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F  
E  
D  
C  
B  
A



1A Level 2 - Base Bid Finish Plan  
A802 1/8" = 1'-0"



4A Level 3 - Base Bid Finish Plan  
A802 1/8" = 1'-0"

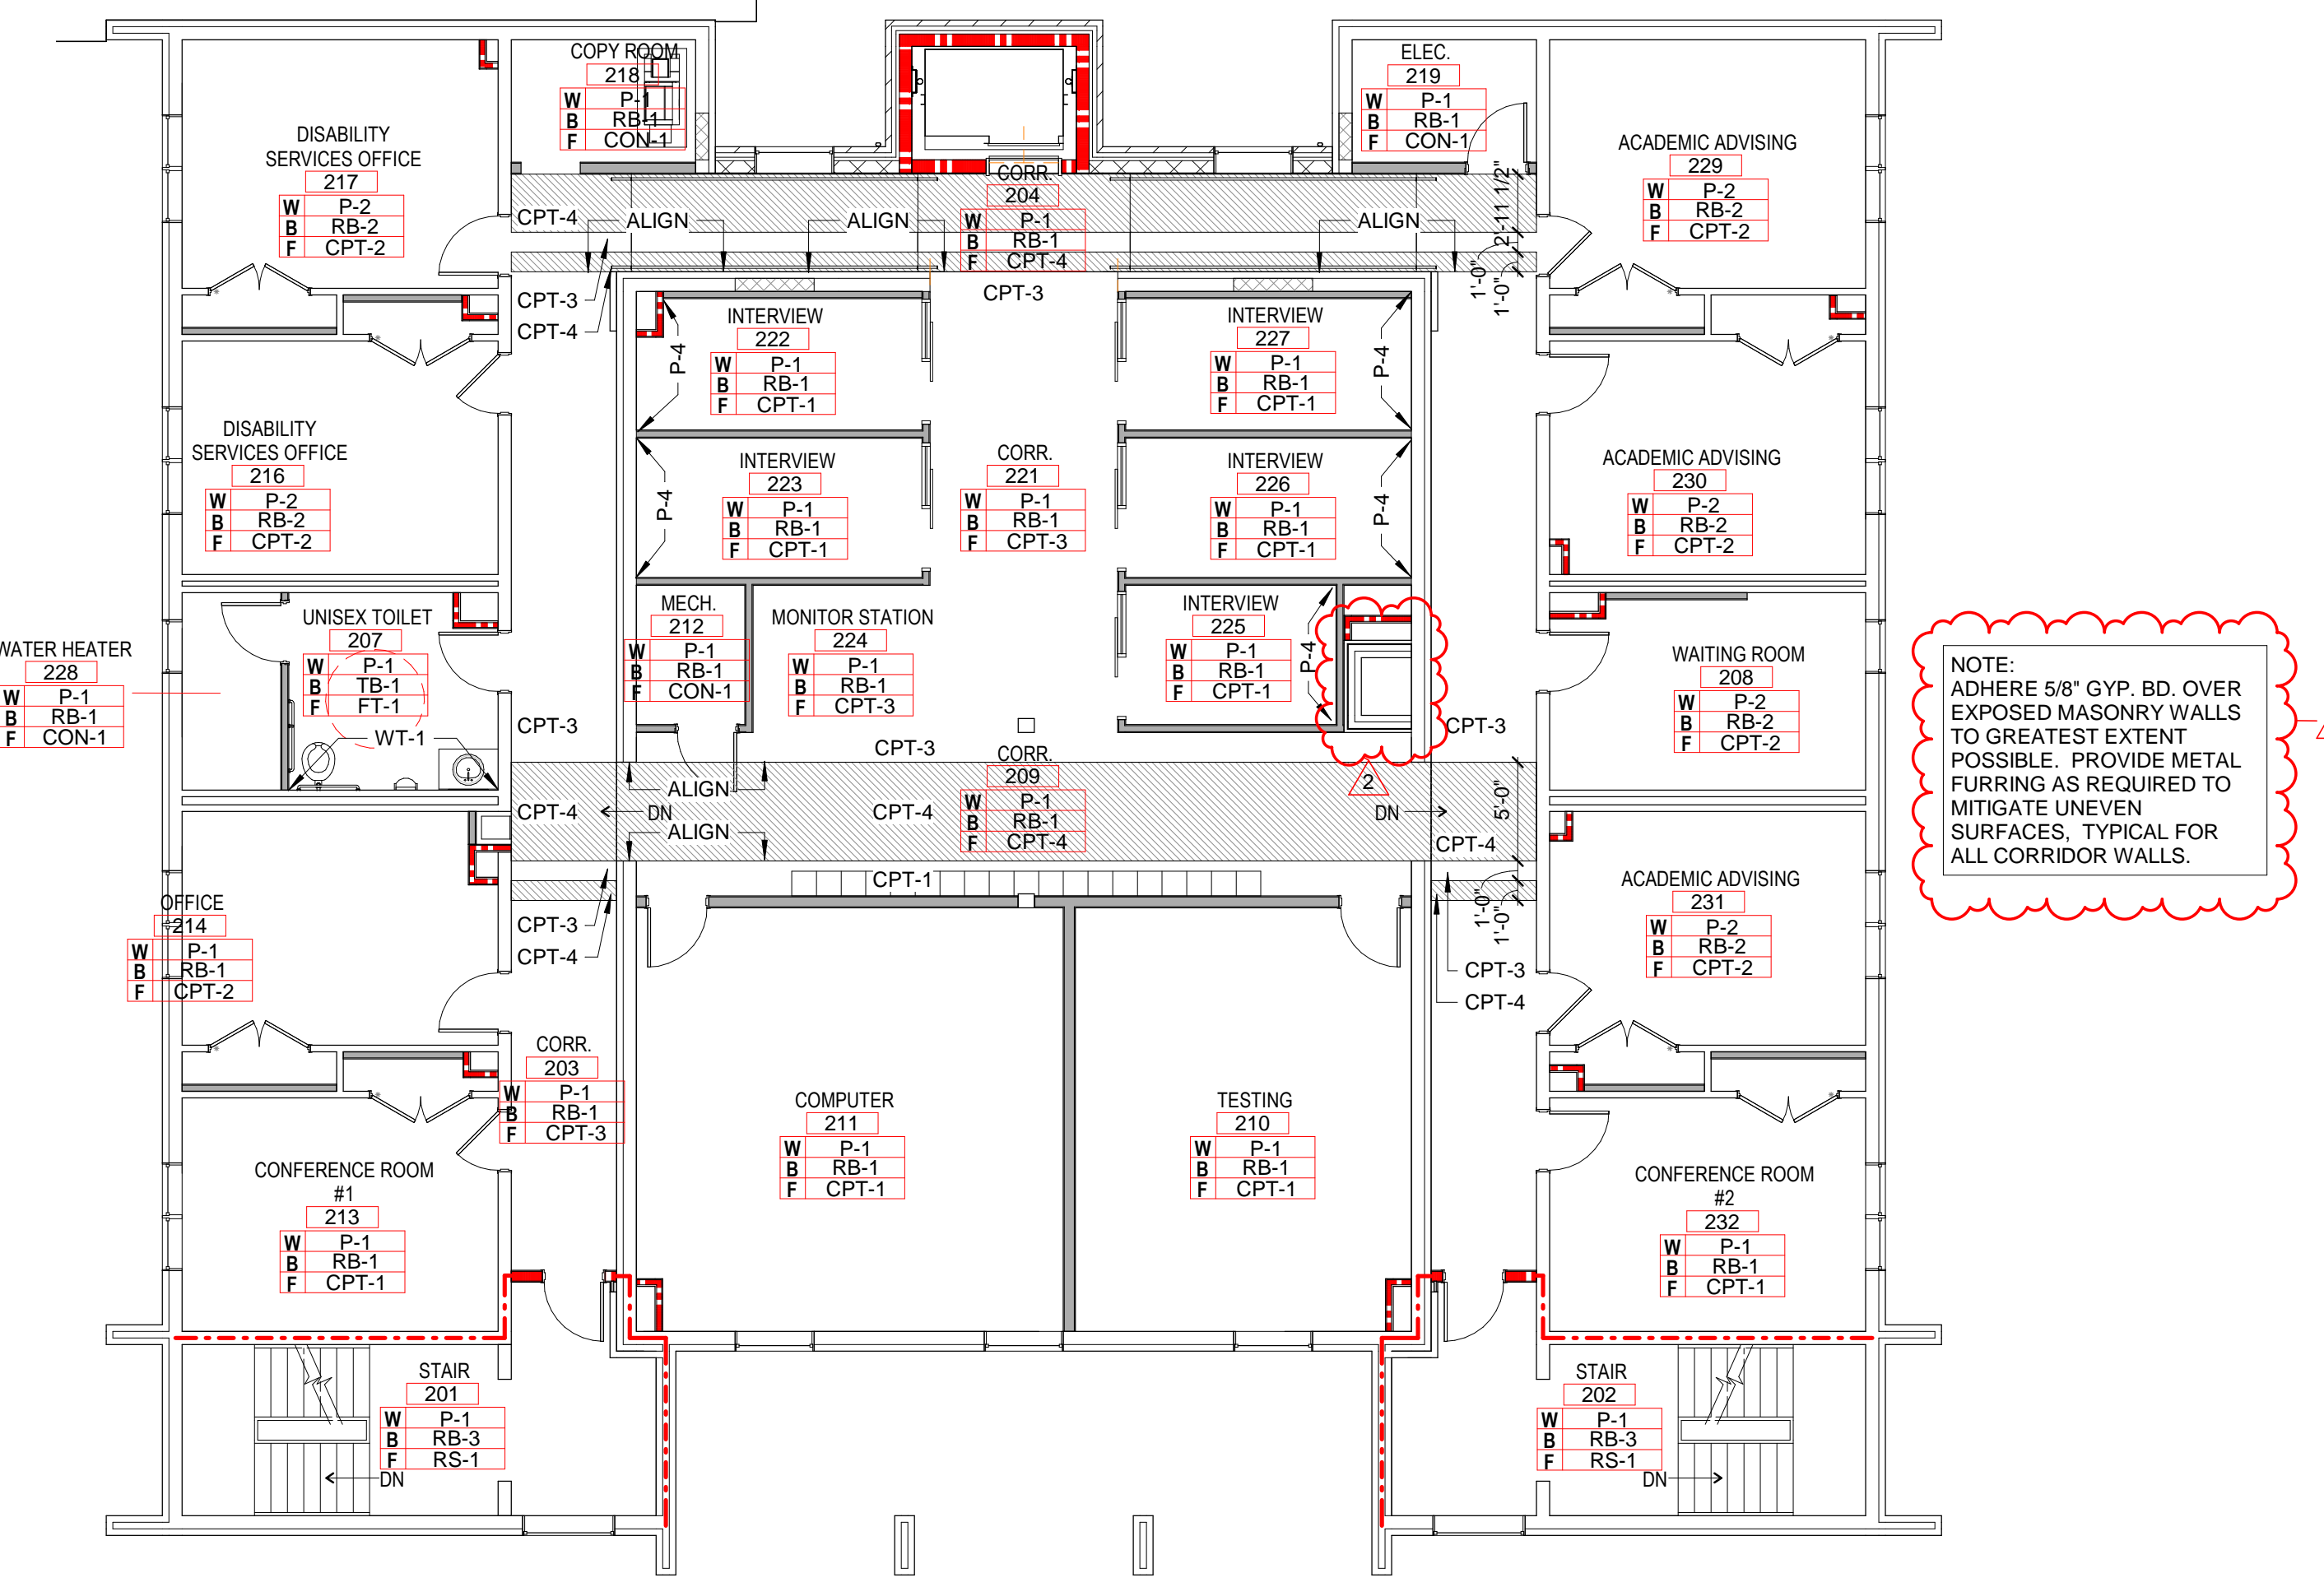NOTES:  
1. BASE BID ON LEVEL 3 INCLUDES NEW ELEVATOR SHAFT AND ROOF, NEW ELEVATOR, NEW EXTERIOR CORRIDOR WALL WITH SALVAGED WINDOWS, NEW CORRIDOR ROOF, NEW CONCRETE RAMP, WORK IN IT AND ELEC. ROOMS.  
2. ALL OTHER WORK ON LEVEL 3 IS TO BE INCLUDED IN FUTURE PHASE 2 UNLESS OTHERWISE NOTED.



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ISSUE DATE 09.11.2018

REVISIONS

NO.	REASON	DATE
1	AV Revisions by Owner and Quality Control	08.20.18
2	Revisions by Owner	09.11.18


PROJECT TEAM  
PRINCIPAL IN CHARGE: ROB KLINEINST, AIA  
PROJECT MANAGER: SHANE WEBSTER, AIA  
DESIGN TEAM: LITTLE  
PROGRAM NAME: CAMPBELL UNIVERSITY DAY HALL RENOVATIONS

PROJECT NO. 513.9660.00

SHEET TITLE FINISH PLANS - LEVELS 2 AND 3

SHEET NUMBER A802

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**1D** INTERIOR ELEVATION - CLASSROOM #1 - 1  
A821 3/8" = 1'-0"

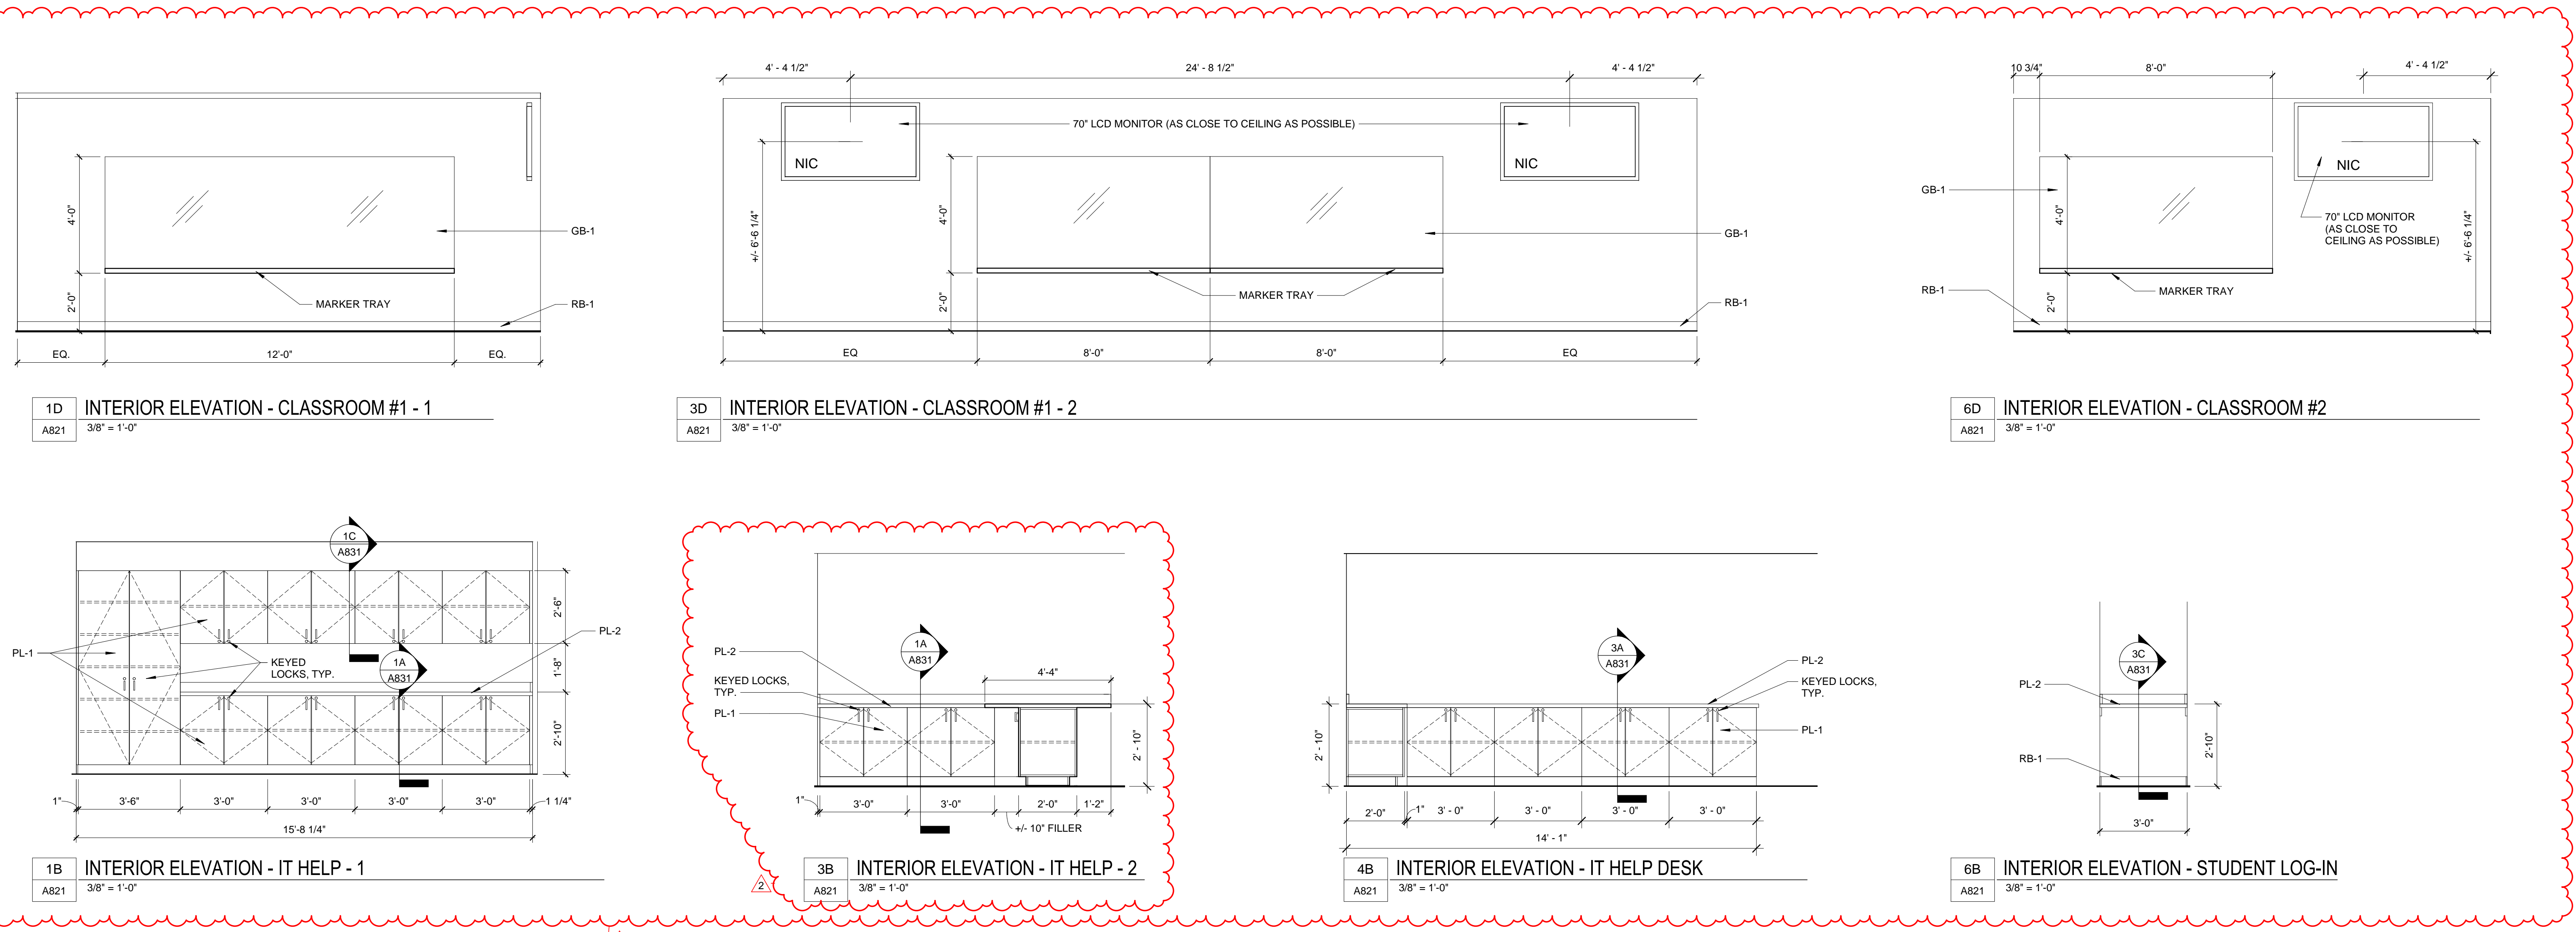**3D** INTERIOR ELEVATION - CLASSROOM #1 - 2  
A821 3/8" = 1'-0"


**6D** INTERIOR ELEVATION - CLASSROOM #2  
A821 3/8" = 1'-0"

**1B** INTERIOR ELEVATION - IT HELP - 1  
A821 3/8" = 1'-0"


**3B** INTERIOR ELEVATION - IT HELP - 2  
A821 3/8" = 1'-0"

**4B** INTERIOR ELEVATION - IT HELP DESK  
A821 3/8" = 1'-0"

**6B** INTERIOR ELEVATION - STUDENT LOG-IN  
A821 3/8" = 1'-0"

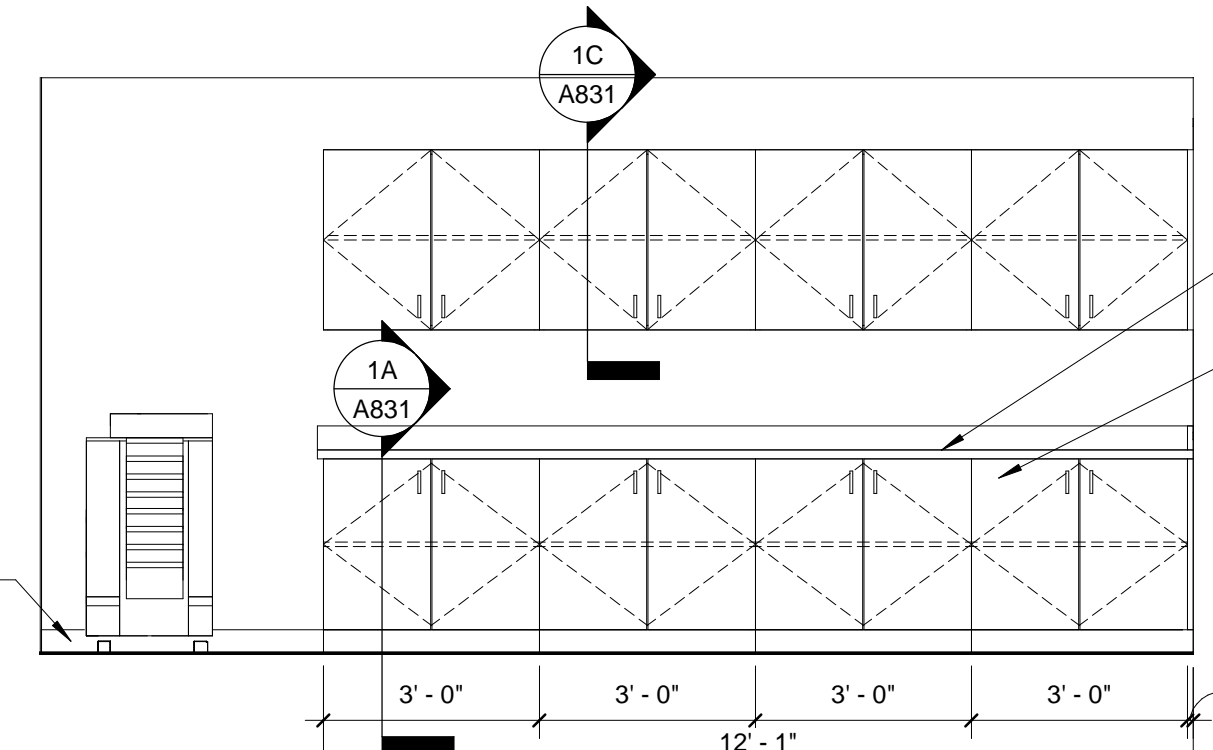

**1A** INTERIOR ELEVATION - WORKROOM 120 N  
A821 3/8" = 1'-0"

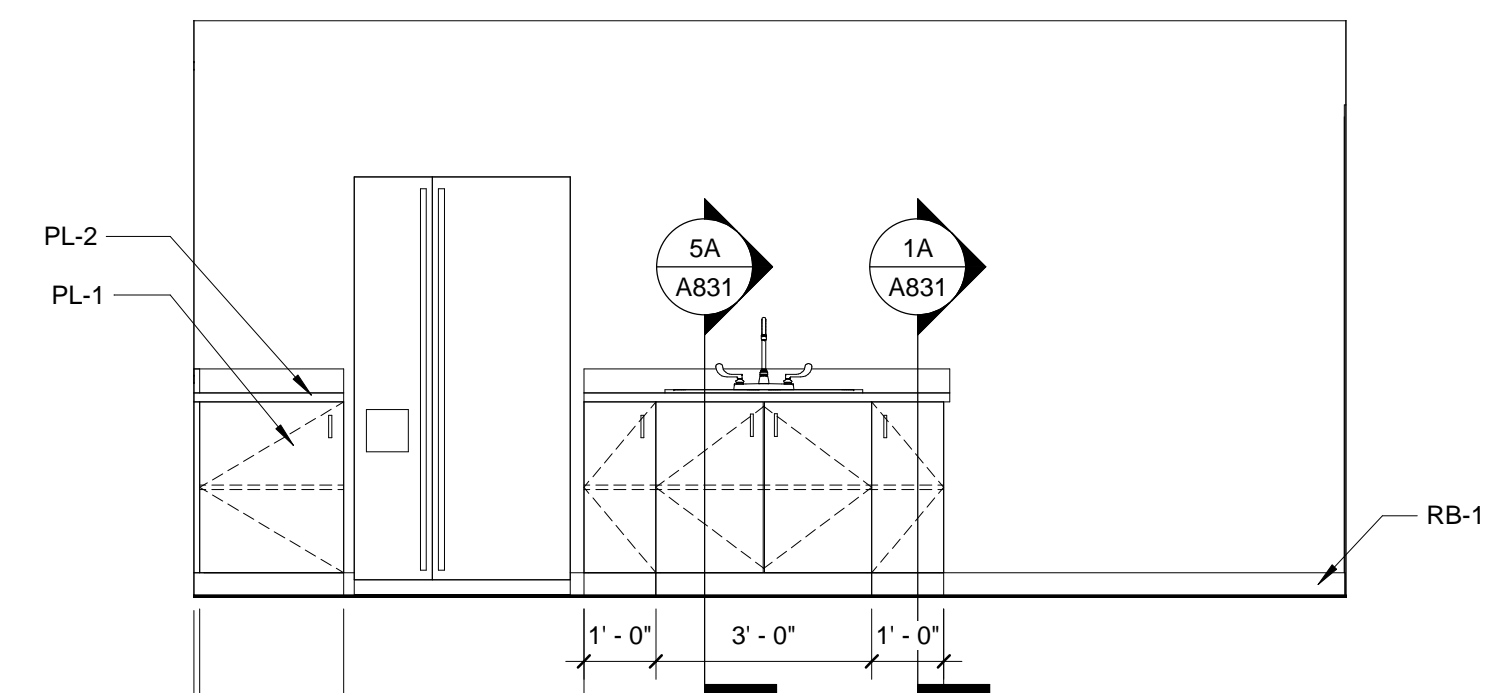

**3A** INTERIOR ELEVATION - WORKROOM 120 S  
A821 3/8" = 1'-0"



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CAMPBELL UNIVERSITY DAY HALL RENOVATIONS

PROJECT NO. 513.9660.00

SHEET TITLE INTERIOR ELEVATIONS


SHEET NUMBER A821

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E


D

C

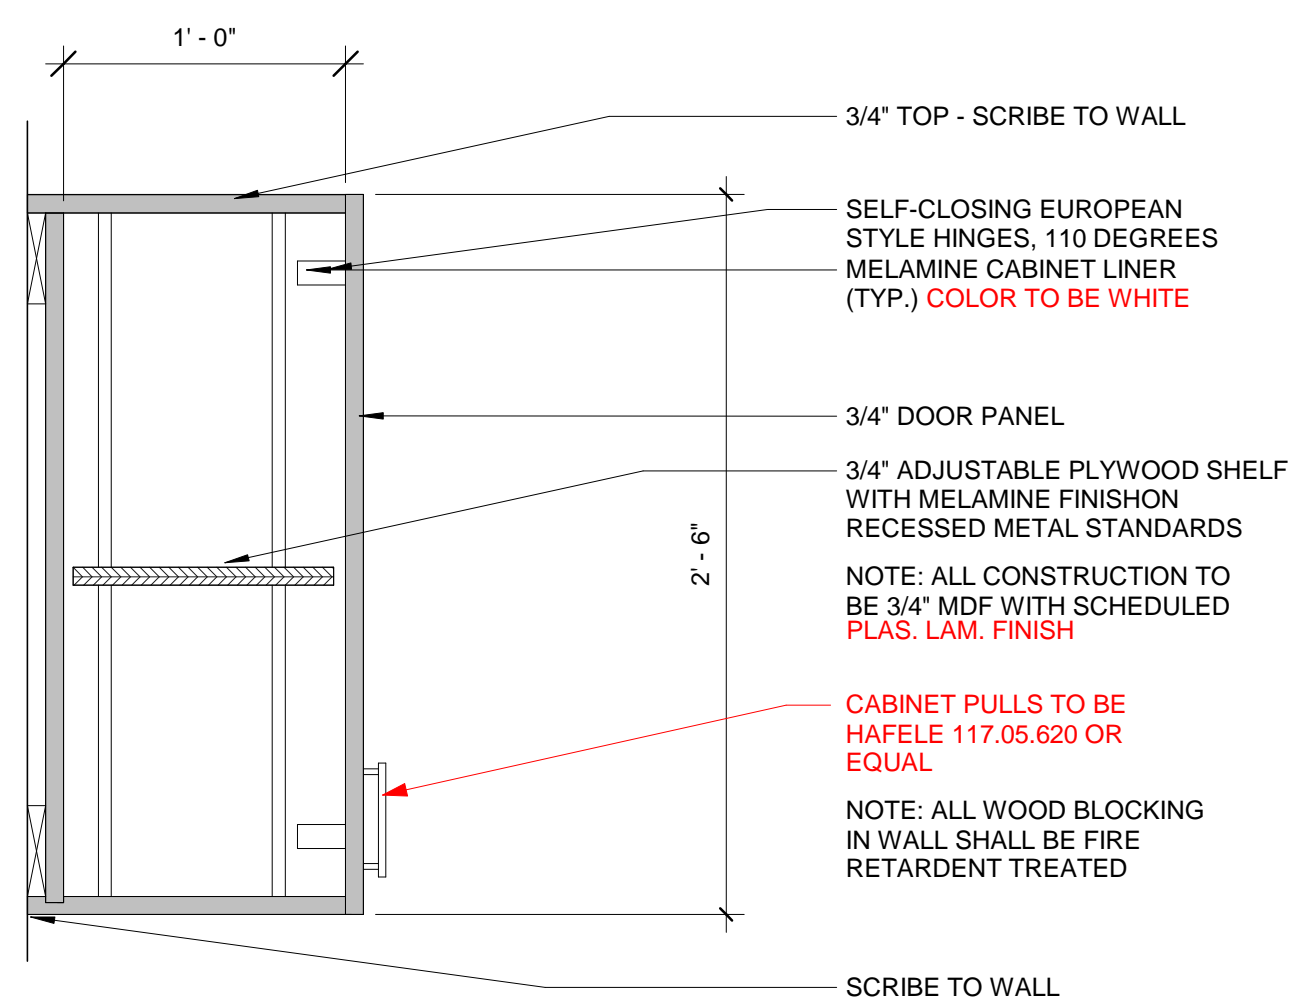

1C CASEWORK - UPPER CABINET - 30" H.


A831 1 1/2" = 1'-0"

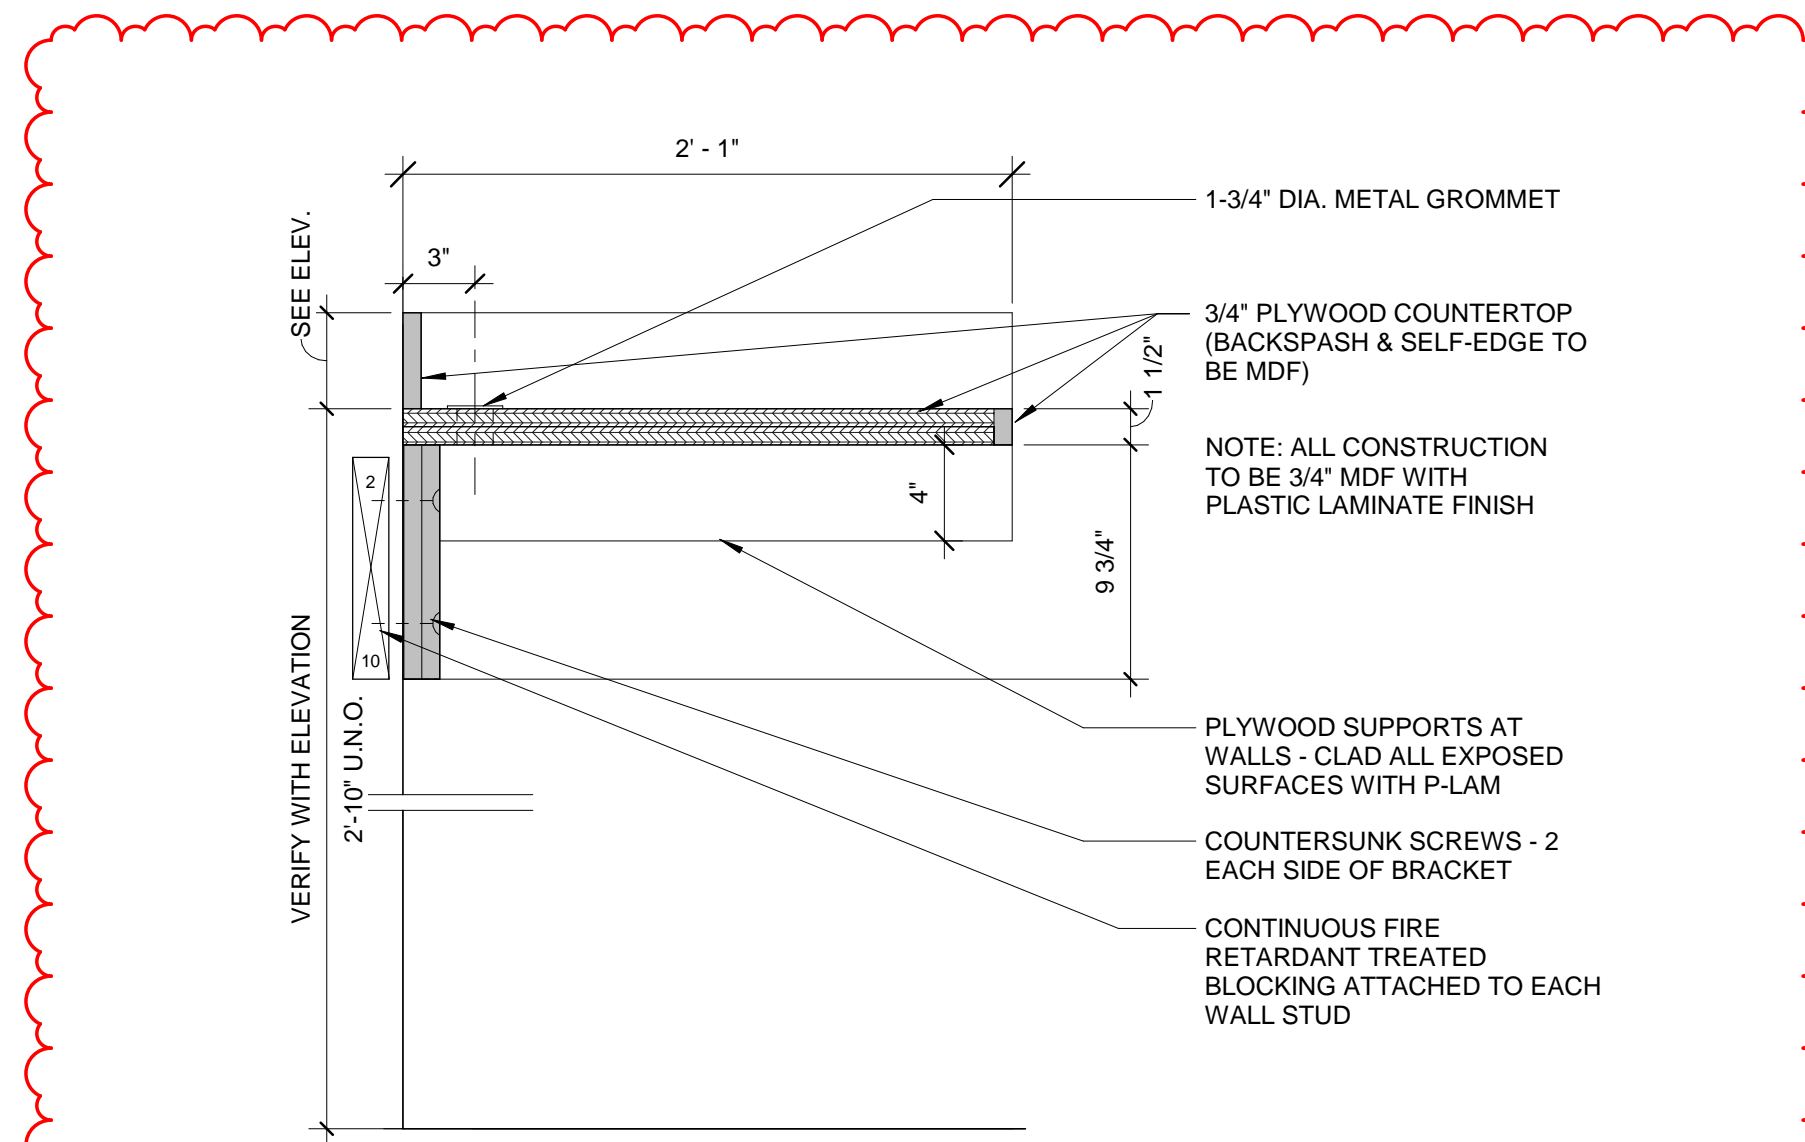

3C CASEWORK - WALL-HUNG P-LAM COUNTER


A831 1 1/2" = 1'-0"

B

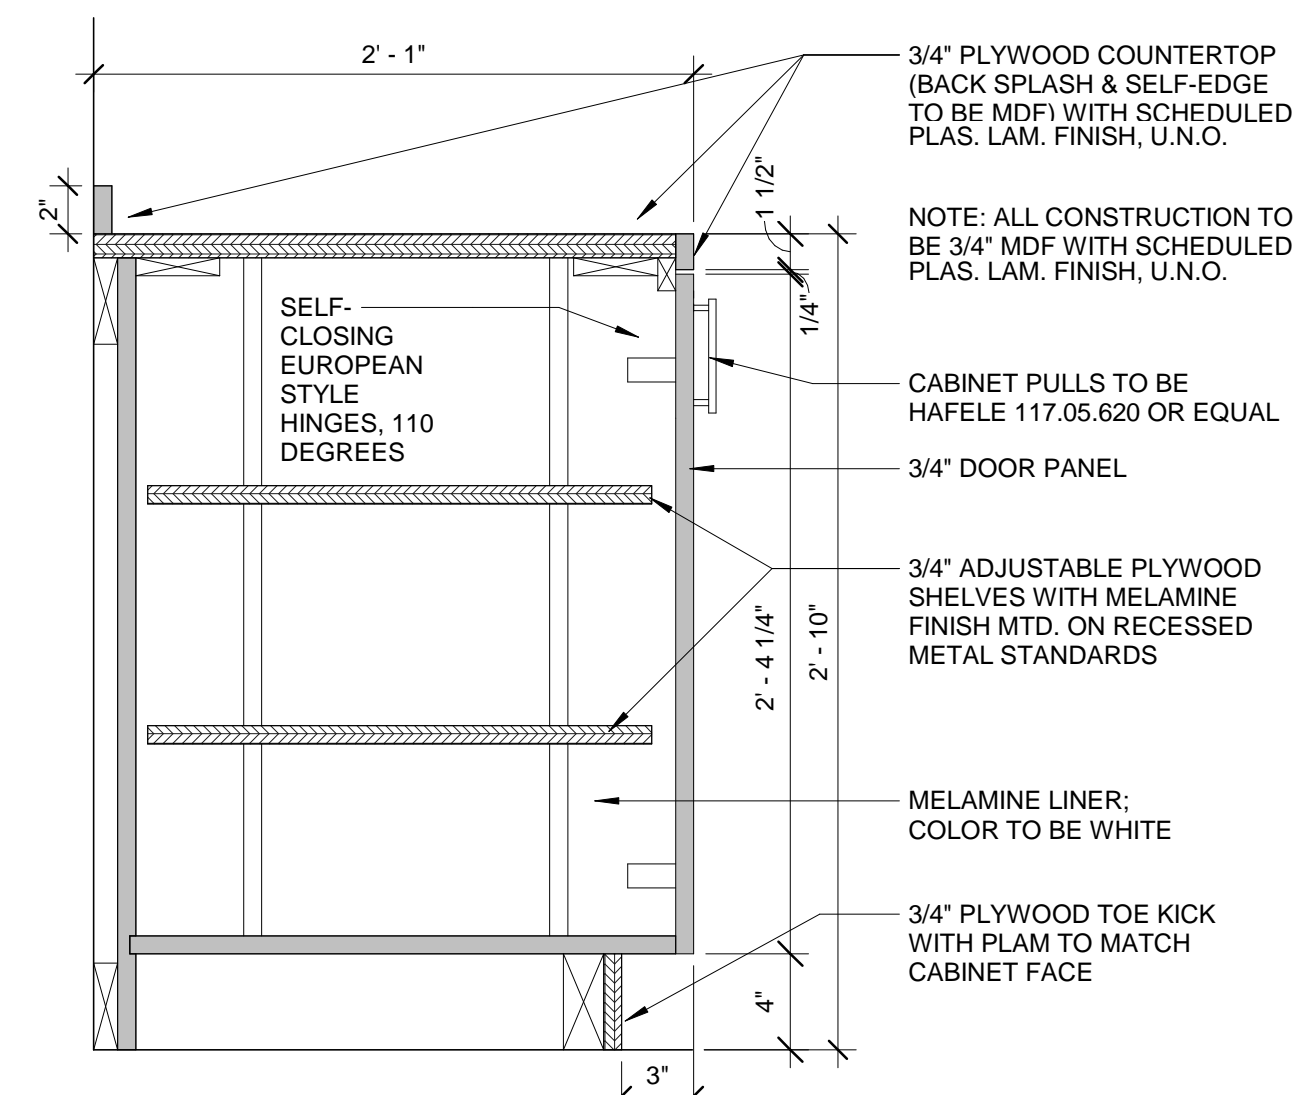


1A CASEWORK - BASE DOOR CABINET

A831 1 1/2" = 1'-0"

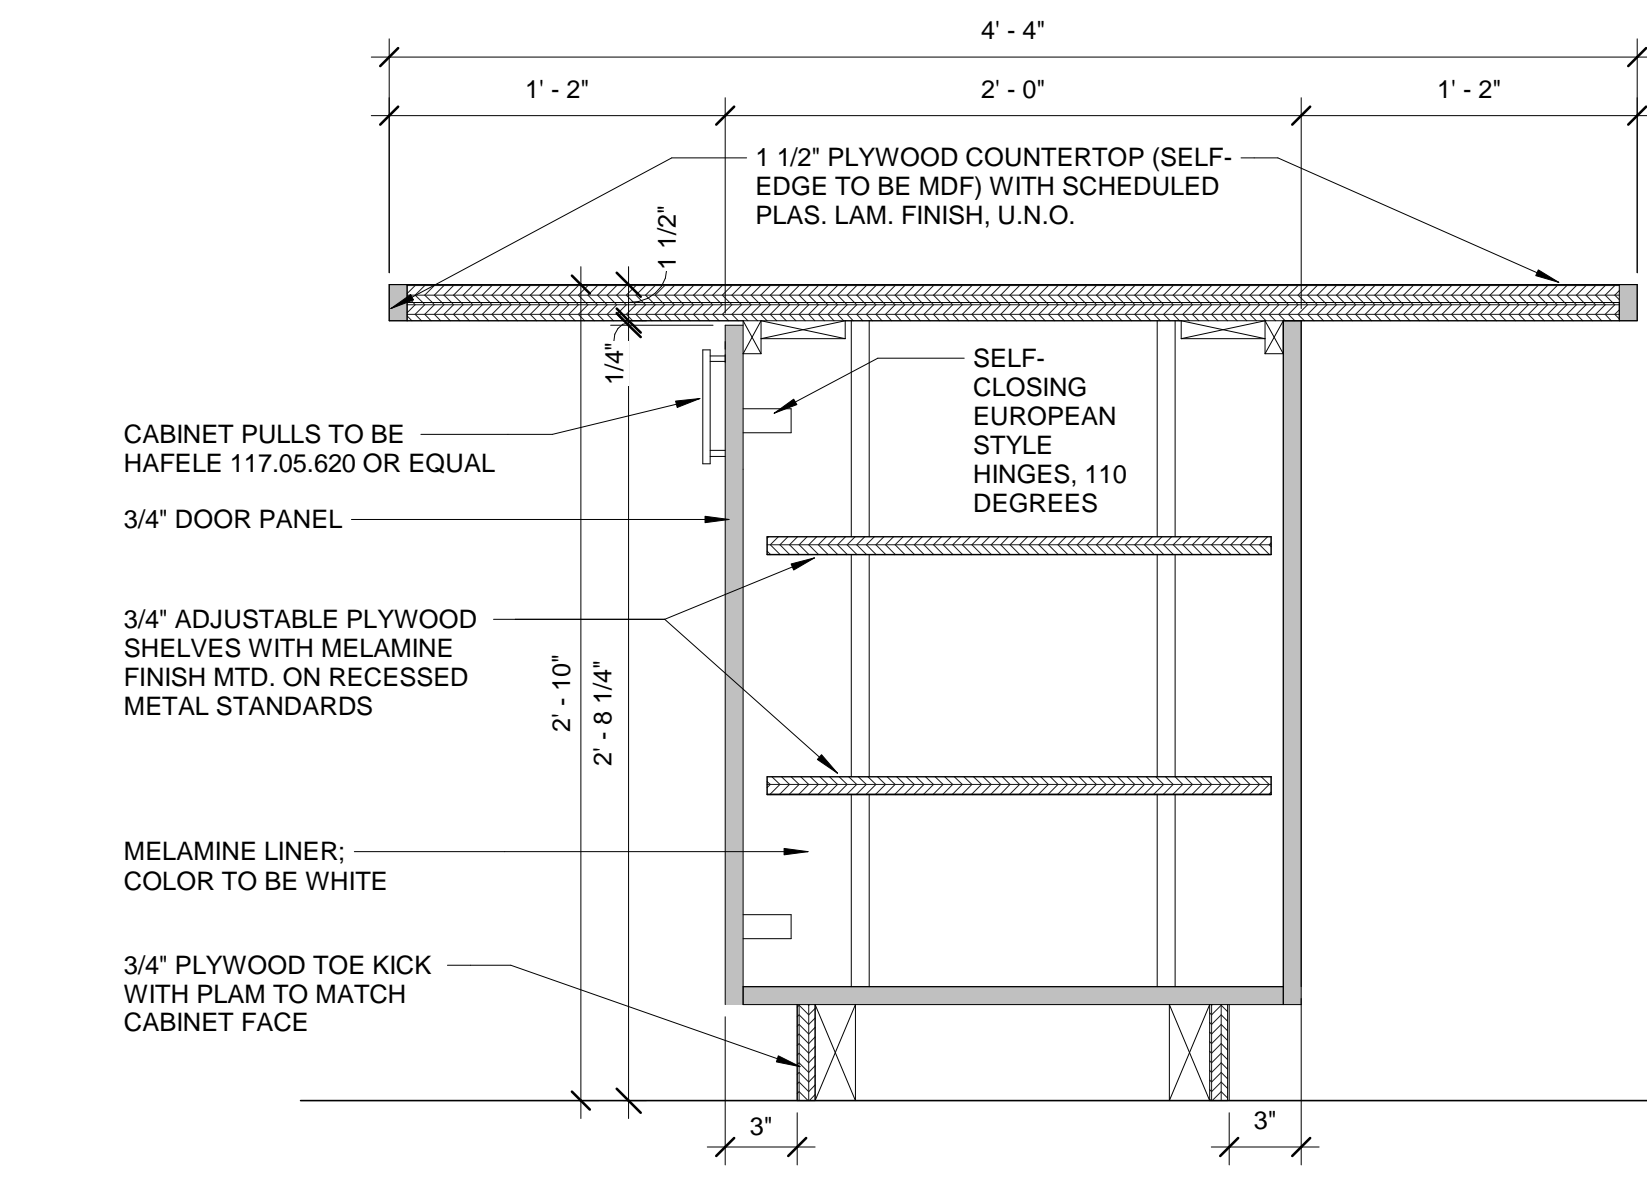


3A CASEWORK - BASE DOOR CABINET - IT HELP DESK

A831 1 1/2" = 1'-0"

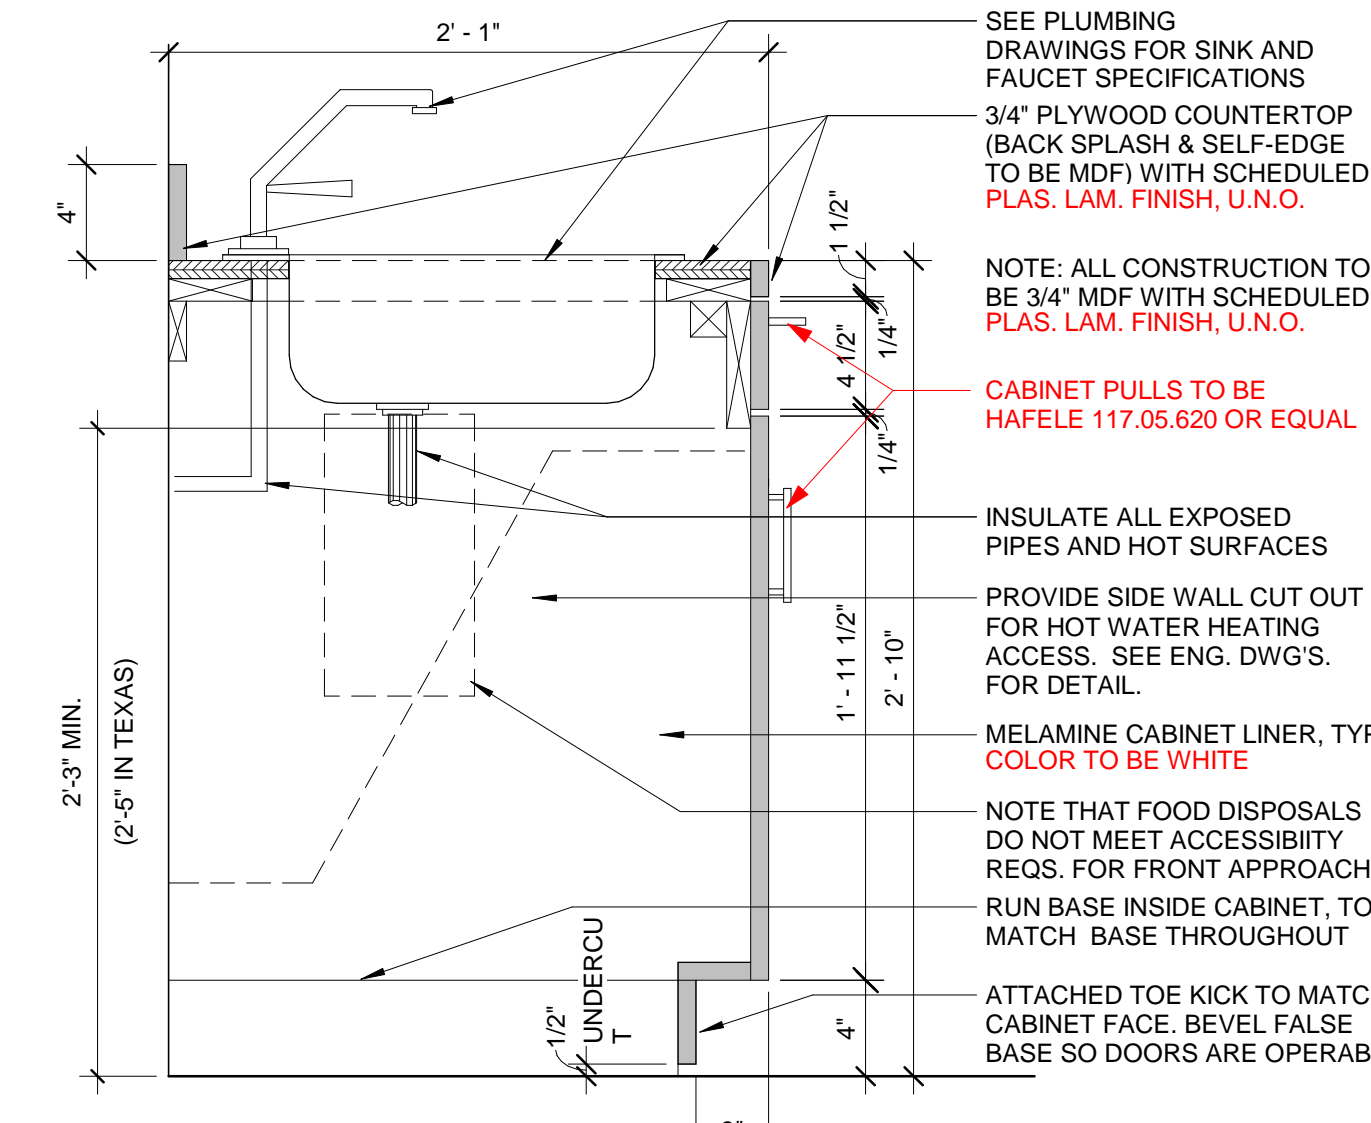

5A CASEWORK - SINK CABT. @ BREAKROOM

A831 1 1/2" = 1'-0"

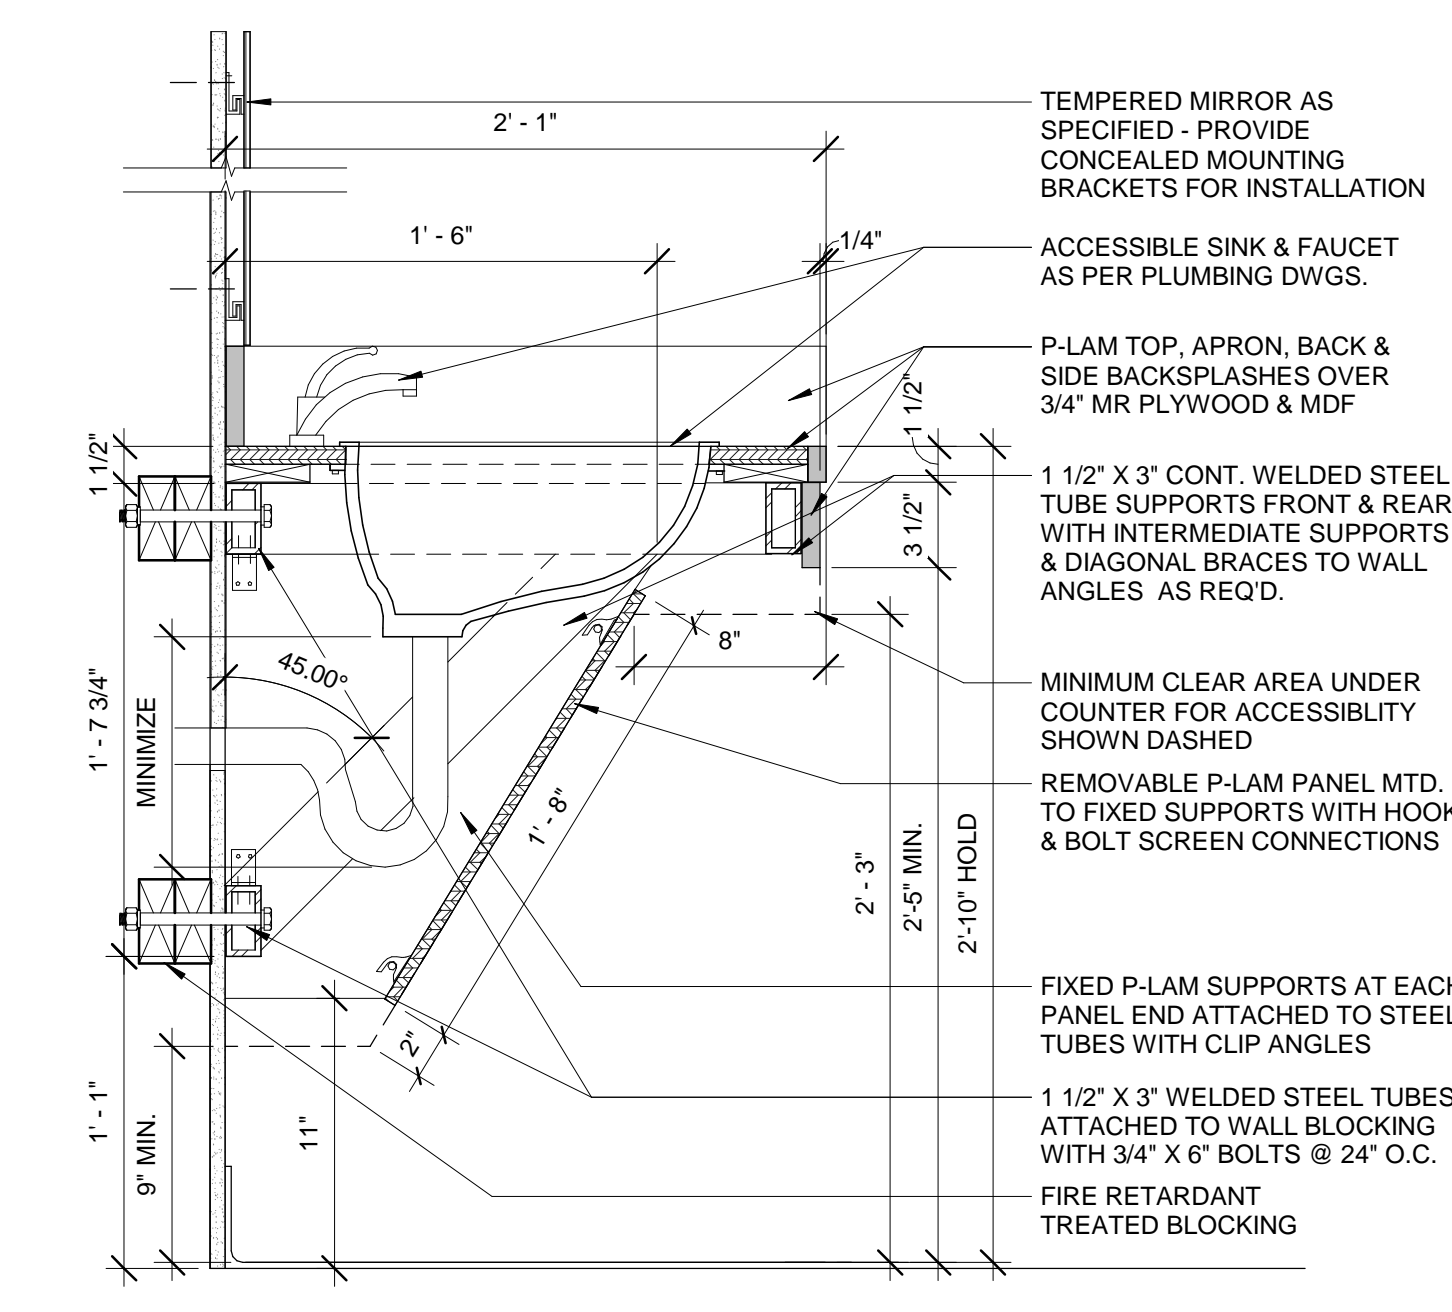

7A WALL HUNG P-LAM LAVATORY COUNTER

A831 1 1/2" = 1'-0"



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PROJECT MANAGER

SHANE WEBSTER, AIA

DESIGN TEAM

LITTLE

PROJECT NAME

CAMPBELL UNIVERSITY

DAY HALL RENOVATIONS

PROJECT NO.

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SHEET TITLE

INTERIOR SECTIONS

SHEET NUMBER

A831


VERIFY ALL DIMENSIONS AND EXISTING CONDITIONS, TYPICAL

**LITTLE**  
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4A Level 1 - Base Bid Furniture  
A851 1/8" = 1'-0"



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DESIGN TEAM  
LITTLE  
PROJECT NAME

CAMPBELL UNIVERSITY  
DAY HALL RENOVATIONS

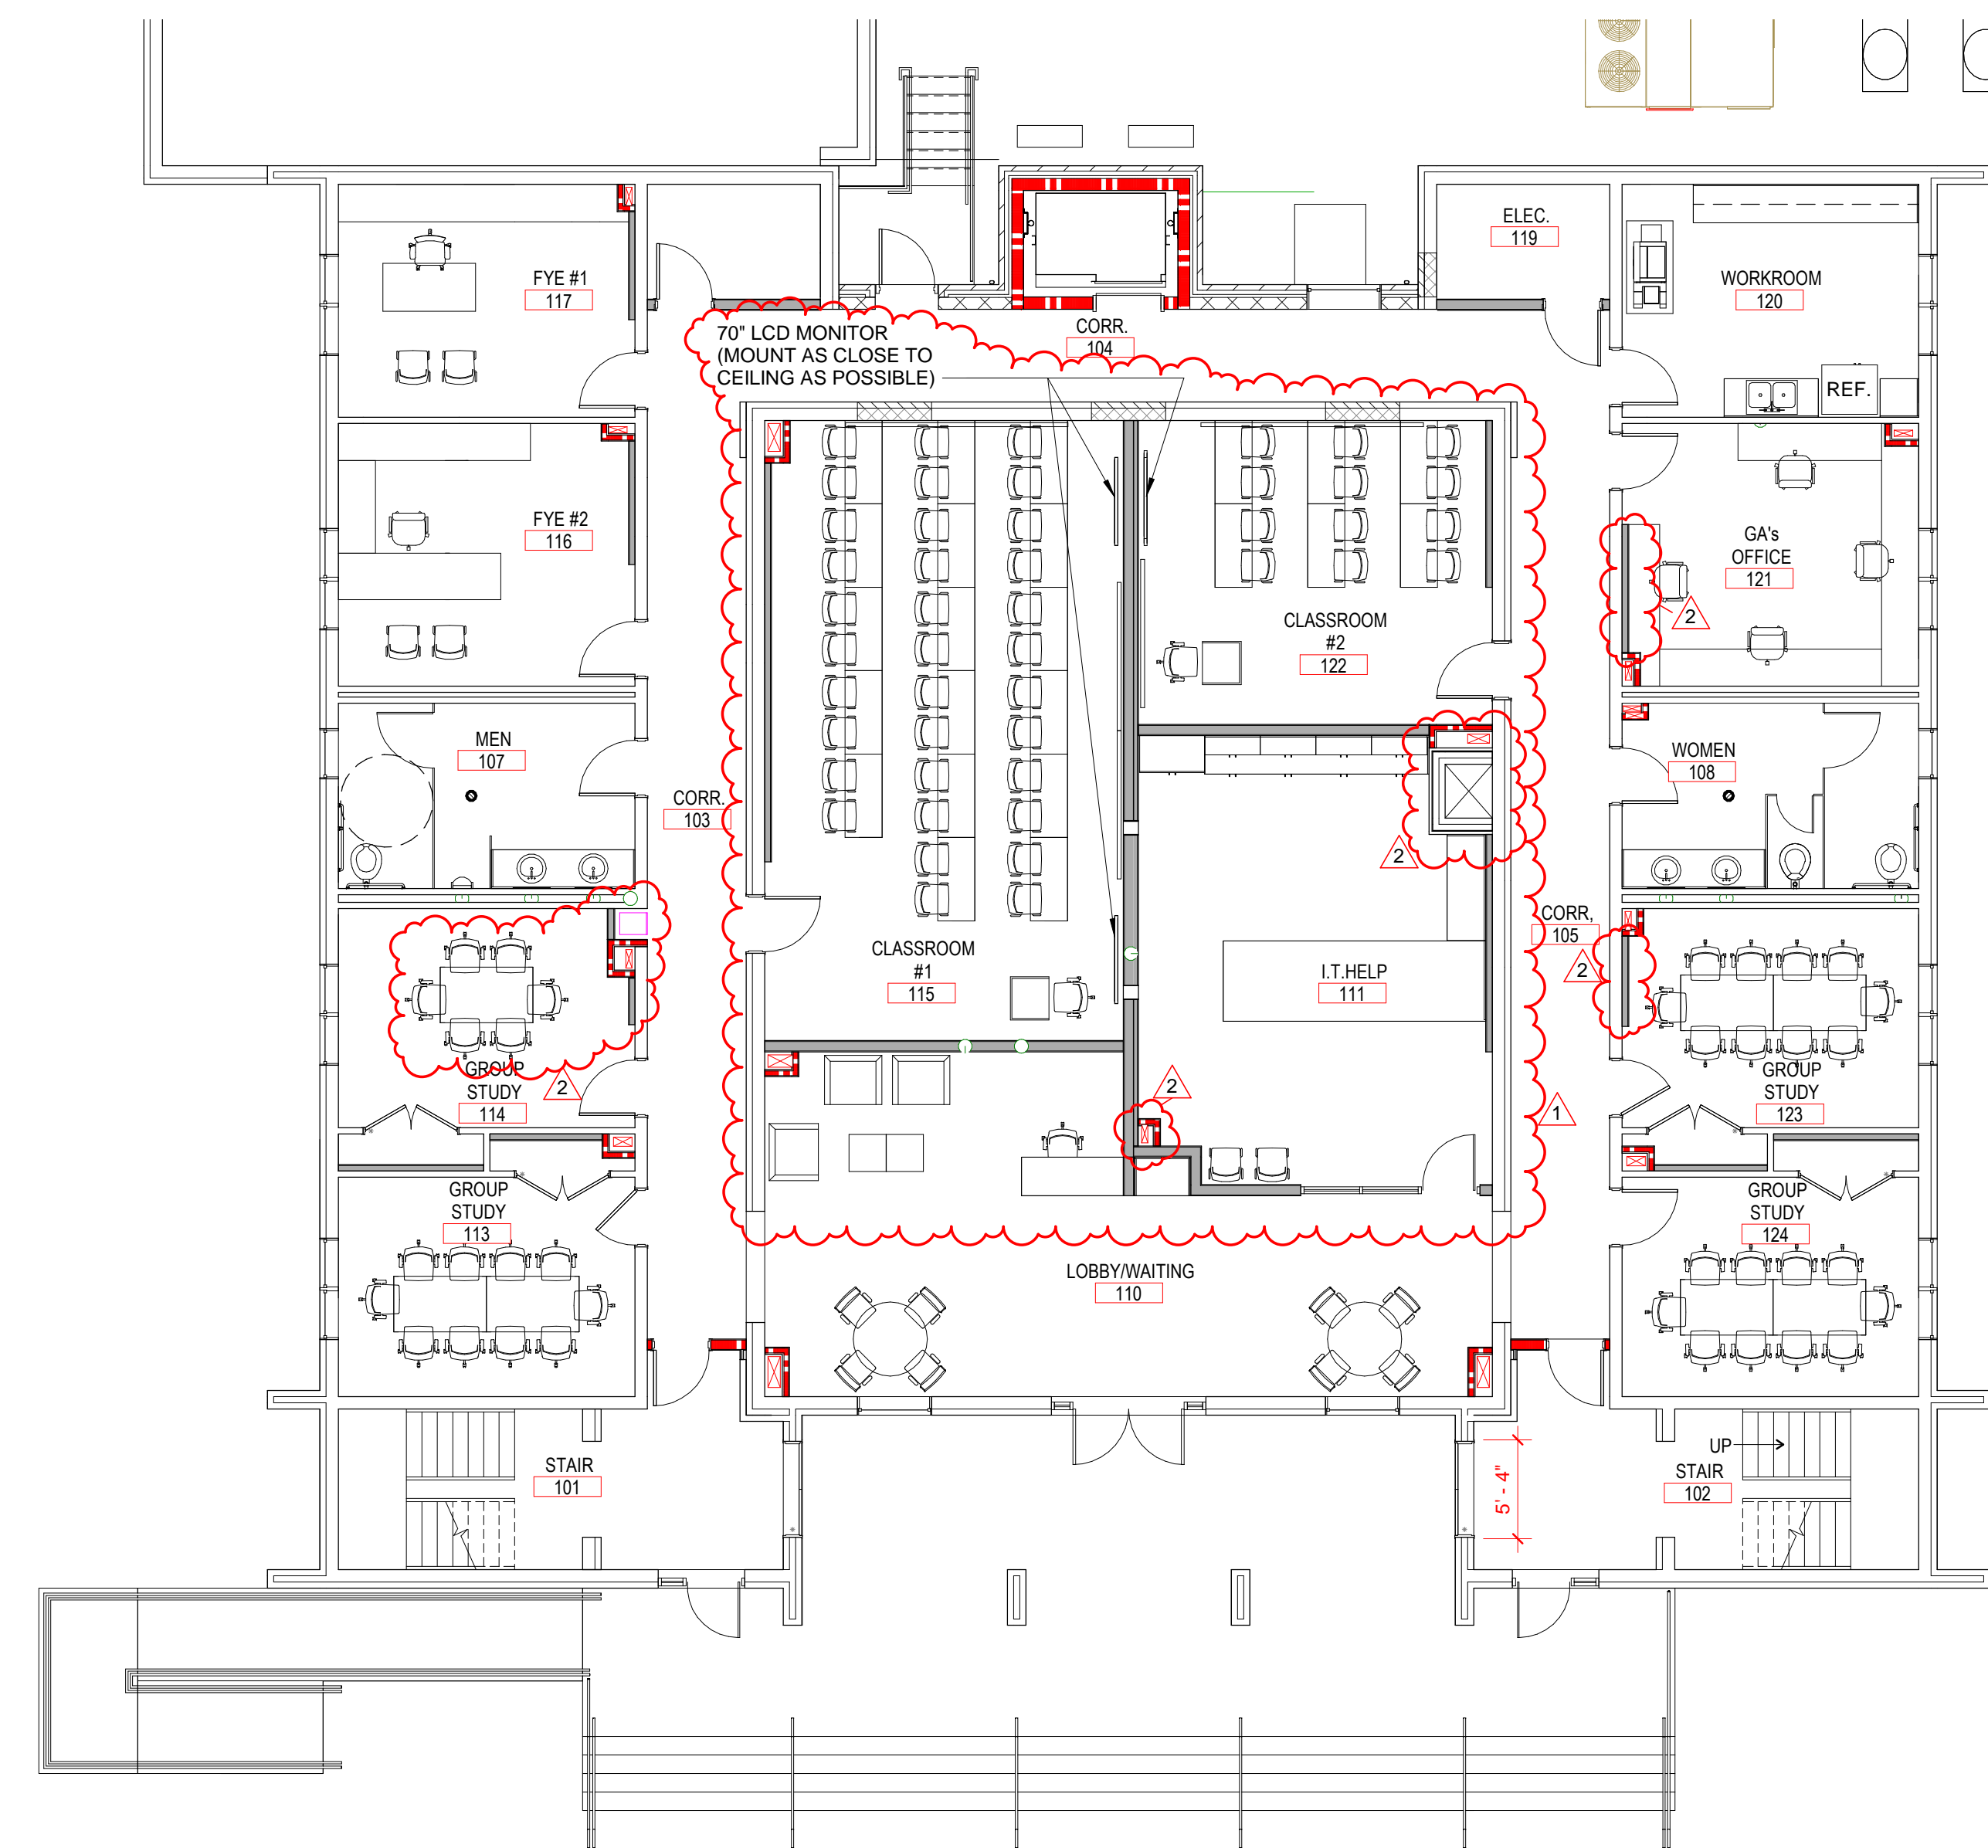PROJECT NO.  
513.9660.00

SHEET TITLE  
FURNITURE PLANS -  
BASE BID - LEVEL 1

SHEET NUMBER  
A851



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NOTES:  
1. BASE BID ON LEVEL 3 INCLUDES NEW ELEVATOR SHAFT AND ROOF, NEW ELEVATOR, NEW EXTERIOR CORRIDOR WALL WITH SALVAGED WINDOWS, NEW CORRIDOR ROOF, NEW CONCRETE RAMP, WORK IN IT AND ELEC. ROOMS.  
2. ALL OTHER WORK ON LEVEL 3 IS TO BE INCLUDED IN FUTURE PHASE 2 UNLESS OTHERWISE NOTED.

1A Level 2 - Base Bid Furniture  
A852 1/8" = 1'-0"

4A Level 3 - Base Bid Furniture  
A852 1/8" = 1'-0"



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PROJECT NAME:

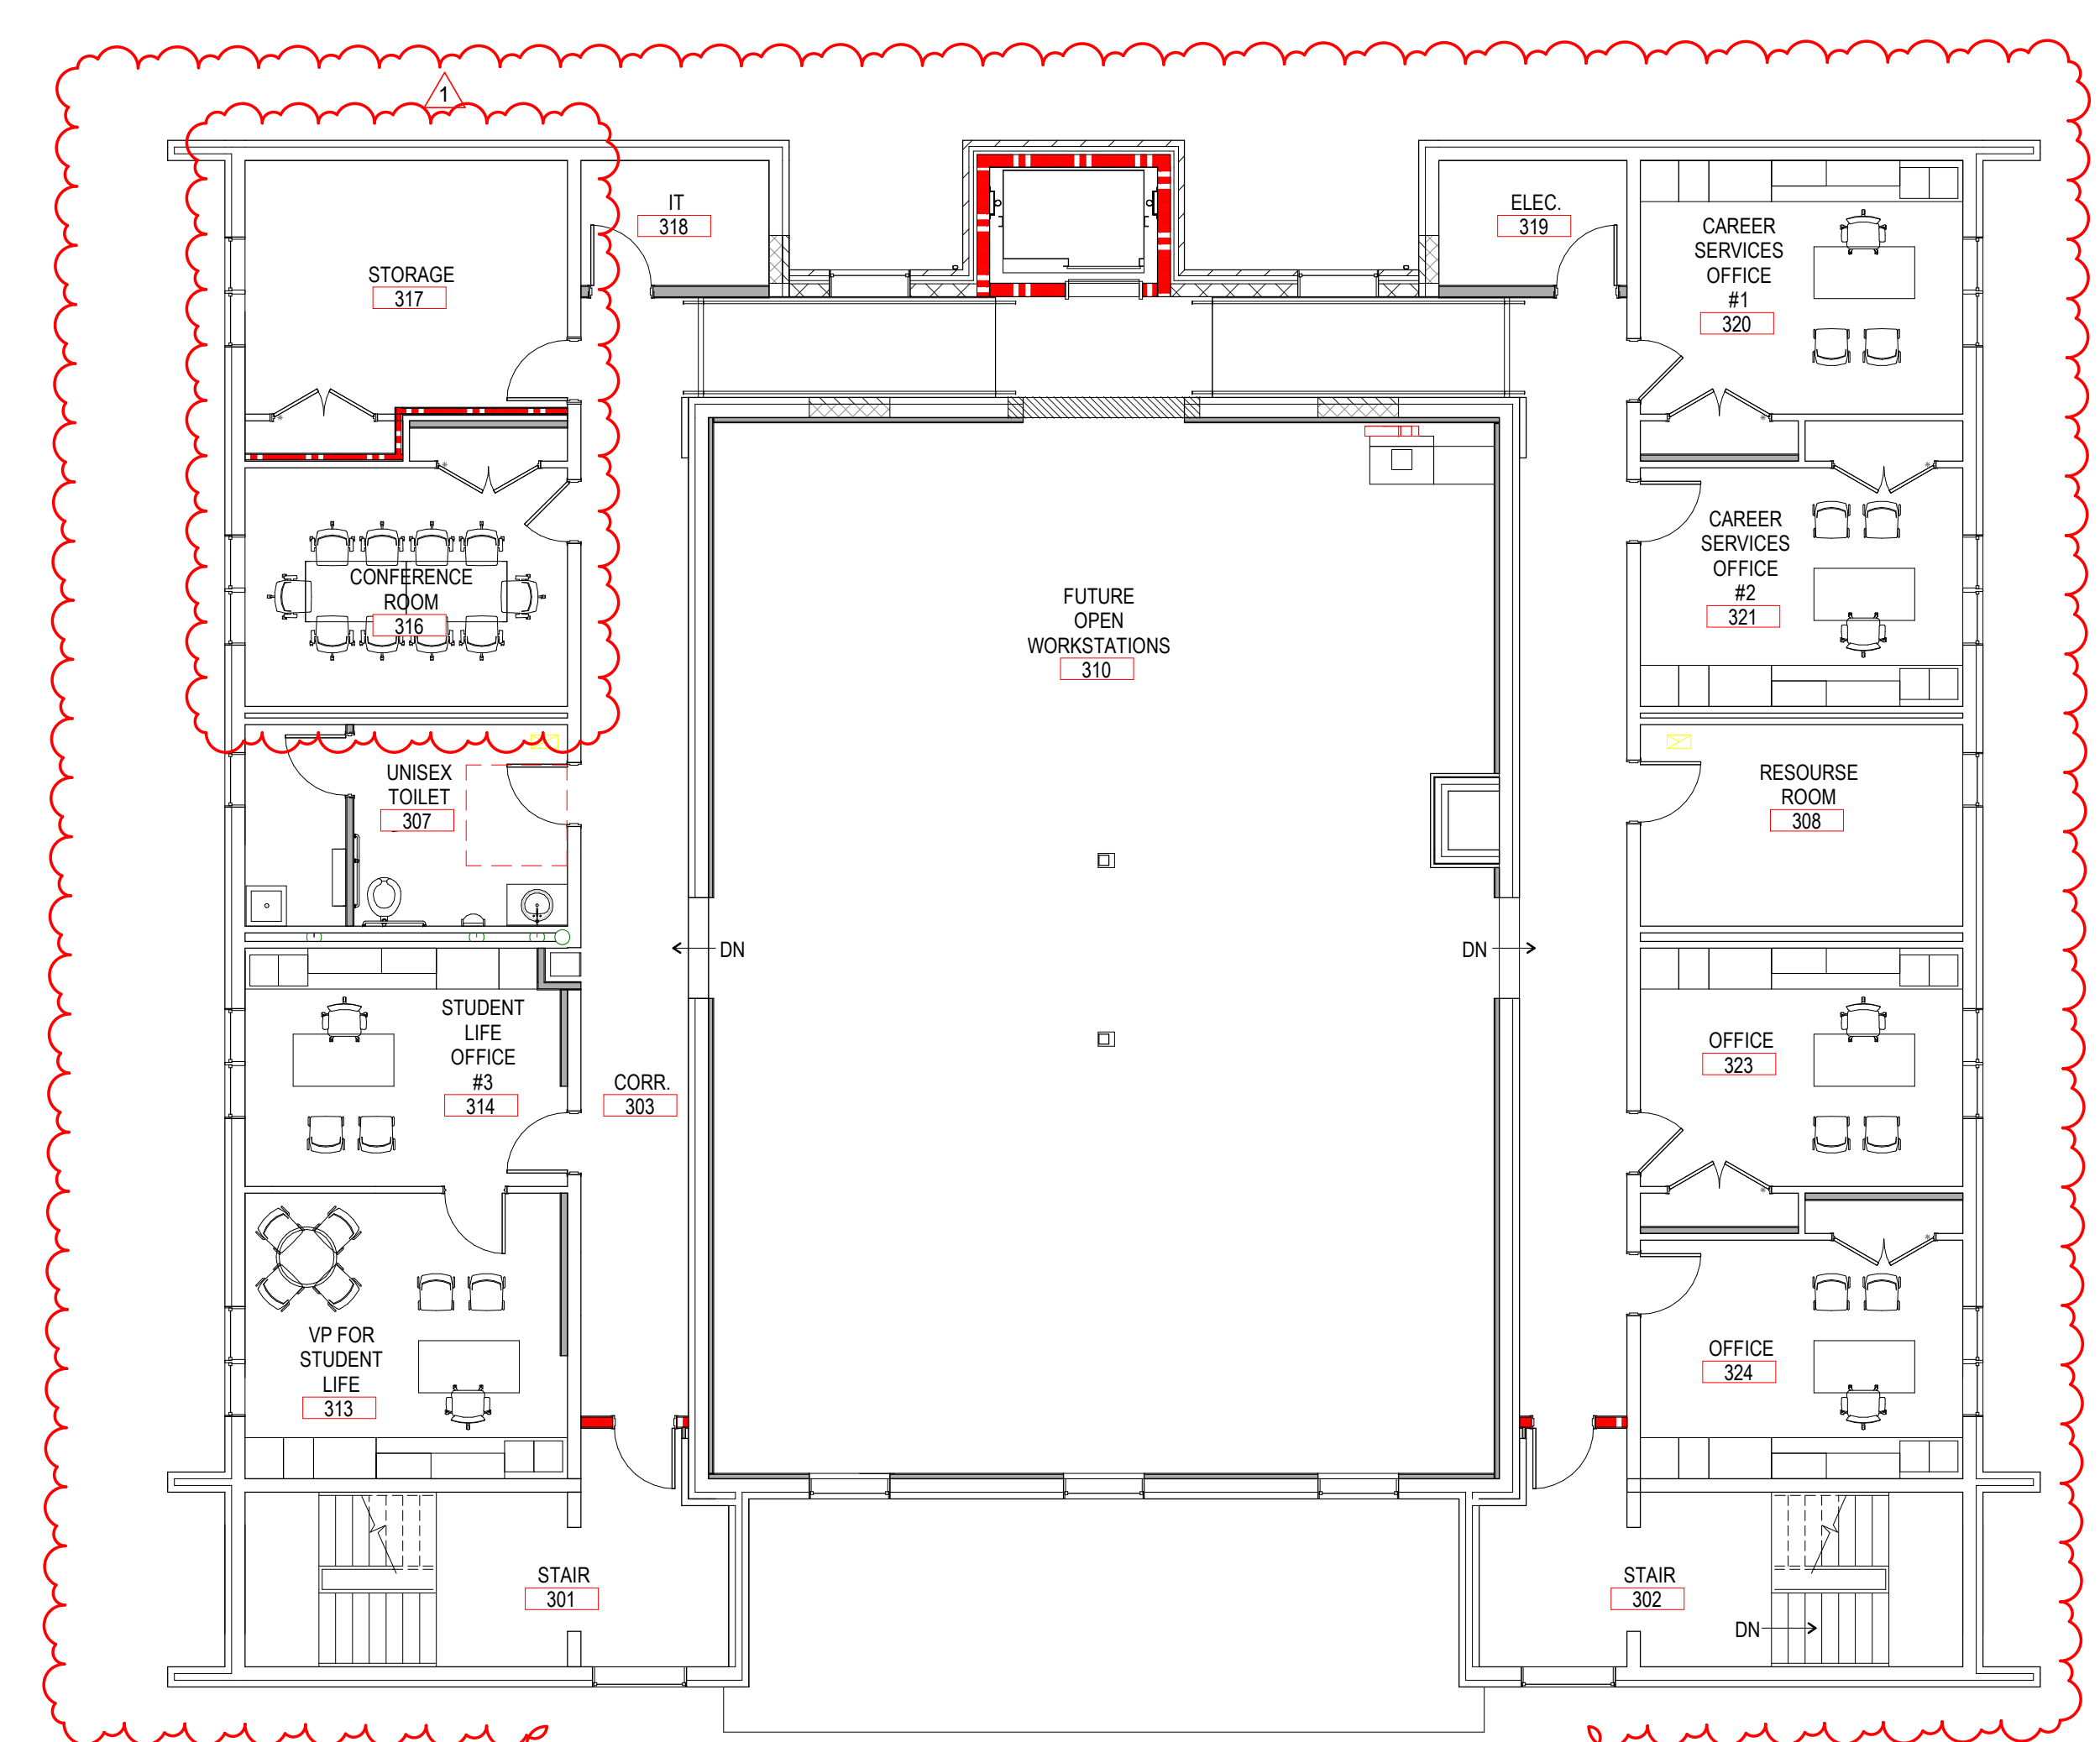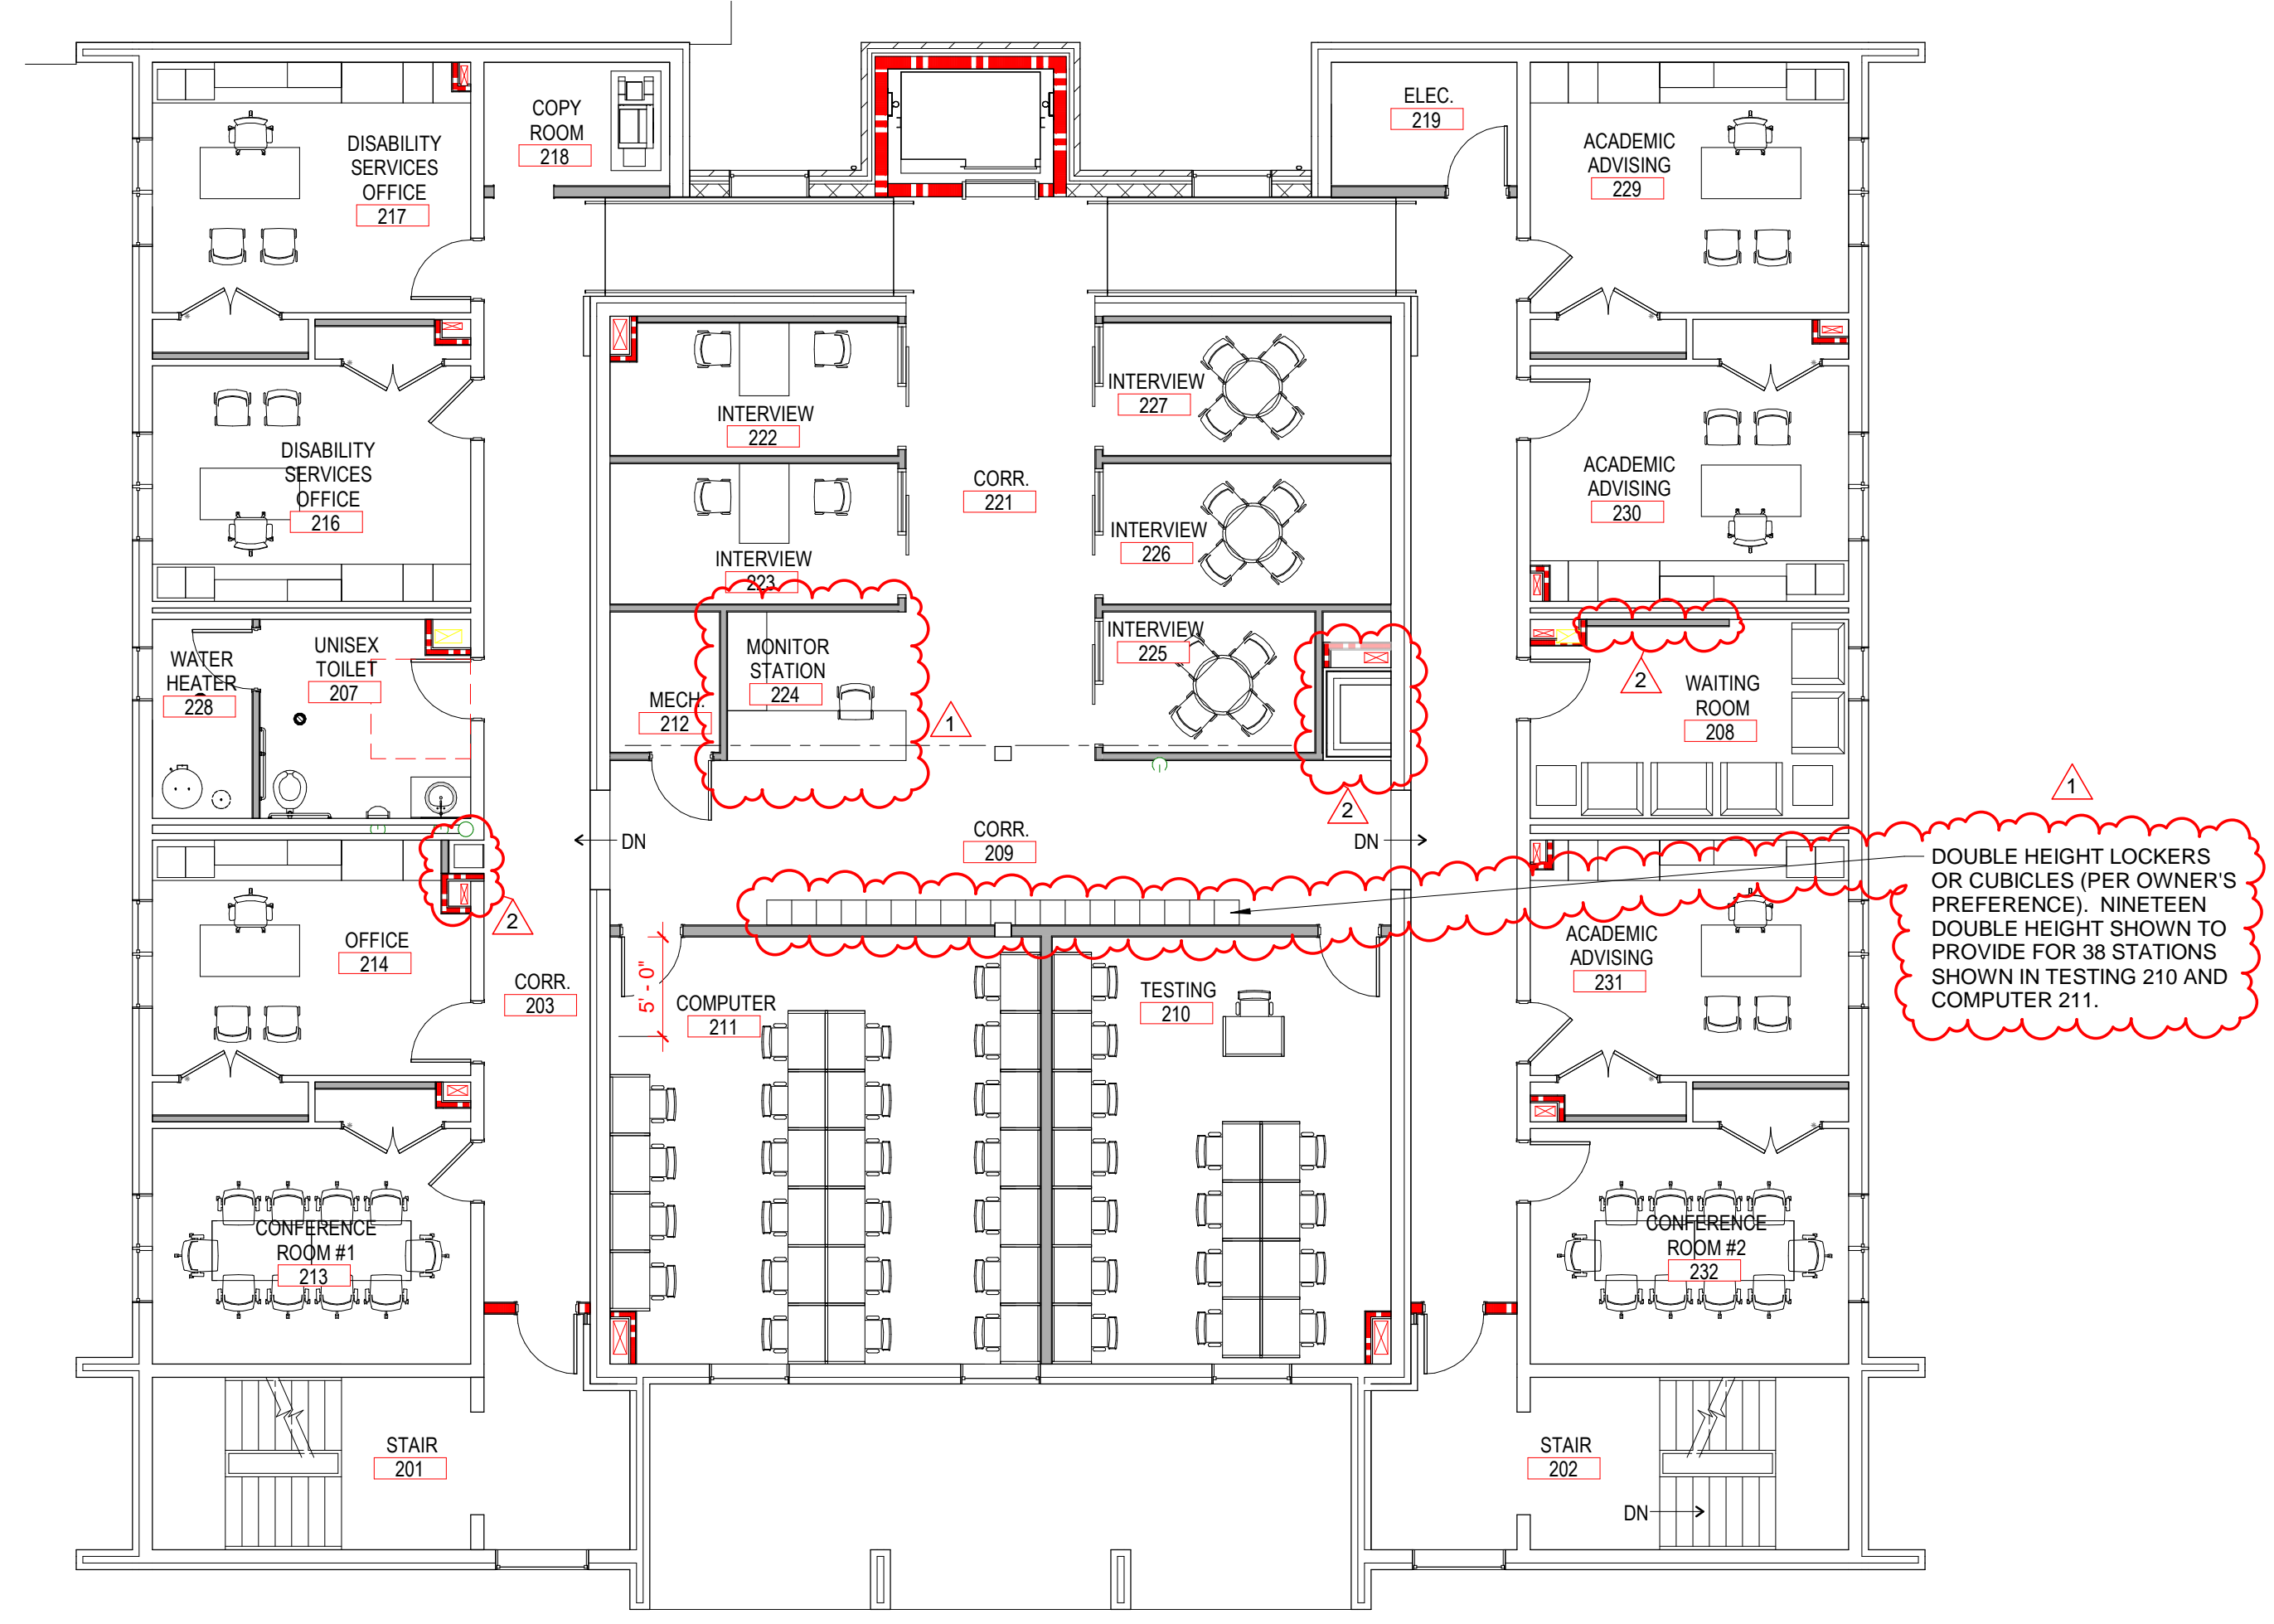CAMPBELL UNIVERSITY DAY HALL RENOVATIONS


PROJECT NO. 513.9660.00

SHEET TITLE FURNITURE PLANS - BASE BID - LEVELS 2 AND 3


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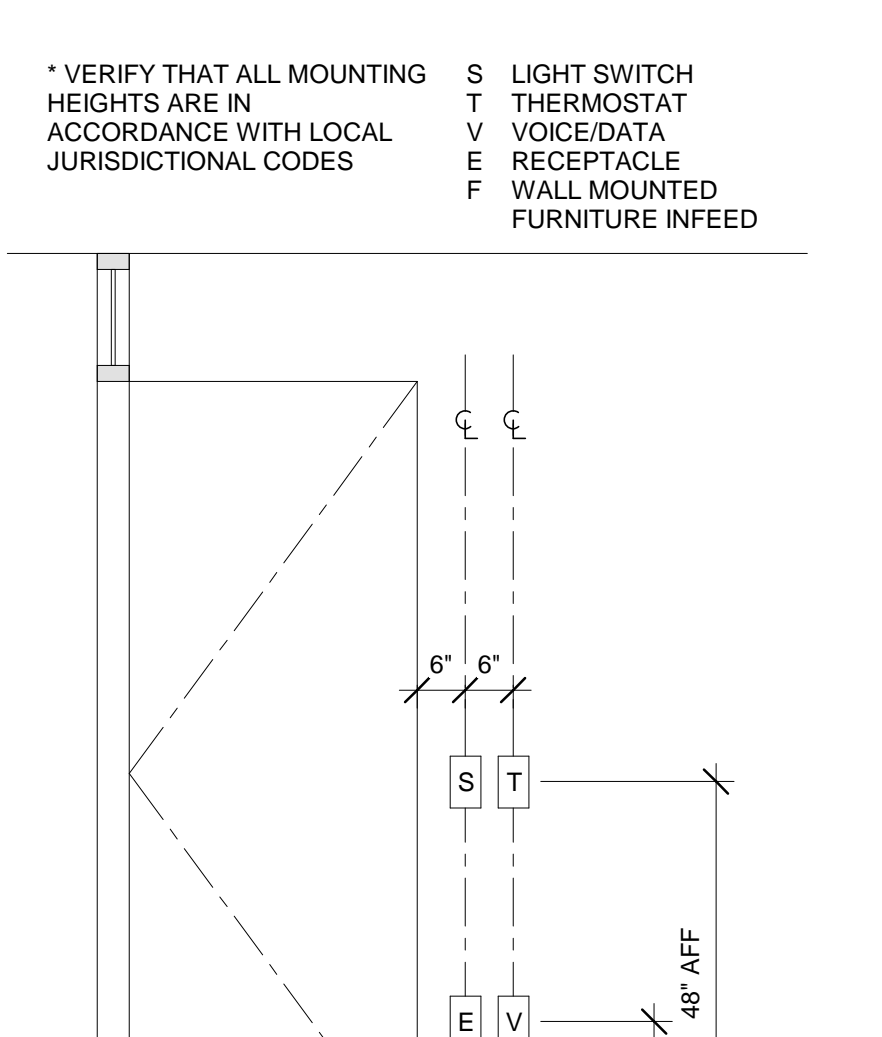
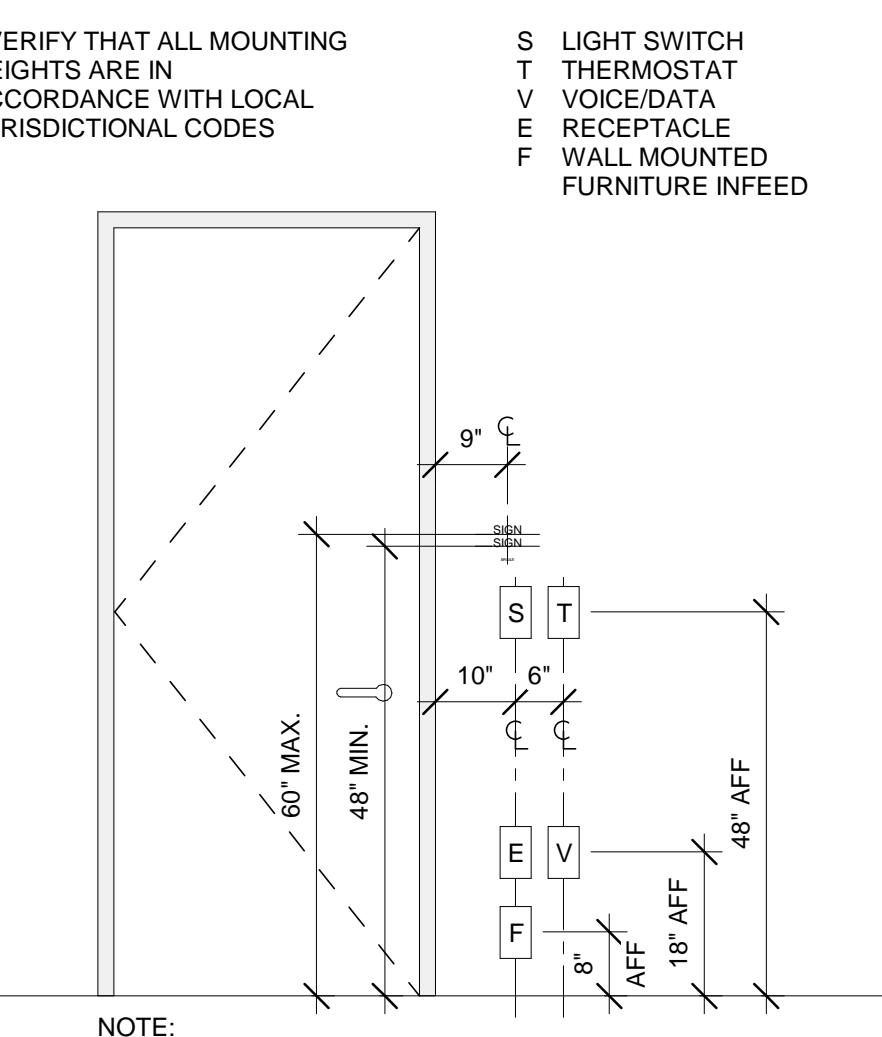
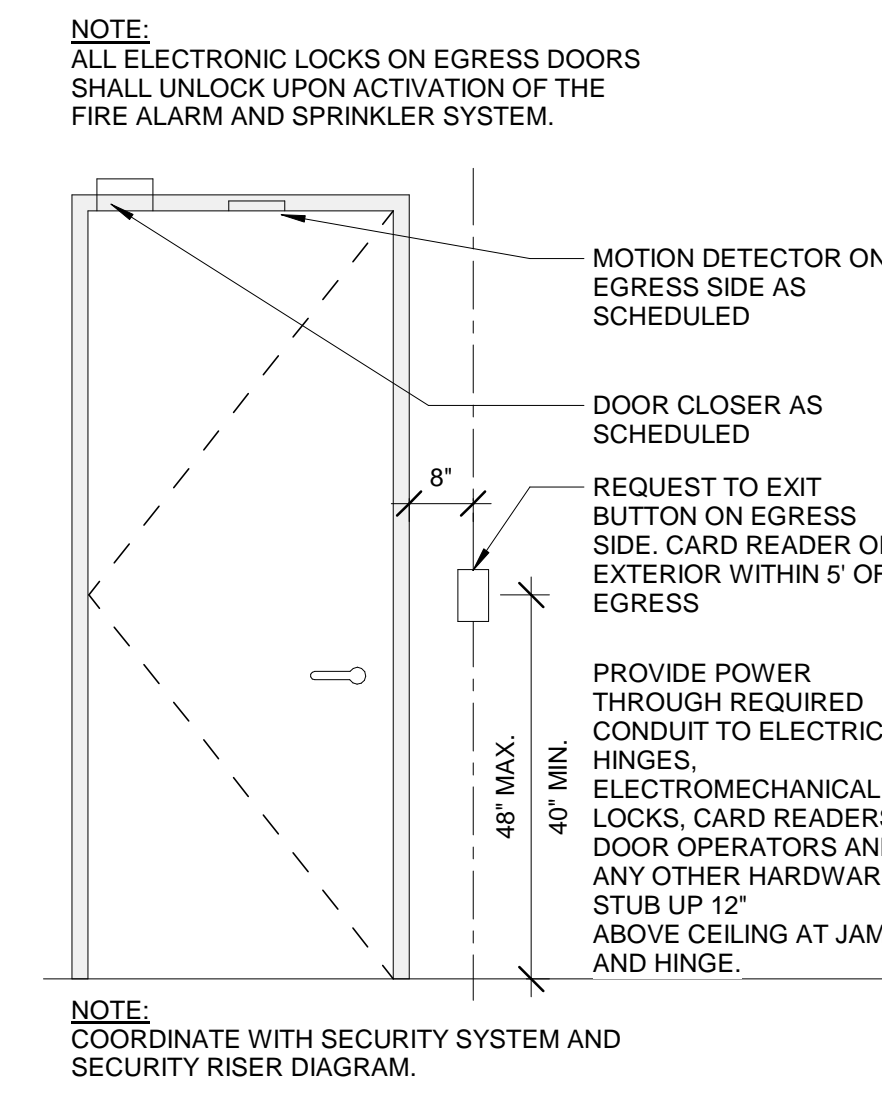
FRAME TYPES




DOOR TYPES

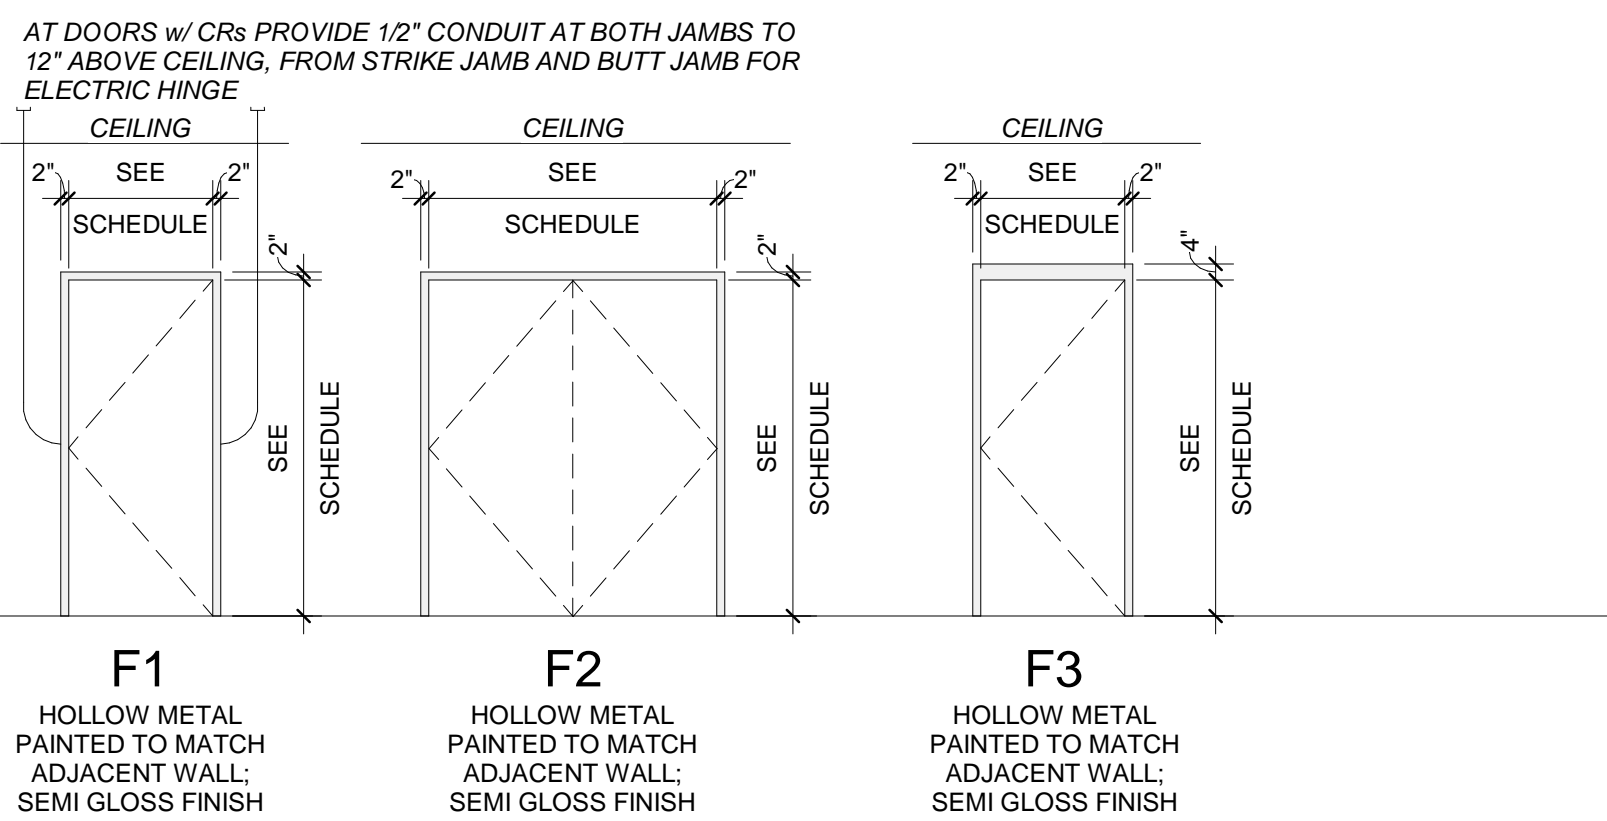


DEVICE LOCATIONS

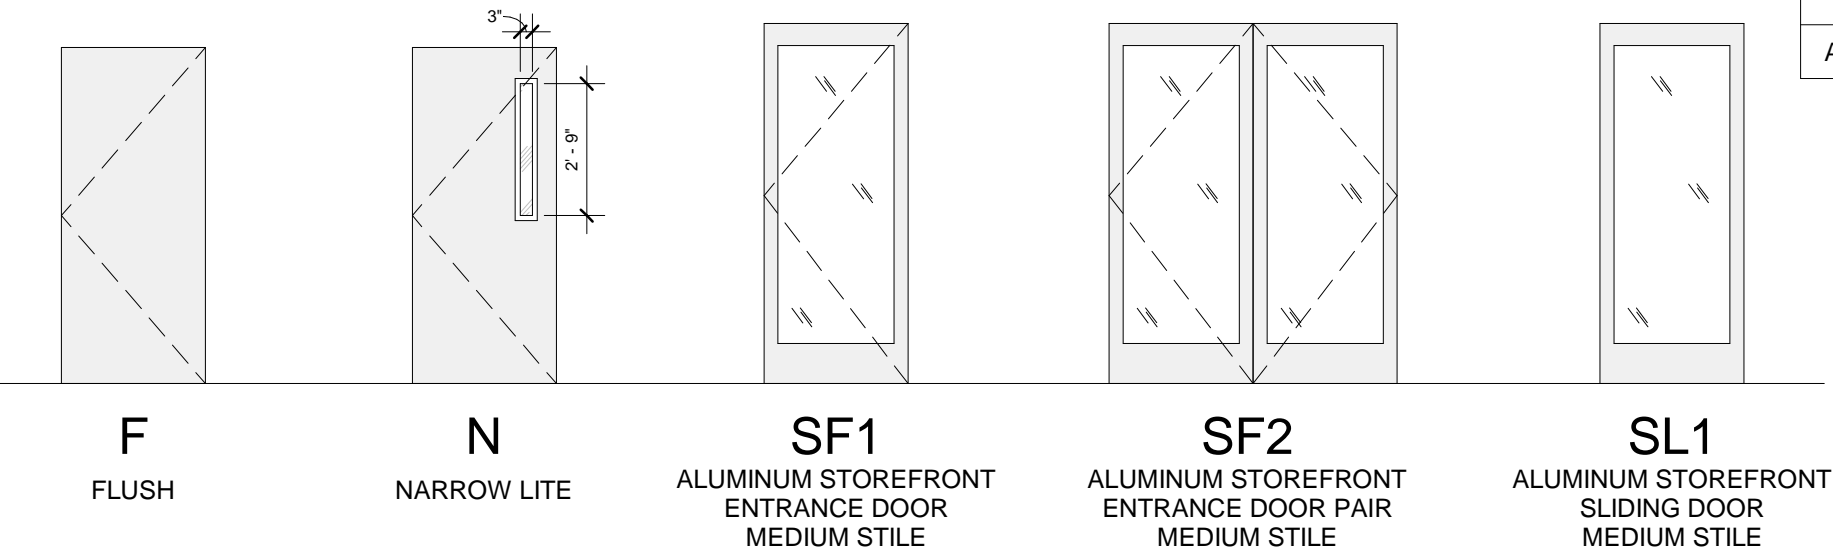

ALUMINUM FRAMING SYSTEM TYPES - EXTERIOR

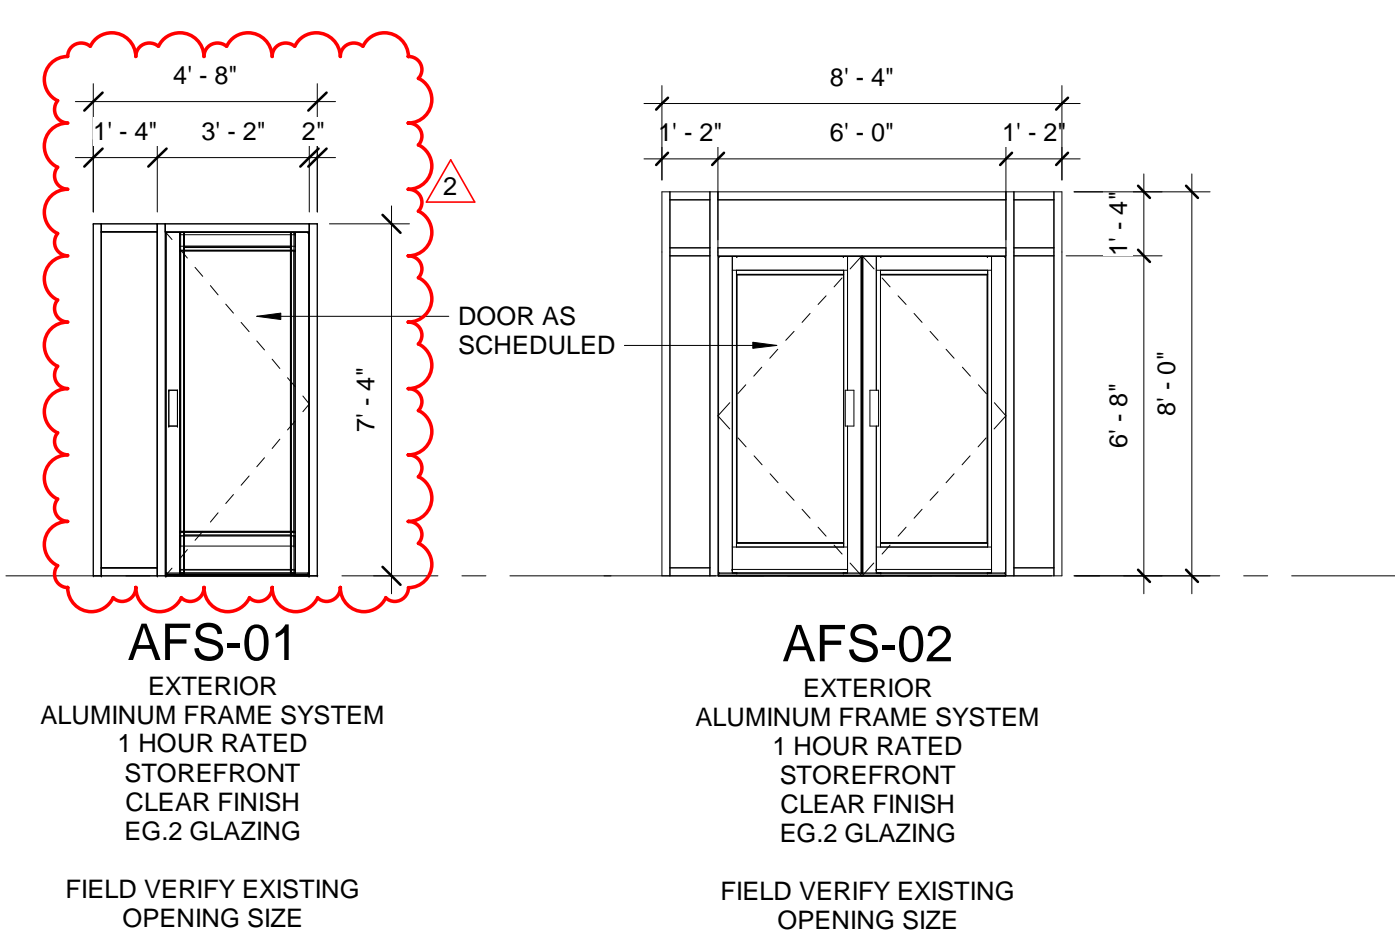


ALUMINUM FRAMING SYSTEM TYPES - INTERIOR

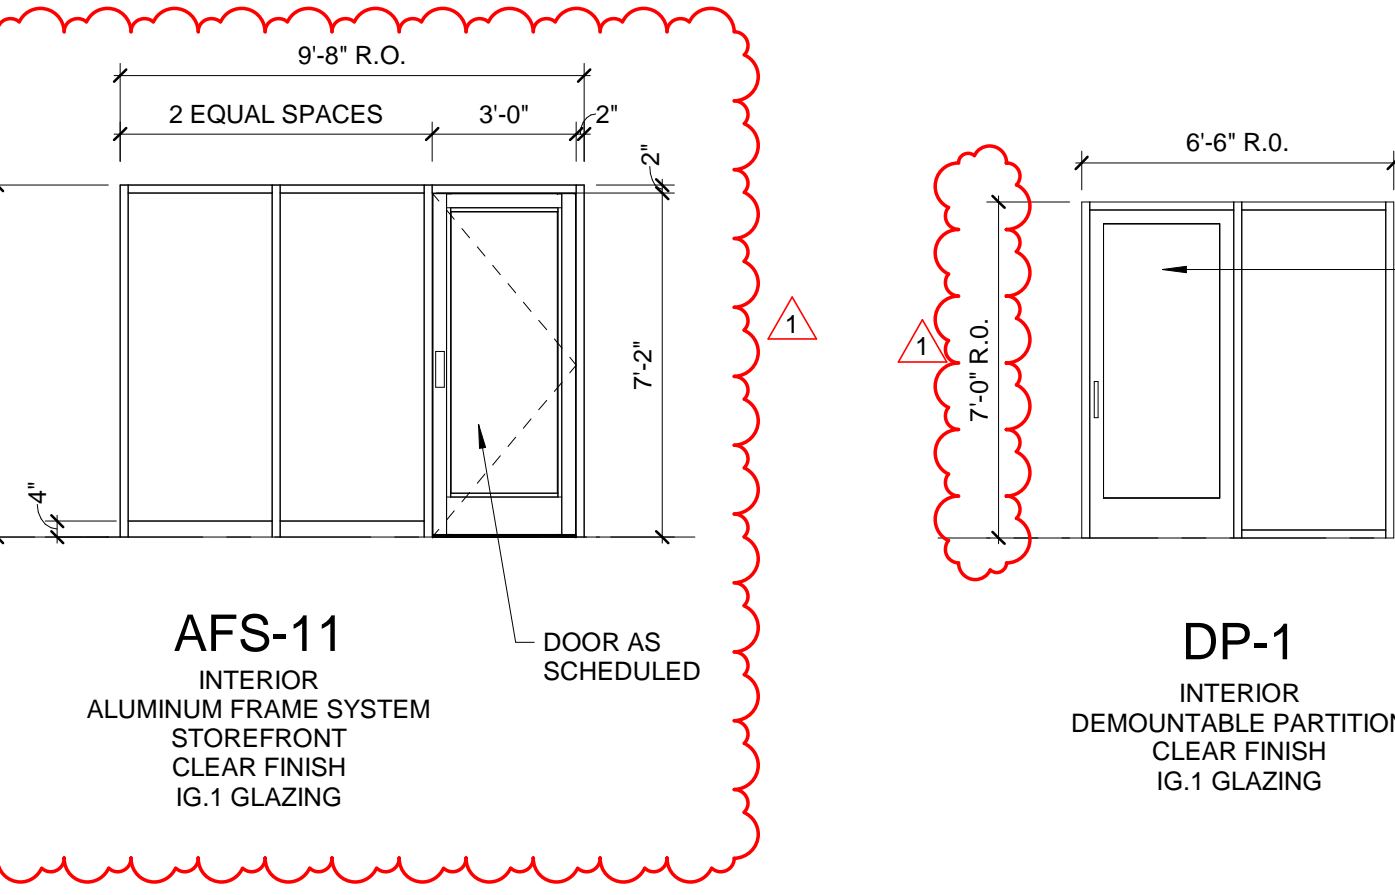

HARDWARE SETS

- Hardware Set #1 (Exterior Stair Doors 101-2 and 102-2)
Hardware Set #6 (Office Doors 114-1, 116, 117, 120, 121, 123-1, 124-1, 214-1, 217-1, 208, and 232-1)
Hardware Set #7 (Office Doors 113-1, 123-1, 213-1, 216-1, 229-1, 311, 313, 314, 316-1, 320-1, and 323-1)
Hardware Set #8 (Closet Doors 113-2, 114-2, 123-2, 124-2, 214-2, 213-2, 216-2, 217-2, 229-2, 230-2, 231-2, 232-2, 316-2, 317-2, 320-2, 321-2, 324-2)
Hardware Set #9 (Door 118, 119, 212, 219, 318, and 319)
Hardware Set #10 (Door 115, 122, 210, and 211)
Hardware Set #11 (Women 107, Men 108)
Hardware Set #12 (Unisex Toilet 207, 307)
Hardware Set #13 (Door 222, 223, 224, 225, 226, and 227)

EXTERIOR HM FRAME HEAD DETAIL (JAMB SIMILAR)

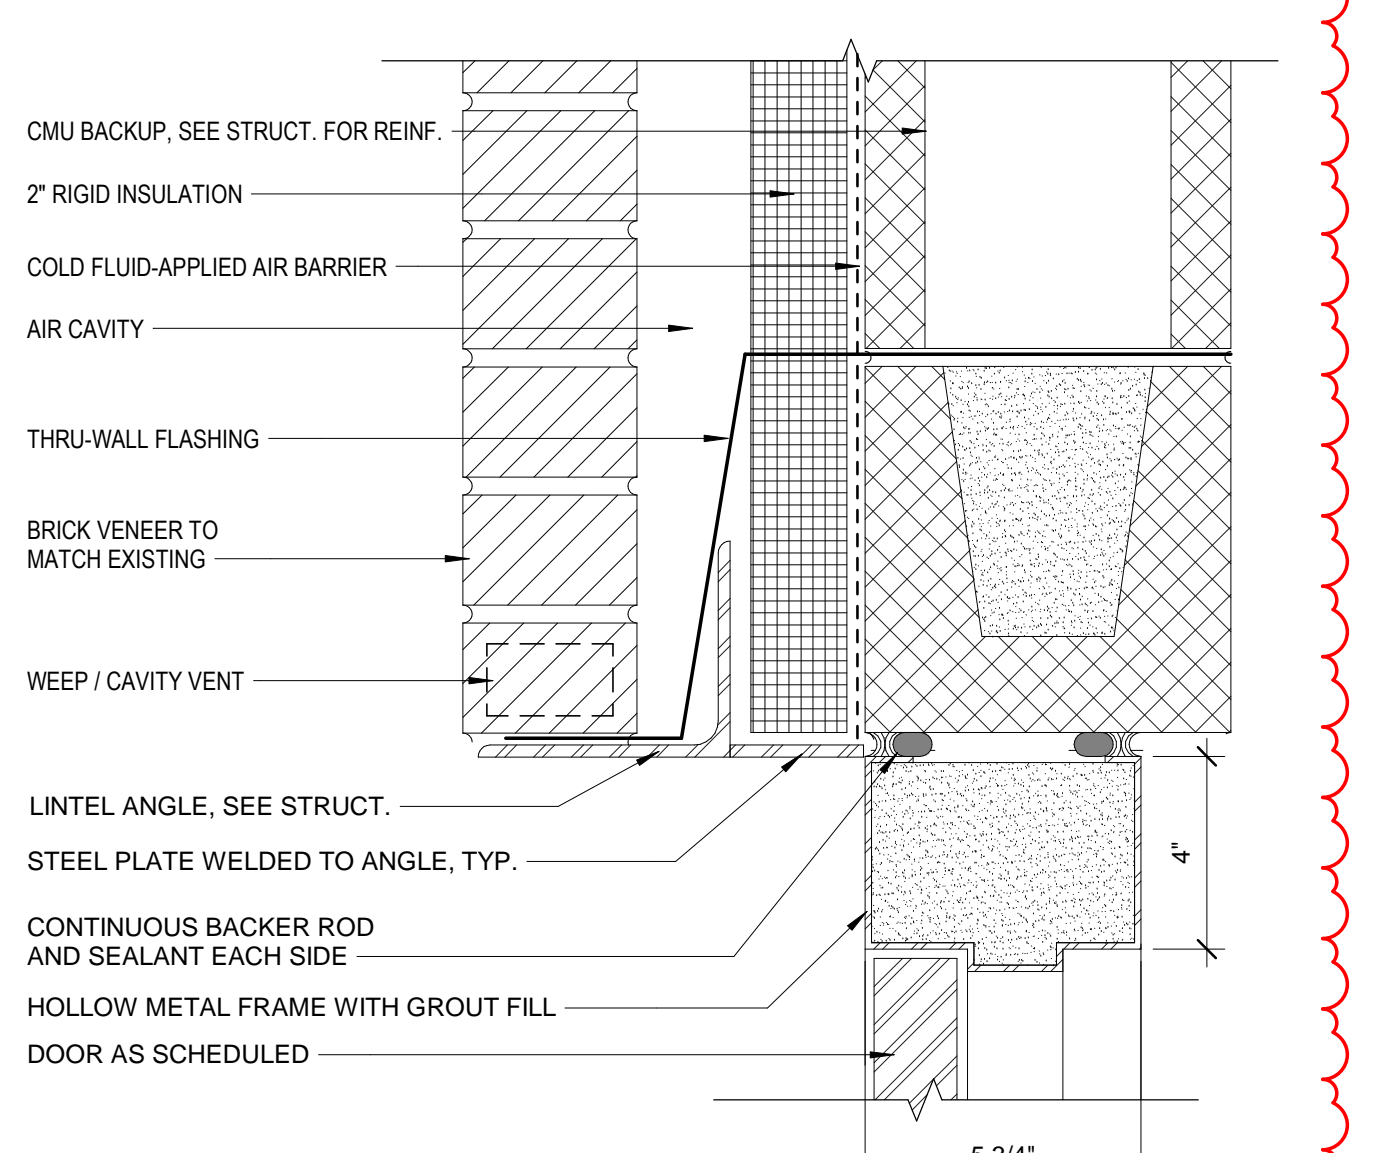


DOOR SCHEDULE

Table with columns: Door Number, Type, Width, Height, Material, Finish, Rating, Hardware, Type, Material, Finish, Comments. Lists 326 door entries.

DOOR SCHEDULE NOTES

- 1. FIELD VERIFY EXISTING DOOR AND FRAME TYPE, SIZE, MATERIAL AND FINISH.
2. FIELD VERIFY THAT EXISTING DOORS ARE 6'-8" HIGH WITH 2" HOLLOW METAL FRAME.
3. WHERE DOORS AND FRAMES ARE SCHEDULED TO BE INSTALLED IN EXISTING OPENINGS, FIELD VERIFY ALL OPENING SIZES PRIOR TO FABRICATION OF DOORS AND FRAMES.
4. REFINISH ALL EXISTING WOOD DOORS WITH STAIN FINISH TO MATCH EXISTING.
5. REPAIR ALL EXISTING PAINTED DOORS AND HOLLOW METAL FRAMES.
6. NEW WOOD DOORS ARE TO BE 6'-8" HIGH TO MATCH EXISTING UNLESS OTHERWISE NOTED.
7. NEW WOOD DOOR FINISH IS TO MATCH EXISTING WOOD DOOR FINISH.
8. FIELD VERIFY THAT ALL DOUBLE CLOSET DOORS SCHEDULED TO REMAIN ARE SWING DOORS AS SHOWN. IF THE DOORS SHOWN ARE NOT EXISTING, RE-USE EXISTING SALVAGED DOORS OR PROVIDE NEW DOORS.
9. HOLLOW METAL DOOR FRAMES TO BE FULLY WELDED FRAMES.
10. CAULK DOOR JAMBS AND HEADS WHERE GAPS BETWEEN WALL AND FRAME EXCEEDS 1/8".
11. PROVIDE (3) JAMB AND (1) BASE ANCHOR PER JAMB AT GYP. BOARD PARTITIONS.

ADA DOOR CONFIGURATIONS

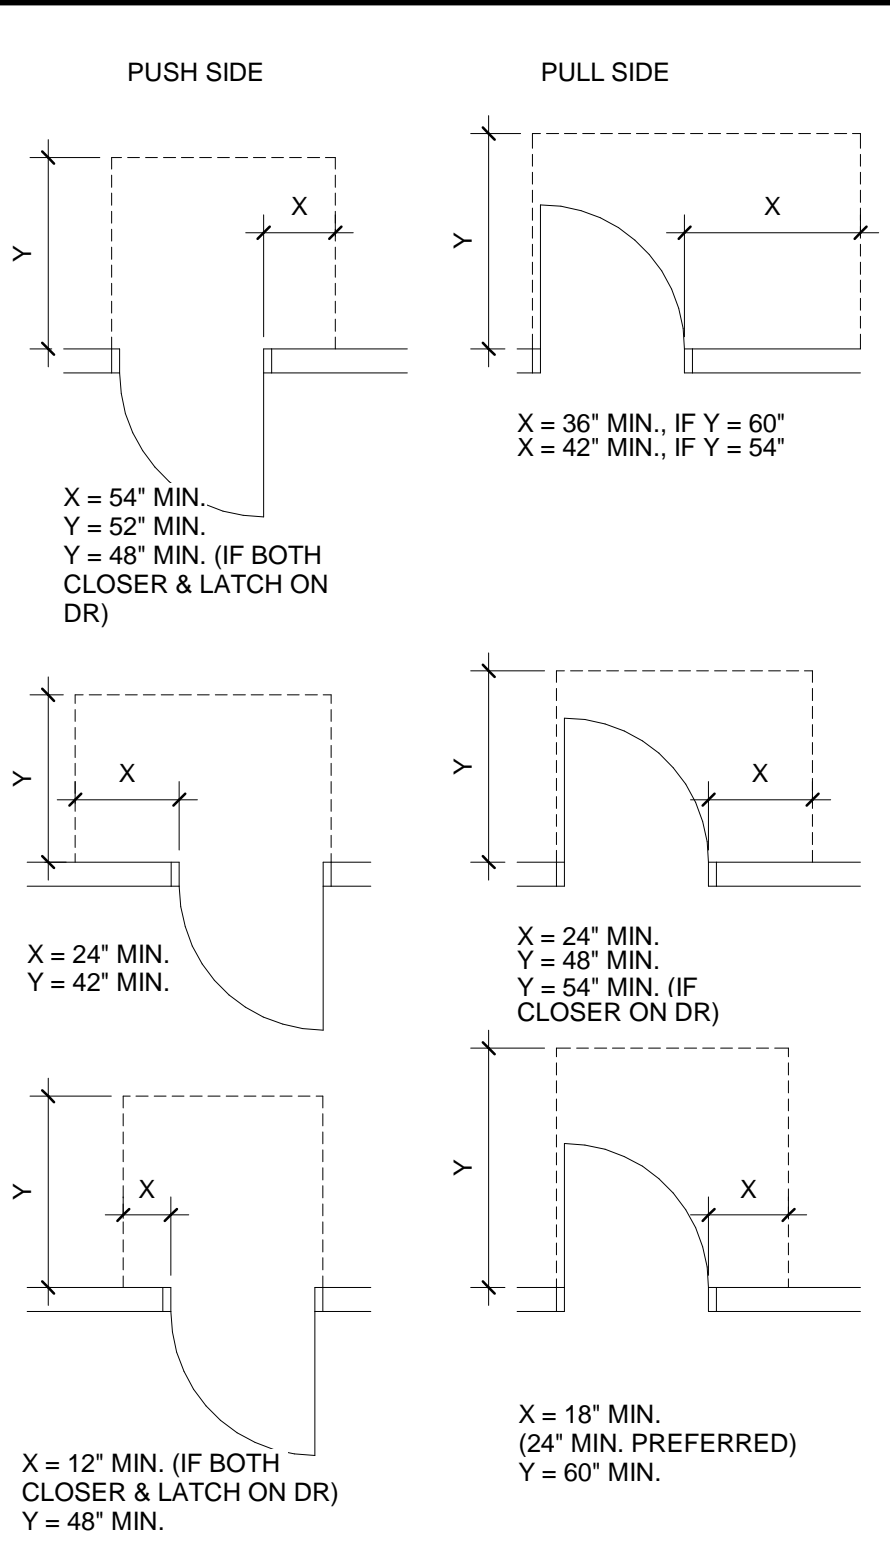

- GLAZING LEGEND
IG.1 1/4" TEMPERED GLASS
IG.2 1/4" TEMPERED GLASS (BACKPAINTED) - NOT USED
IG.3 1/4" TEMPERED GLASS (FROSTED)
IG.4 1/4" TEMPERED GLASS (FROSTED)
IG.5 1" TEMPERED INSULATED GLASS
EG.1 1" TEMPERED INSULATED GLASS
EG.2 1" TEMPERED SPANDREL FIRE GLASS
EG.3 1" TEMPERED SPANDREL GLASS - NOT USED
EG.4 1" TEMPERED FRITTED GLASS - NOT USED

ALUMINUM FRAMING SYSTEM NOTES

- 1. BASIS OF DESIGN FOR EXTERIOR ALUMINUM FRAME SYSTEMS ("AFS"), SUBJECT TO COMPLIANCE WITH REQUIREMENTS, PROVIDE PRODUCTS BY OLCADSTE BUILDING ENVELOPE FG-3000 THERMAL MULTIPANE OR COMPARABLE BY "KAWNEER NORTH AMERICA", "TRACO" OR "YKK AP AMERICA, INC."
2. BASIS OF DESIGN FOR INTERIOR ALUMINUM FRAME SYSTEMS ("AFS"), SUBJECT TO COMPLIANCE WITH REQUIREMENTS, PROVIDE PRODUCTS BY OLCADSTE OR COMPARABLE BY "KAWNEER NORTH AMERICA", "TRACO" OR "YKK AP AMERICA, INC."
3. BASIS OF DESIGN FOR DEMOUNTABLE PARTITIONS ("DP"), SUBJECT TO COMPLIANCE WITH REQUIREMENTS, PROVIDE "TRANQUIL SYSTEMS INTERNATIONAL - TRANQUIL ADAPT WALLS" OR COMPARABLE BY "DIRTT ENVIRONMENTAL SOLUTIONS" OR "STEELECASE INC."

VERIFY ALL DIMENSIONS AND EXISTING CONDITIONS, TYPICAL

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PROJECT NO: 513.9660.00
SHEET TITLE: DOOR SCHEDULE, DOOR AND FRAME TYPES AND DETAILS
SHEET NUMBER: A901